# Nepal Urban Governance and Infrastructure Project (NUGIP) Office of Municipal Executive Pokhara Metropolitan City Kaski District, Gandaki Province







## **DETAIL PROJECT REPORT**

**OF** 

## UPGRADATION OF DOBILLA – BAGMARA – TIKLANG – BADARKOT -LAMGADHI-CHAPLANG – UPALLO PUDITAR – TALLO PUDITAR – JHIGATE (JANAJAGRITI MAVI) TAGAREGAUDA ROAD

VOLUME – I	Main Report
VOLUME – II	Cost Estimate
VOLUME – III	Drawing
VOLUME – IV	Annex

October 2023 (Revised November 2023)

**Submitted By:-**

Plush Engineers and Architects (P.) Ltd. (PEA)
B.N. Consultancy Pvt. Ltd. (BN)
SOIL TEST (P.) Ltd.
(PEA-BN-Soil Test) JV Kathmandu, Nepal


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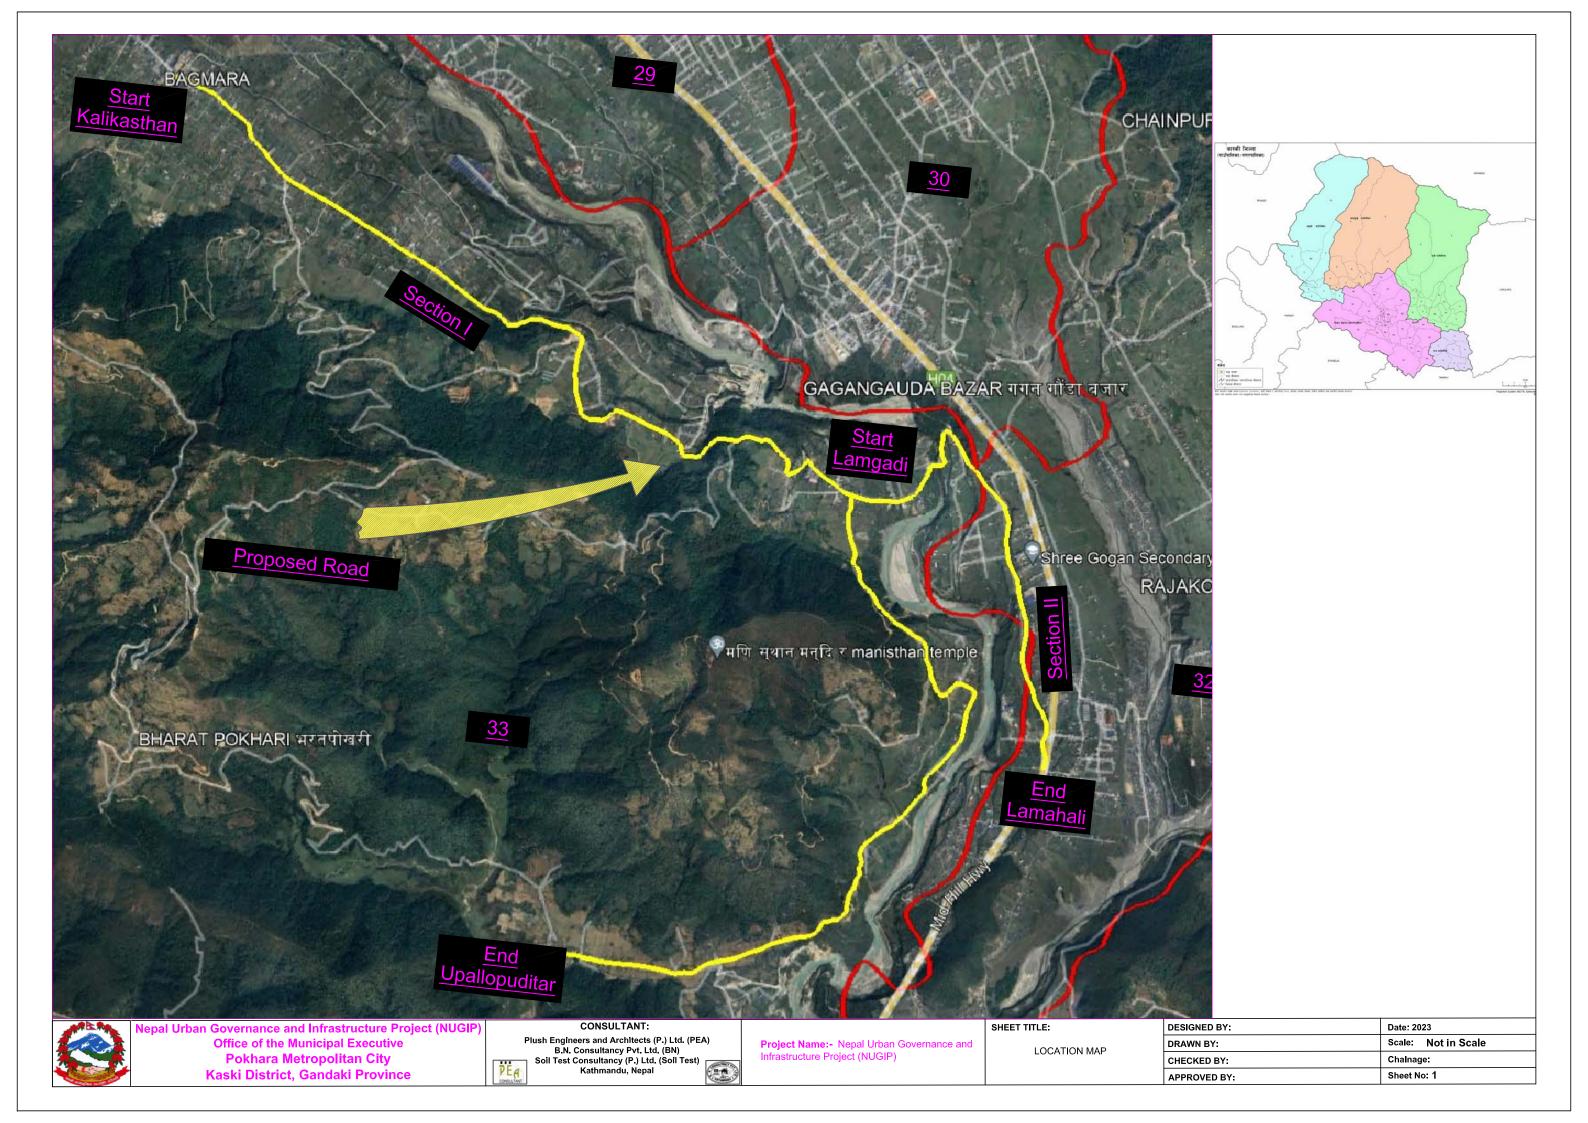
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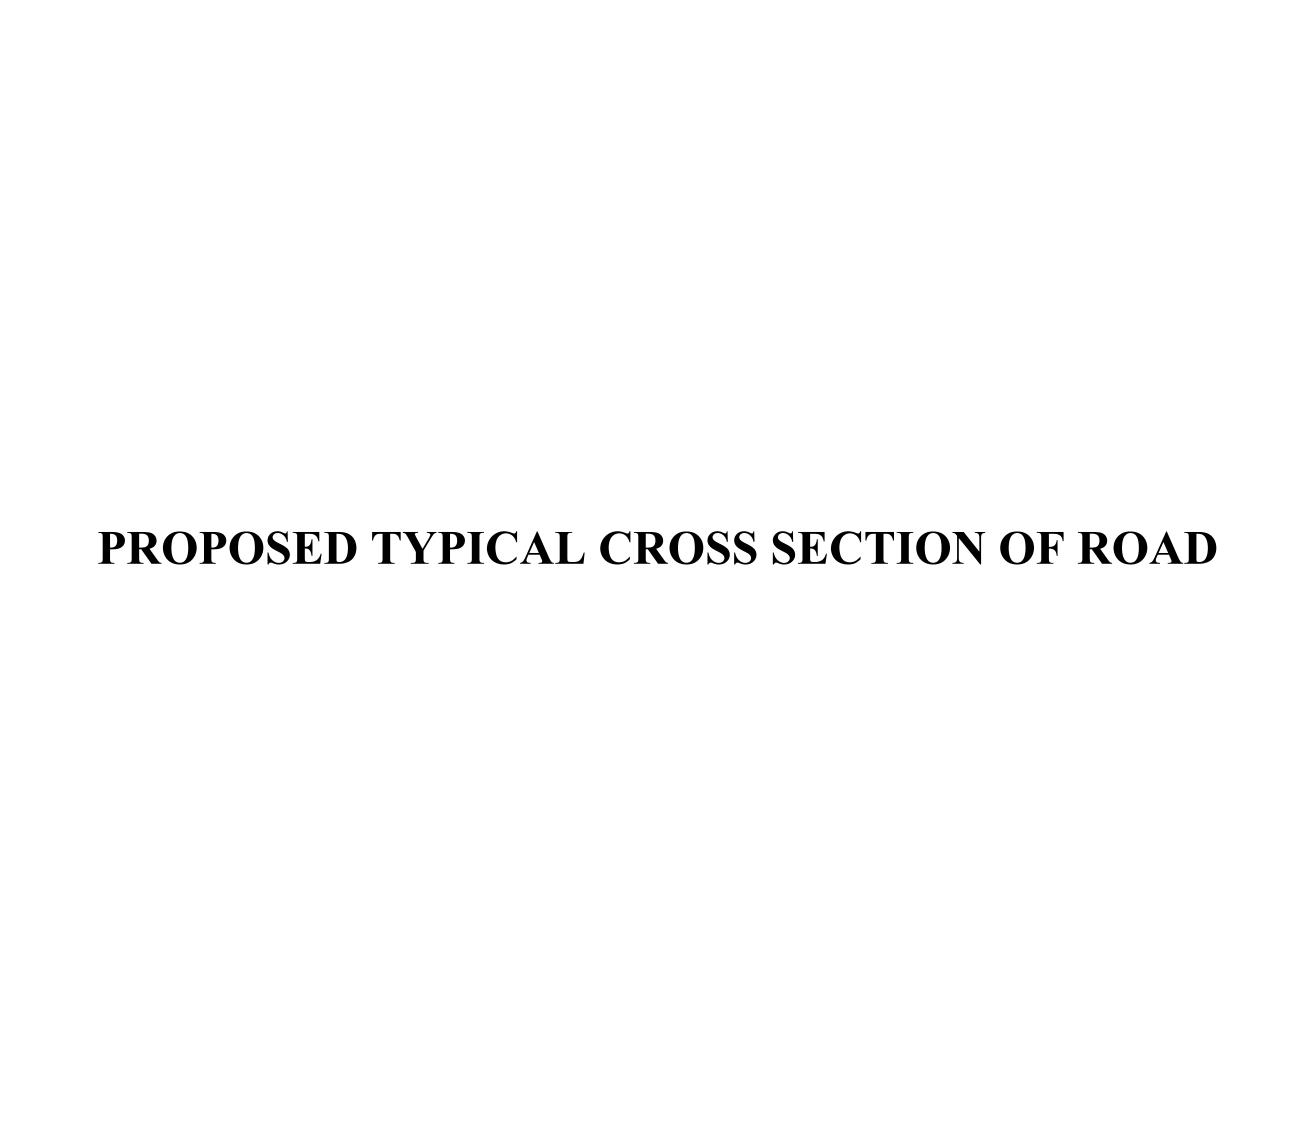
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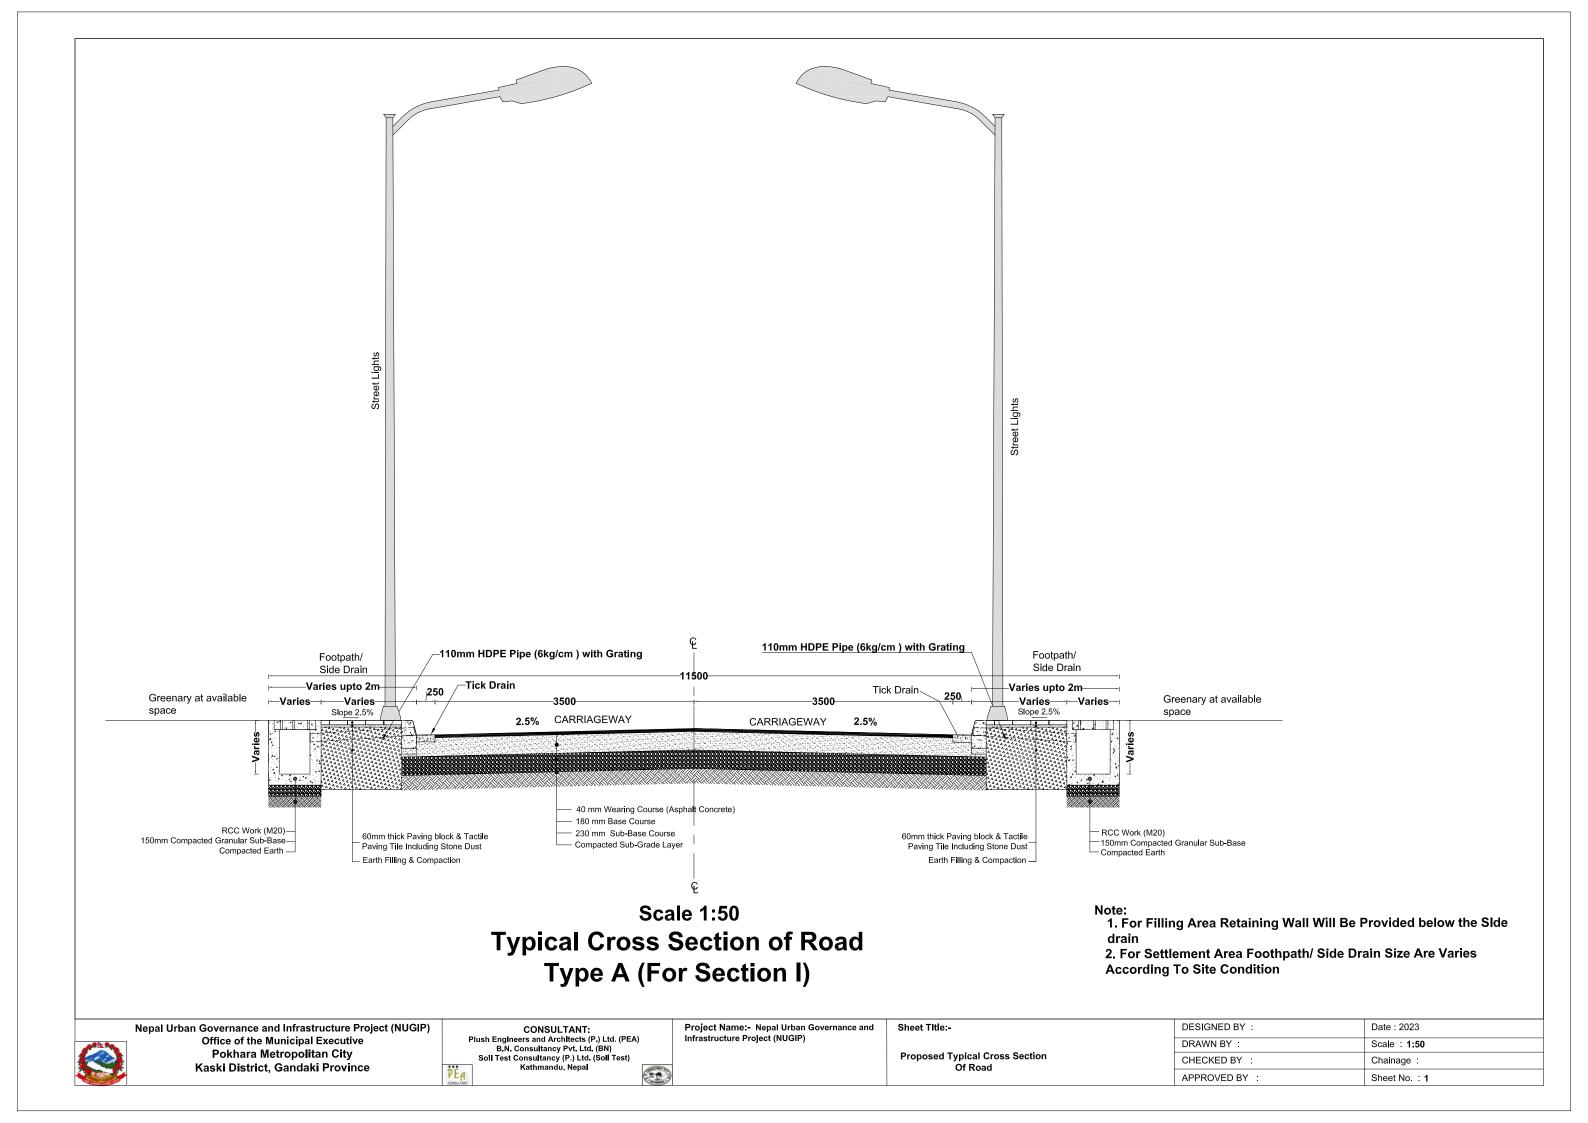
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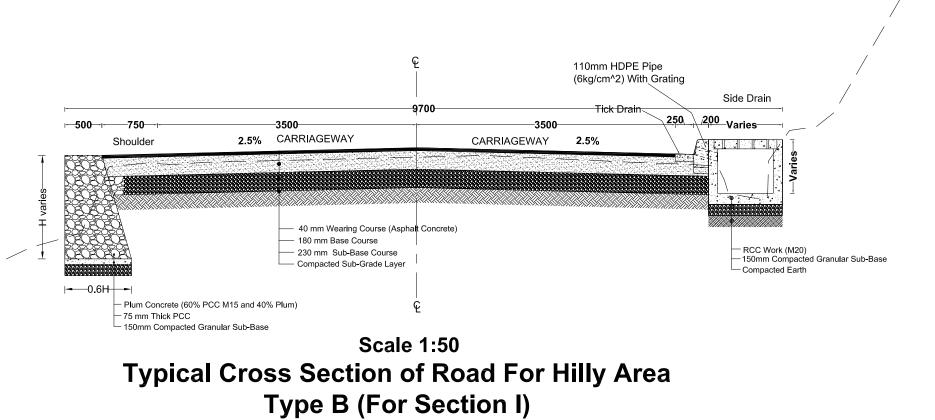
SHEET TITLE: INDEX MAP DESIGNED BY: Date: 2023 Scale: DRAWN BY: CHECKED BY: Chalnage: APPROVED BY: Sheet No: 1

epal Urban Governance and Infrastructure Project (NUGIP Office of the Municipal Executive Pokhara Metropolitan City **Kaski District, Gandaki Province** 








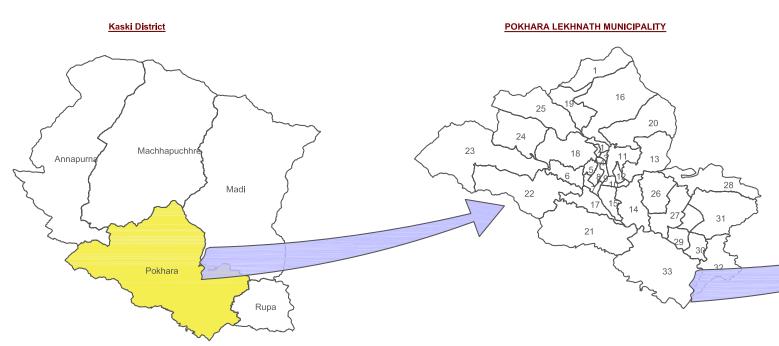

#### Note:

1. Retaining Wall and Breast Wall Will be Provided According to Site Condition

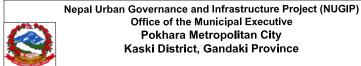

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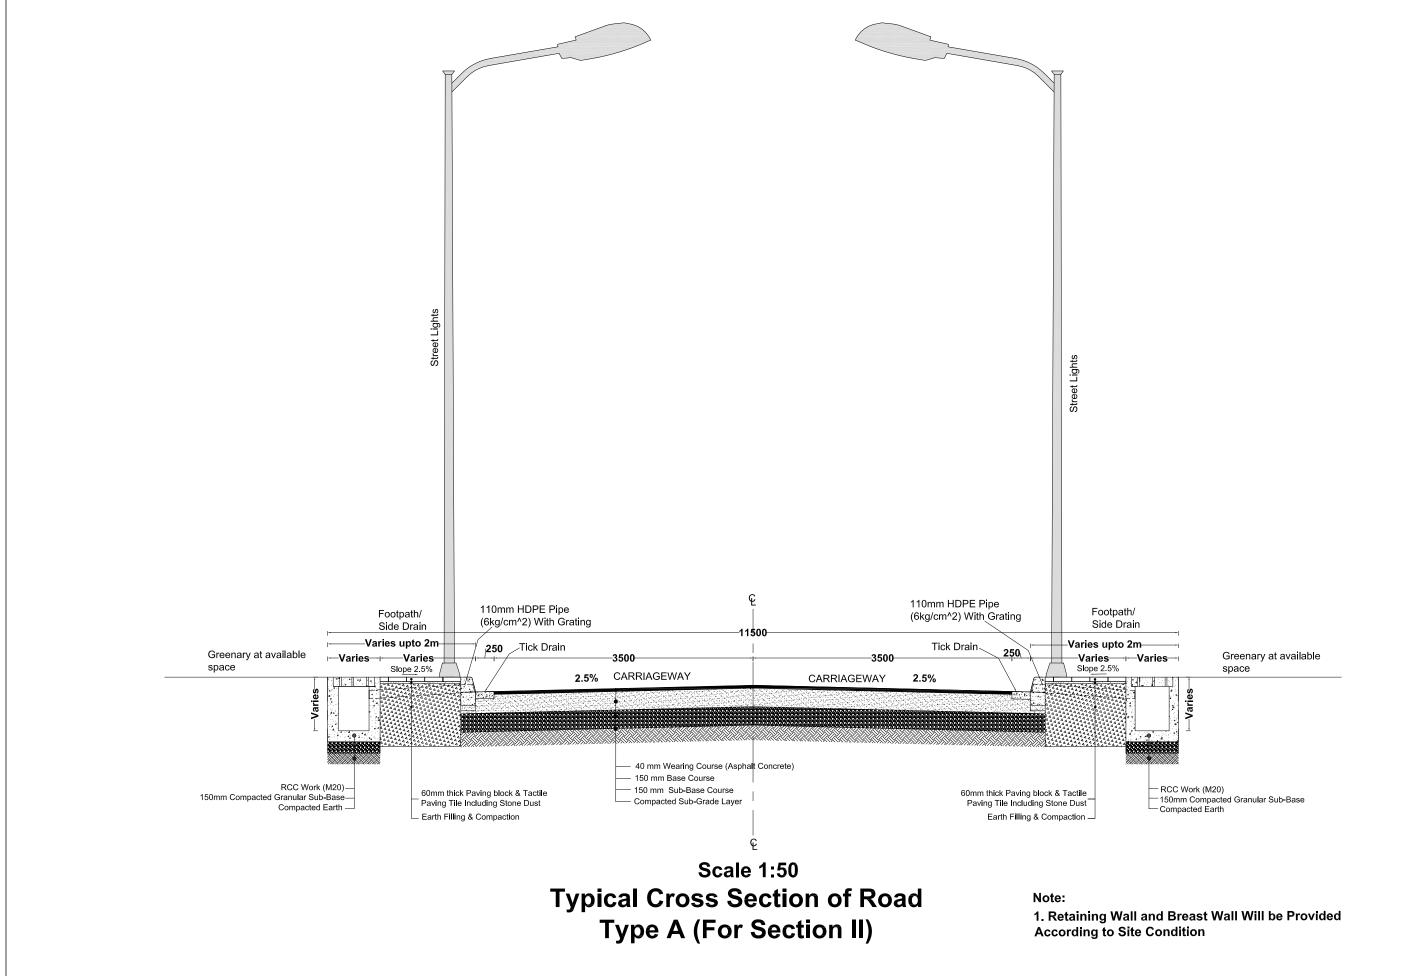
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Proposed Typical Cross Section Of Road 
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Pokhara Metropolitan City
Kaski District, Gandaki Province


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Sheet Title:-

Proposed Typical Cross Section Of Road

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### Note:

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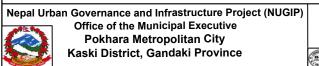
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Proposed Typical Cross Section Of Road

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APPROVED BY :	Sheet No.: 4

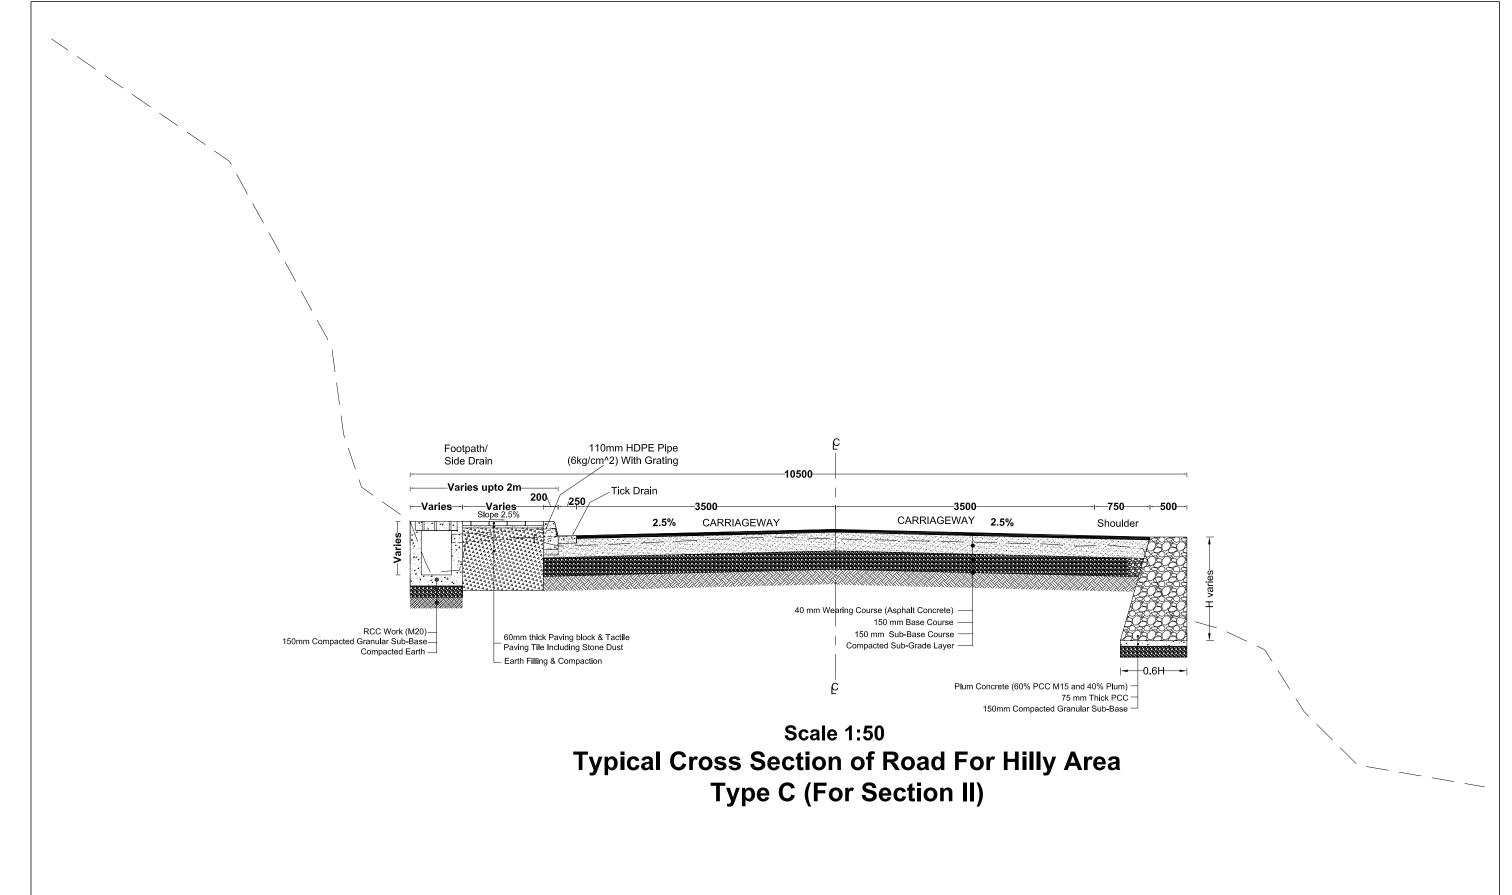

LEGEND	SYMBOL
Bench Mark	⊠ <u>BM-1</u>
Houses	
Hut	
Road center	
Chainage	- 0+040 - 0+030 - 0+010
School	
Chautari	10000d 10000d
Partikshyalaya	7.7.7.7.7 7.7.7.7.7
Box Culvert	
Pipe Culvert	
Compound wall	
Gate	
Wooden Pole	
Electric Pole	<u> </u>
RCC Pole	†
Masonry wall	<i>VIIIIIII</i>
Temple	
Index Contour	$\triangleright$
Tick Drain	
Kerbstone	
Footpath	
Drain	
Fence bar	





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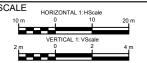
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**LEGEND** 

Retaining wall


Water tank


**RCC** wall





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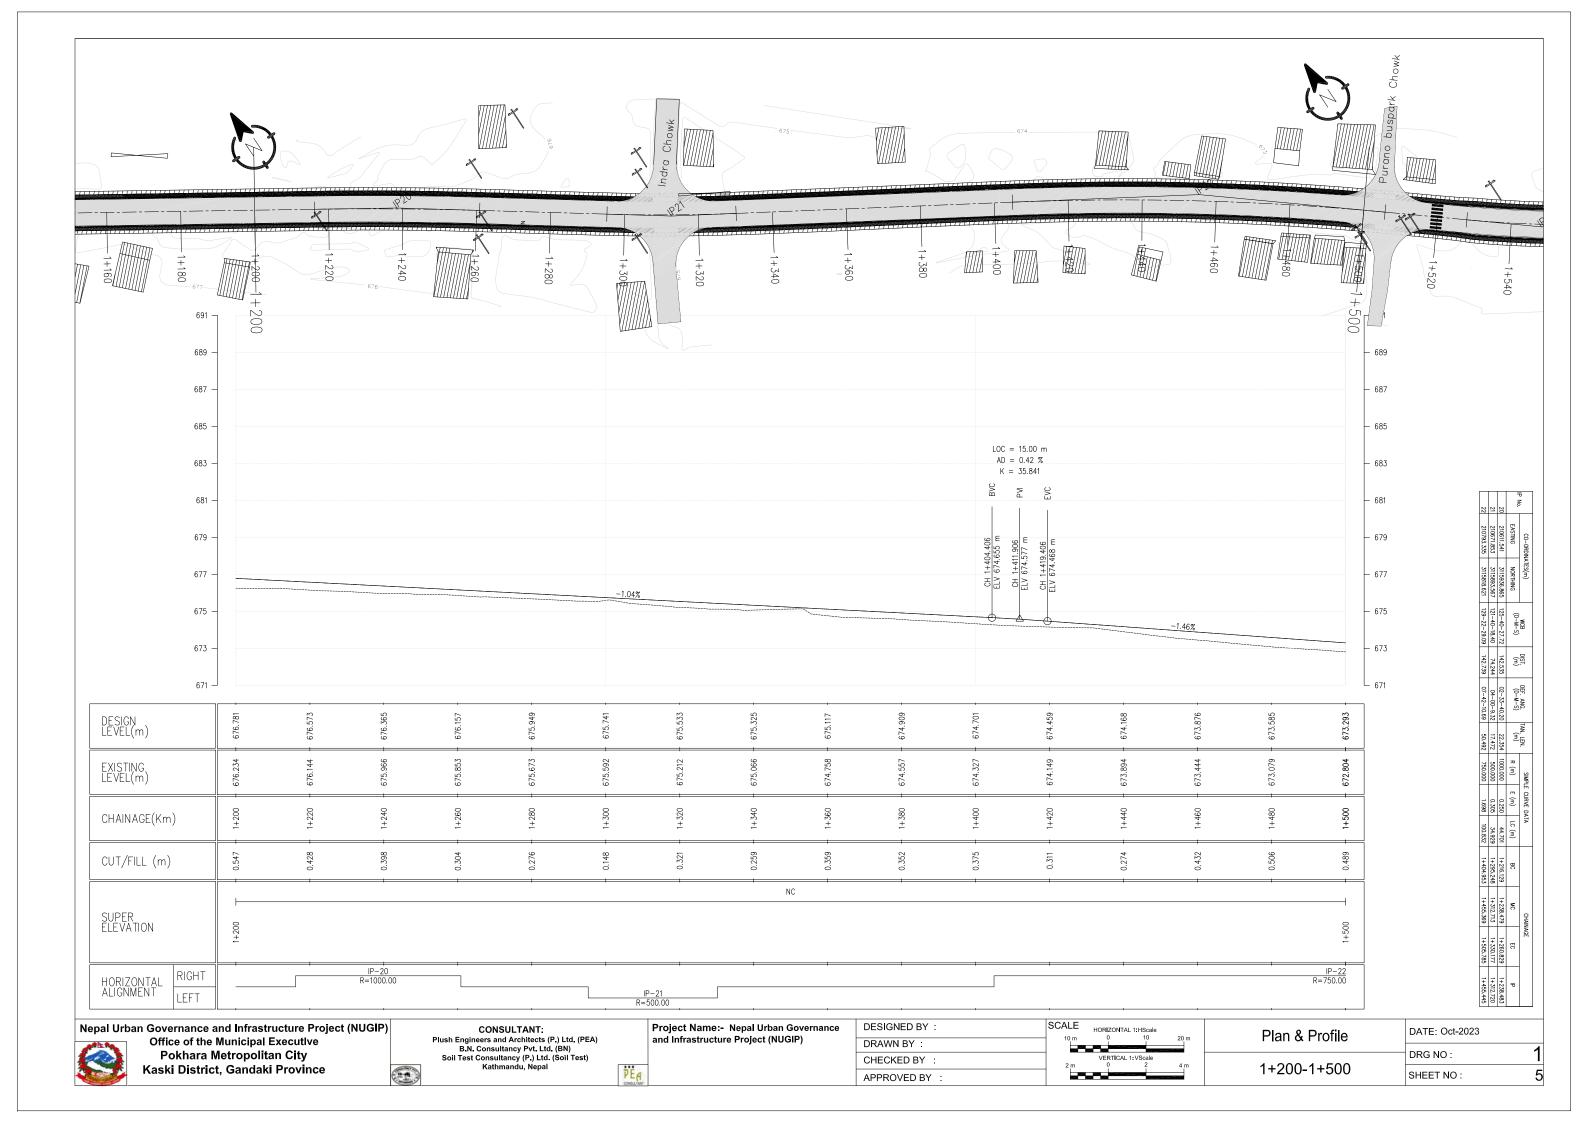
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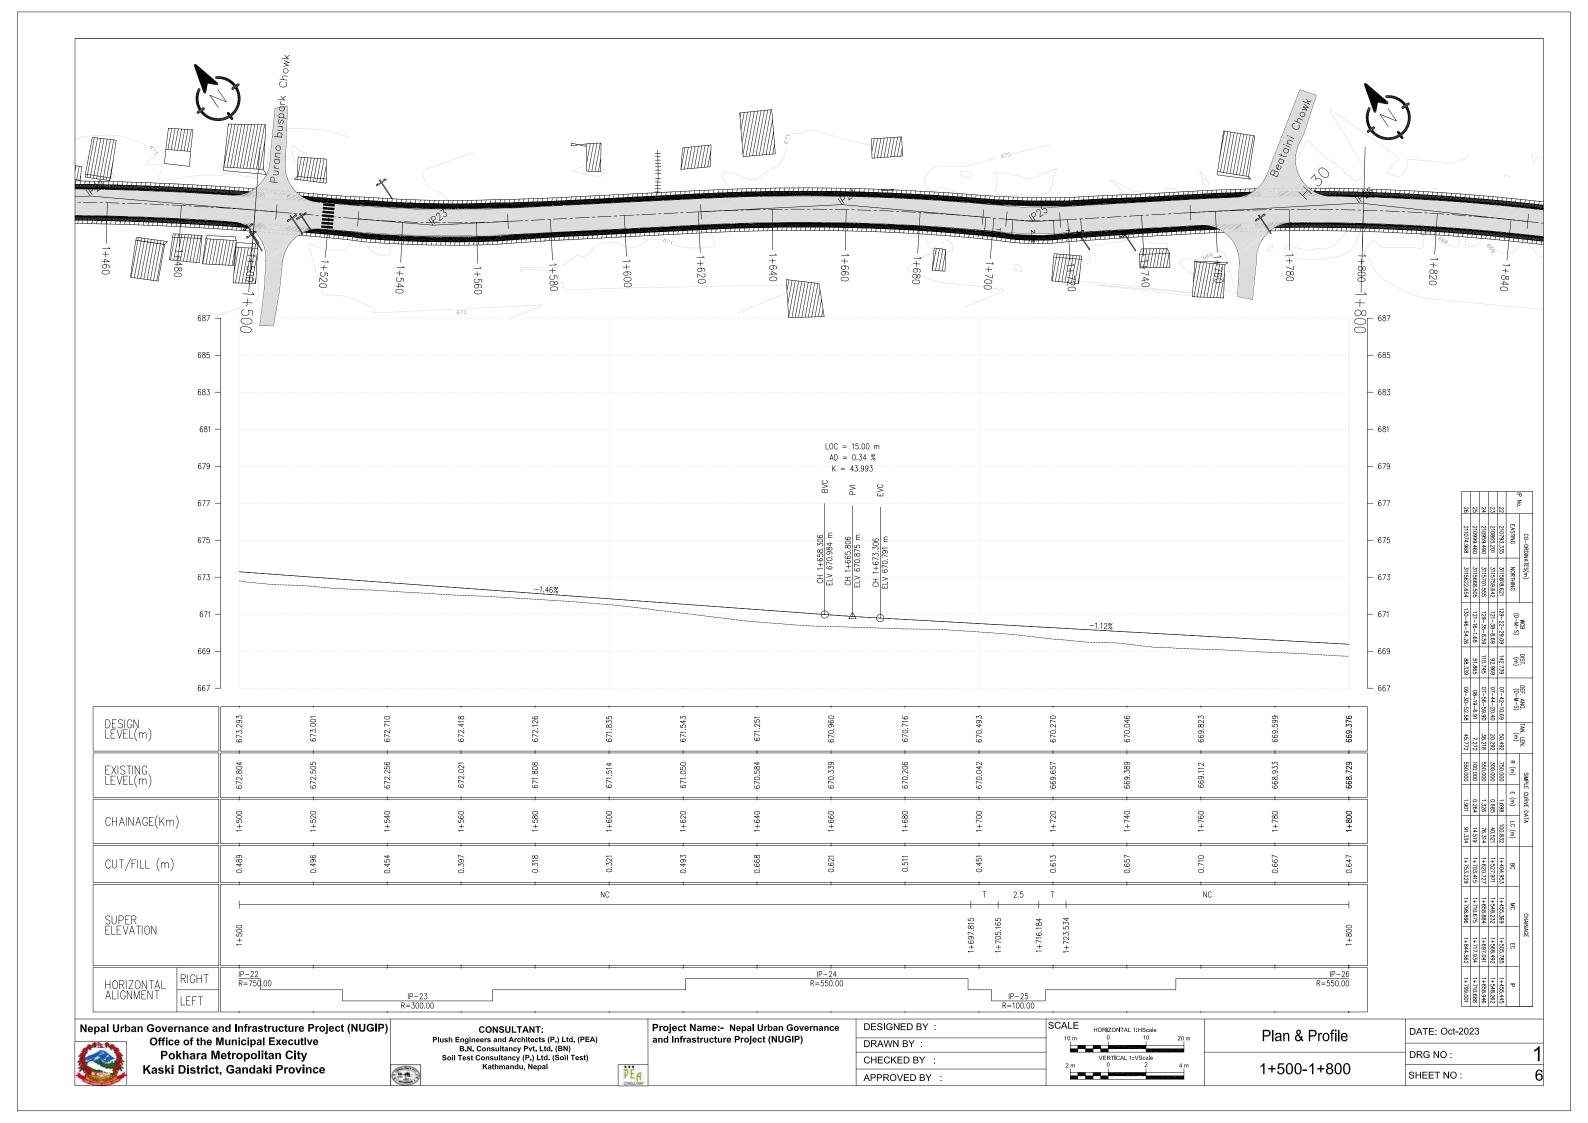





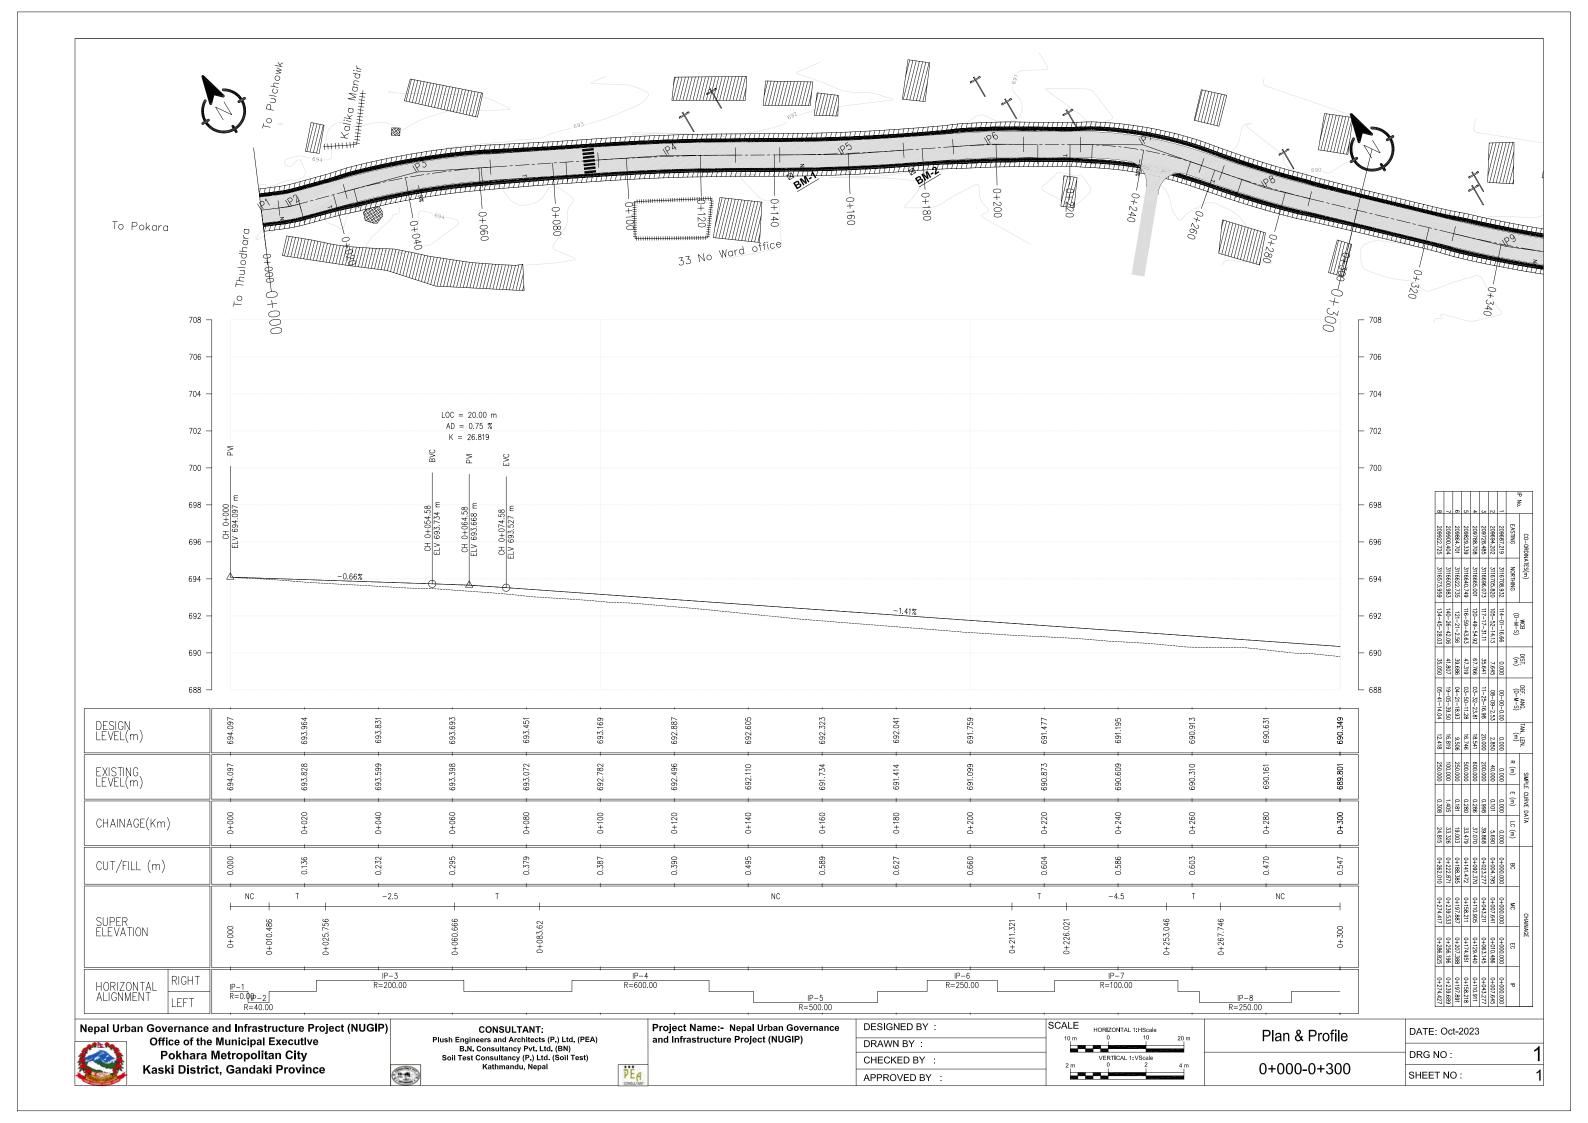


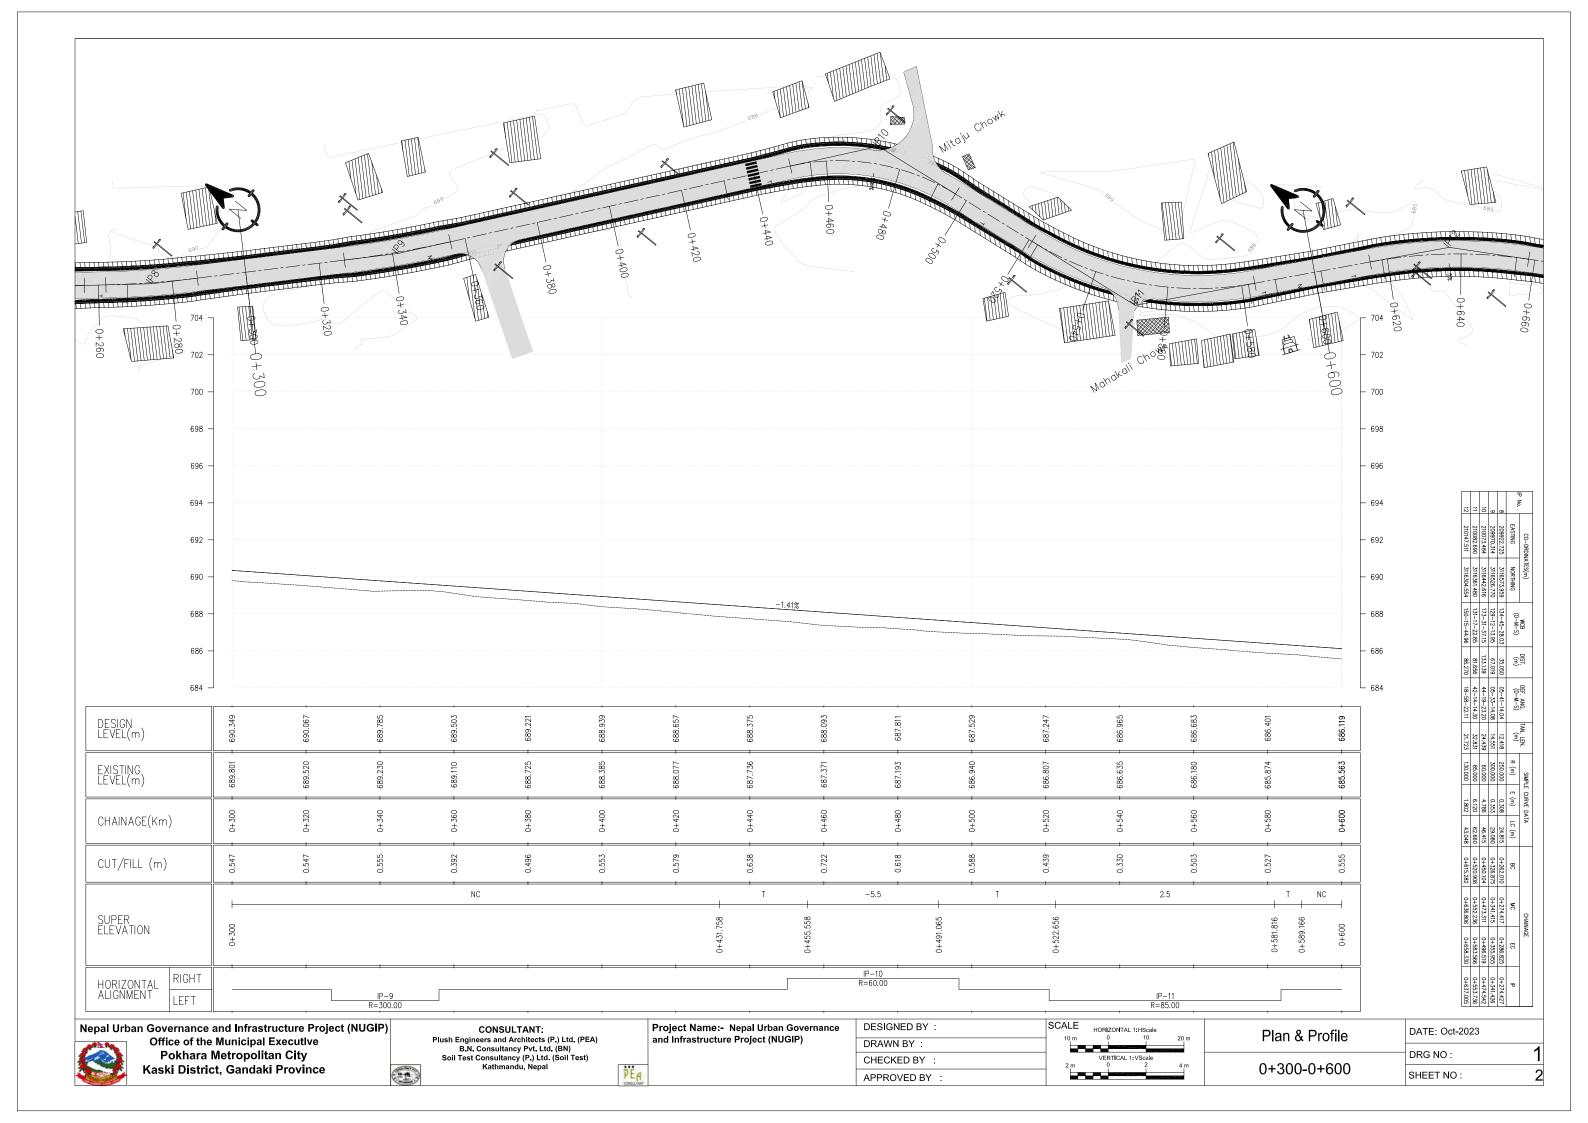


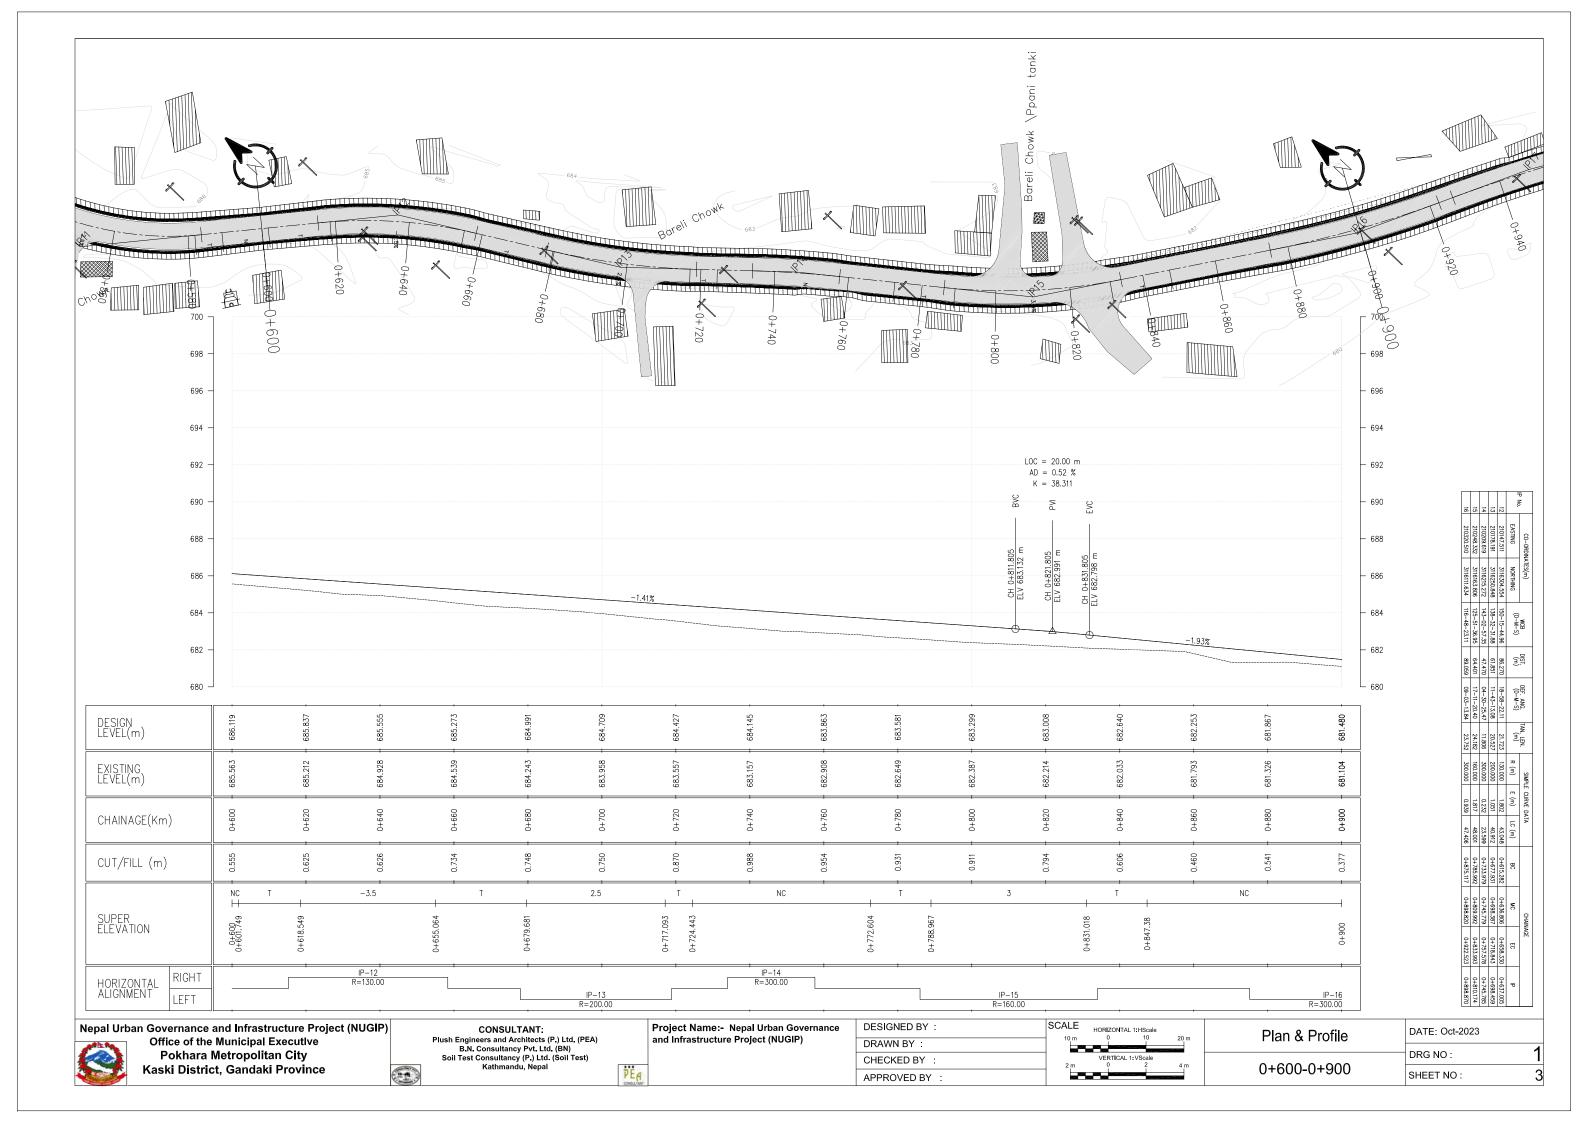


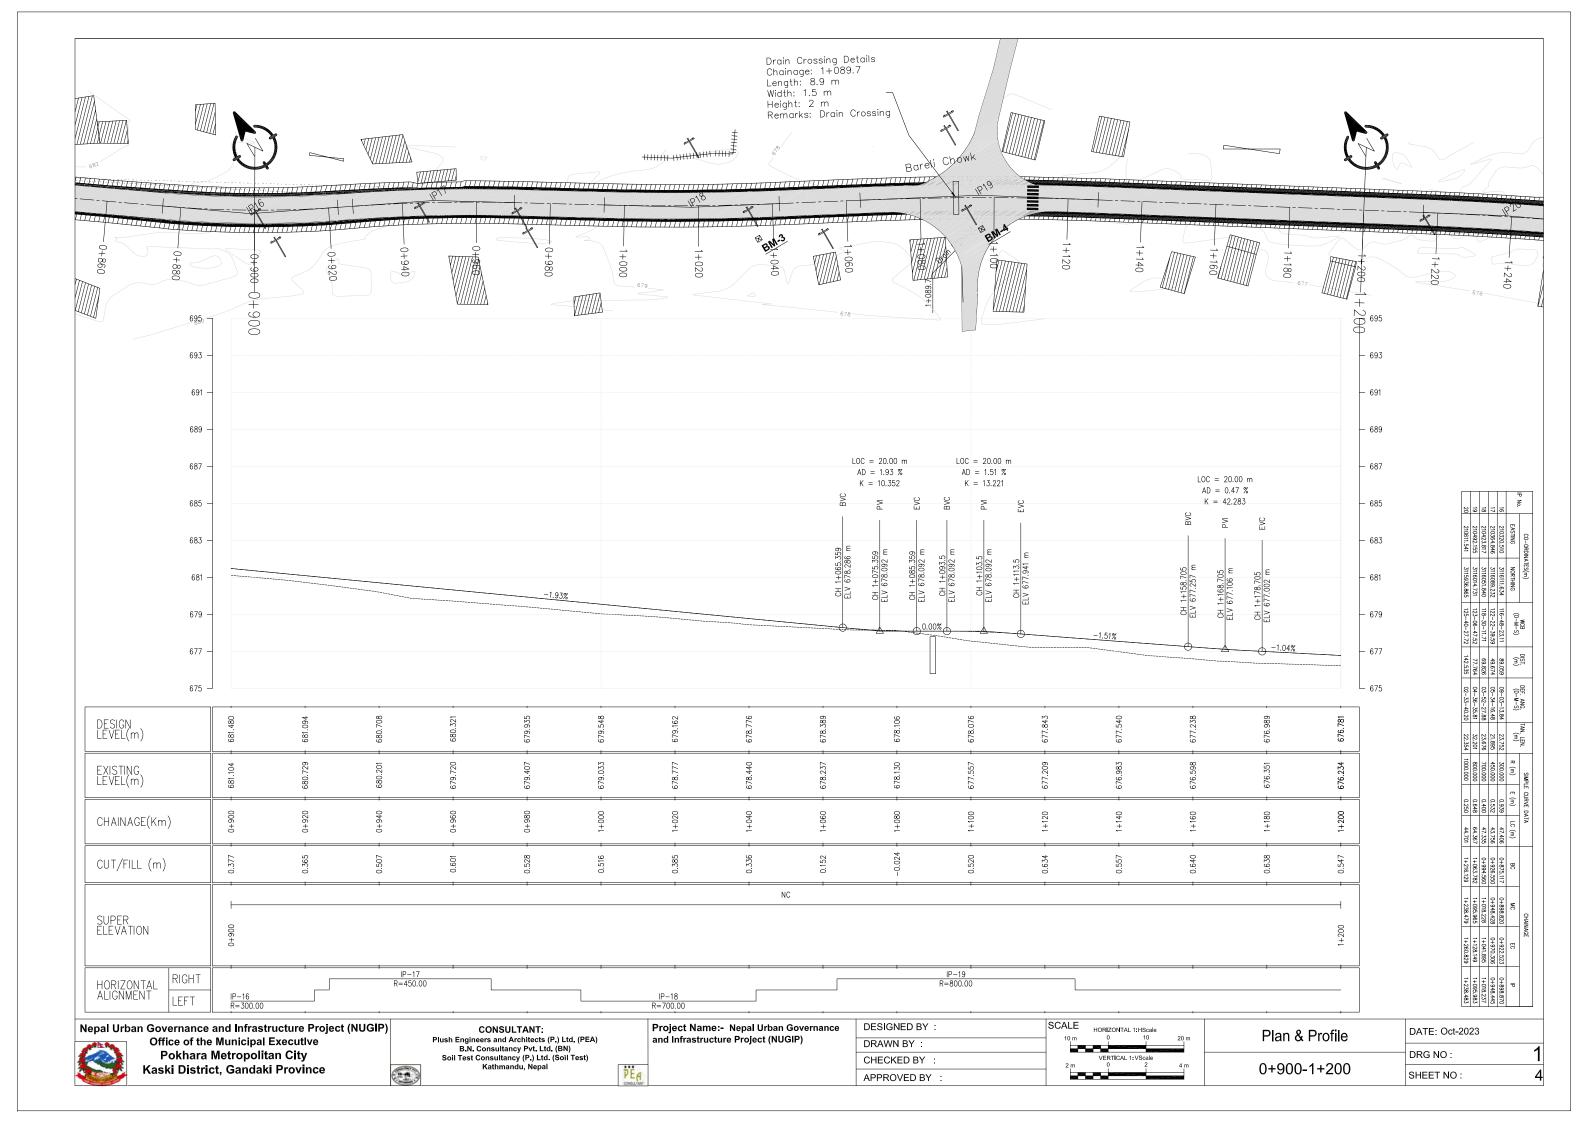


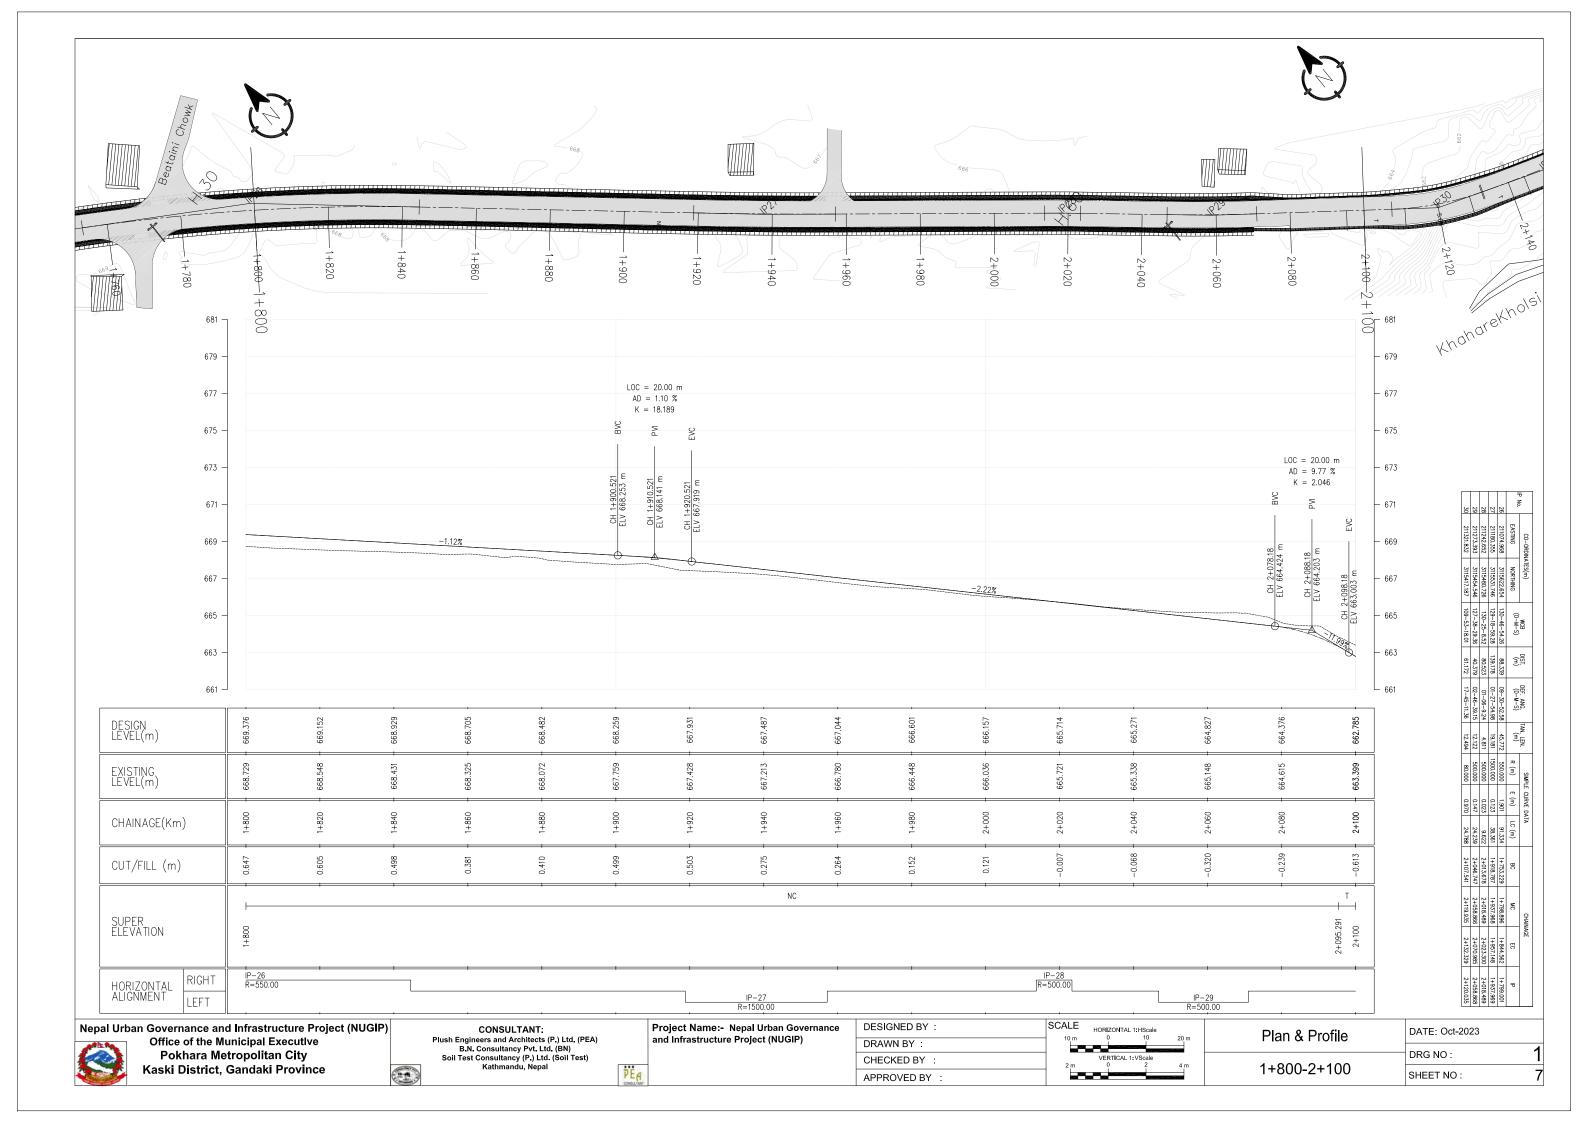


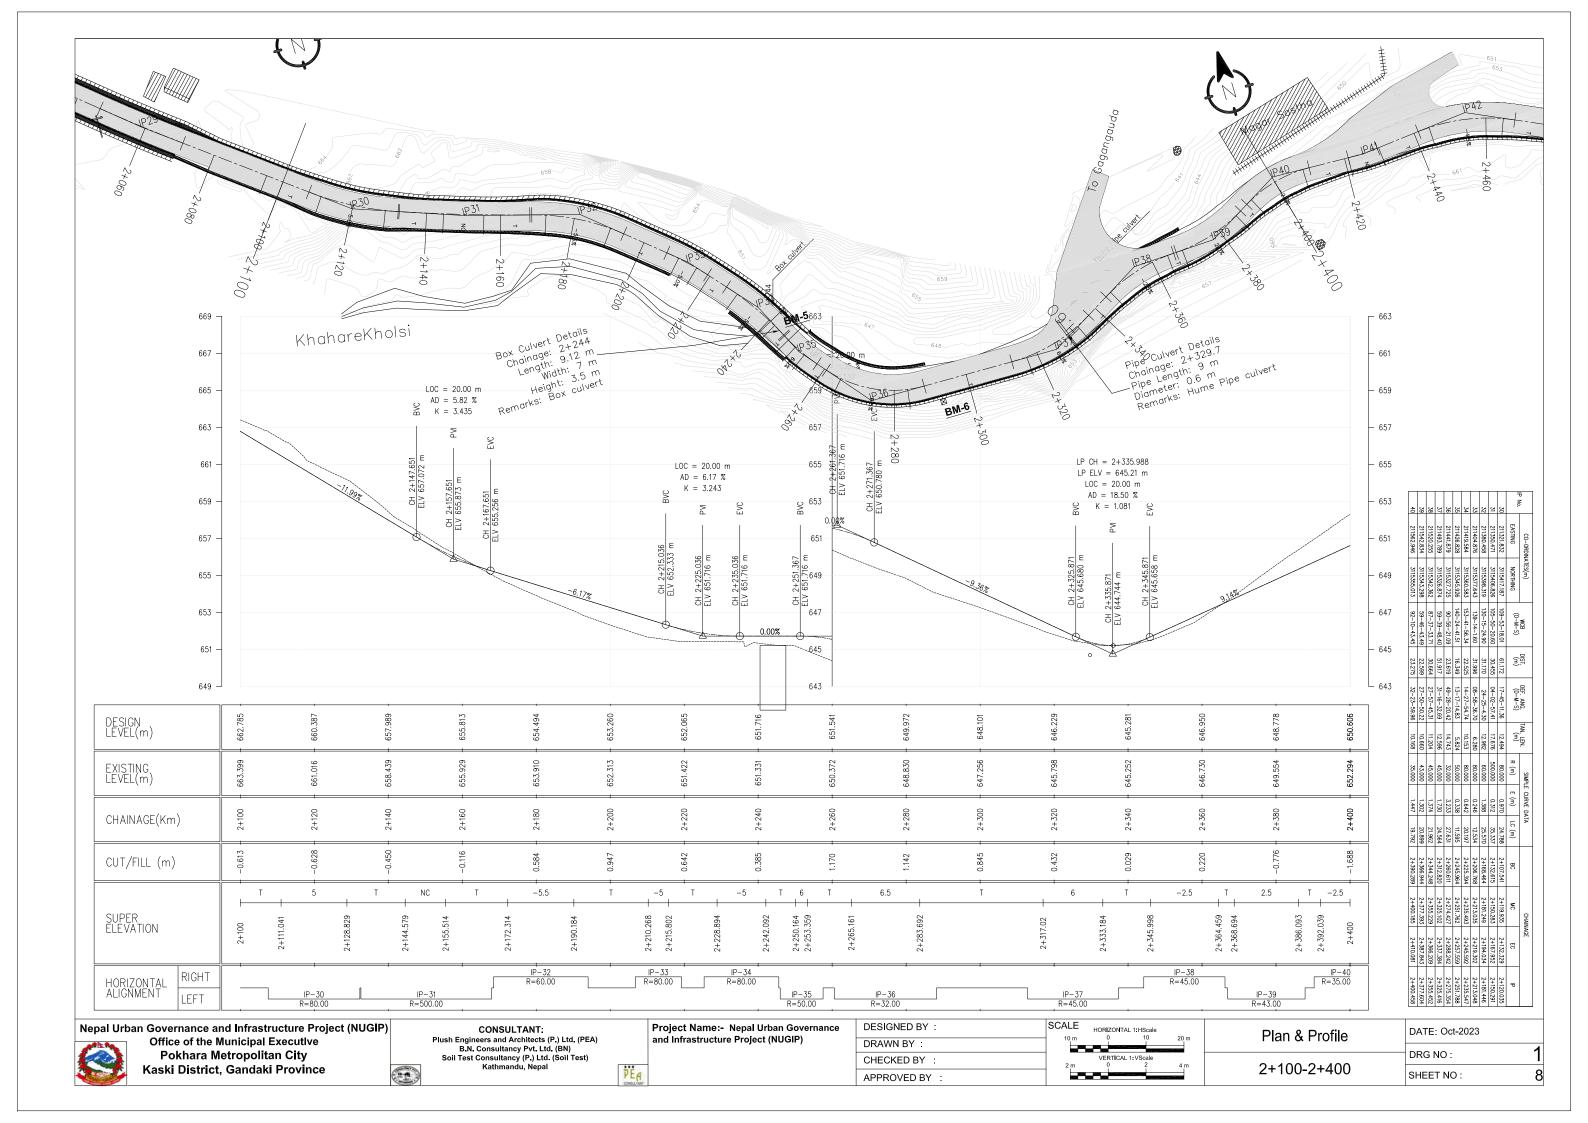


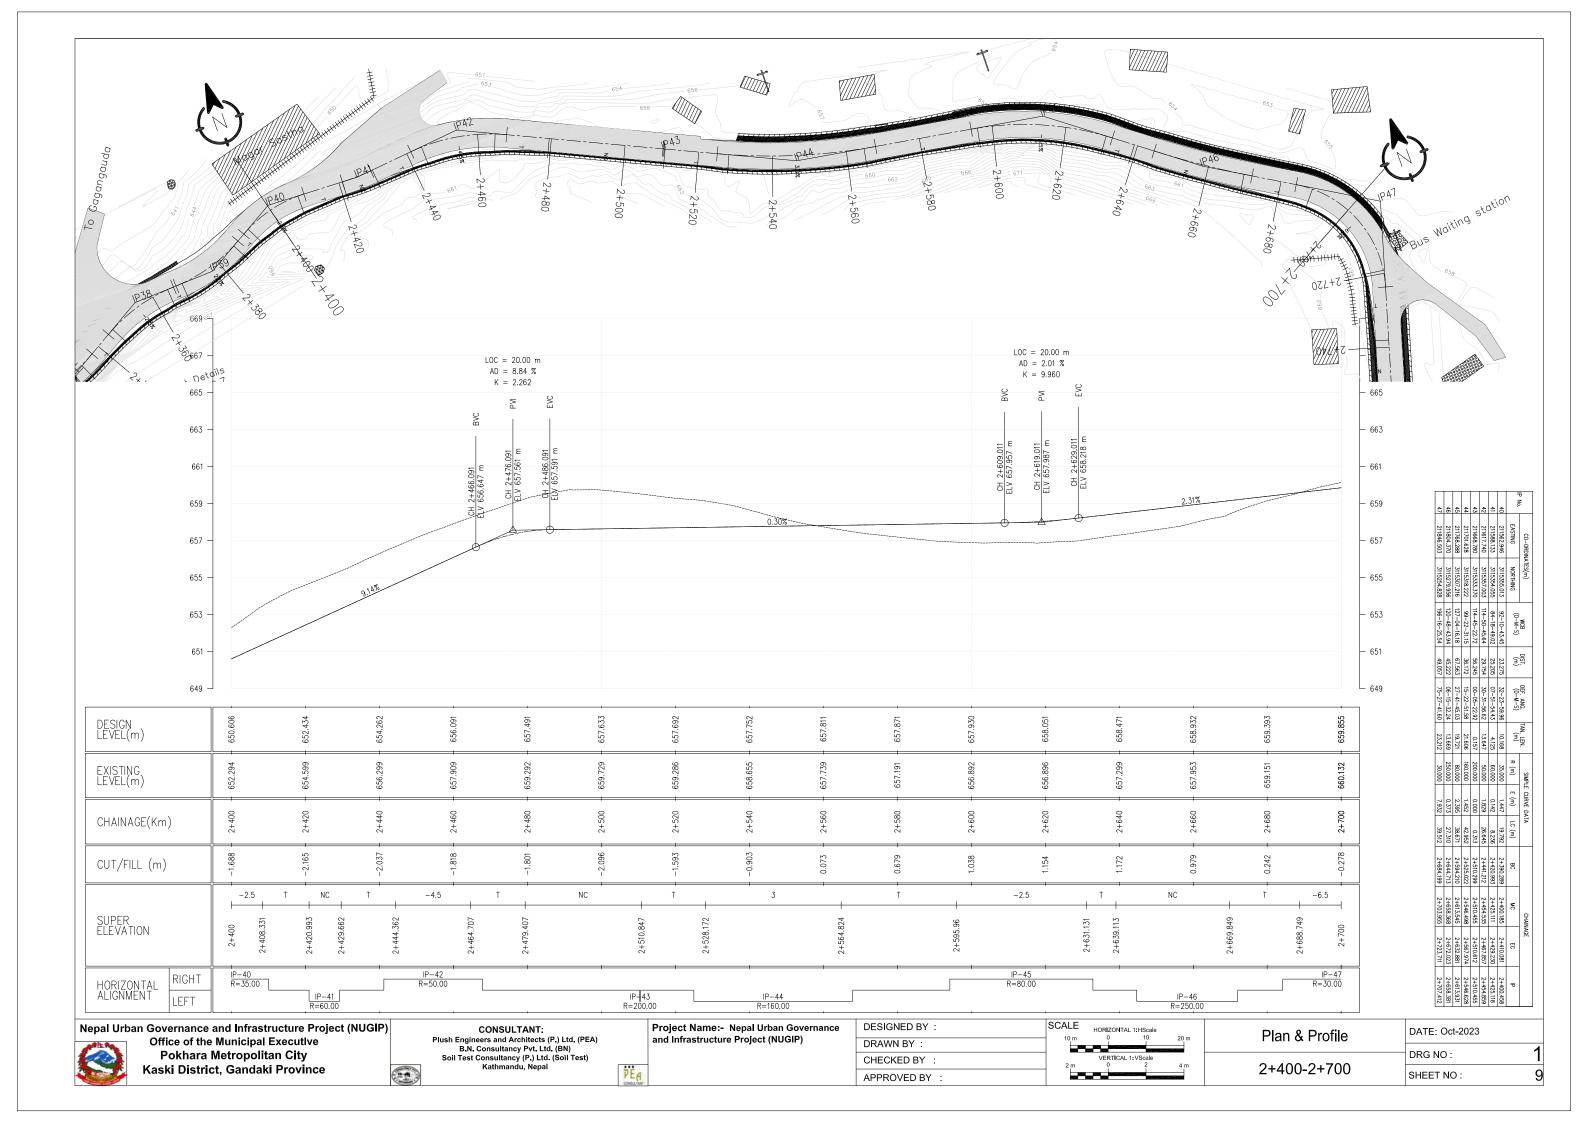


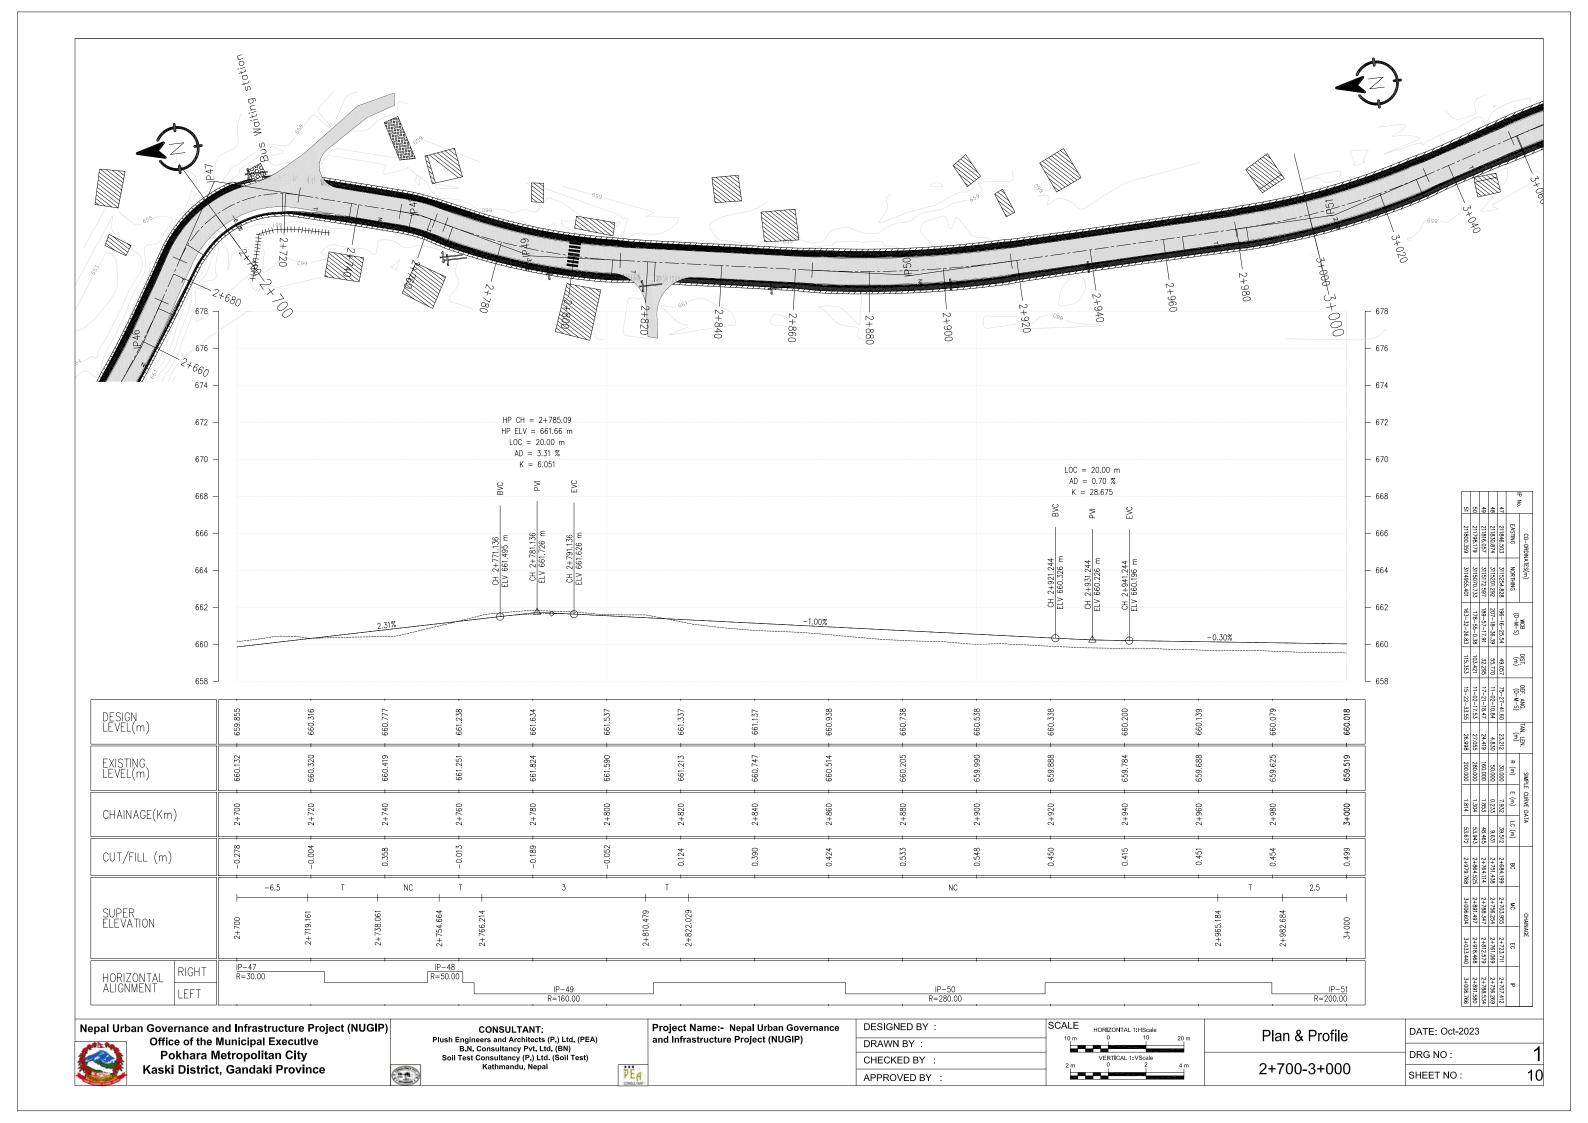


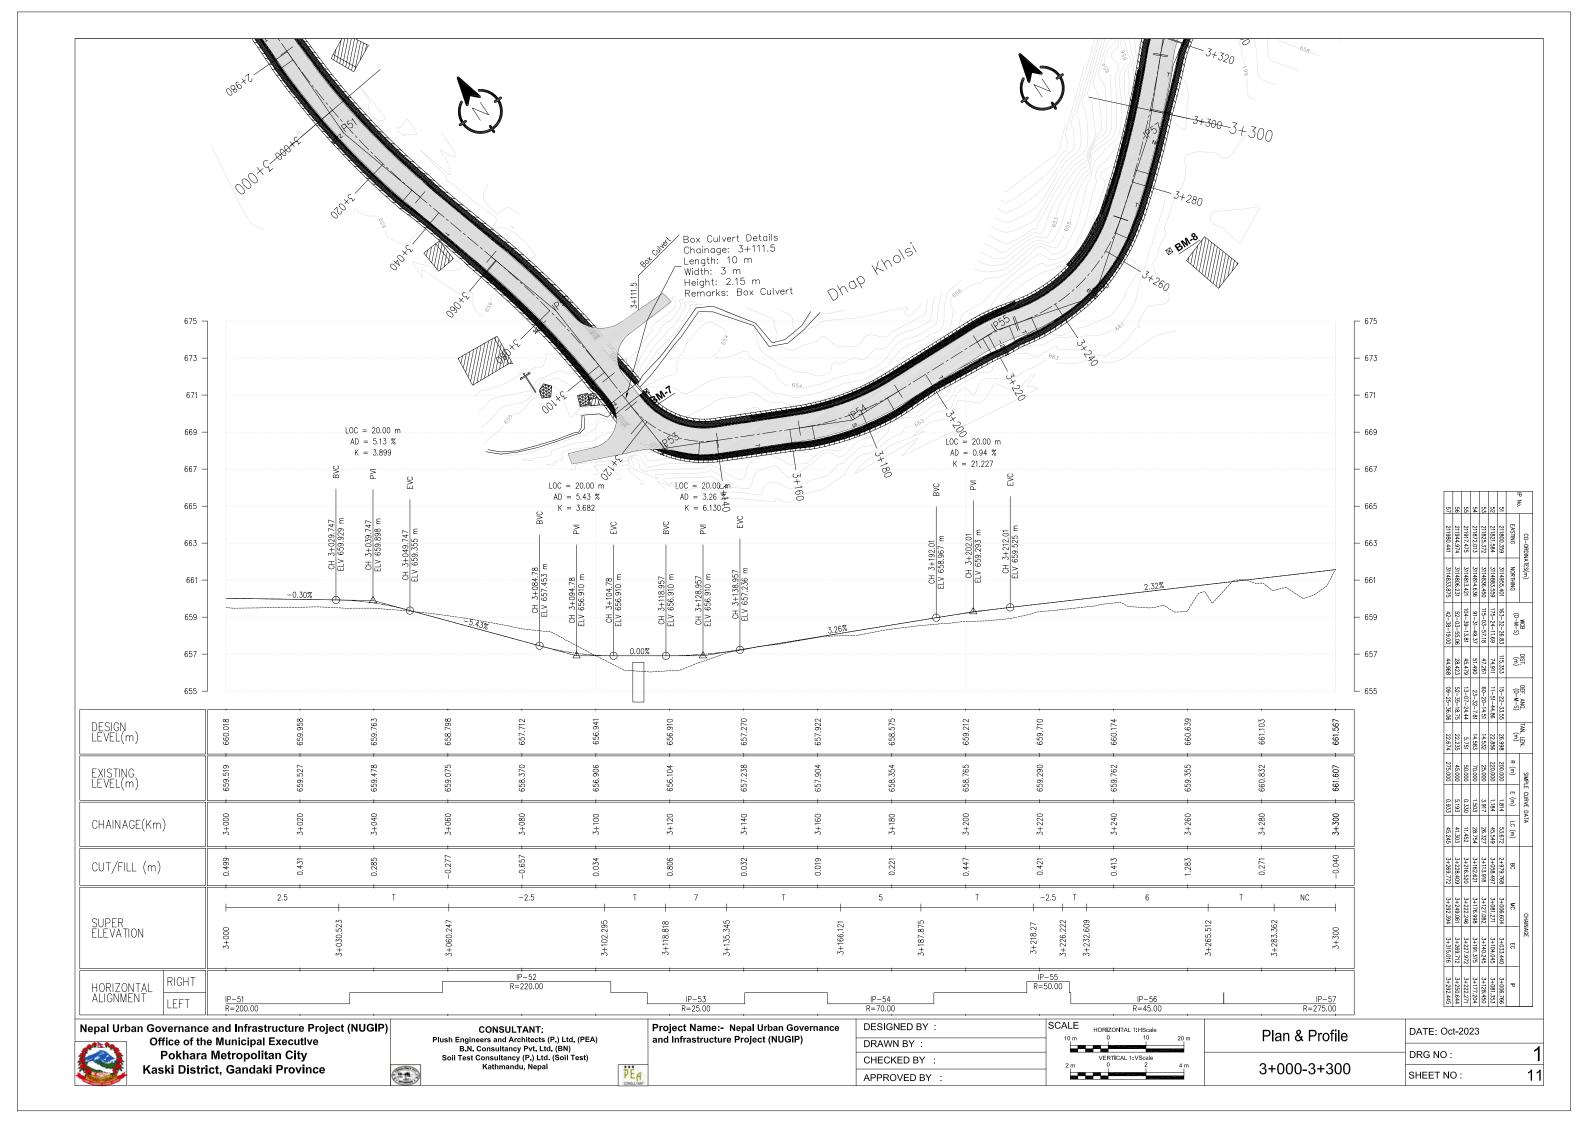


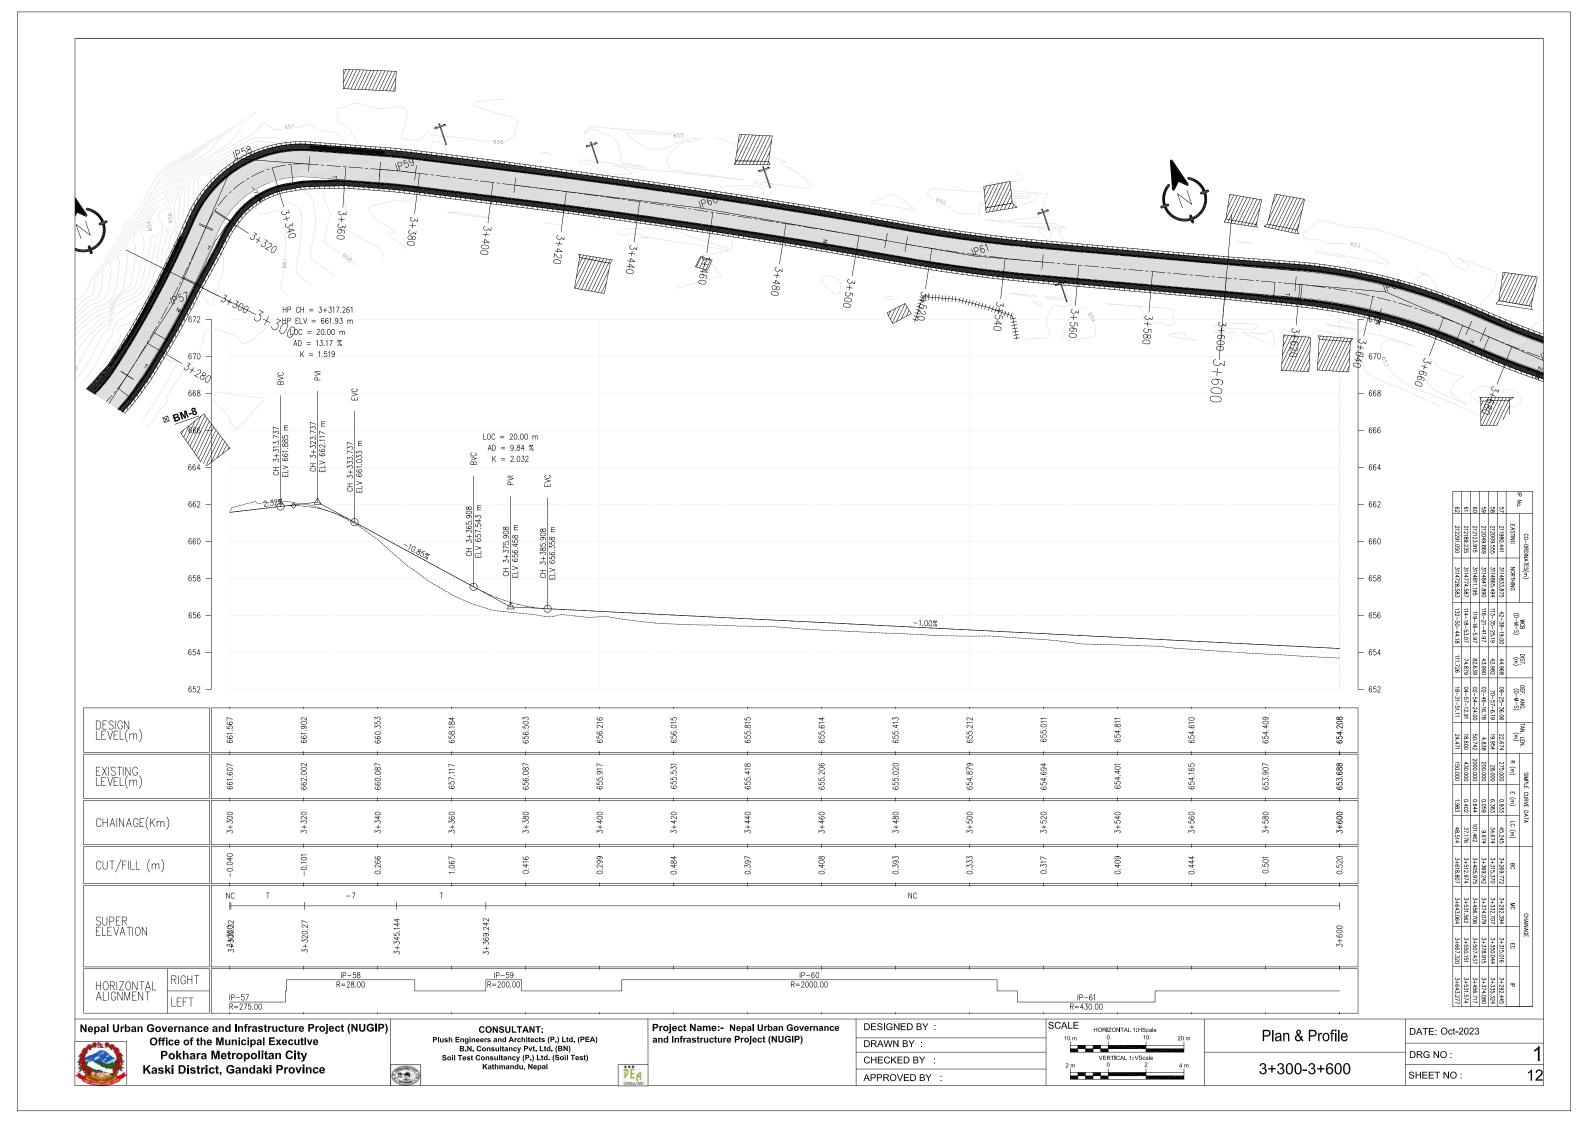


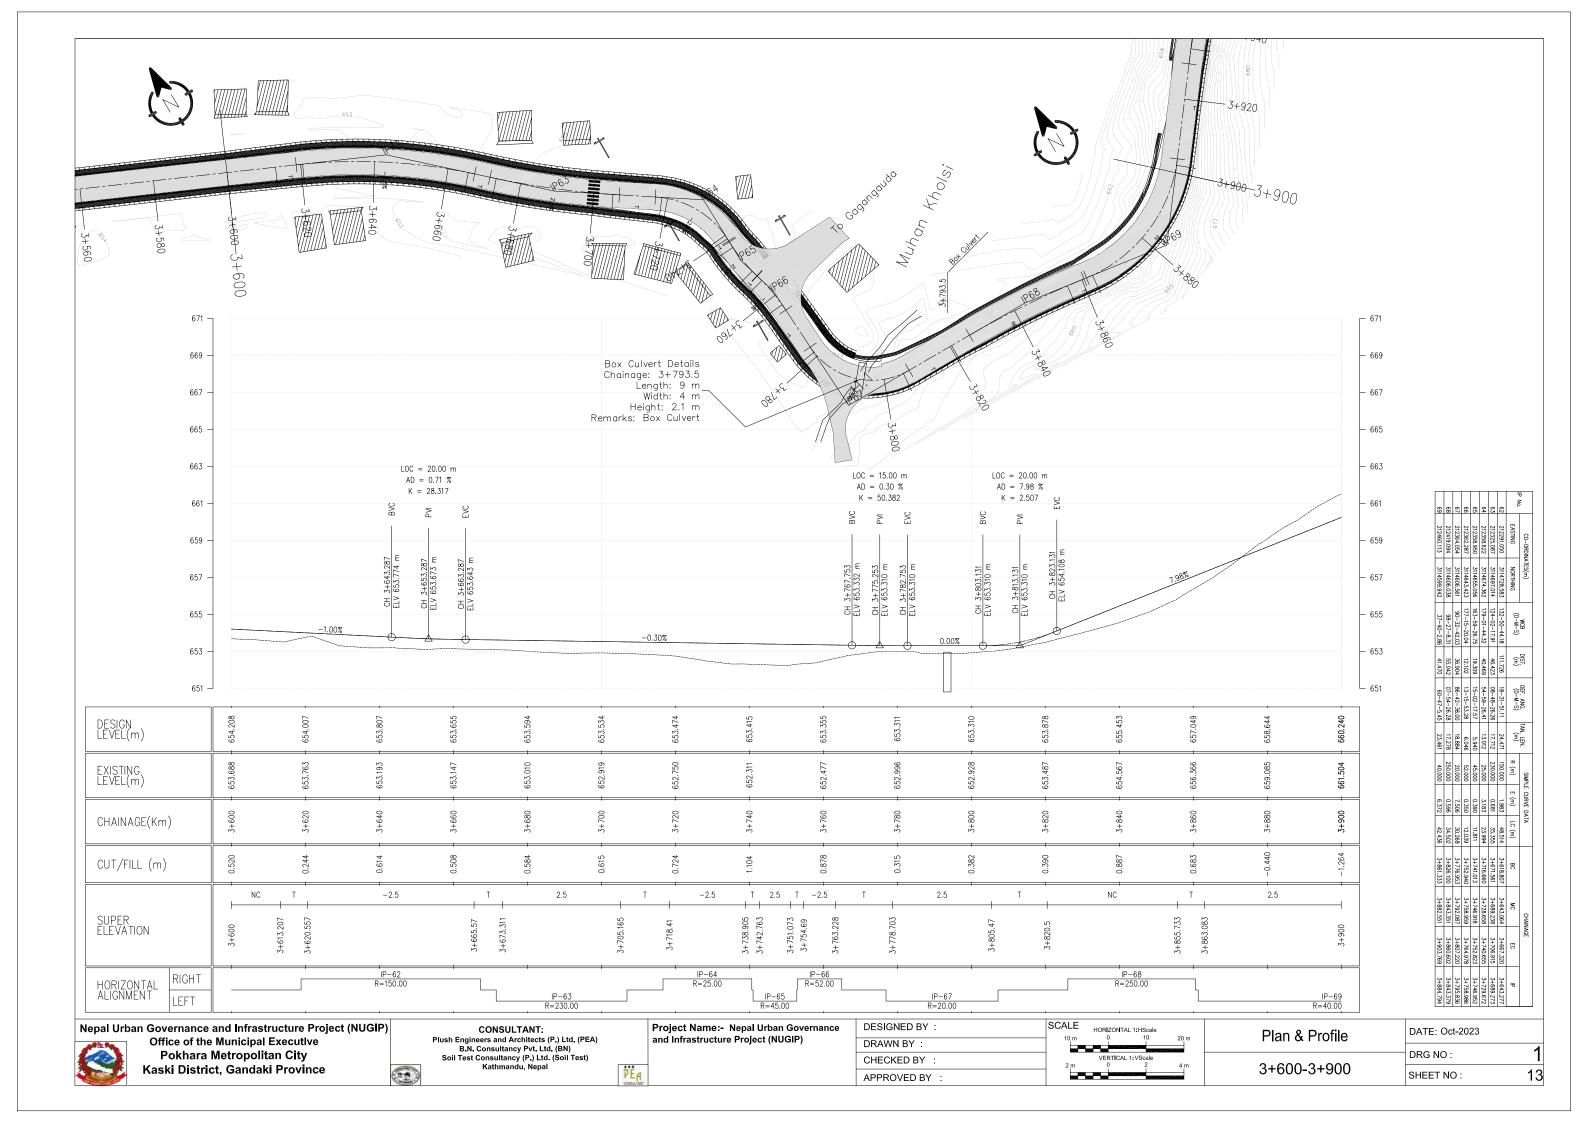


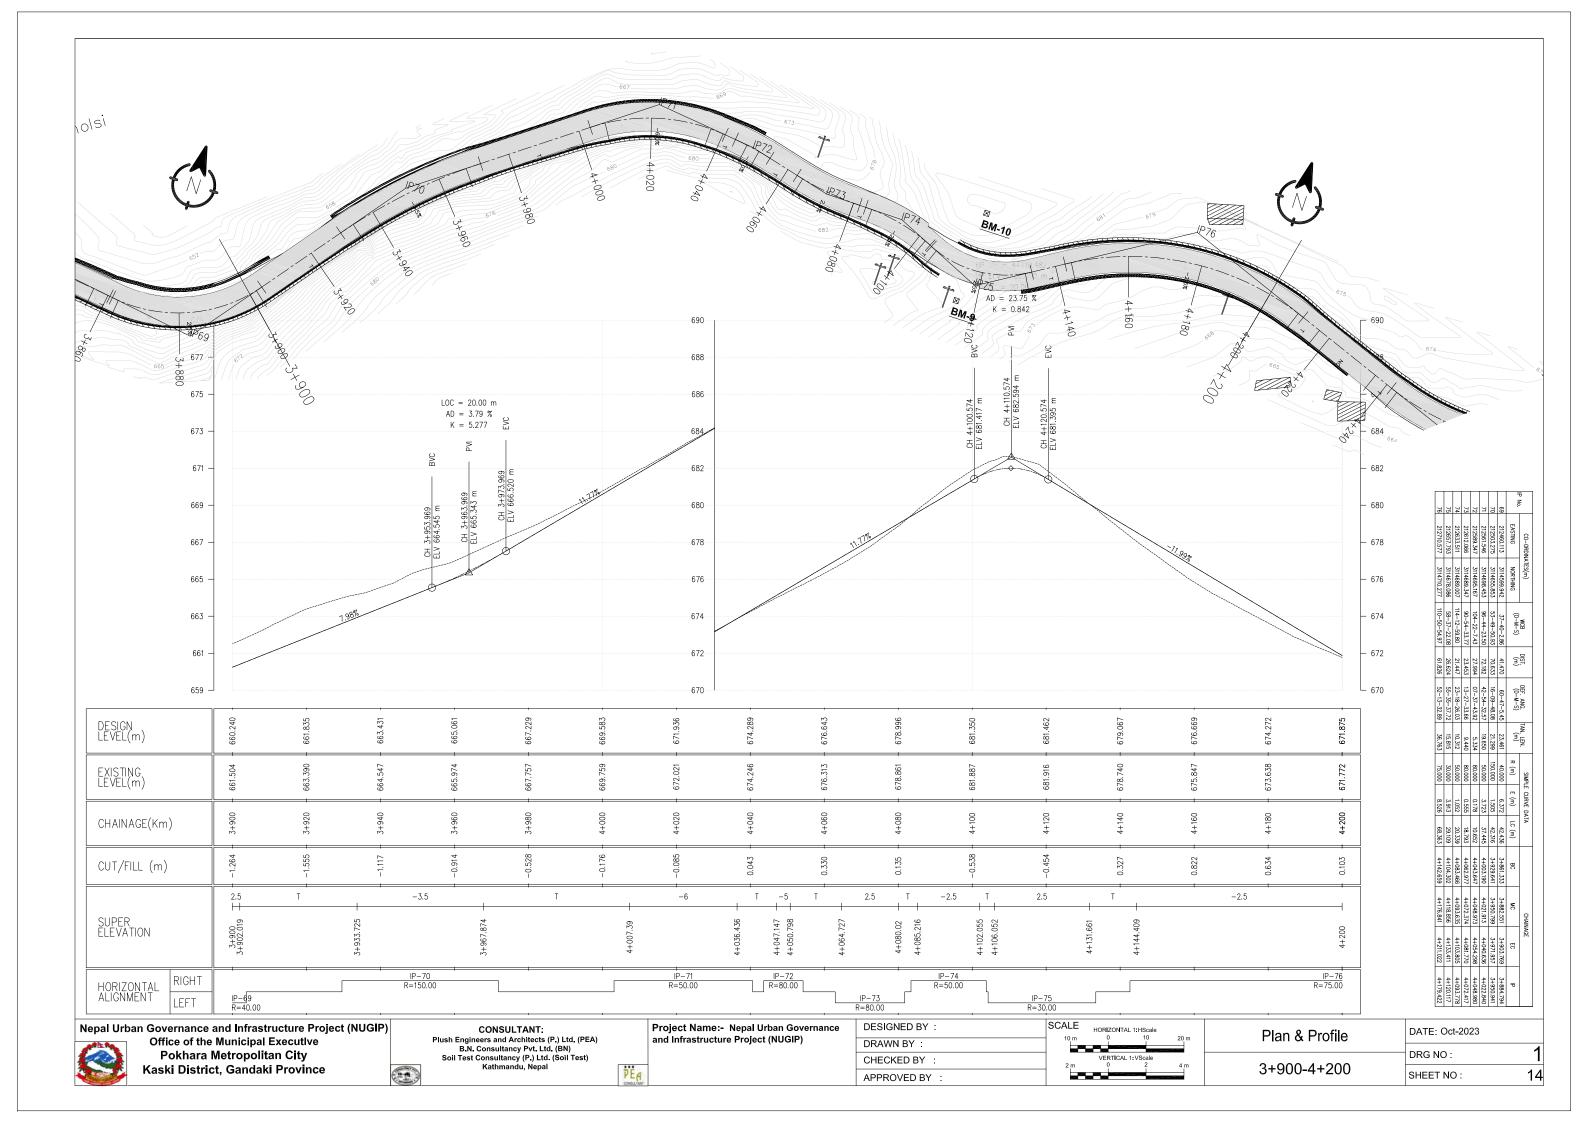


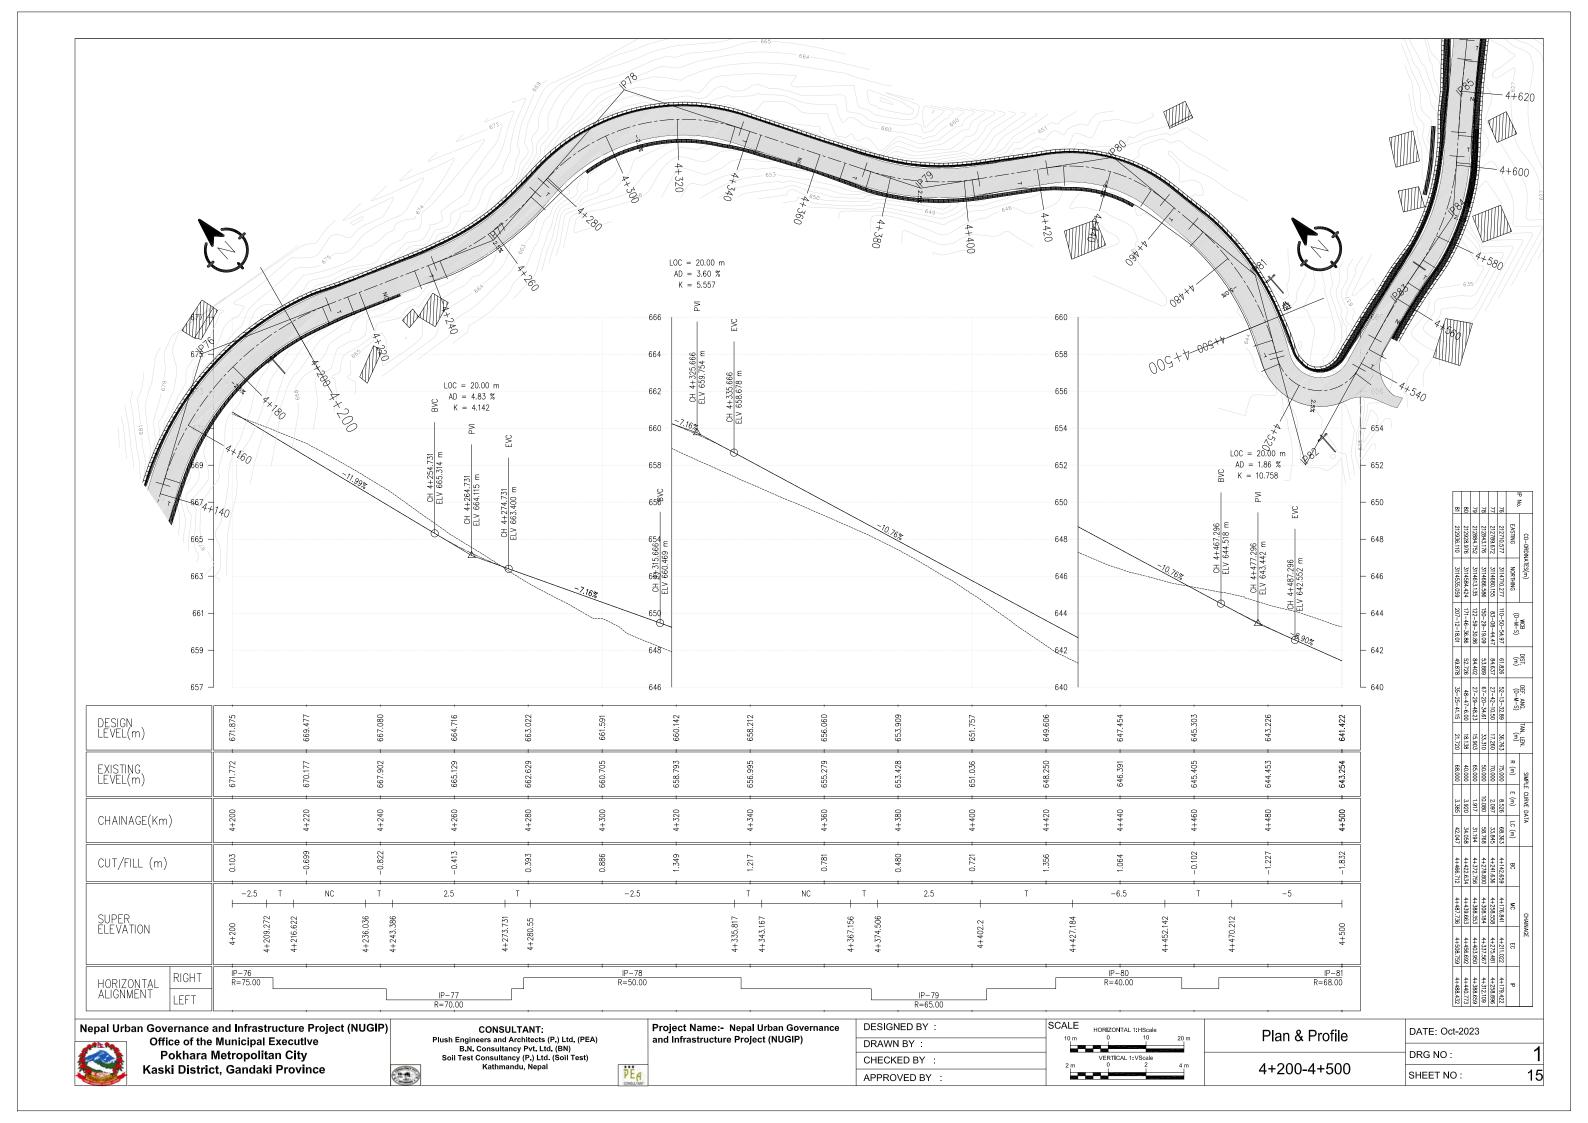


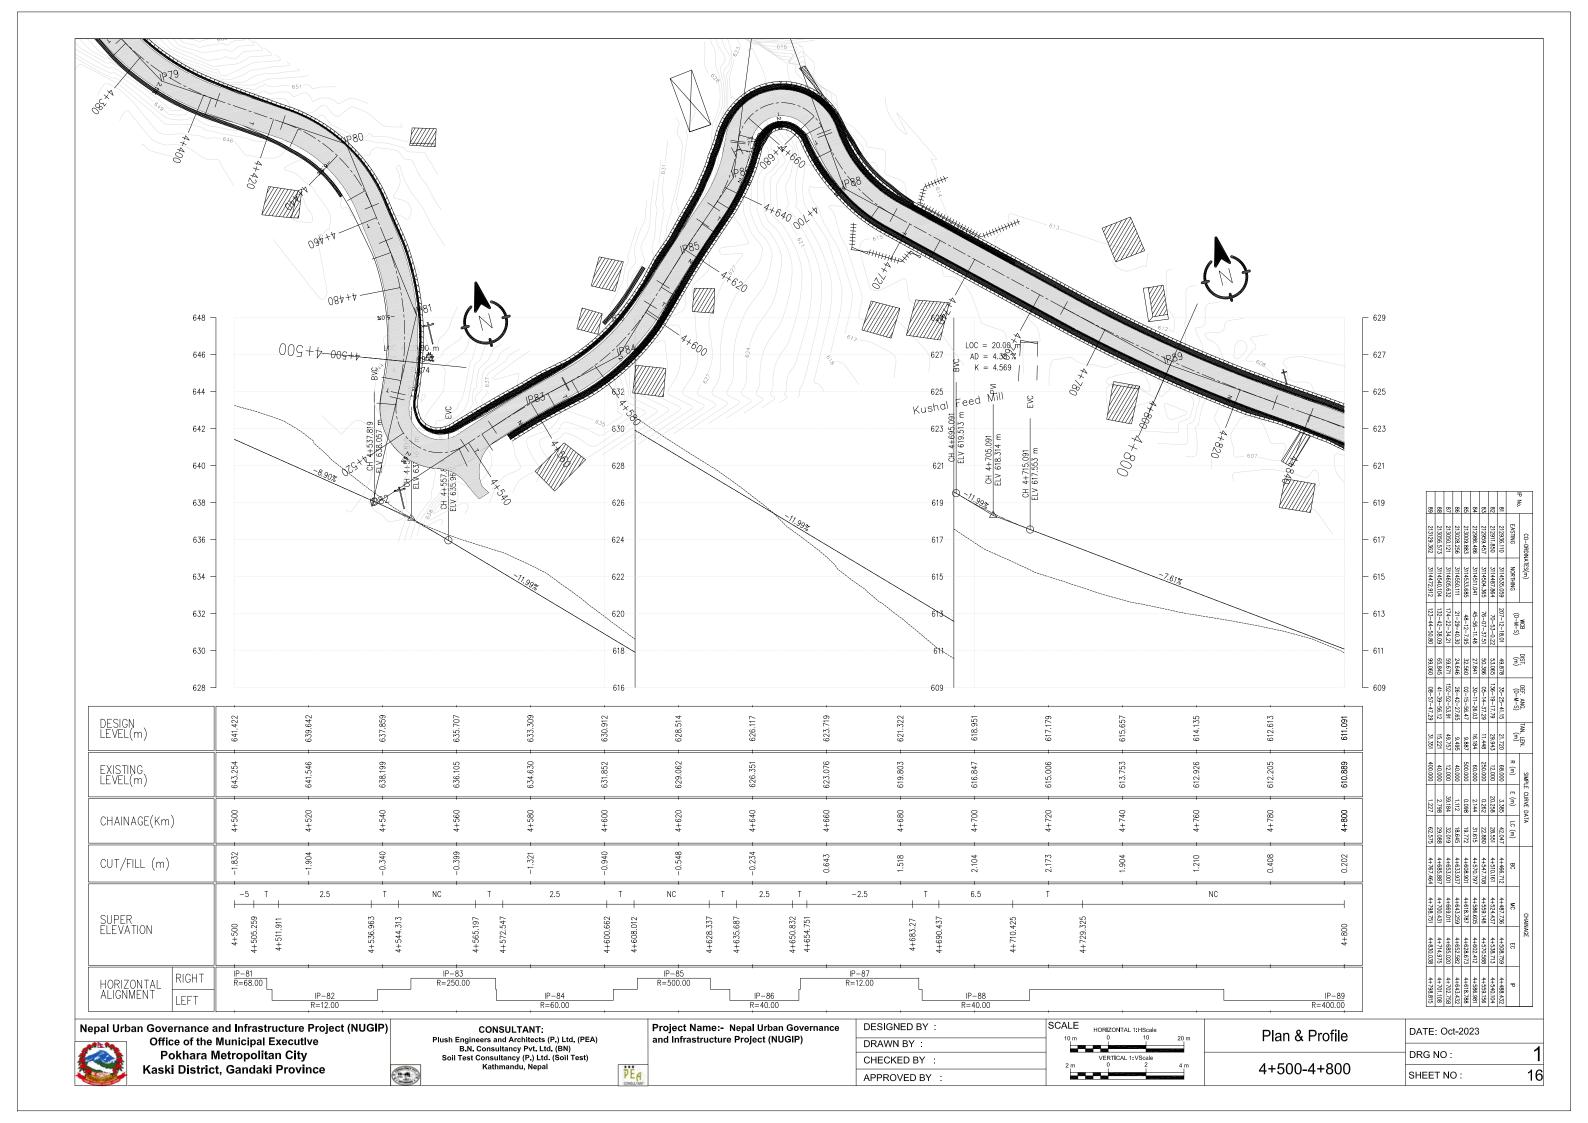


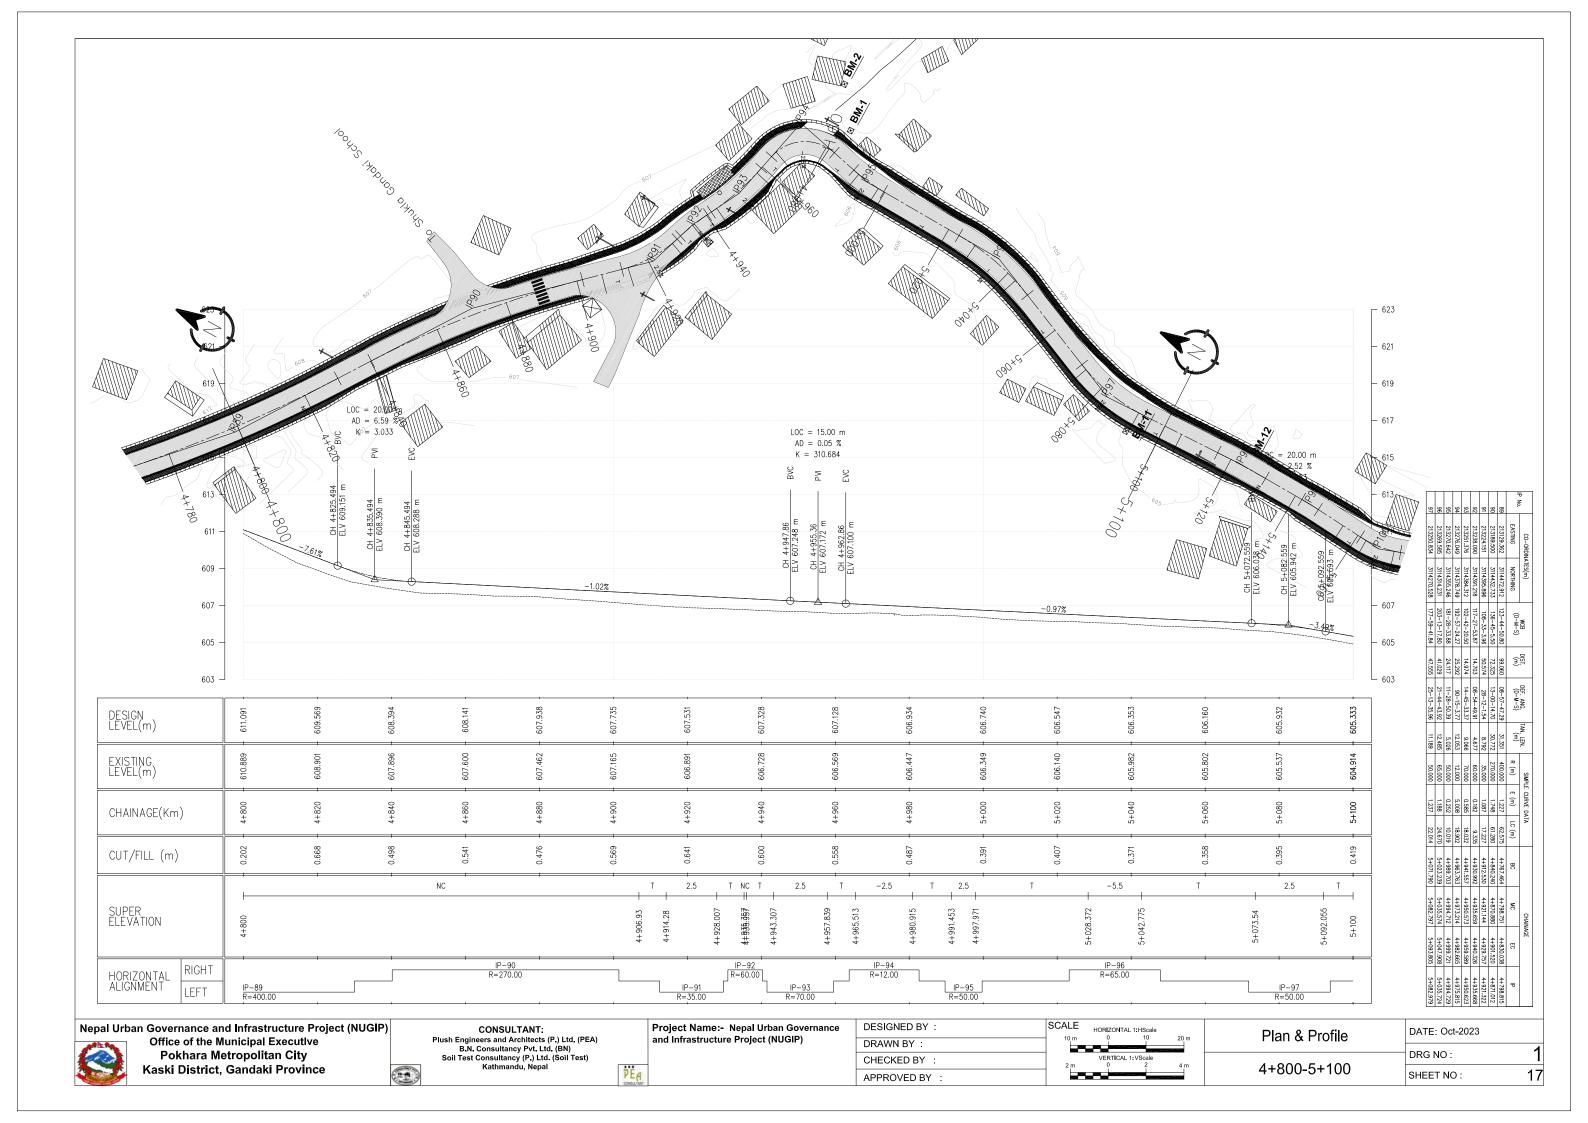


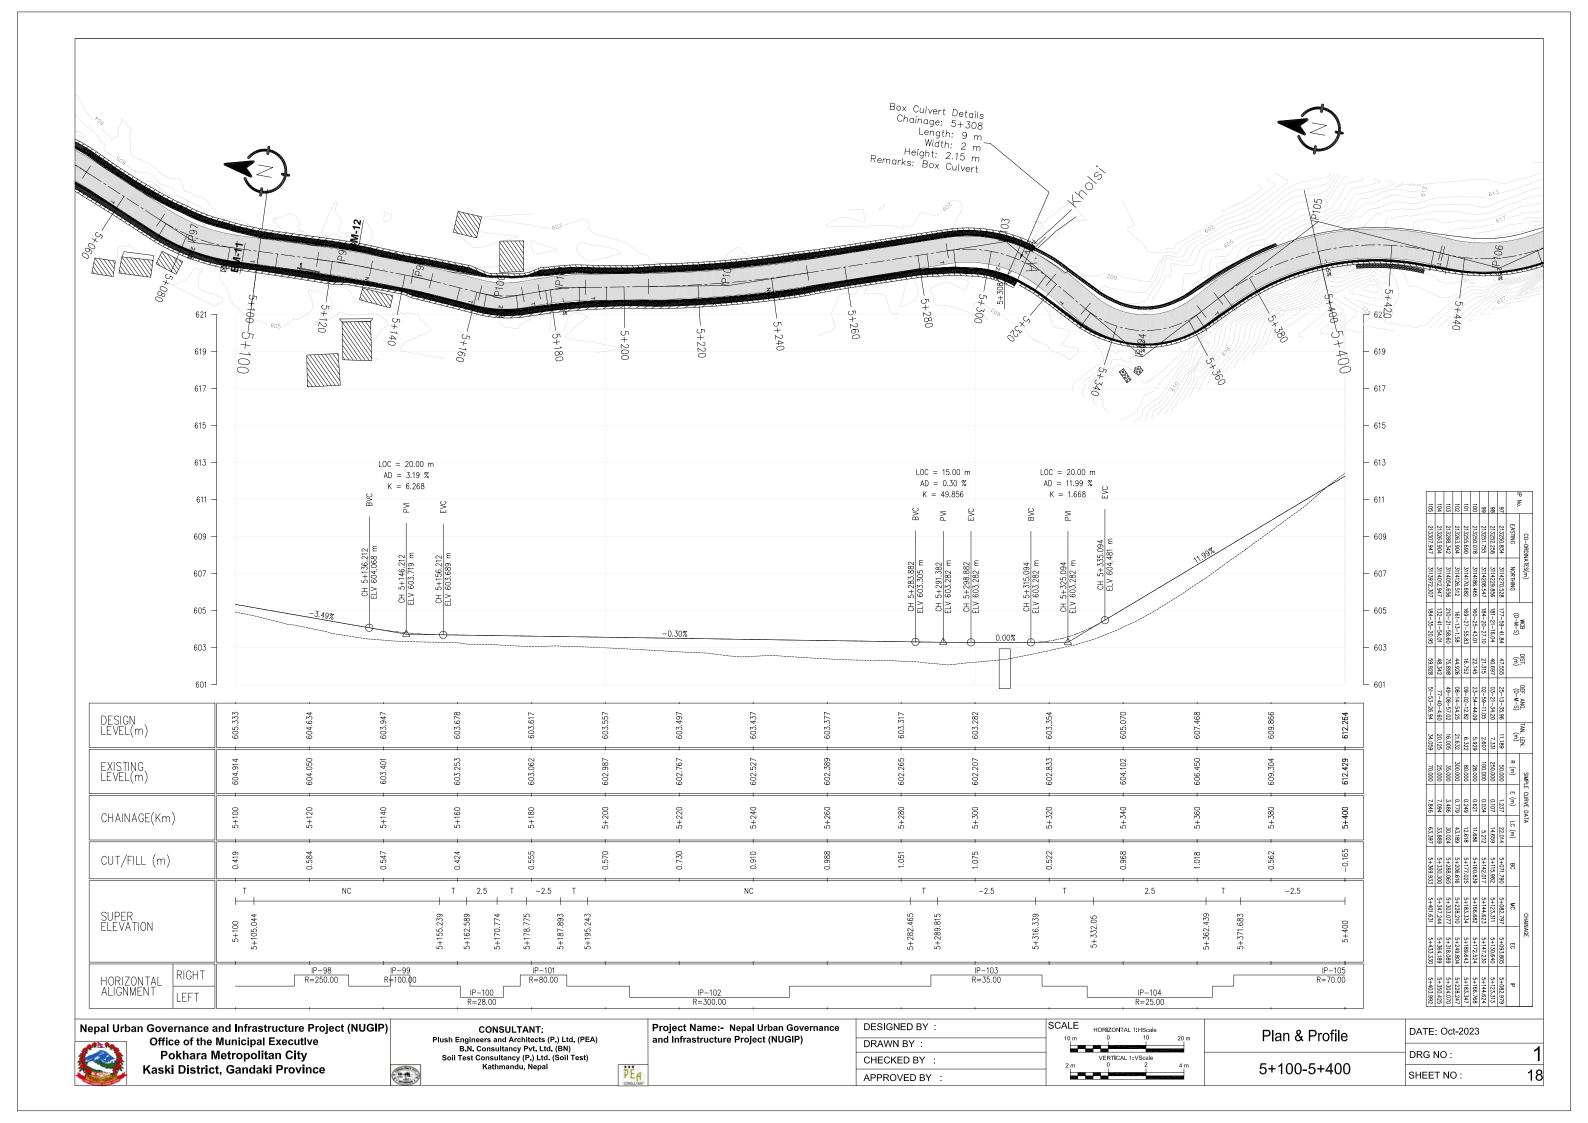


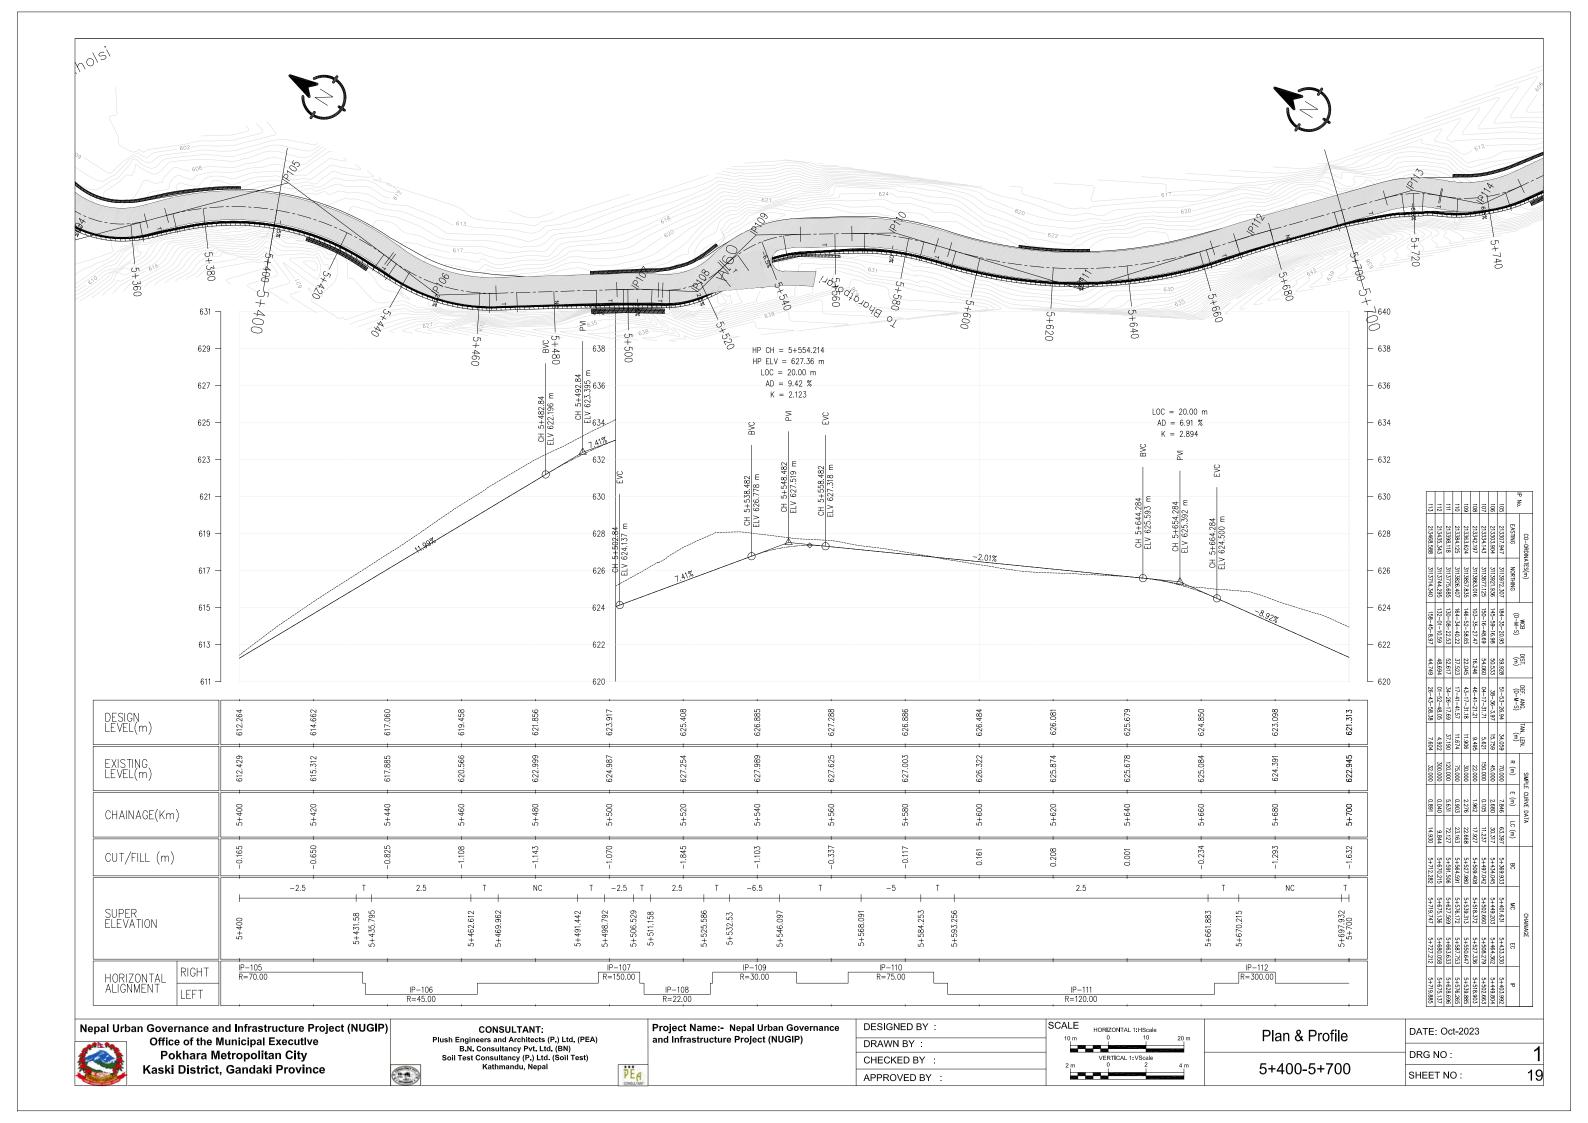


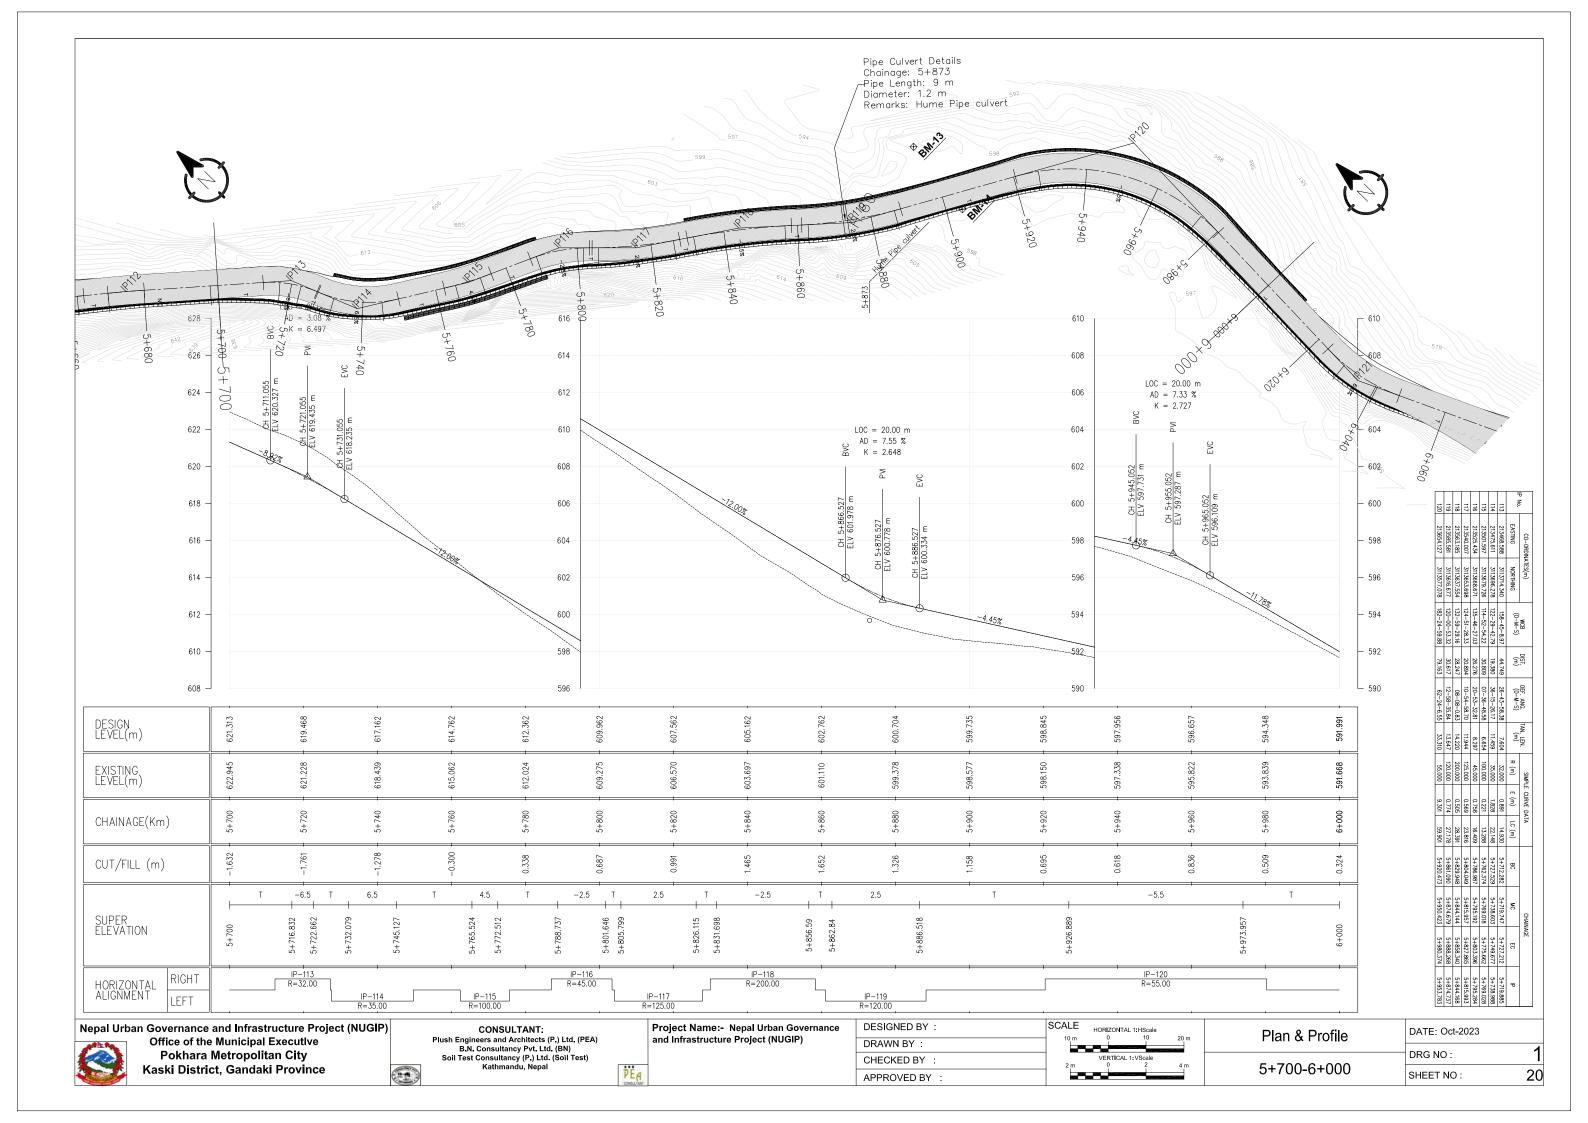


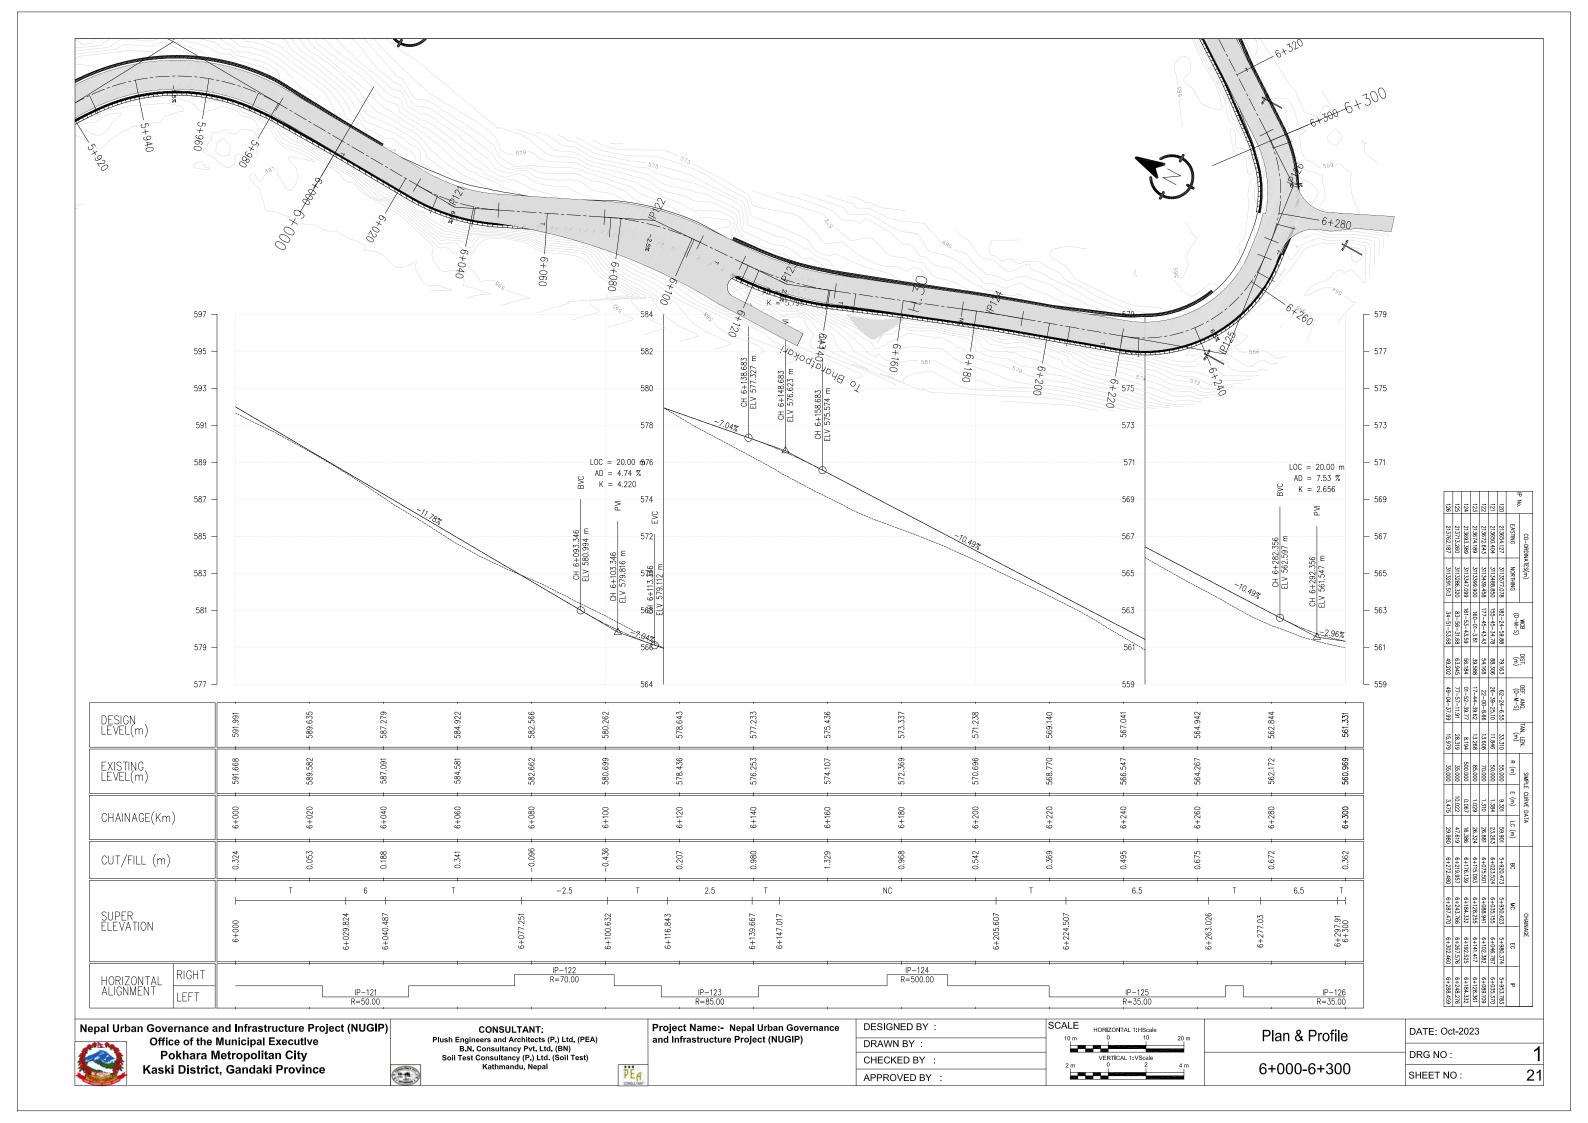


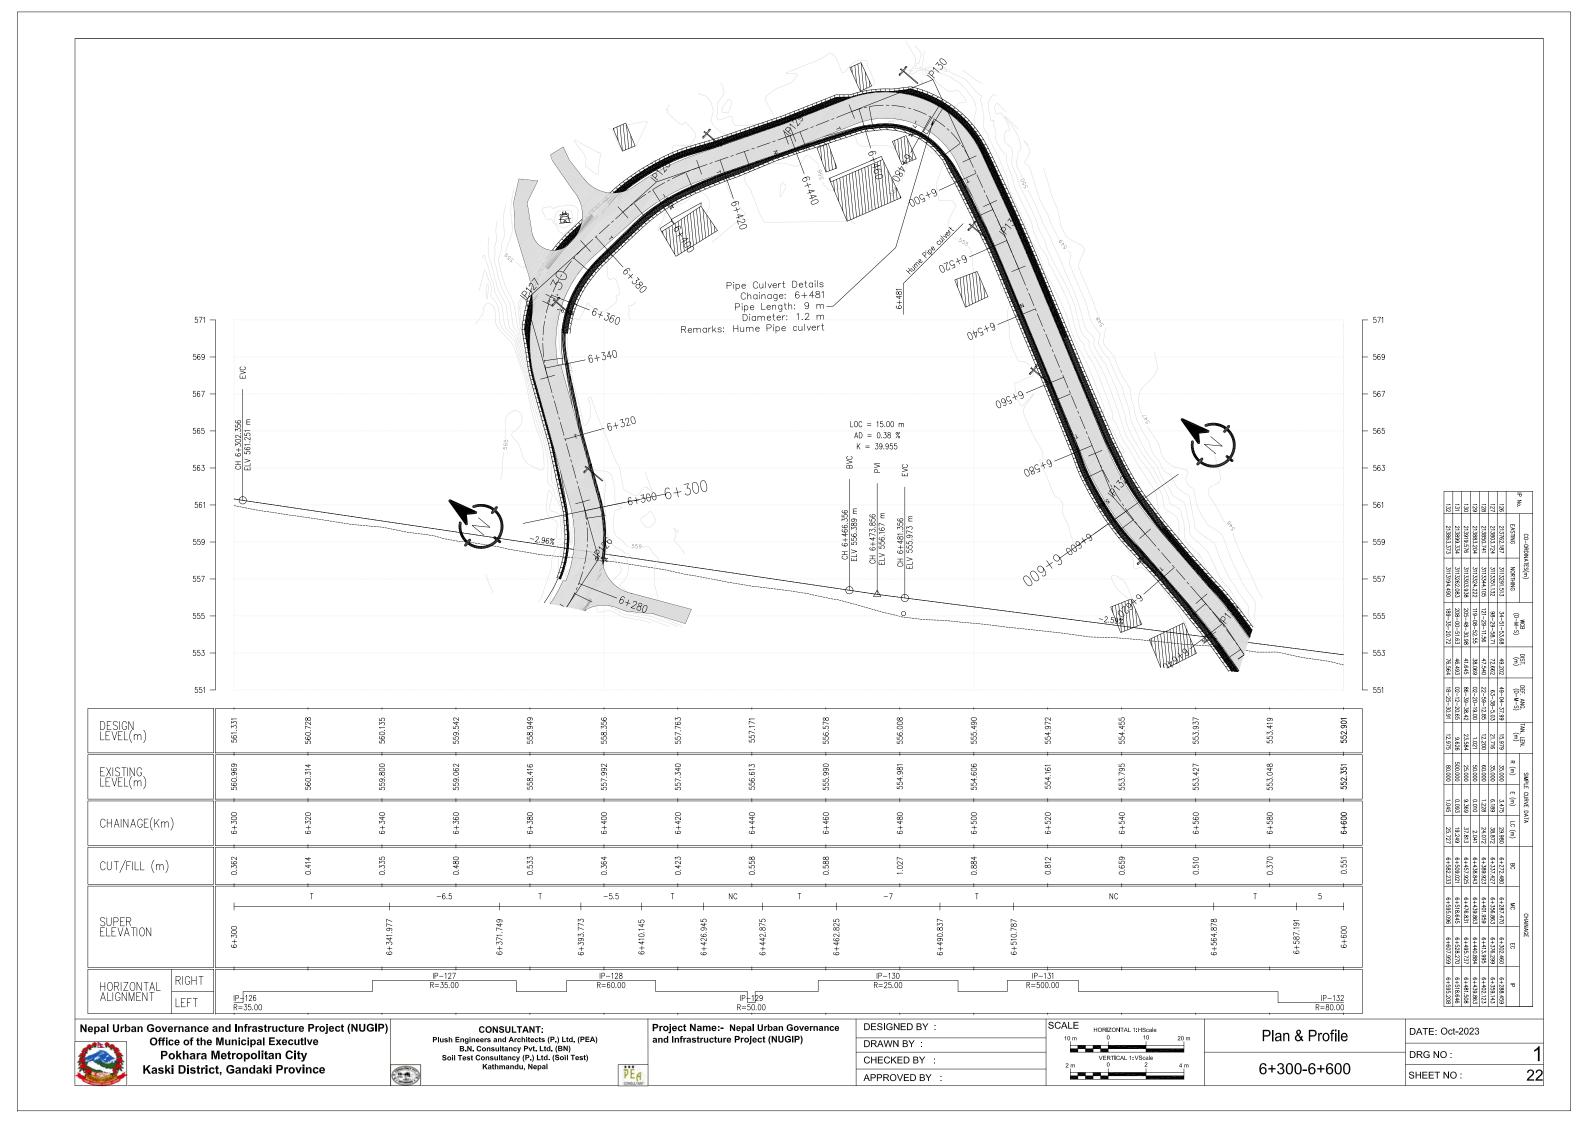


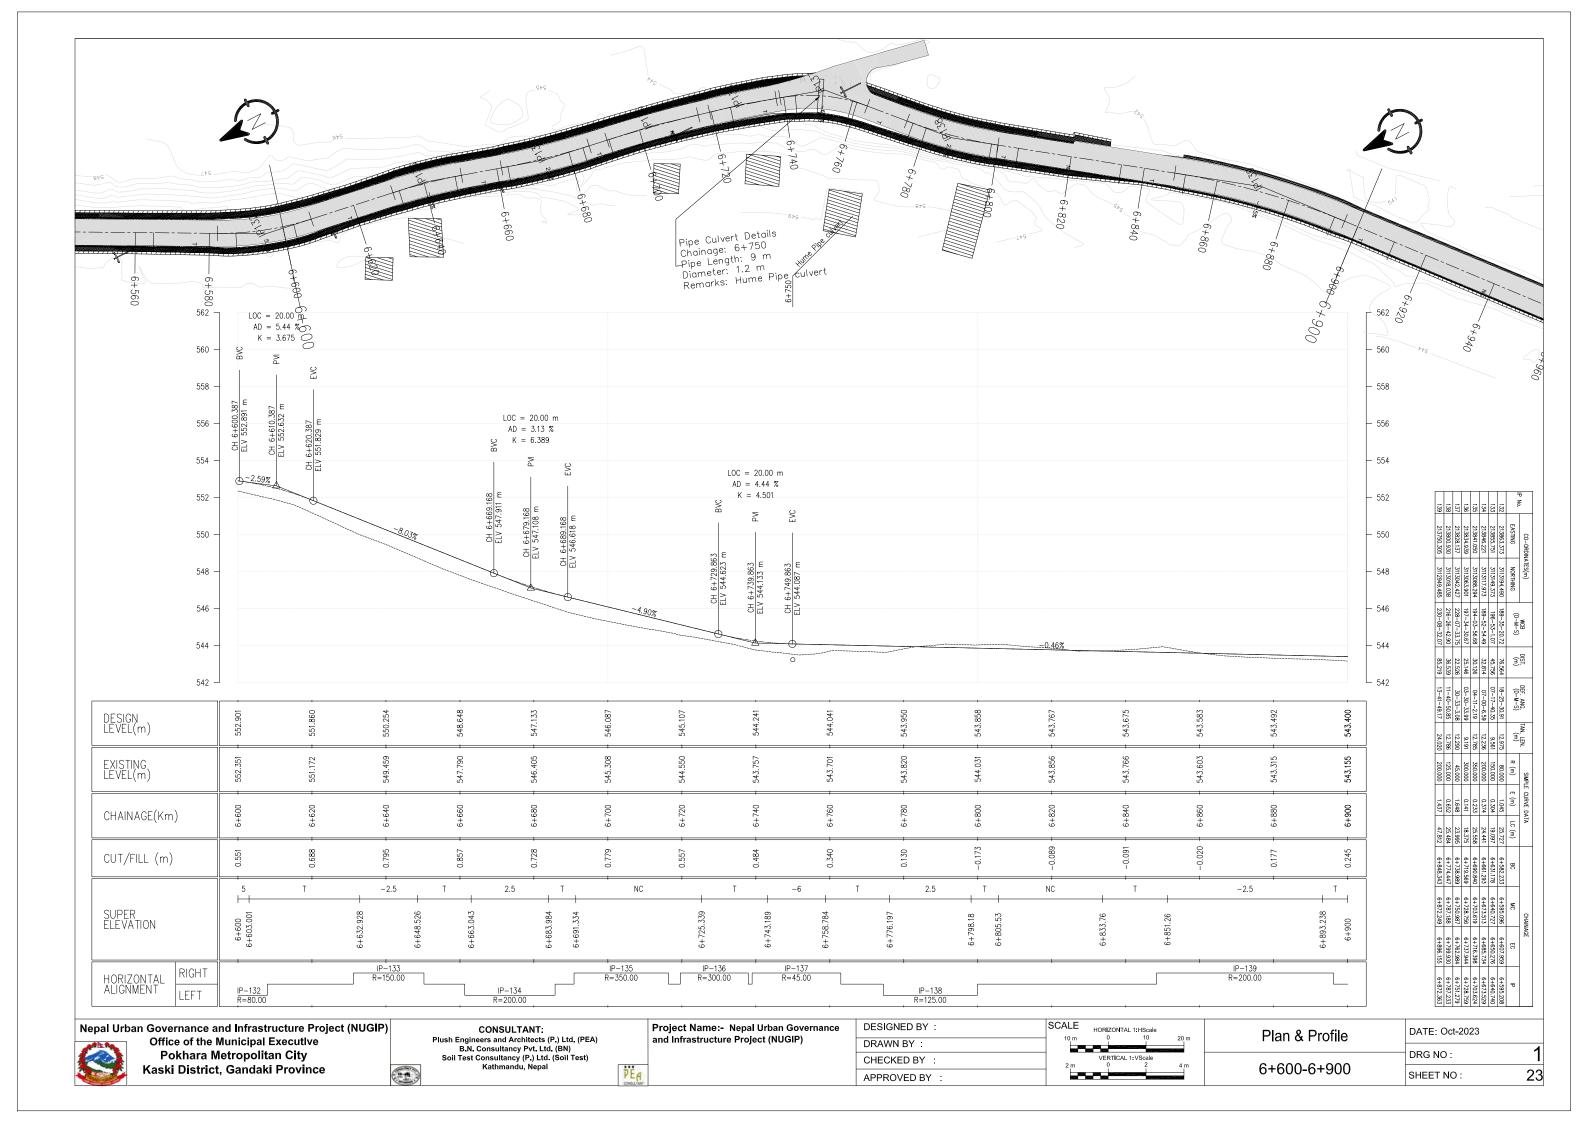


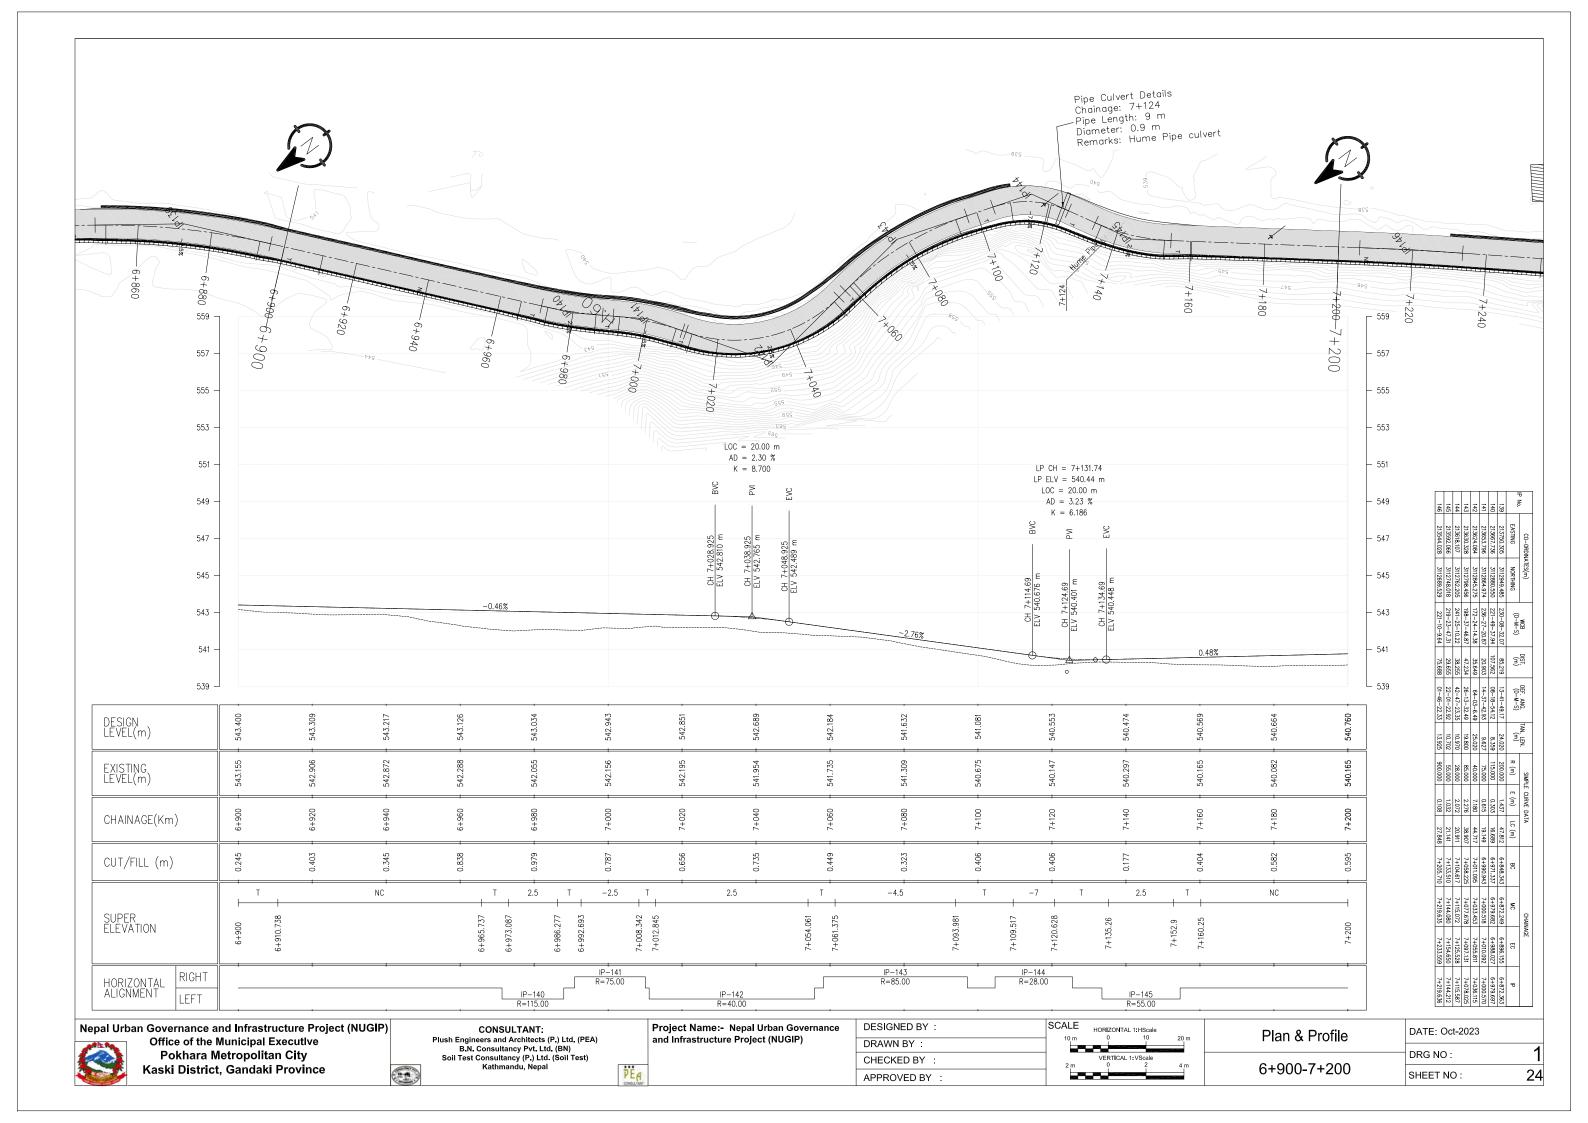


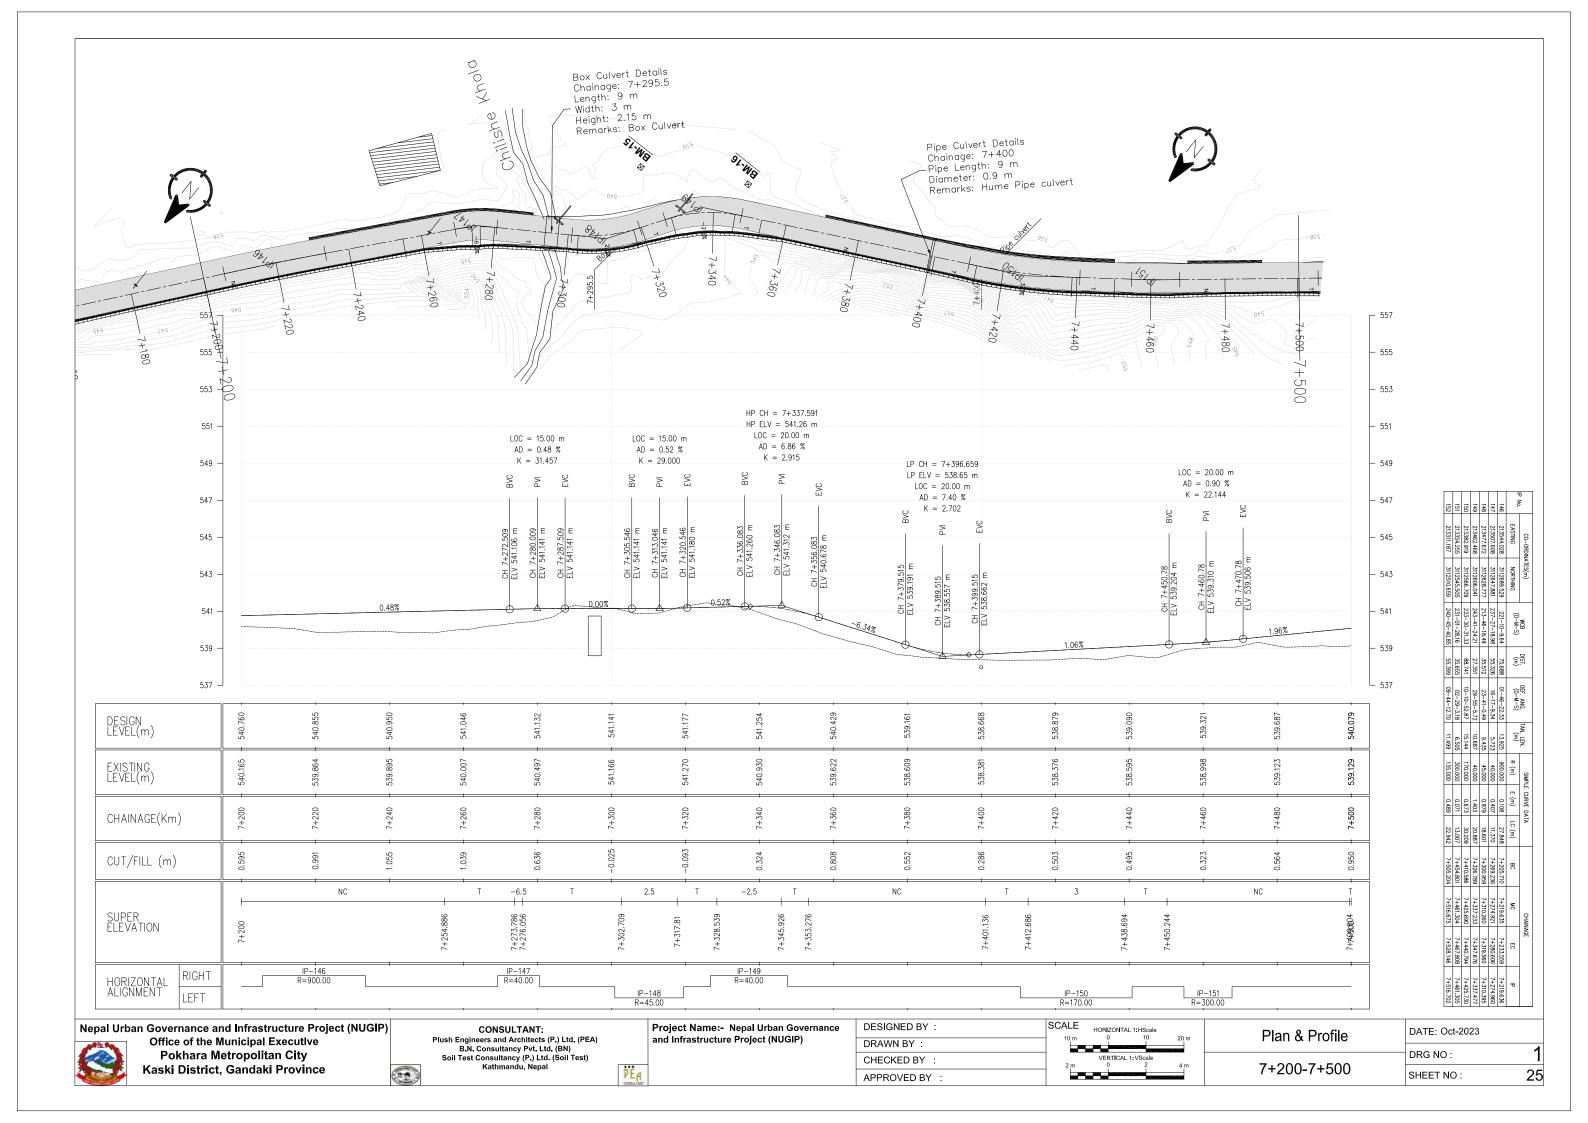


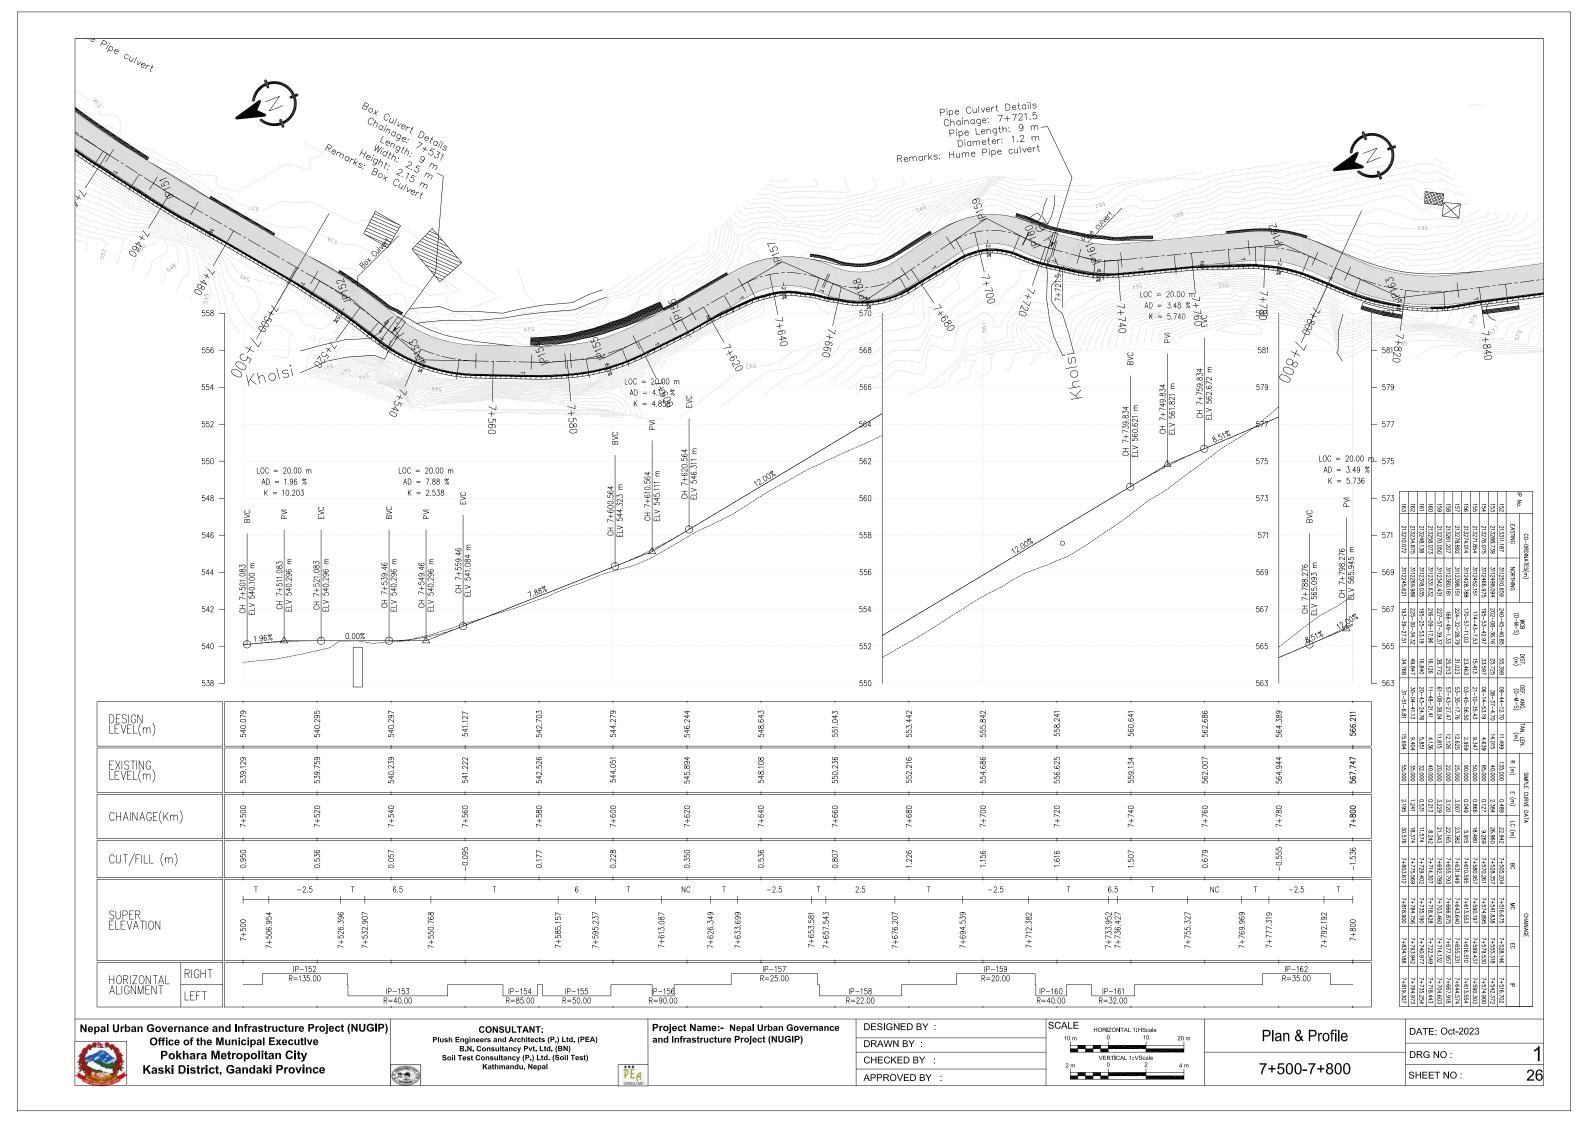


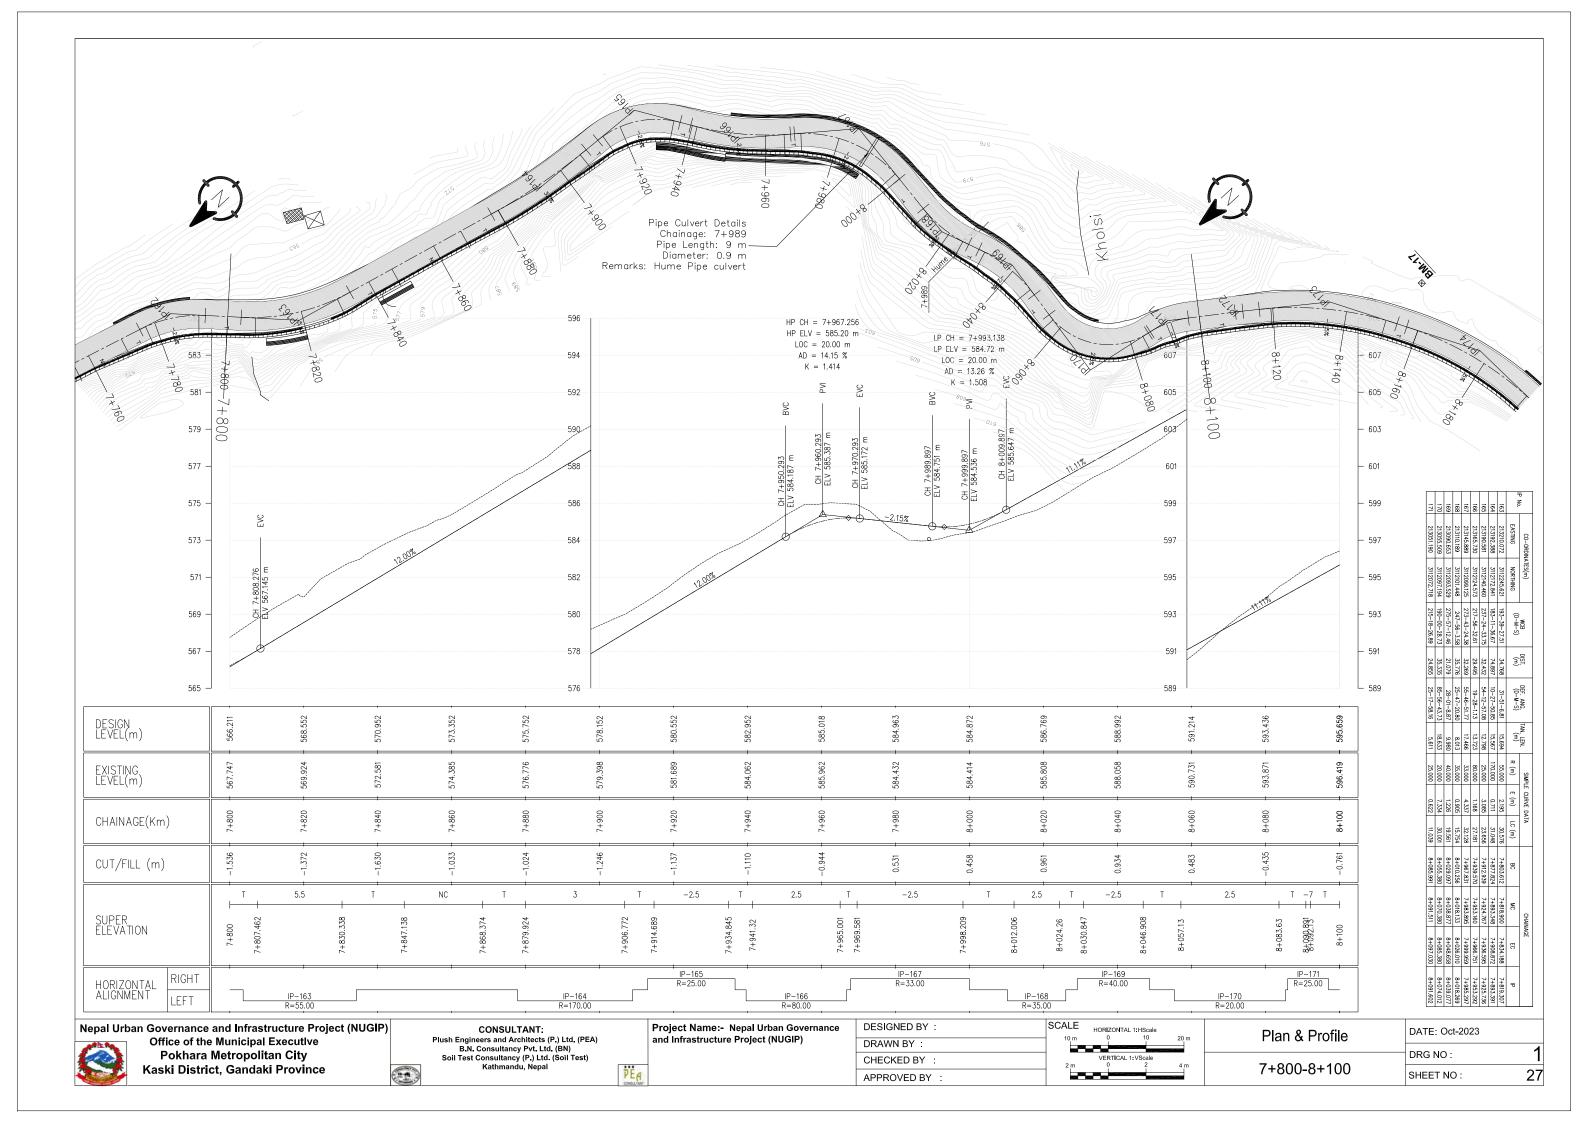


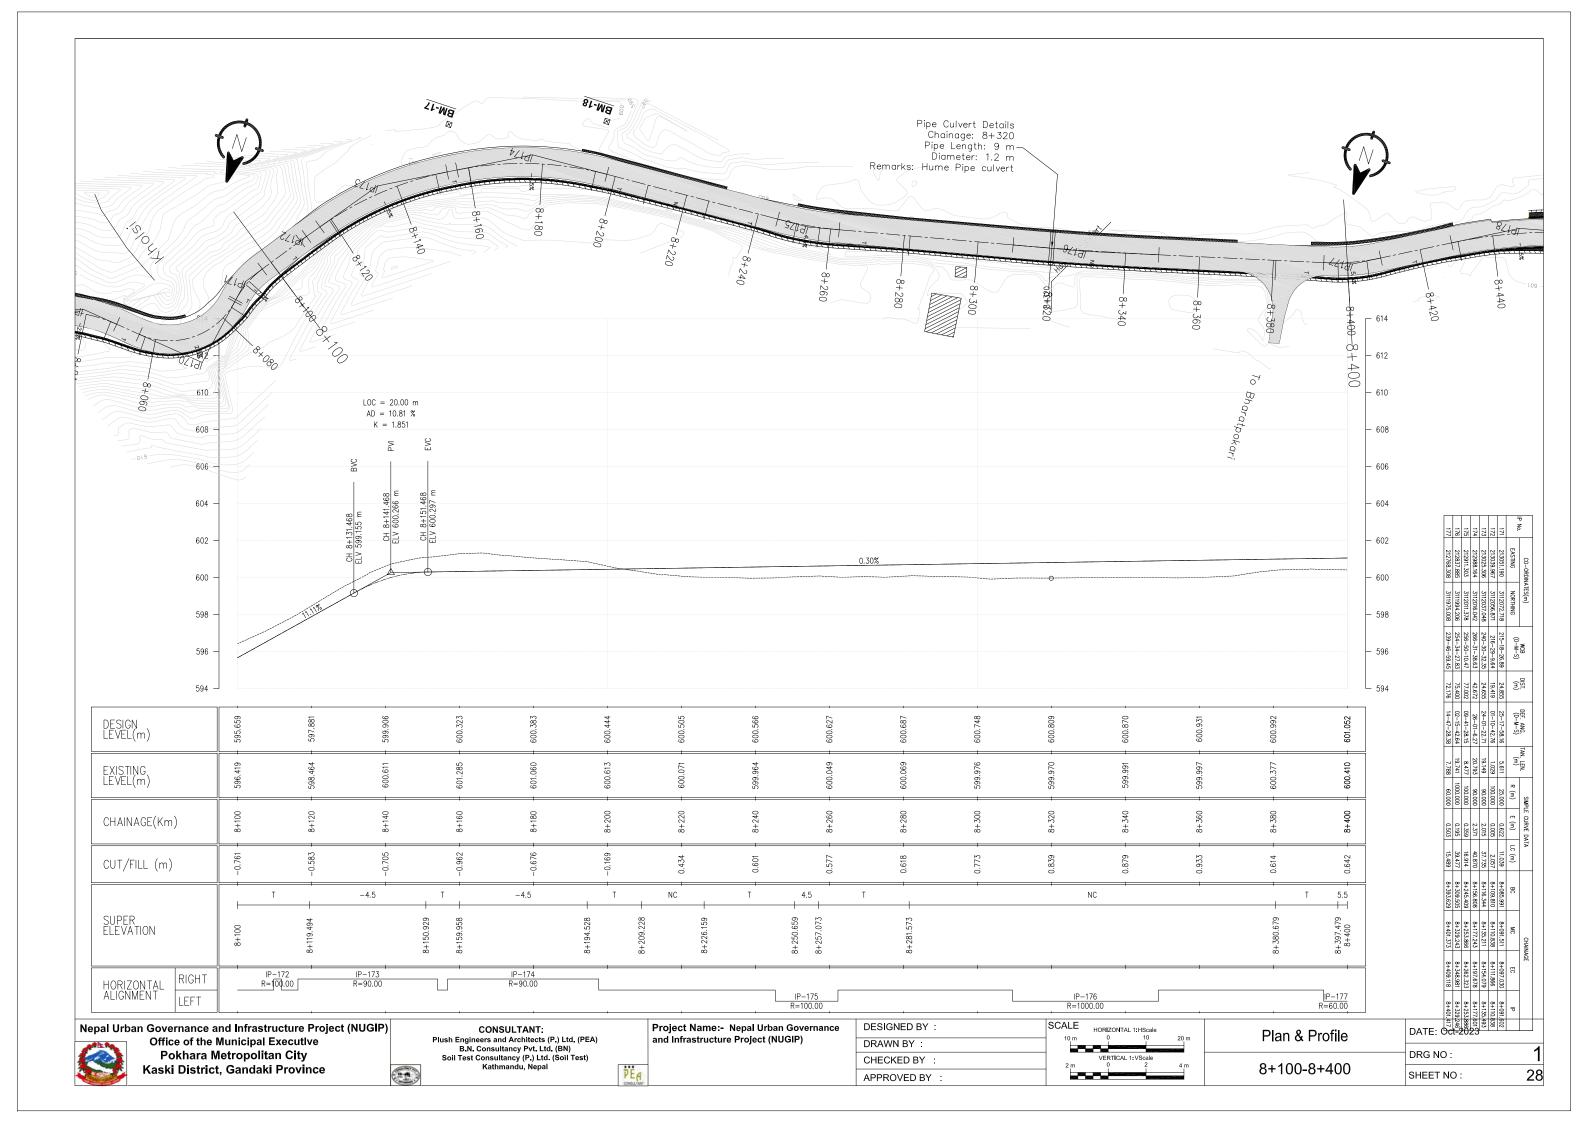


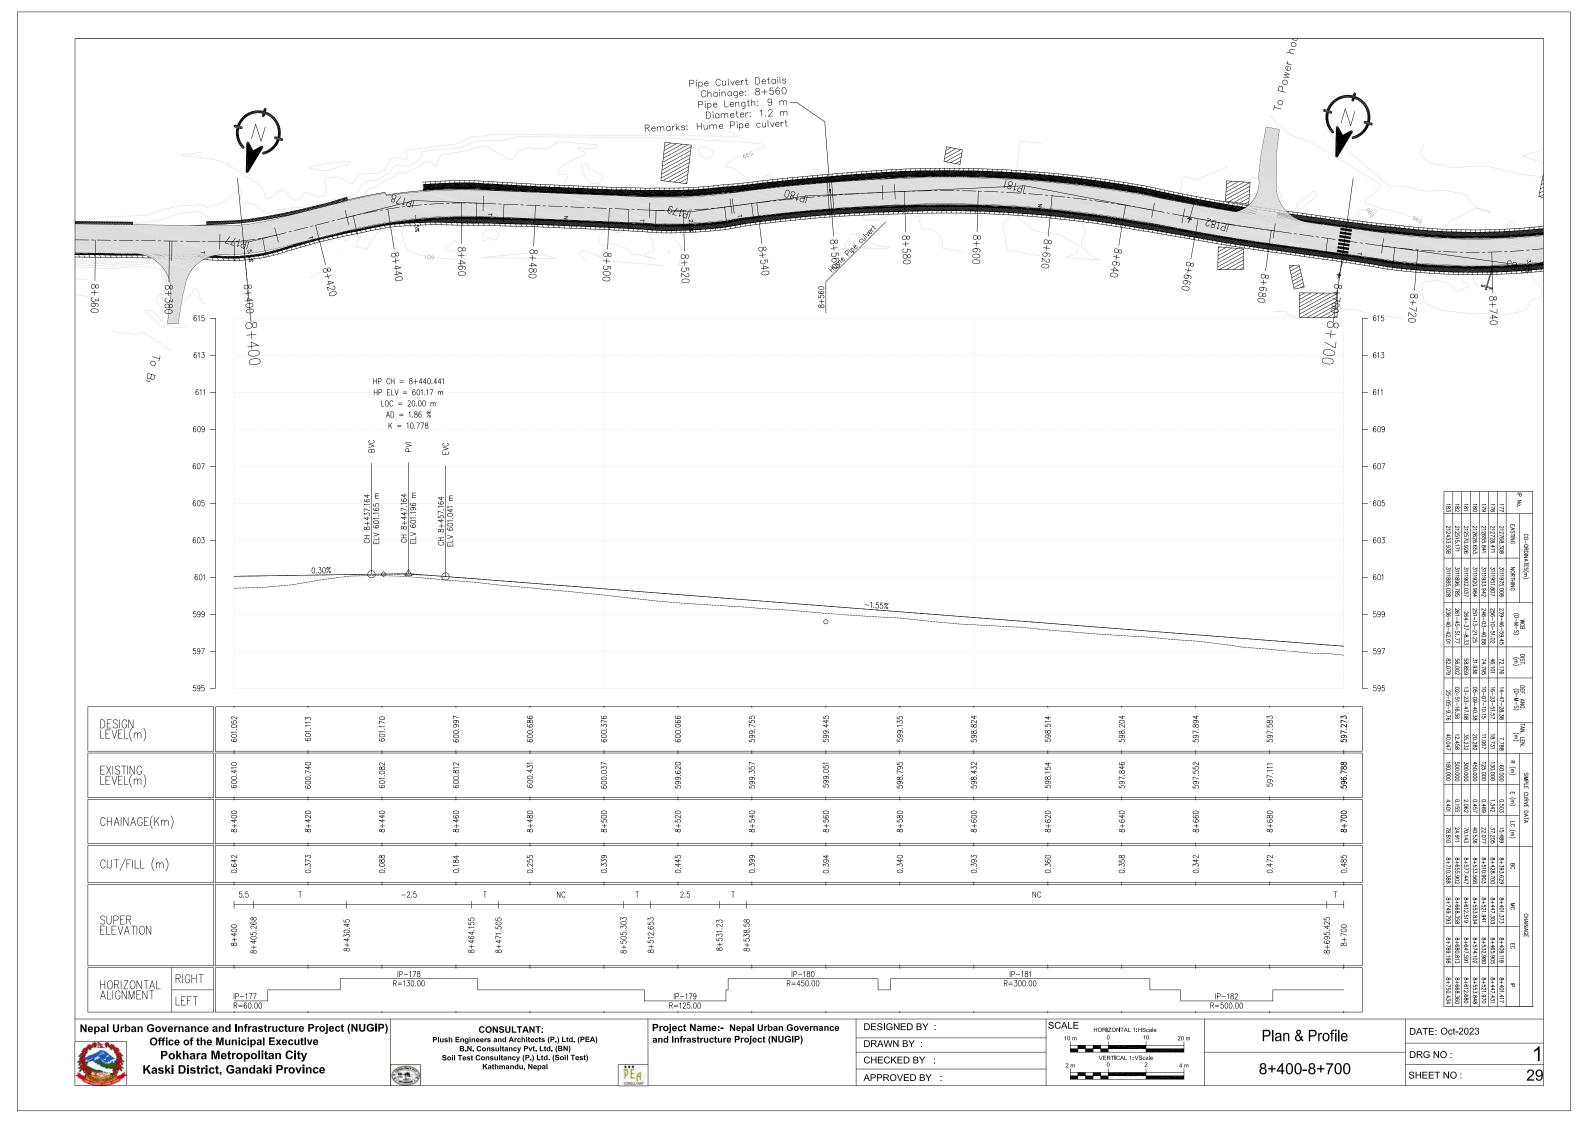

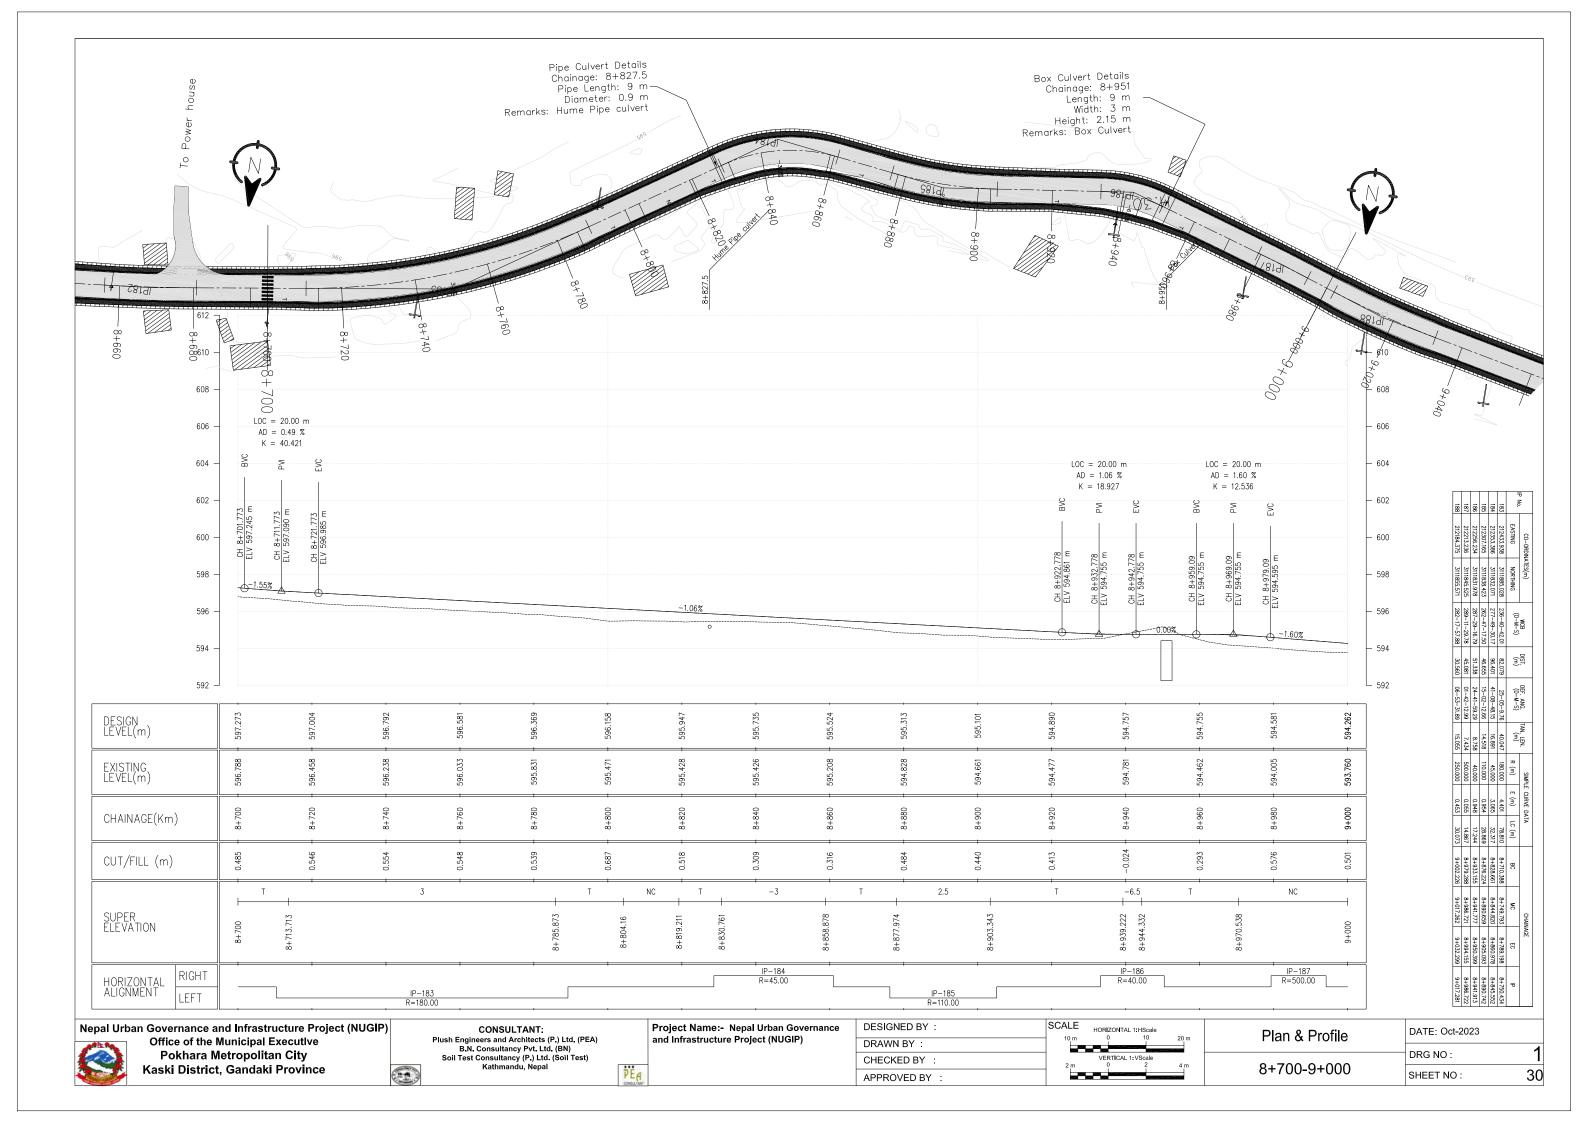

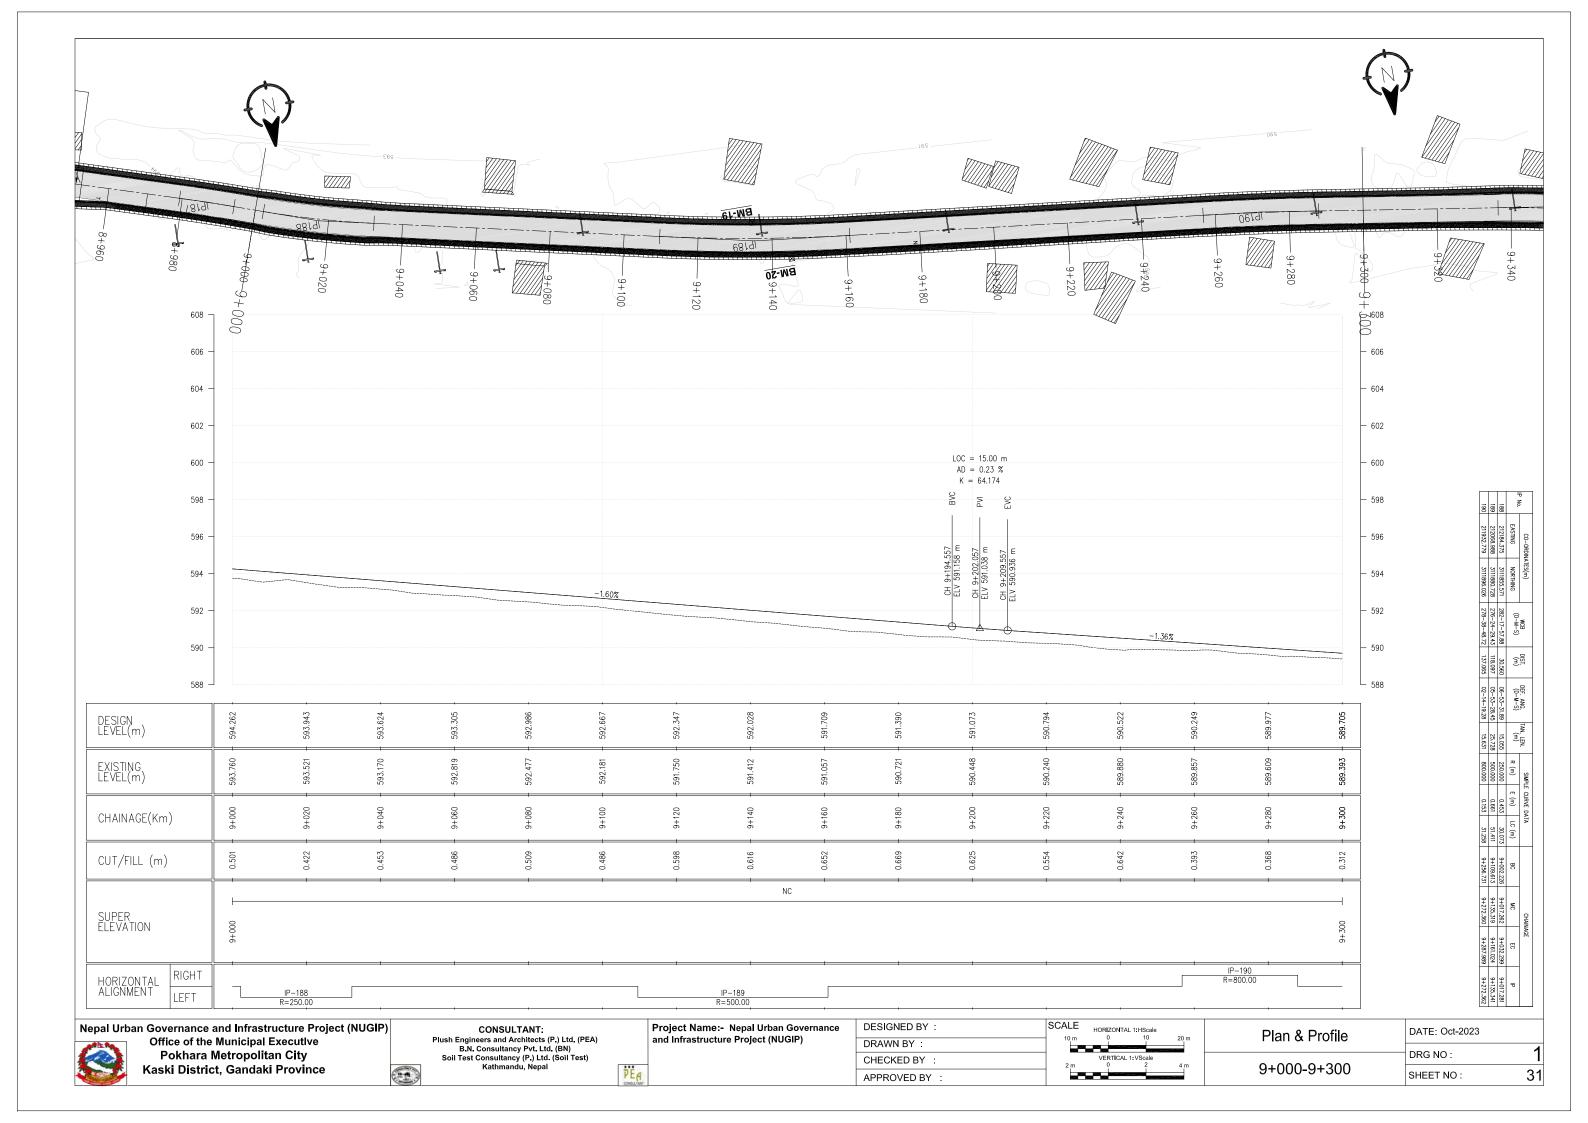

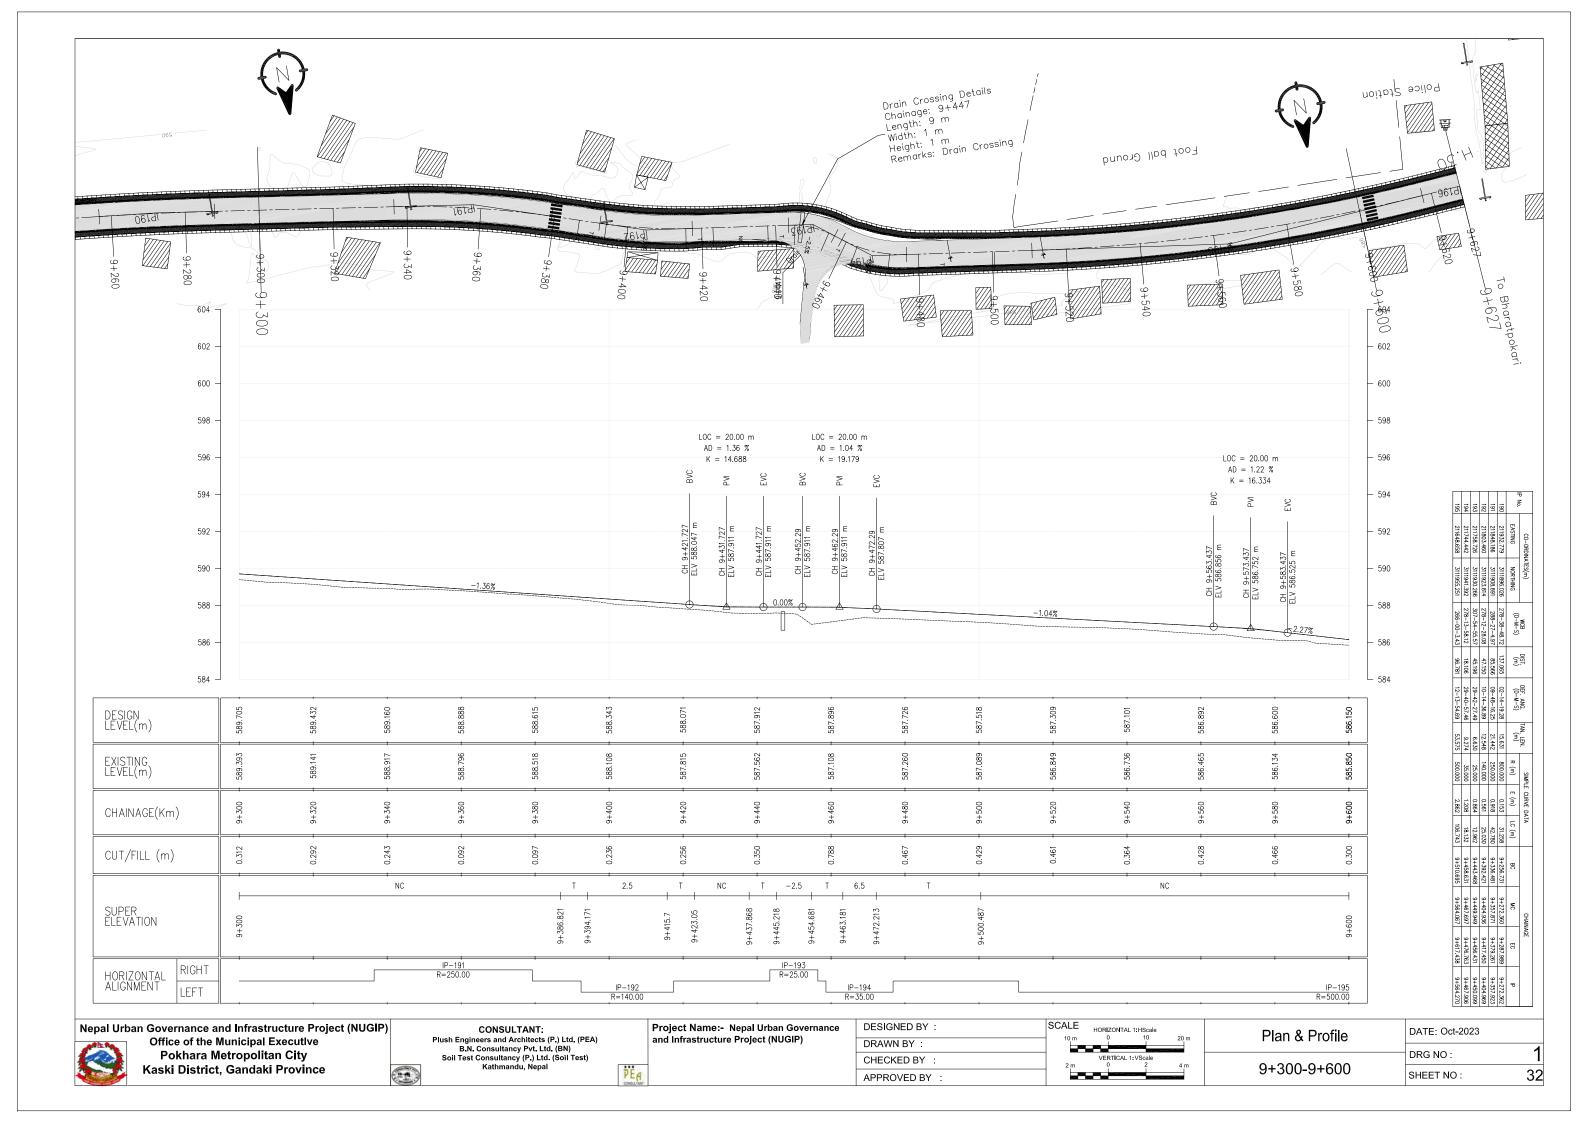

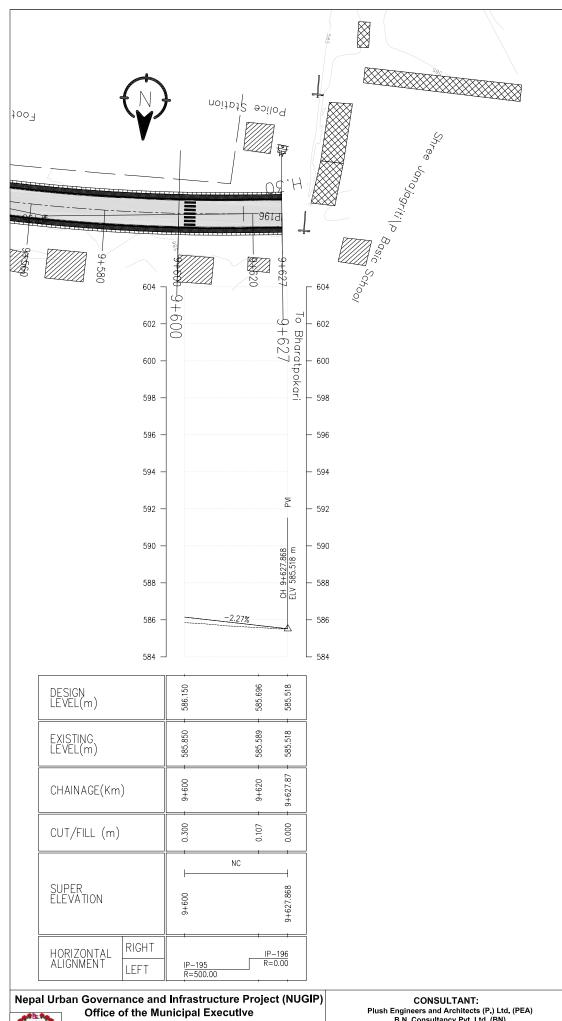


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		EASTING	NORTHING	(D-M-S)	(m)	(D-M-S)	(m)	R (m)	E (m)	LC (m)	BC	MC	EC	IP
	195	211648.658	3111955.251	266-00-3.43	96.781	12-13-54.69	53.575	500.000	2.862	106.743	9+510.695	9+564.067	9+617.438	9+564.270
	196	211584.810	3111950.787	00-00-0.00	64.005	00-00-0.00	0.000	0.000	0.000	0.000	9+627.868	9+627.868	9+627.868	9+627.868

Pokhara Metropolitan City Kaski District, Gandaki Province CONSULTANT:
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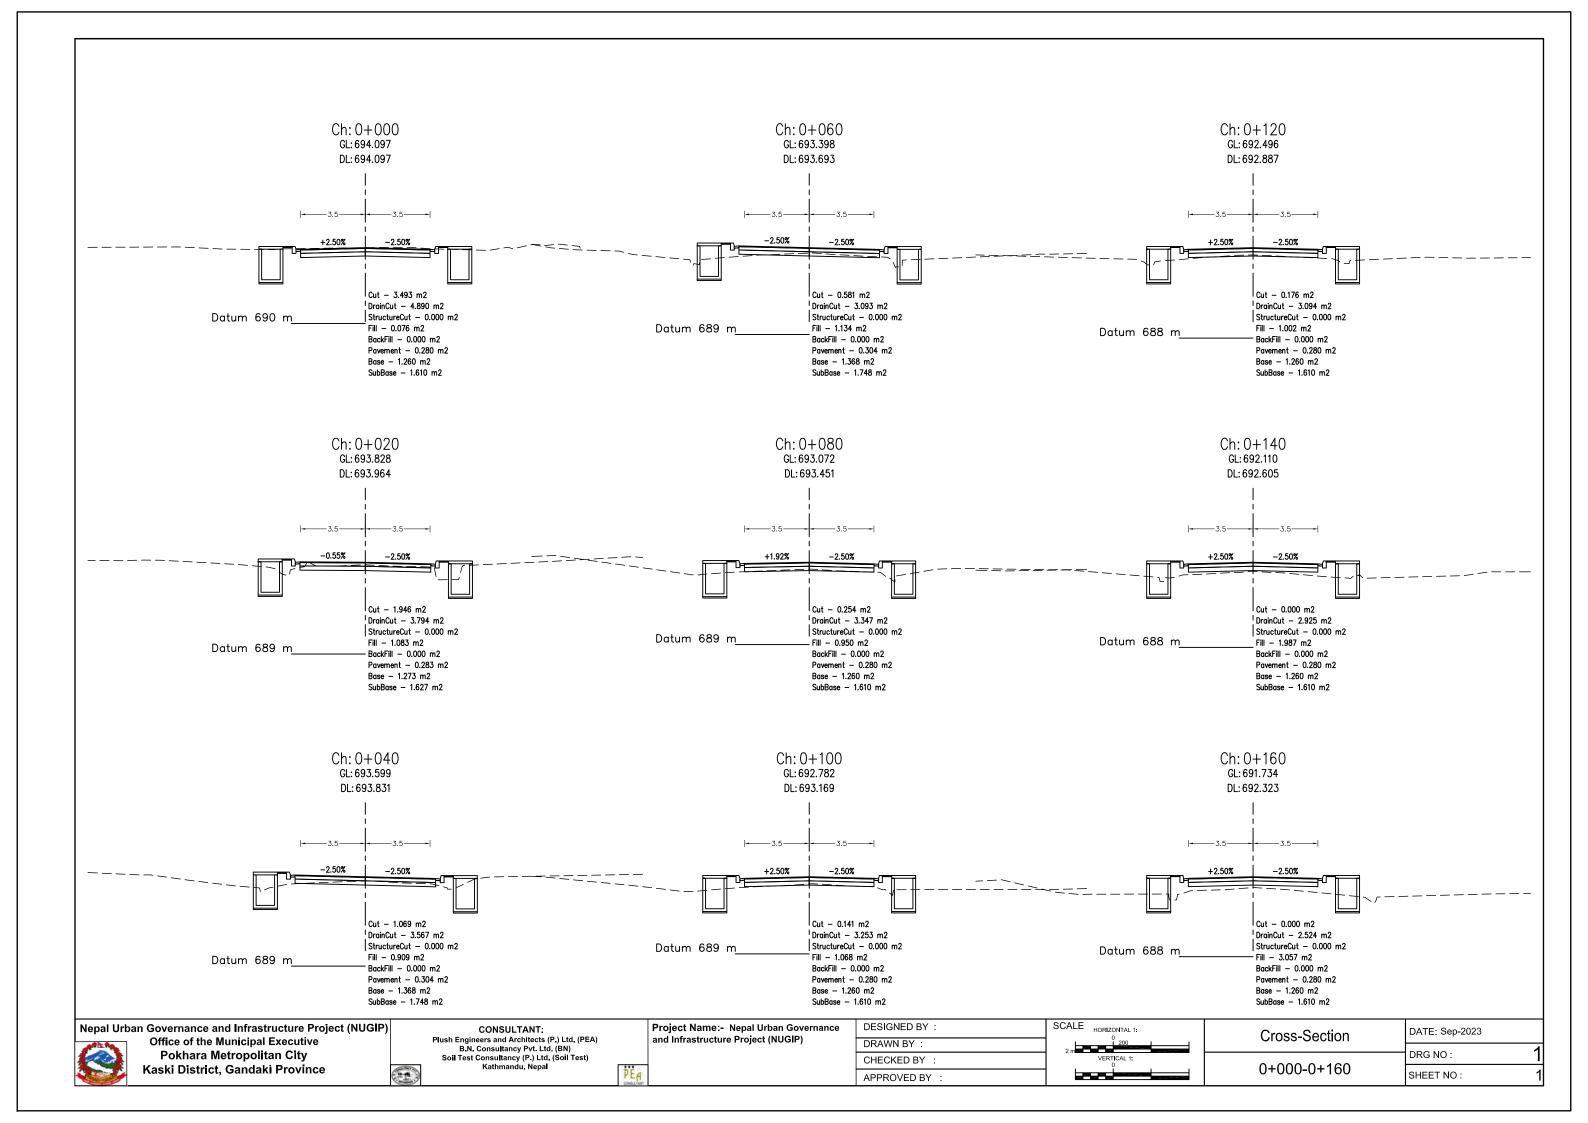
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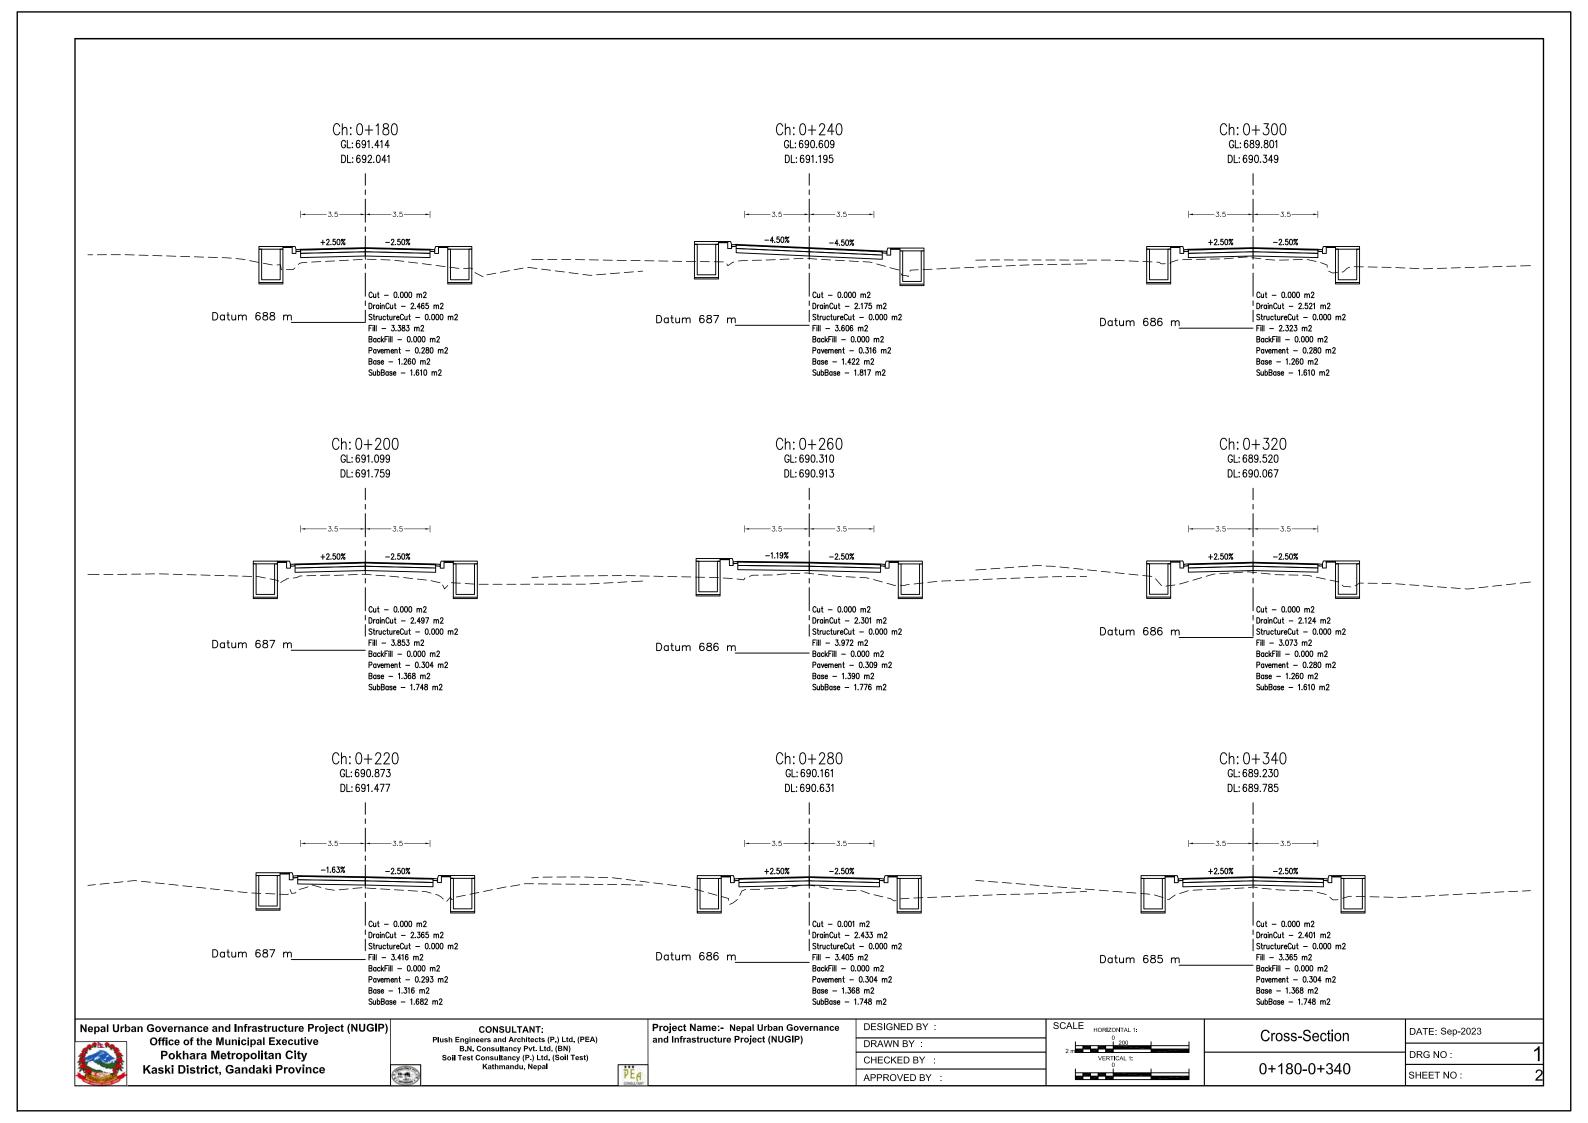
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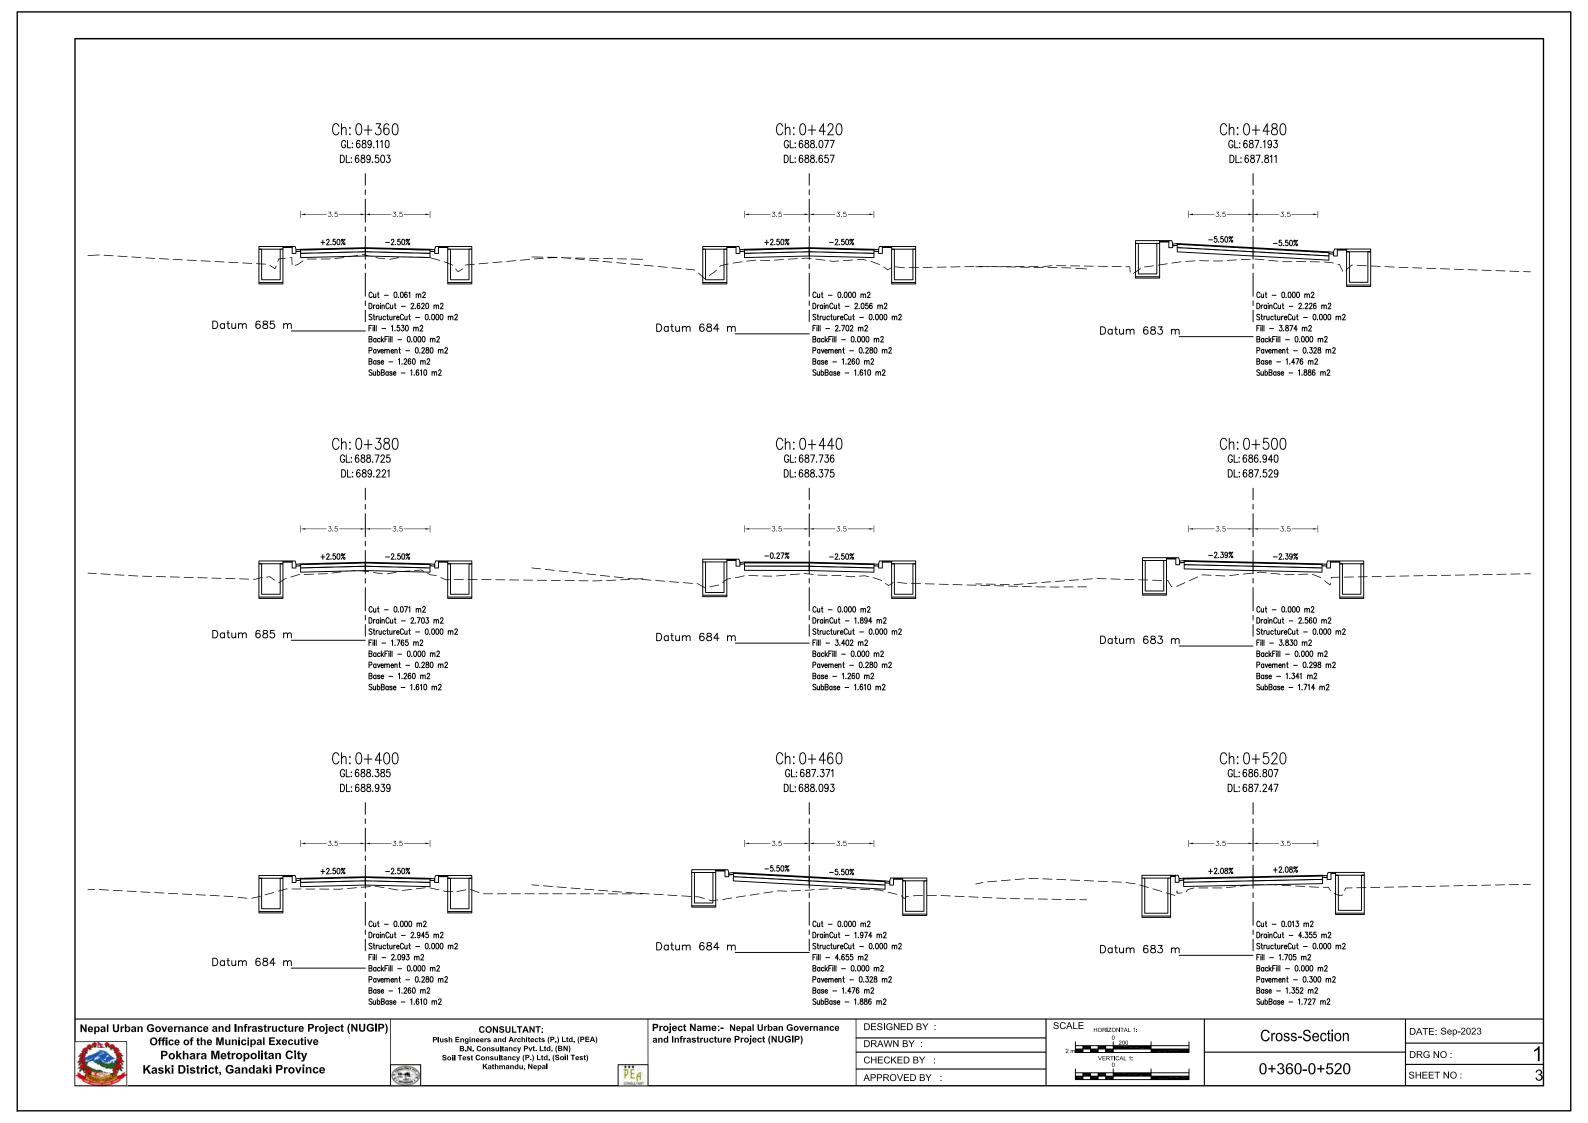



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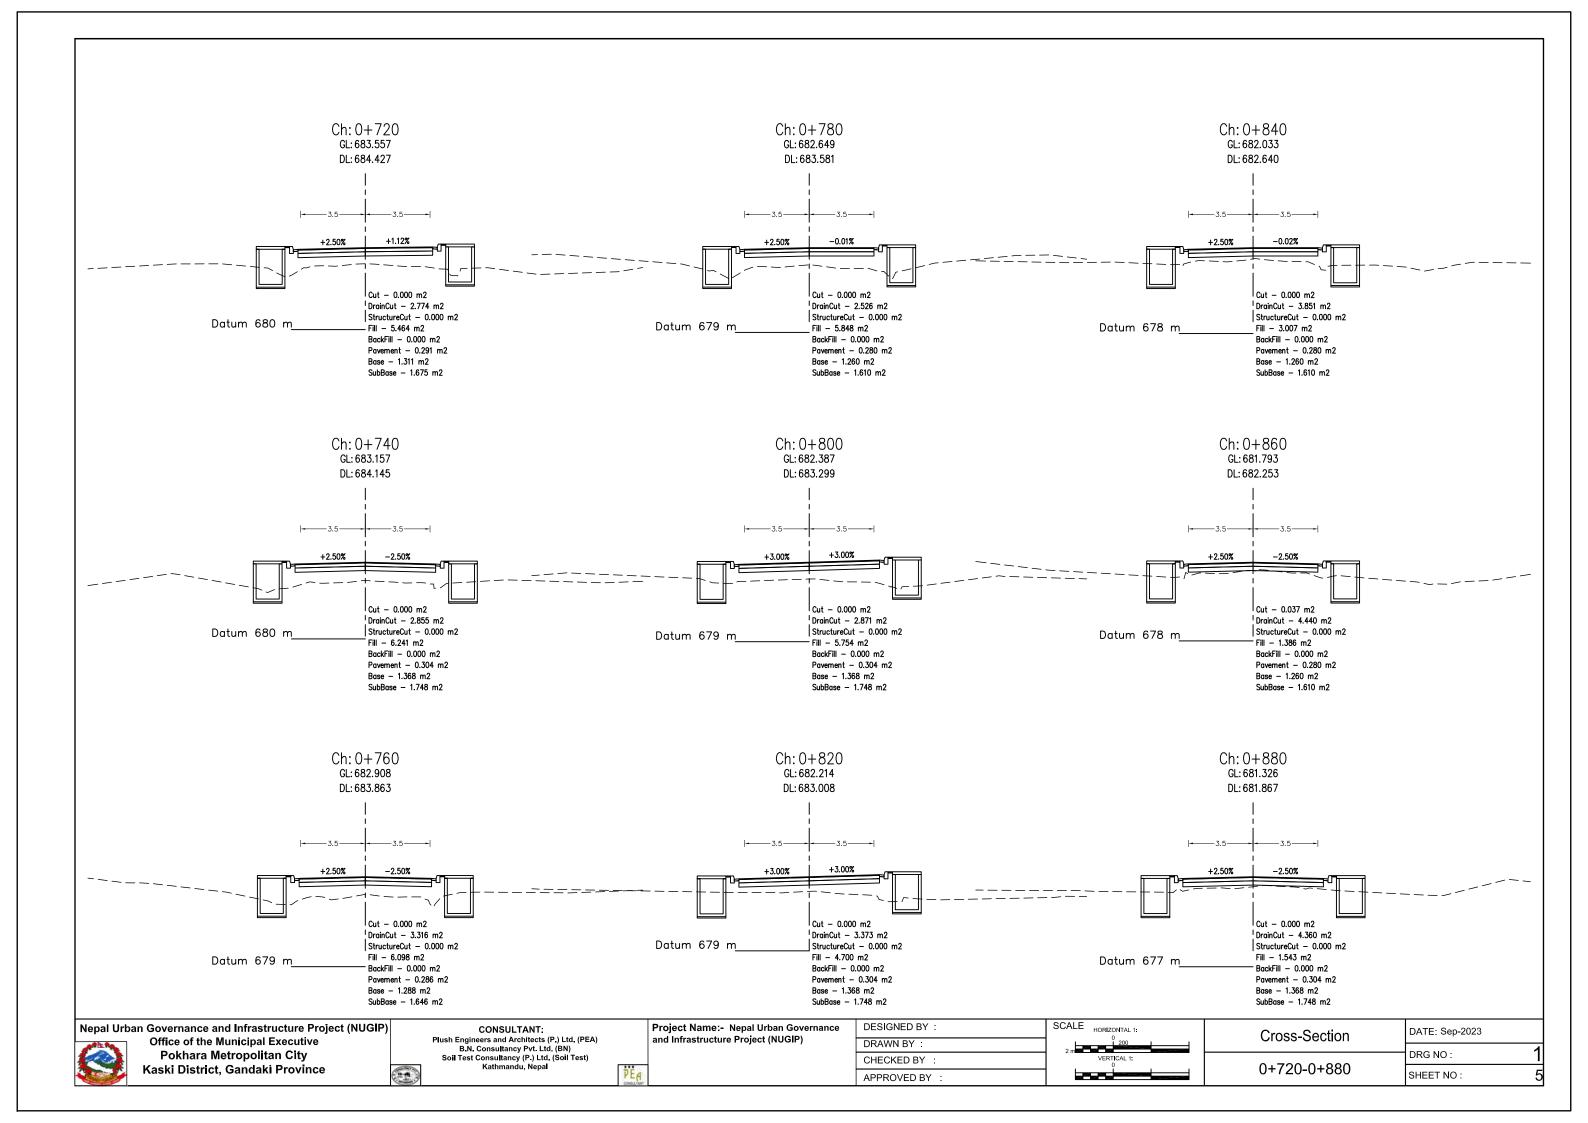
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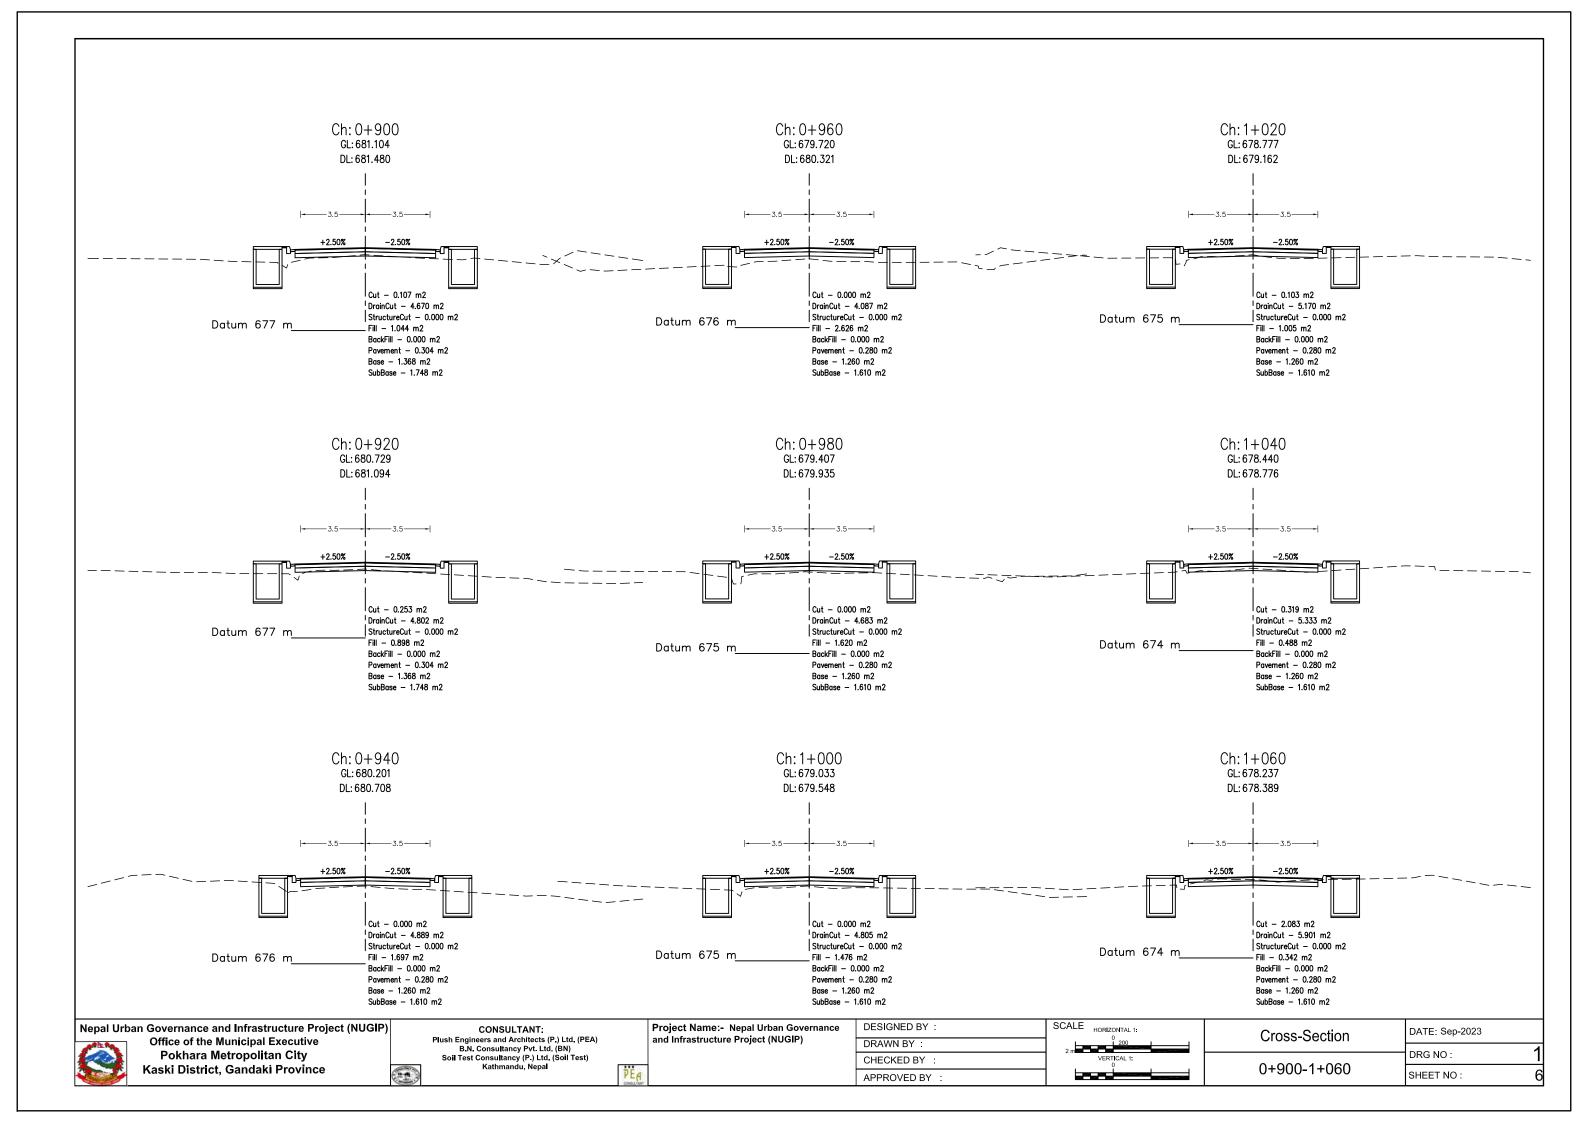





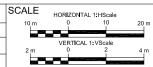








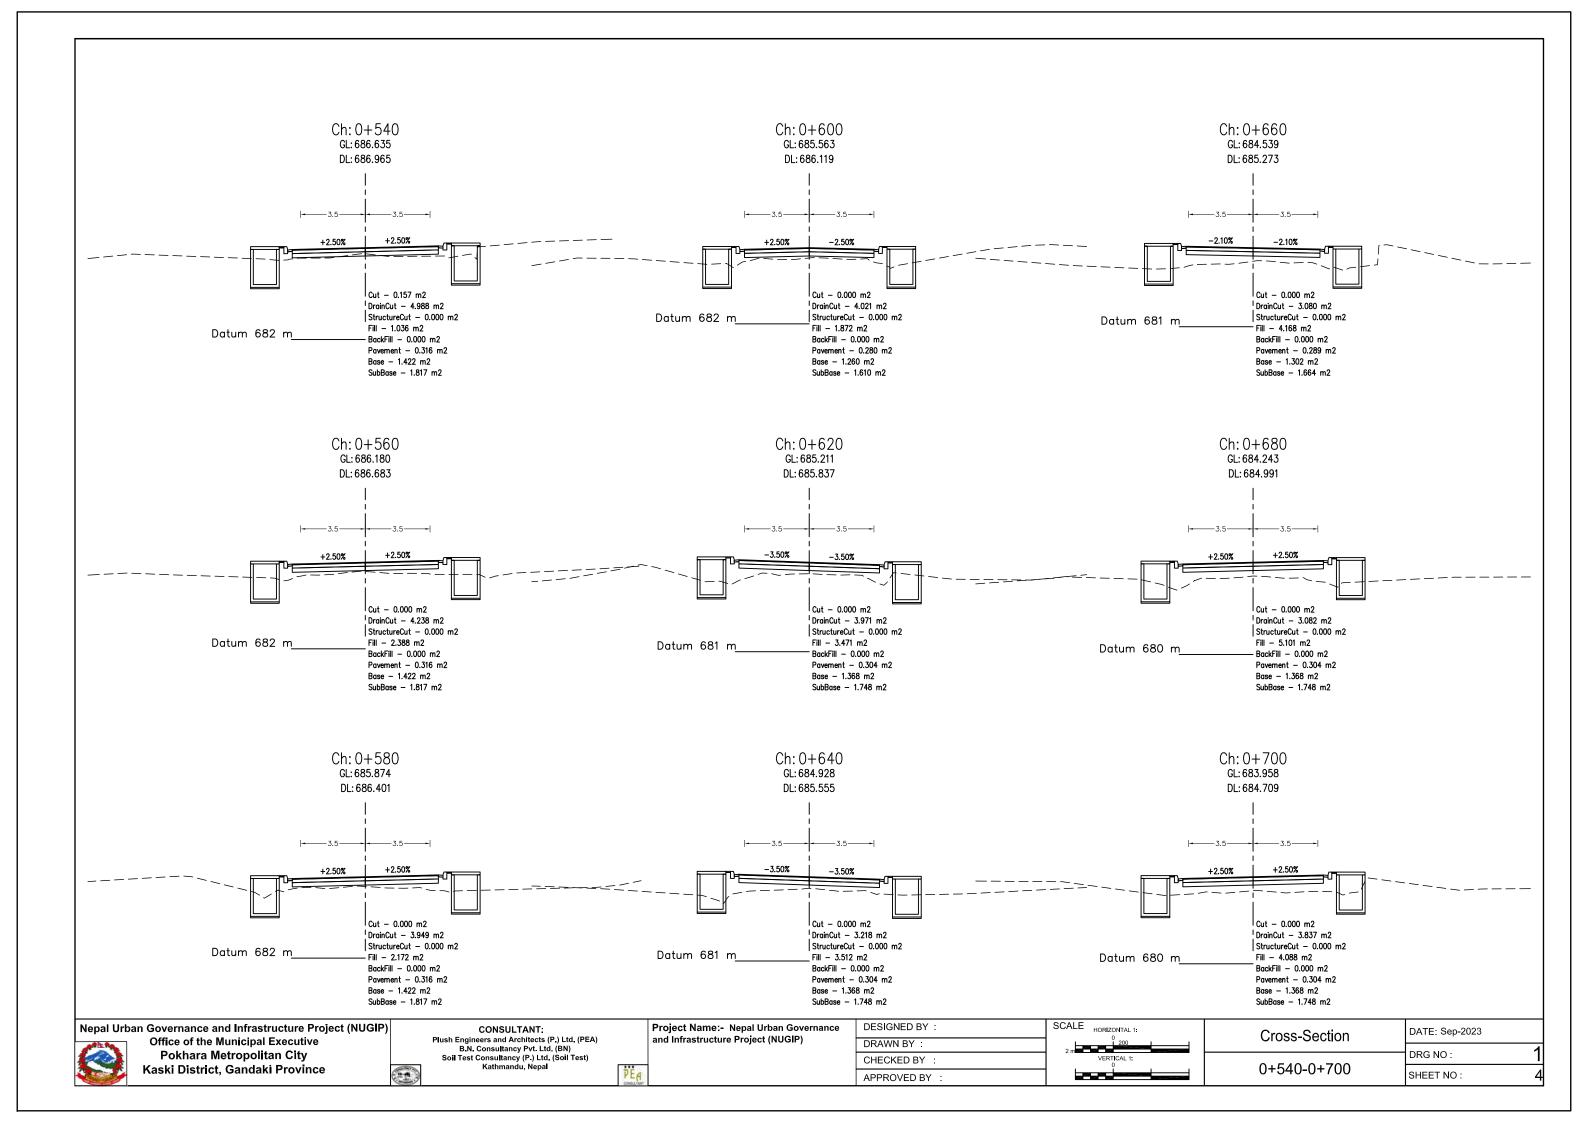


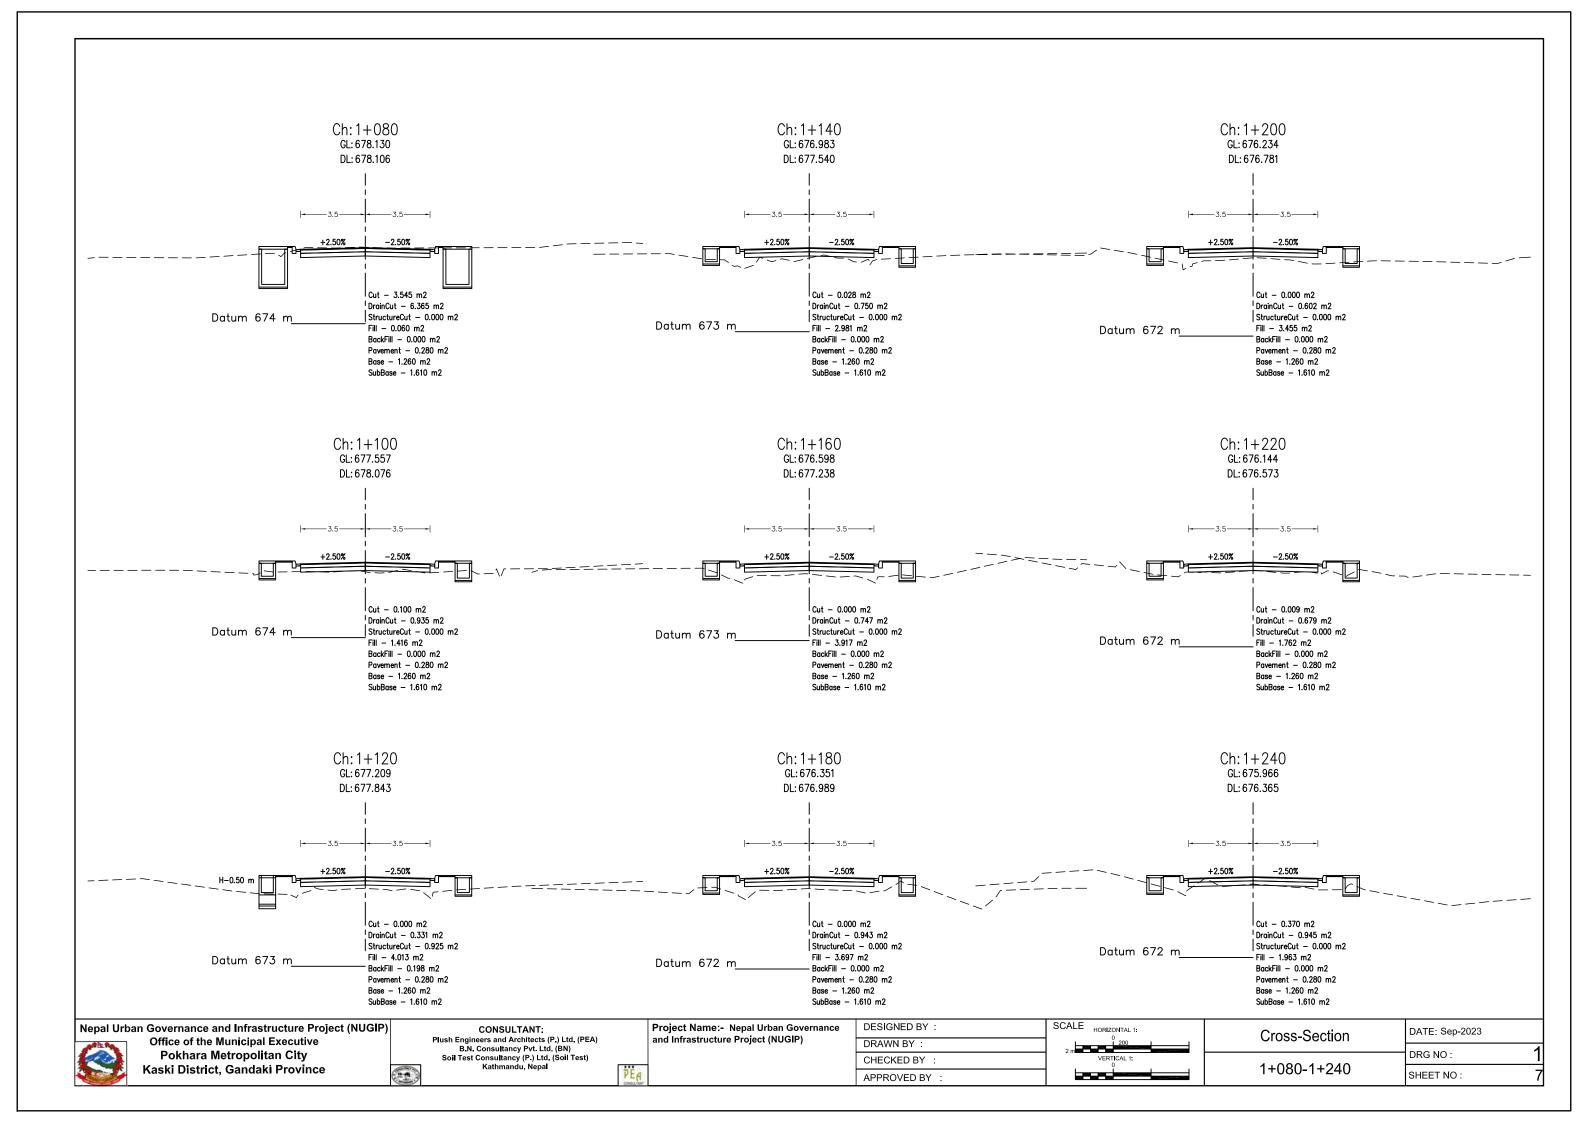


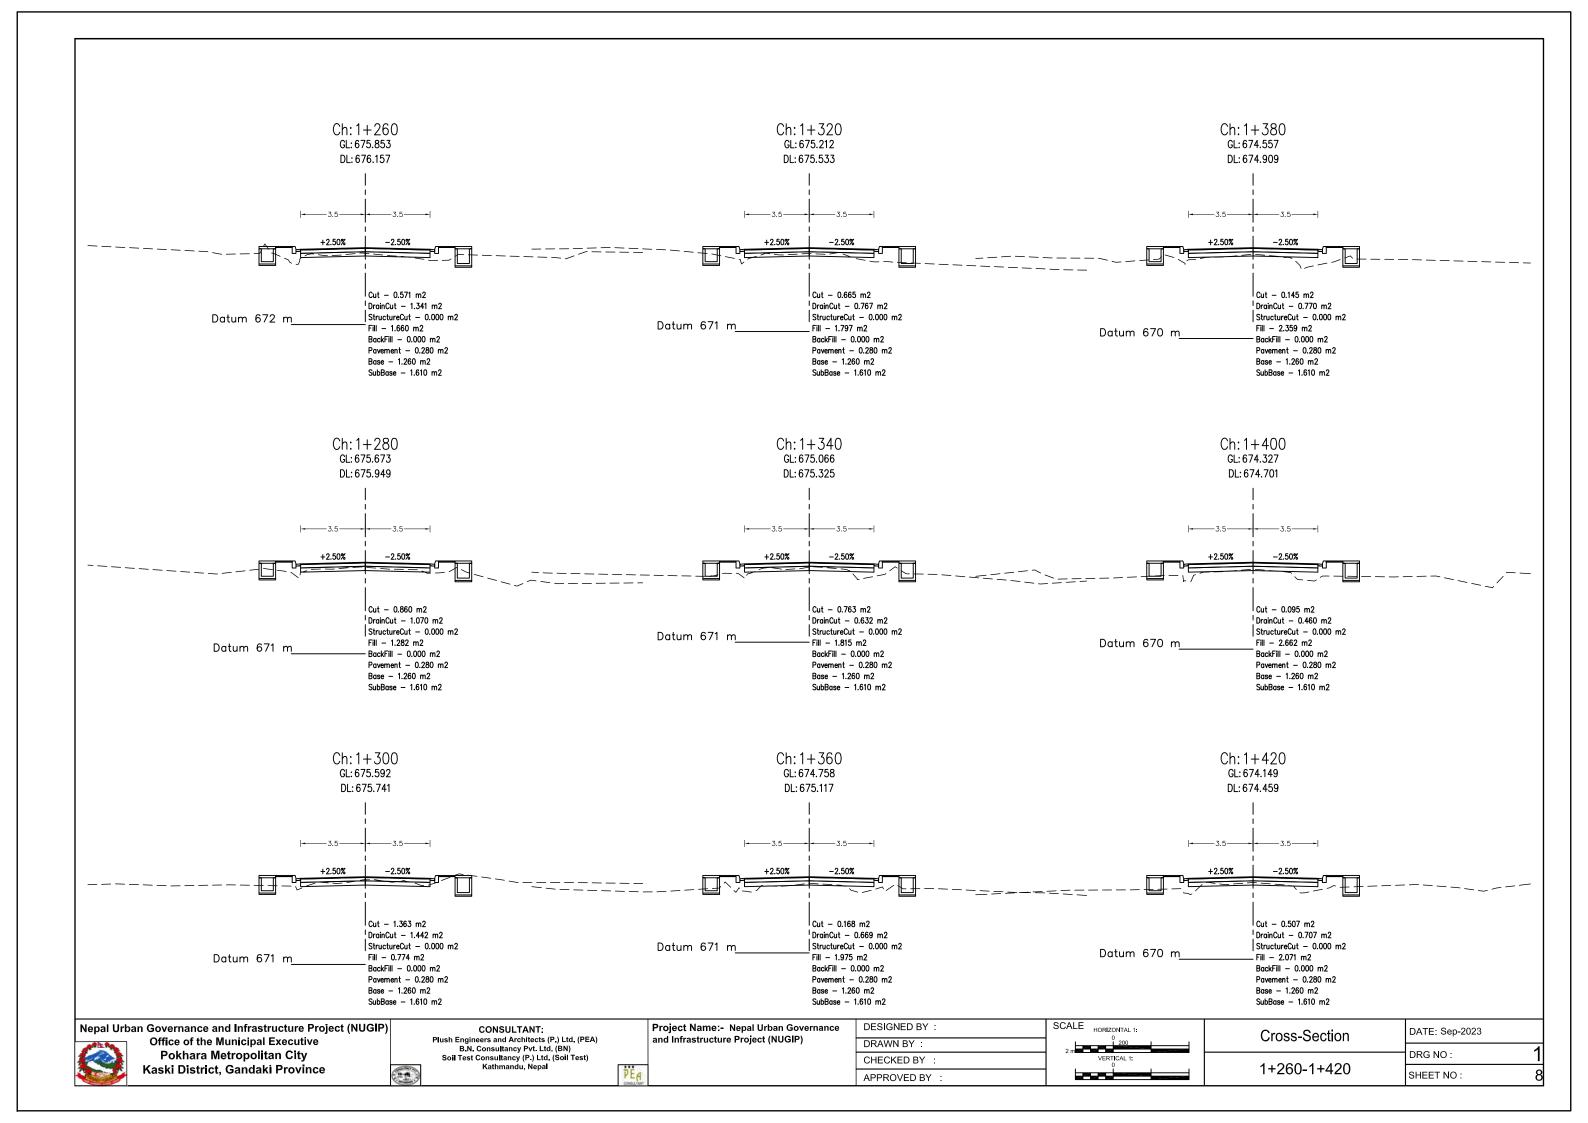


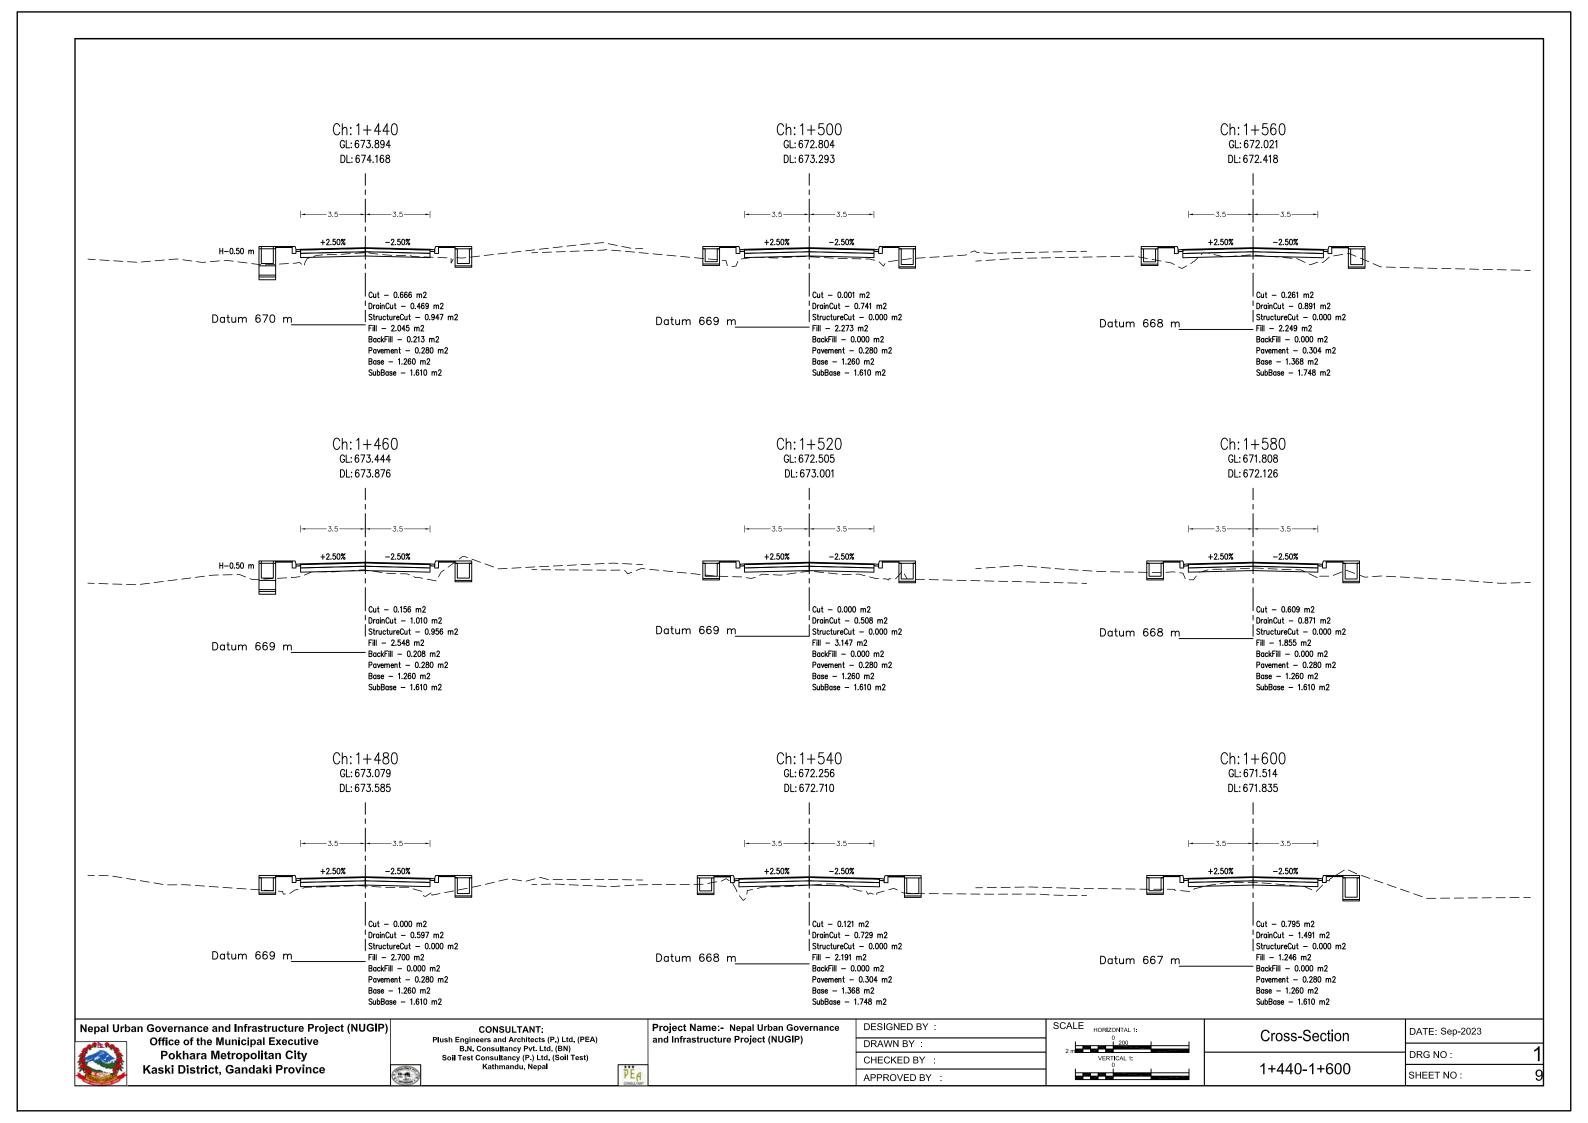


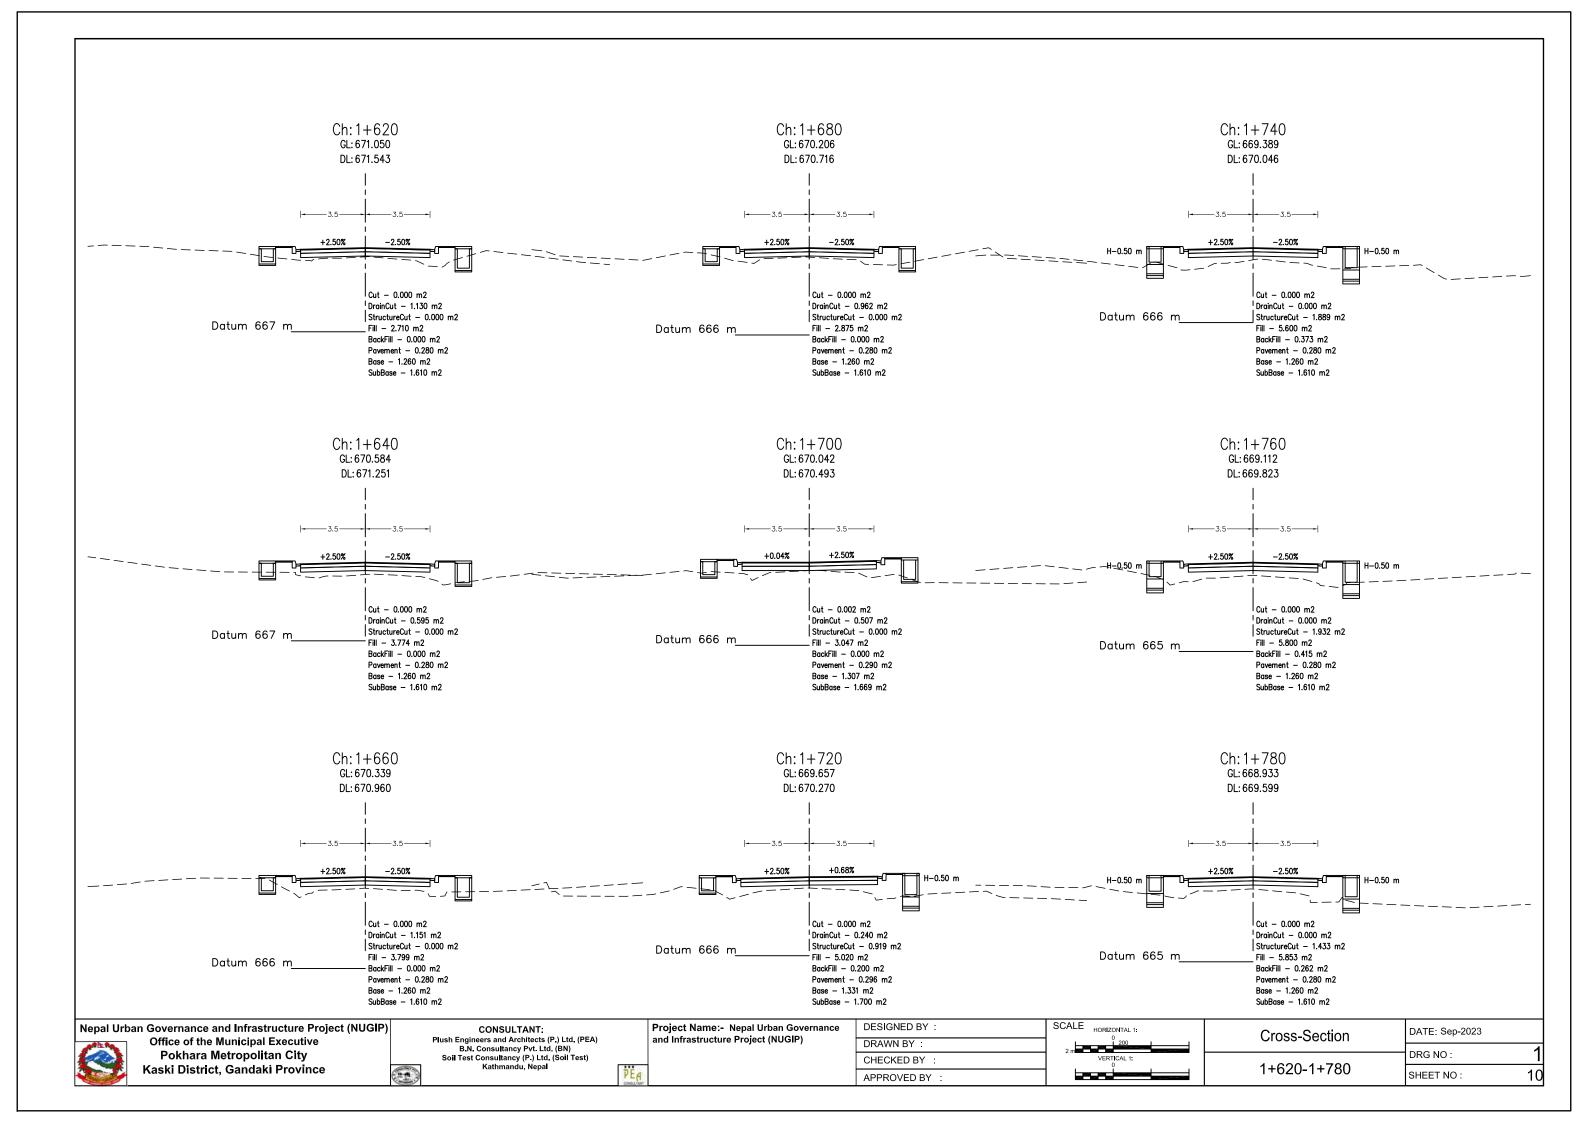


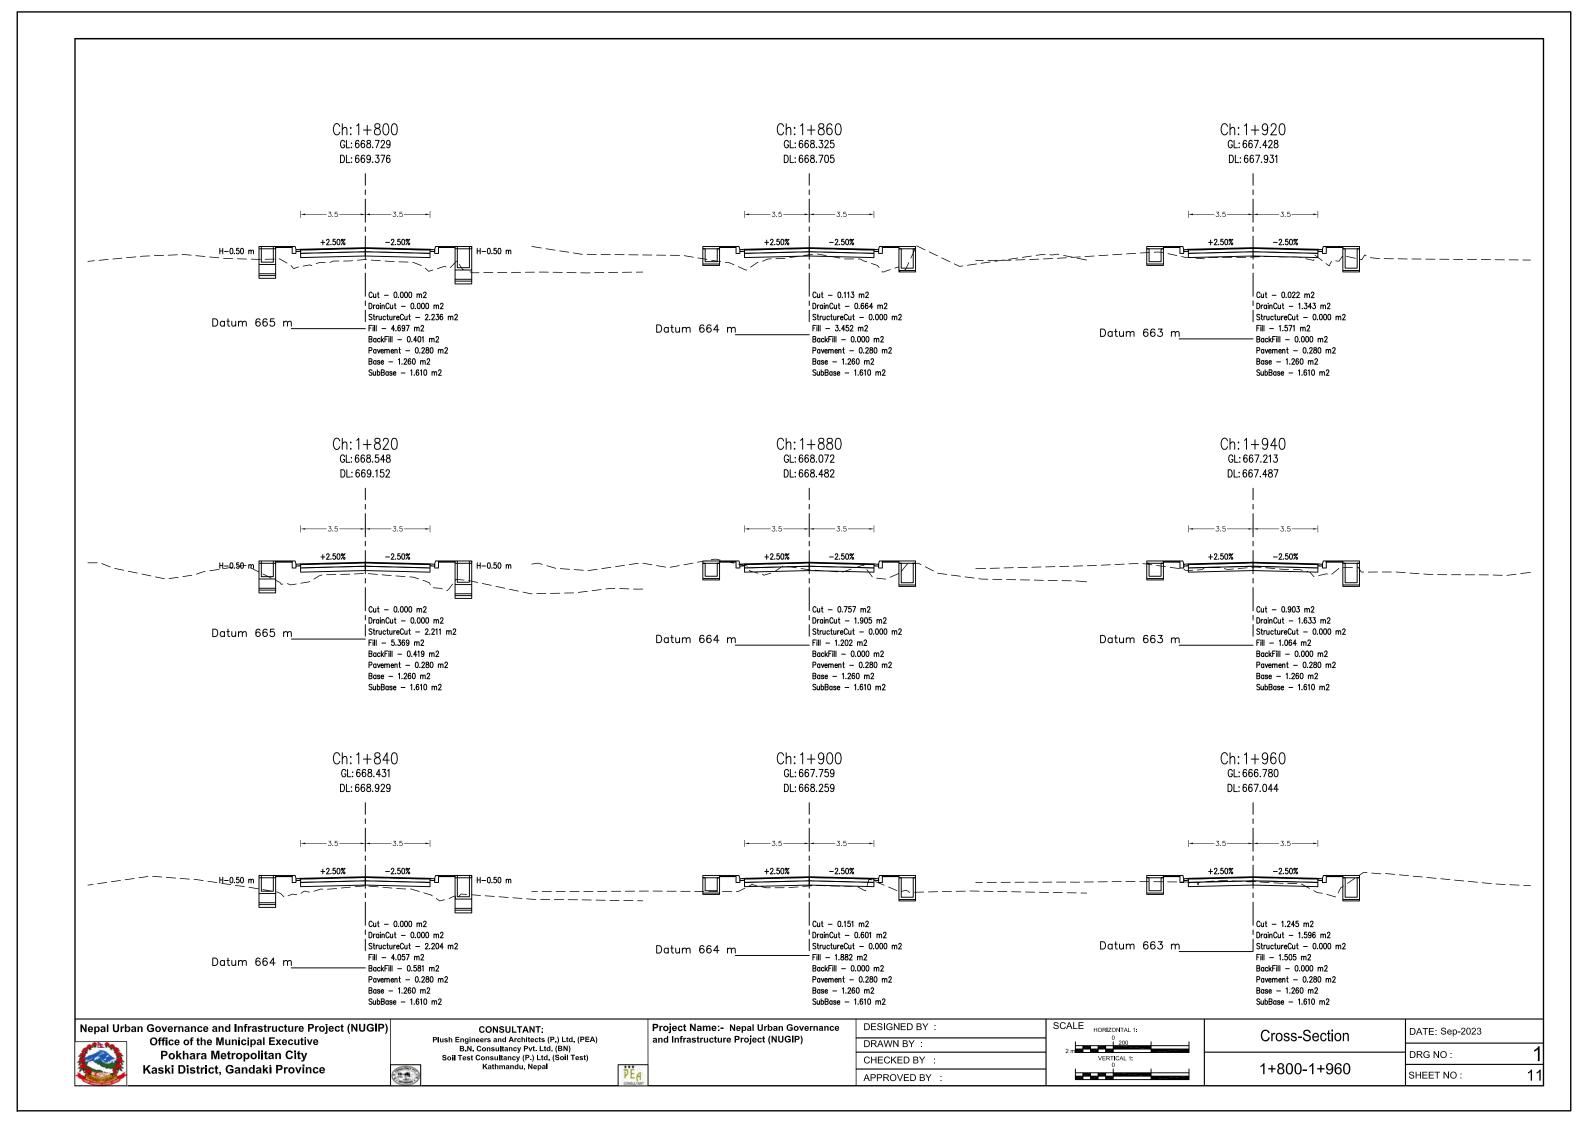


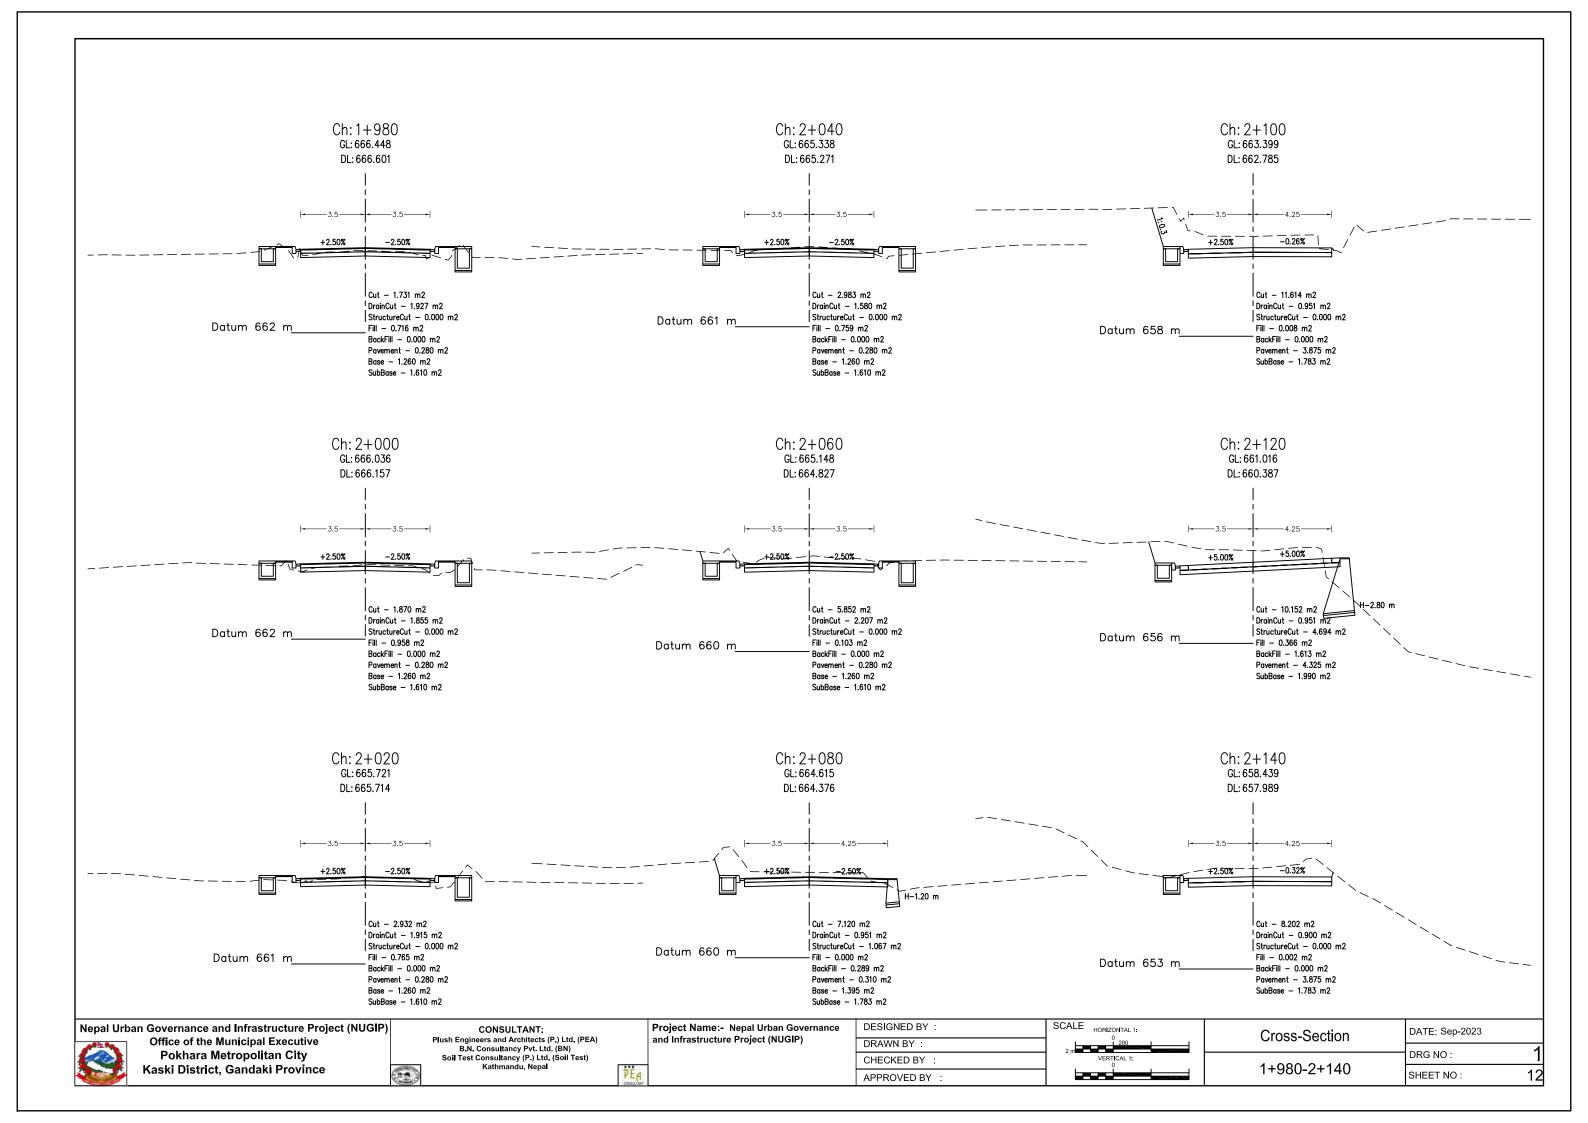


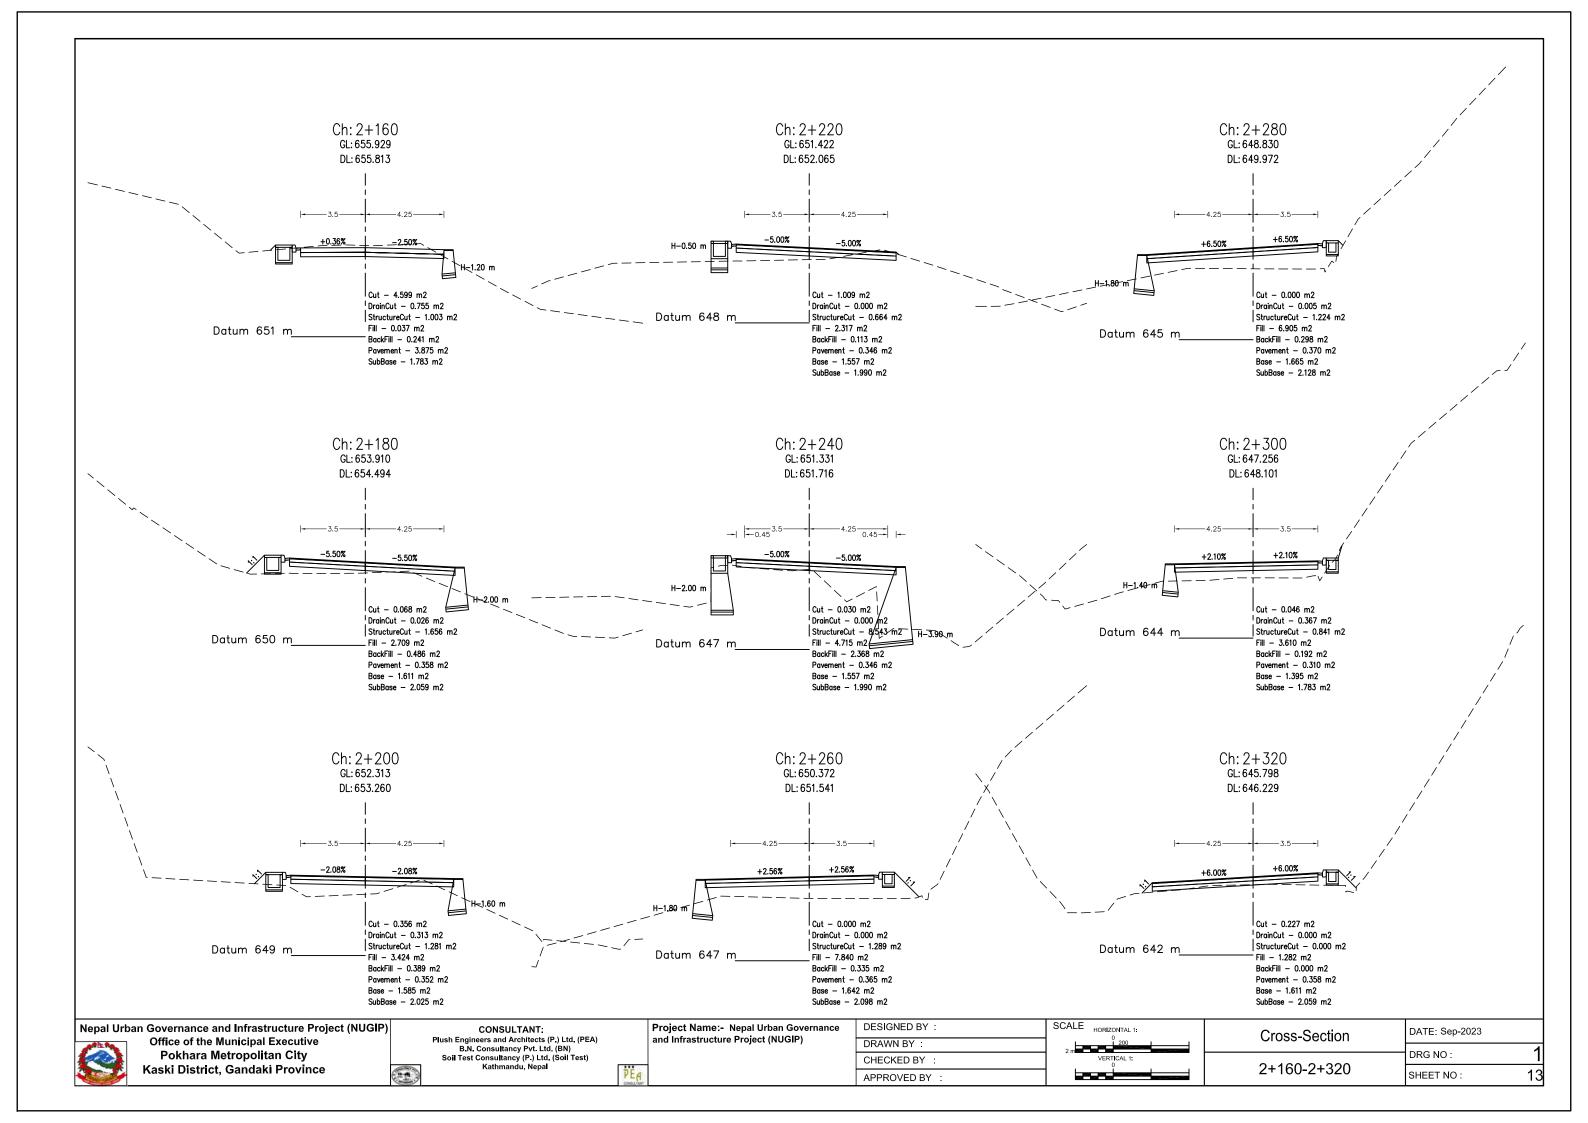


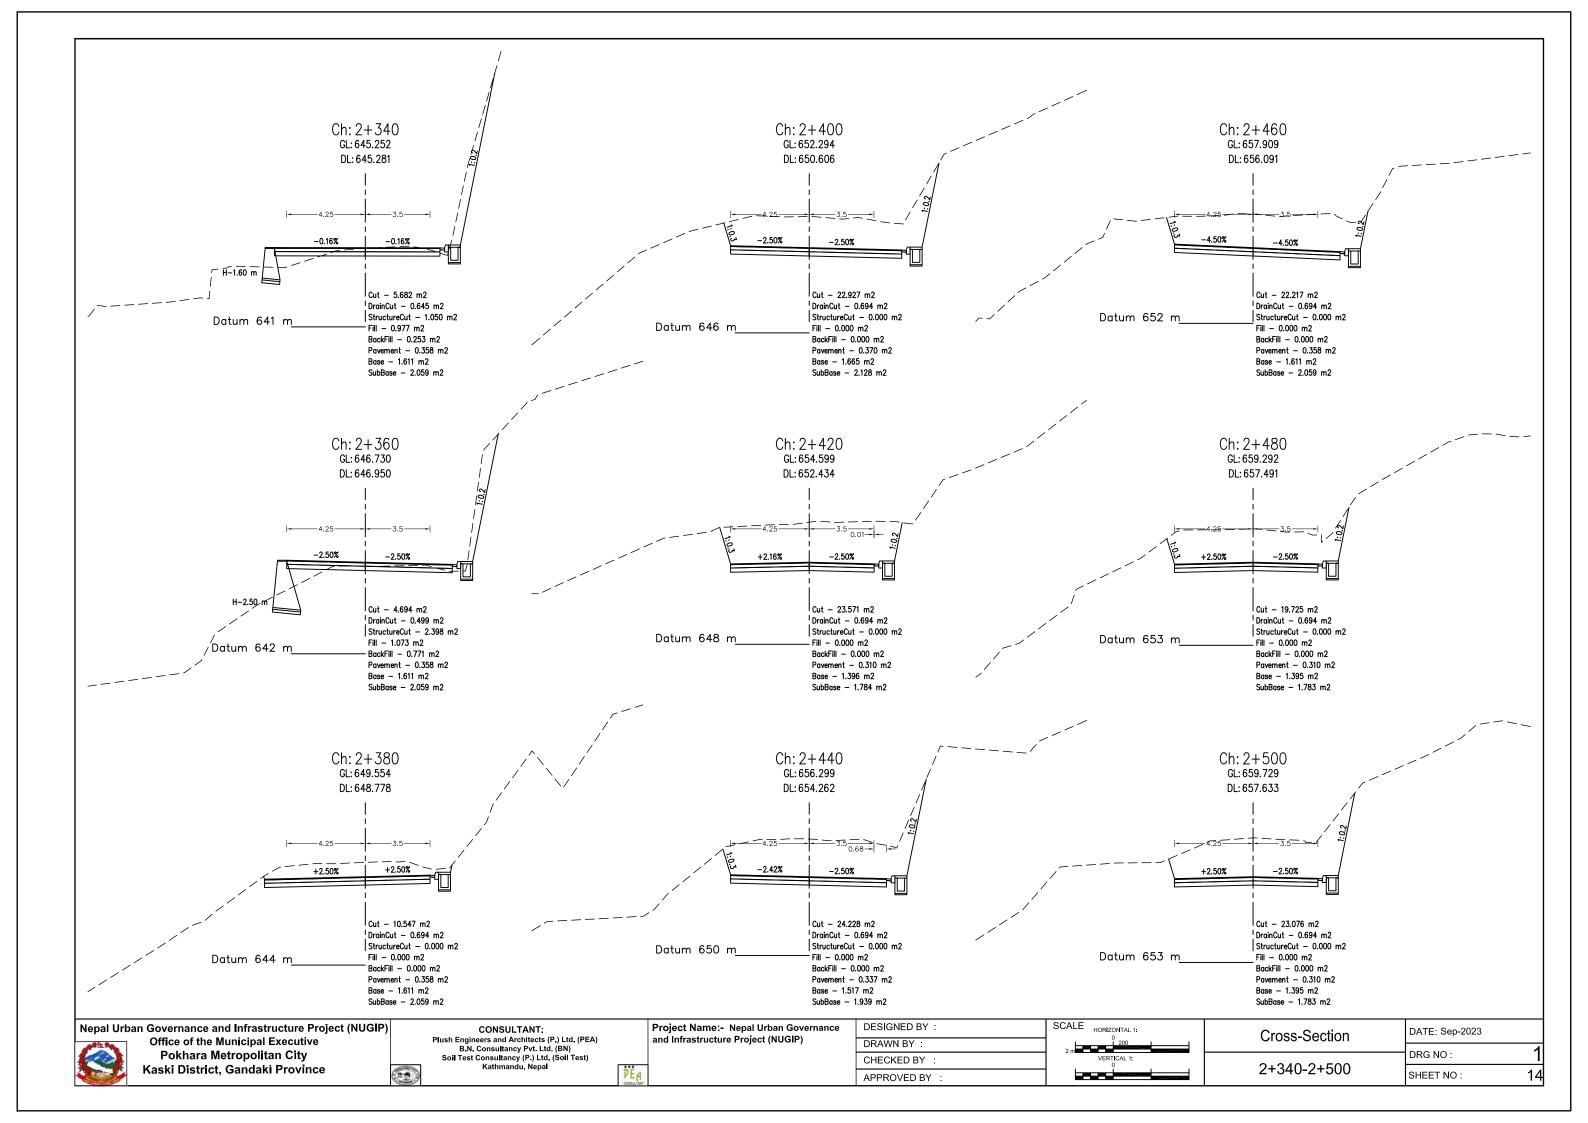


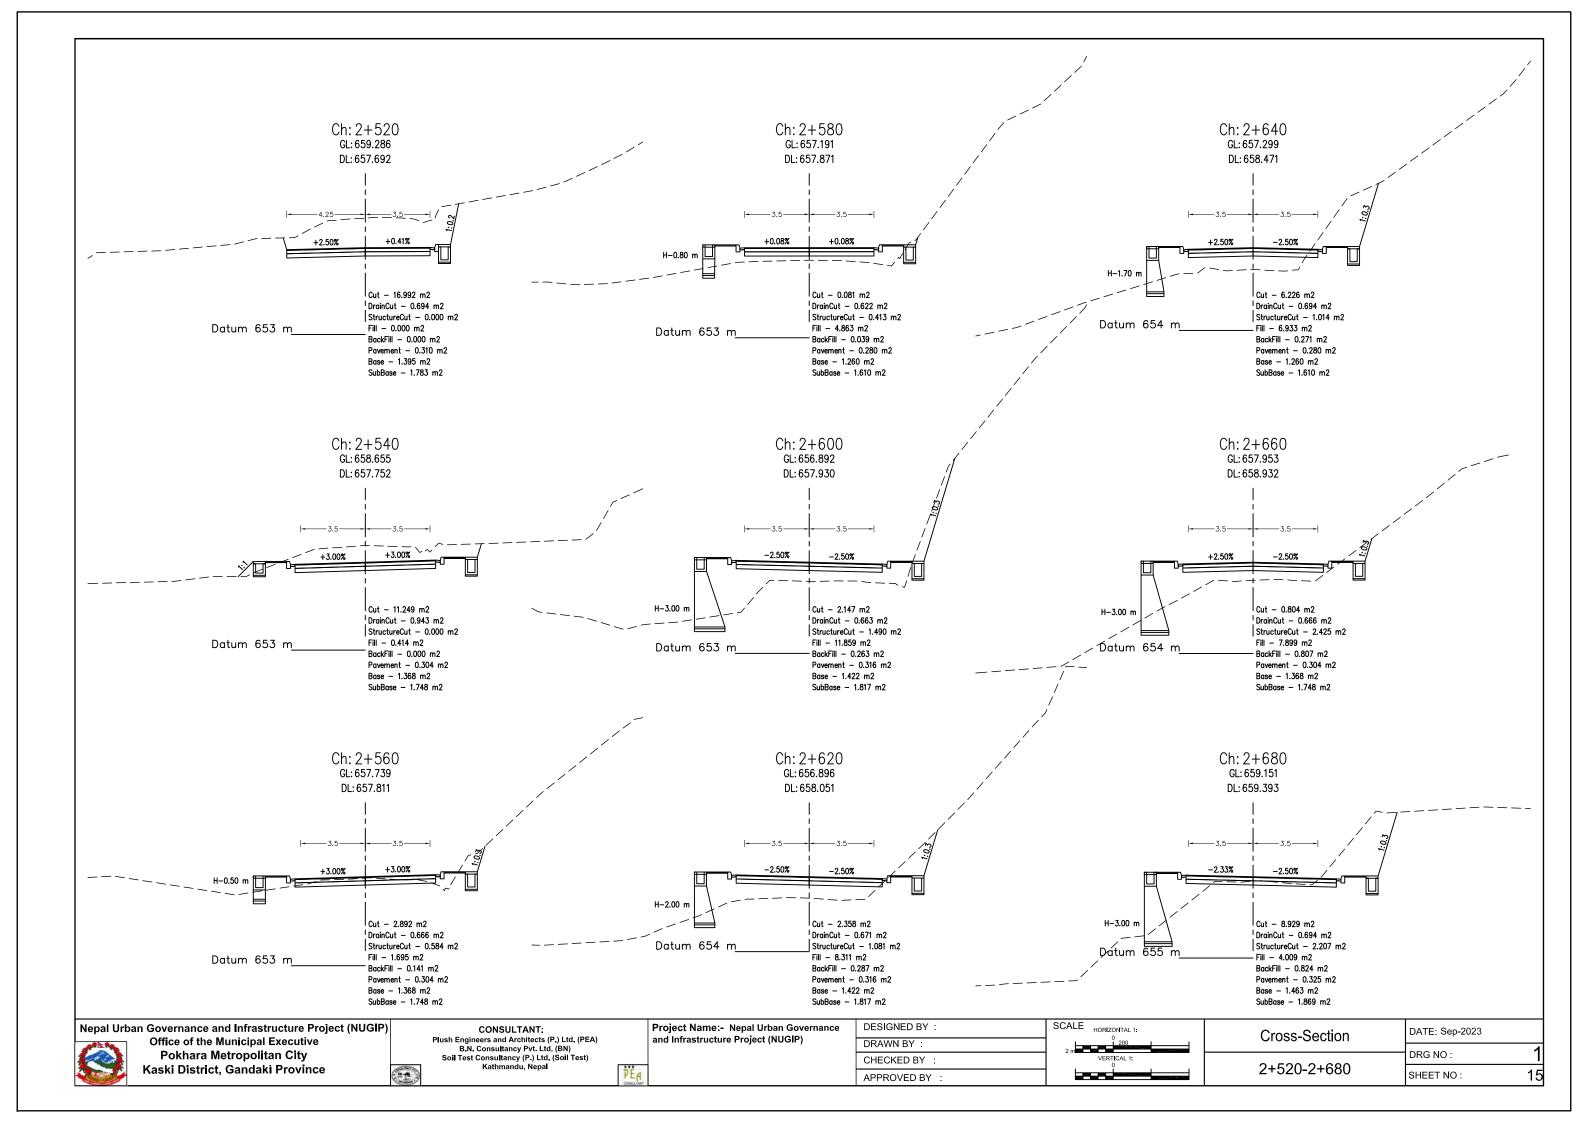


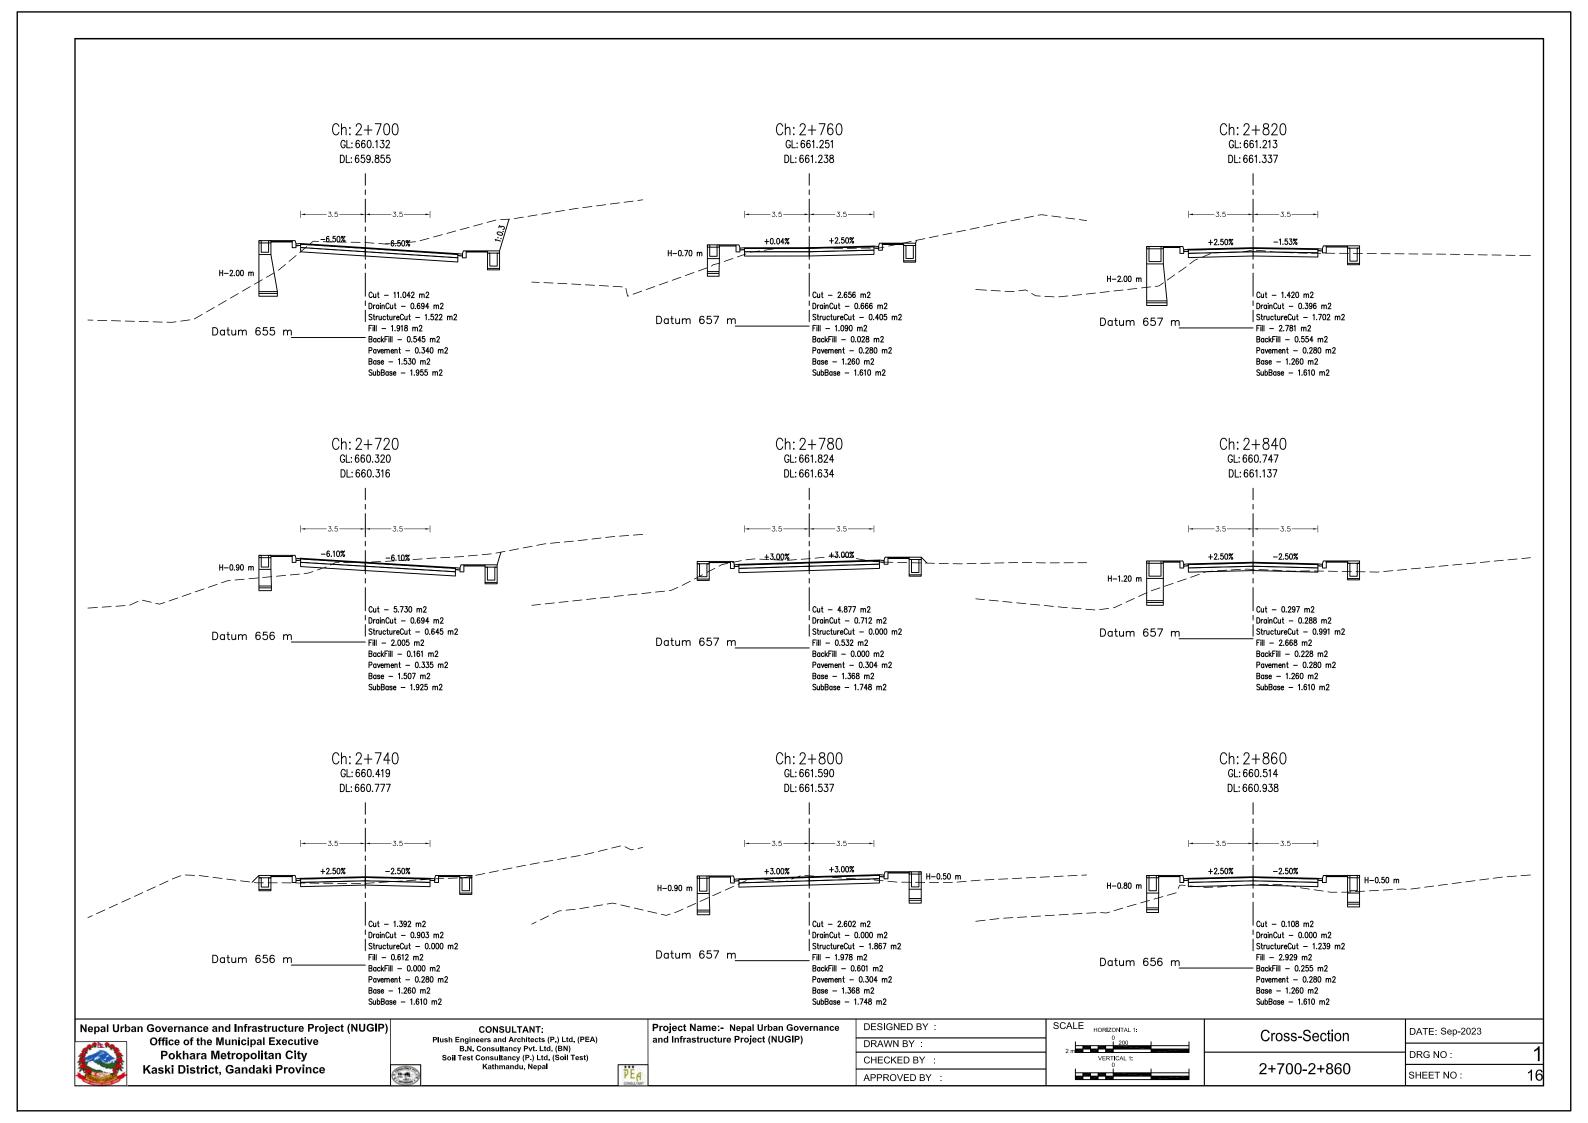


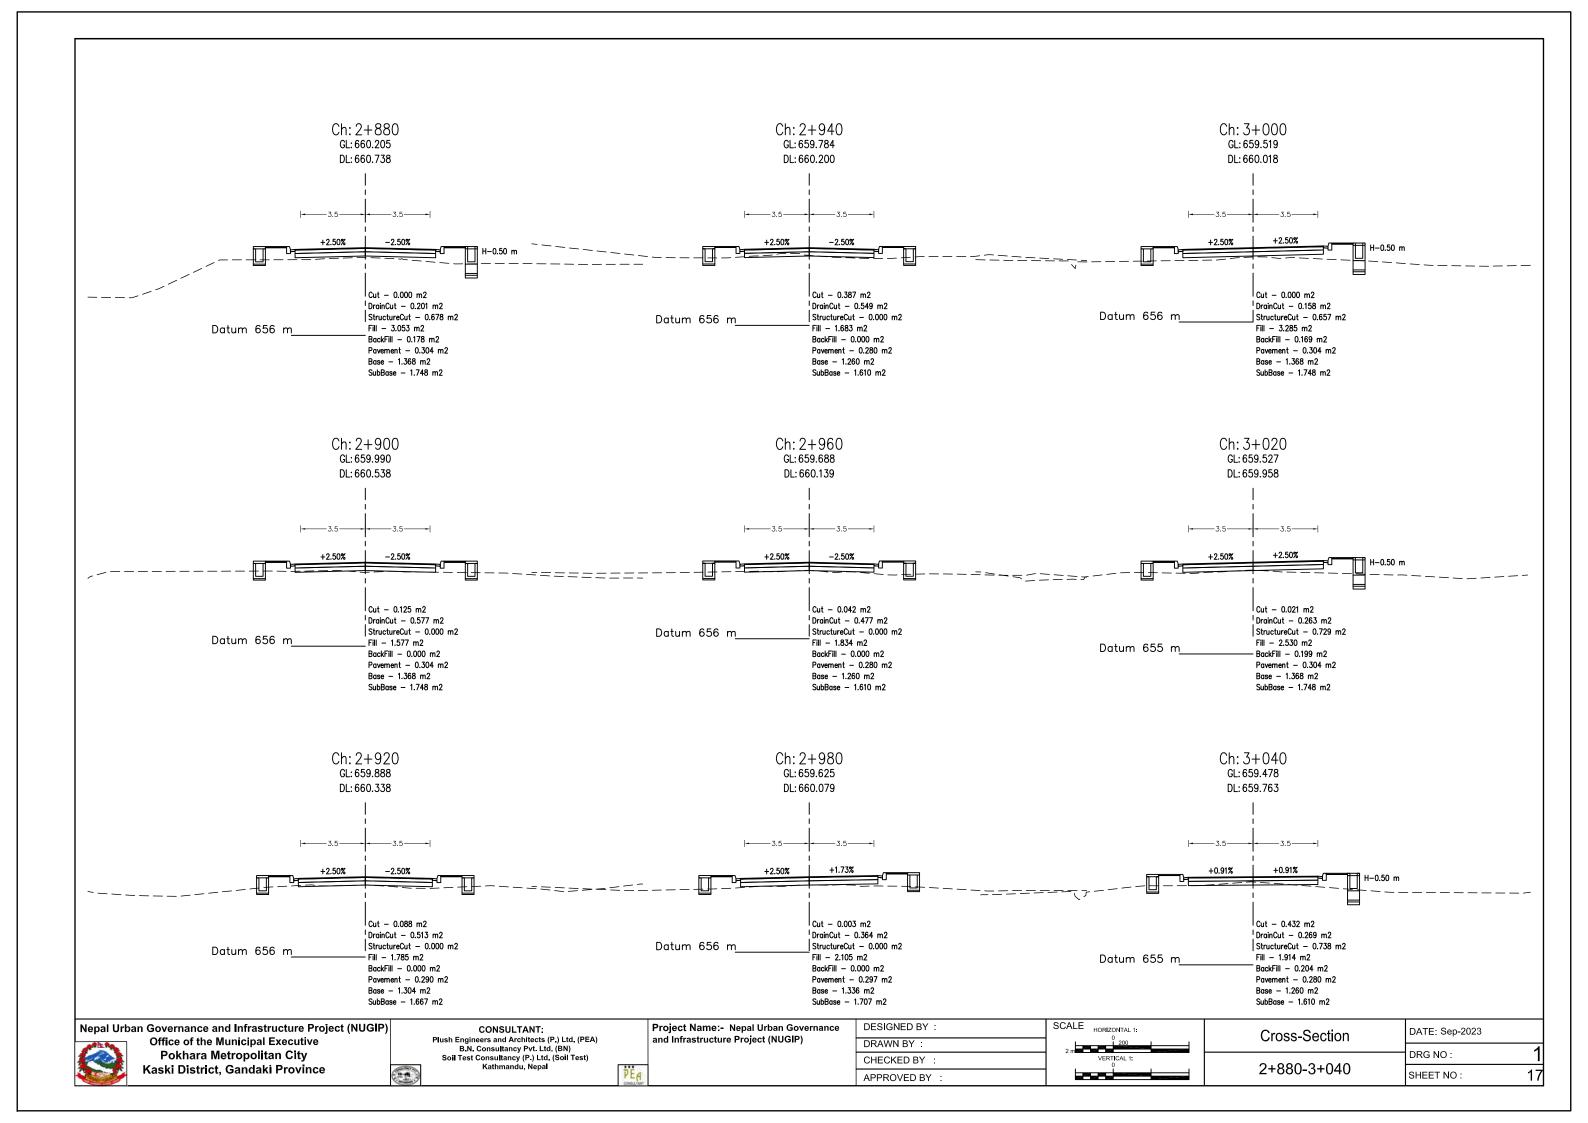


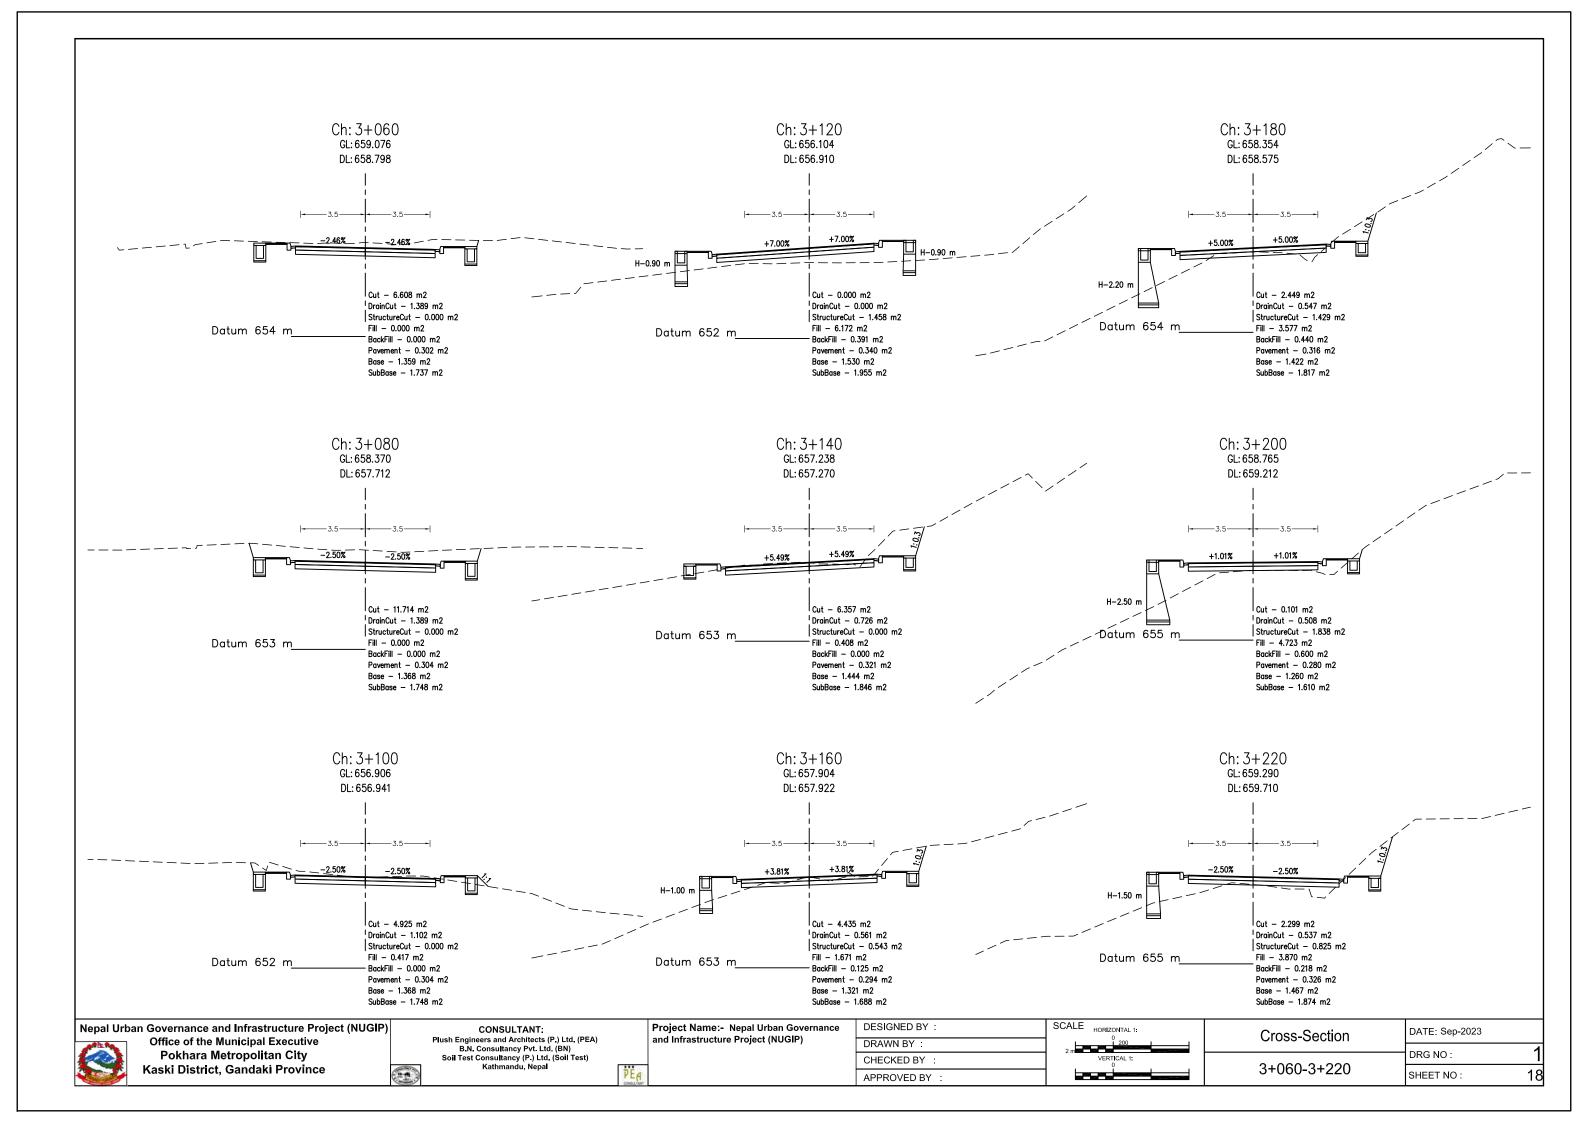


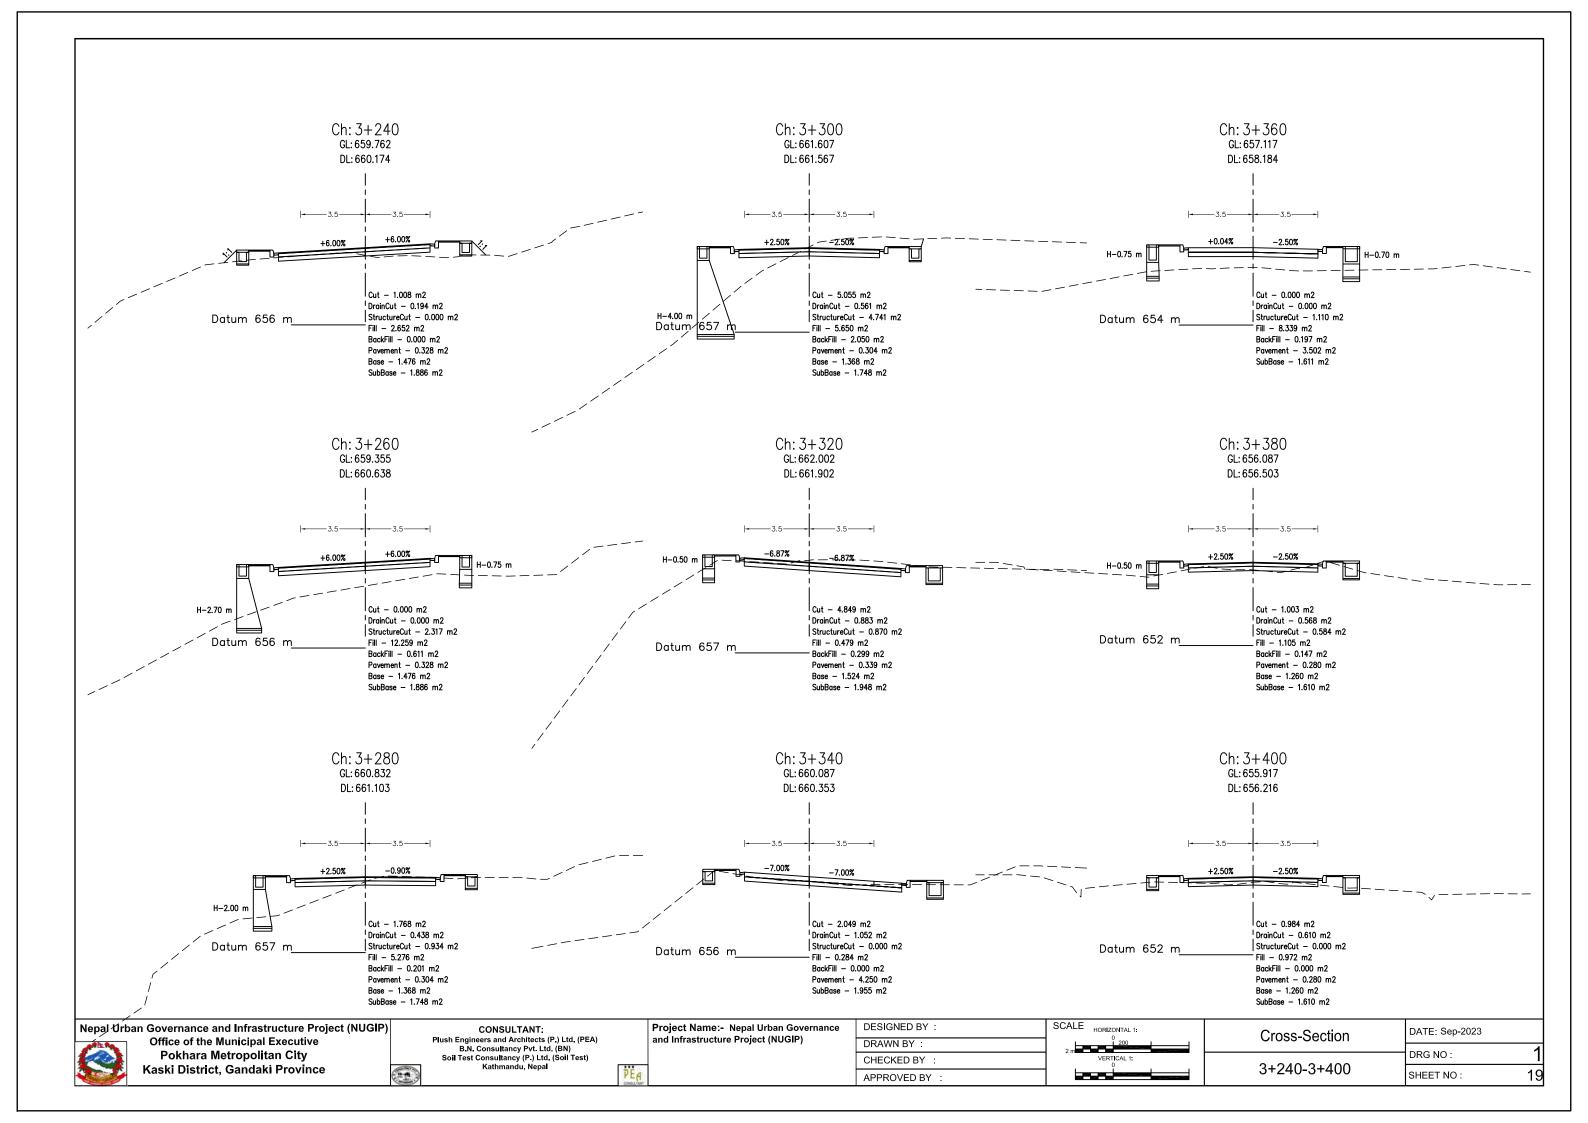


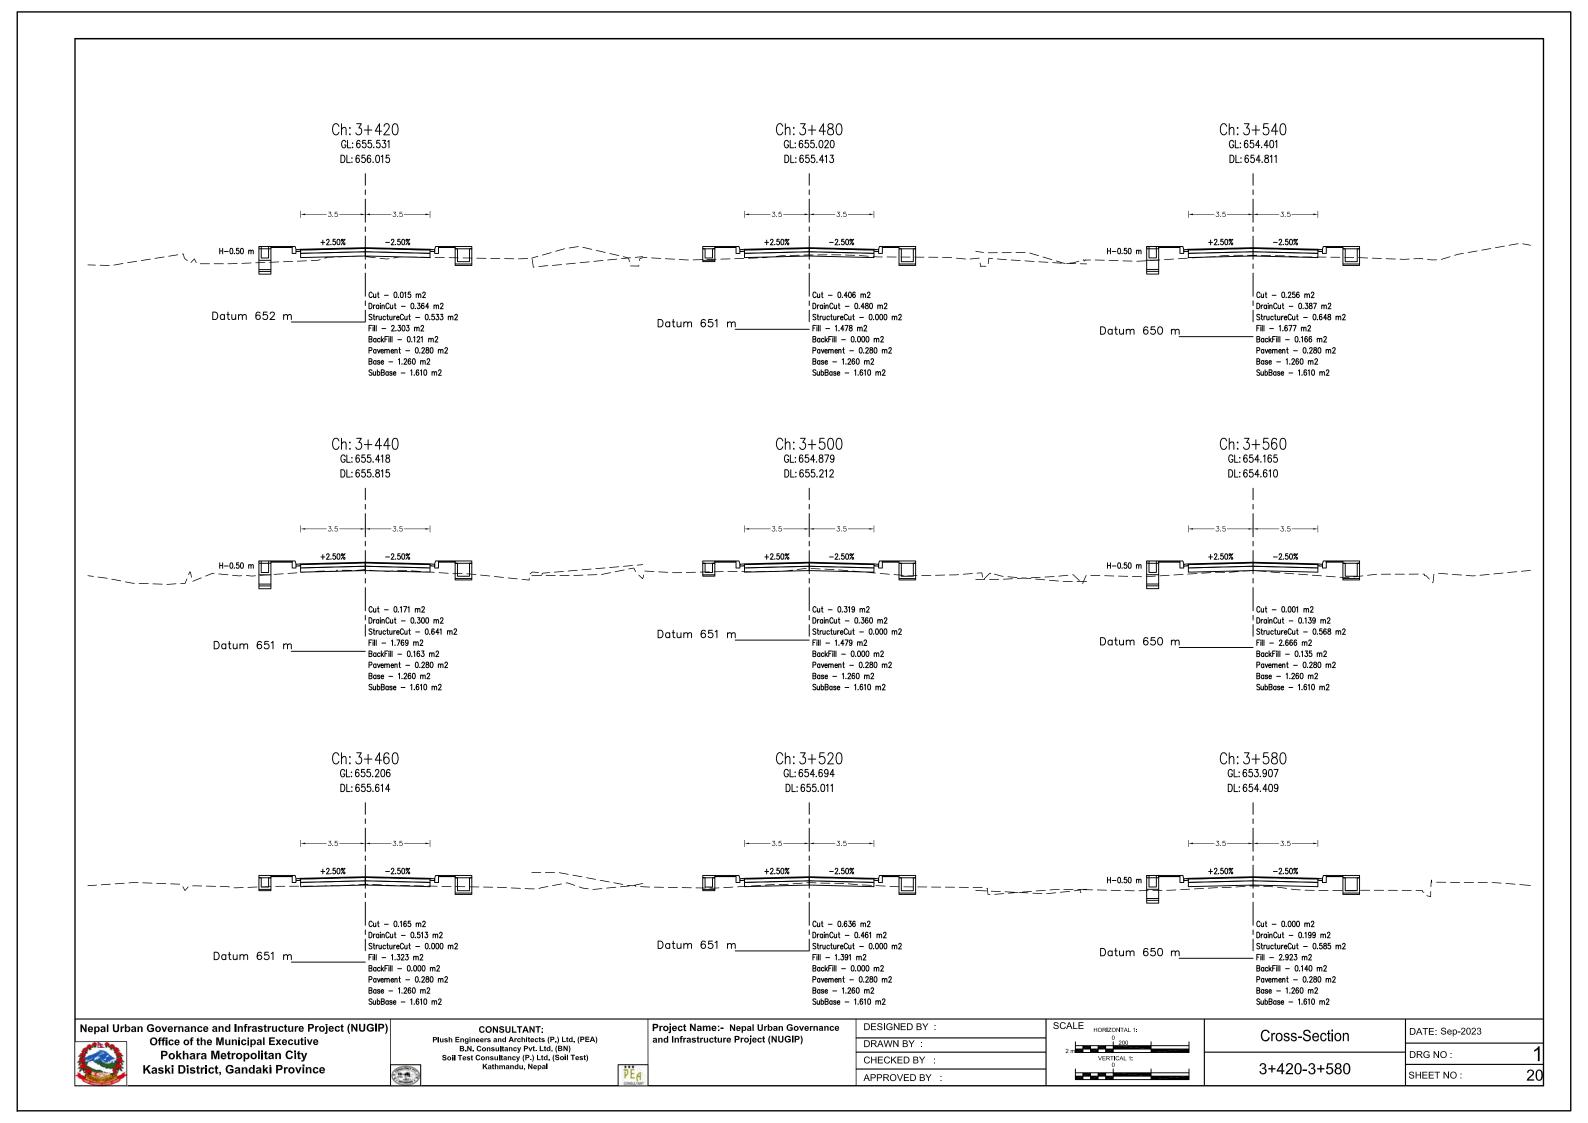


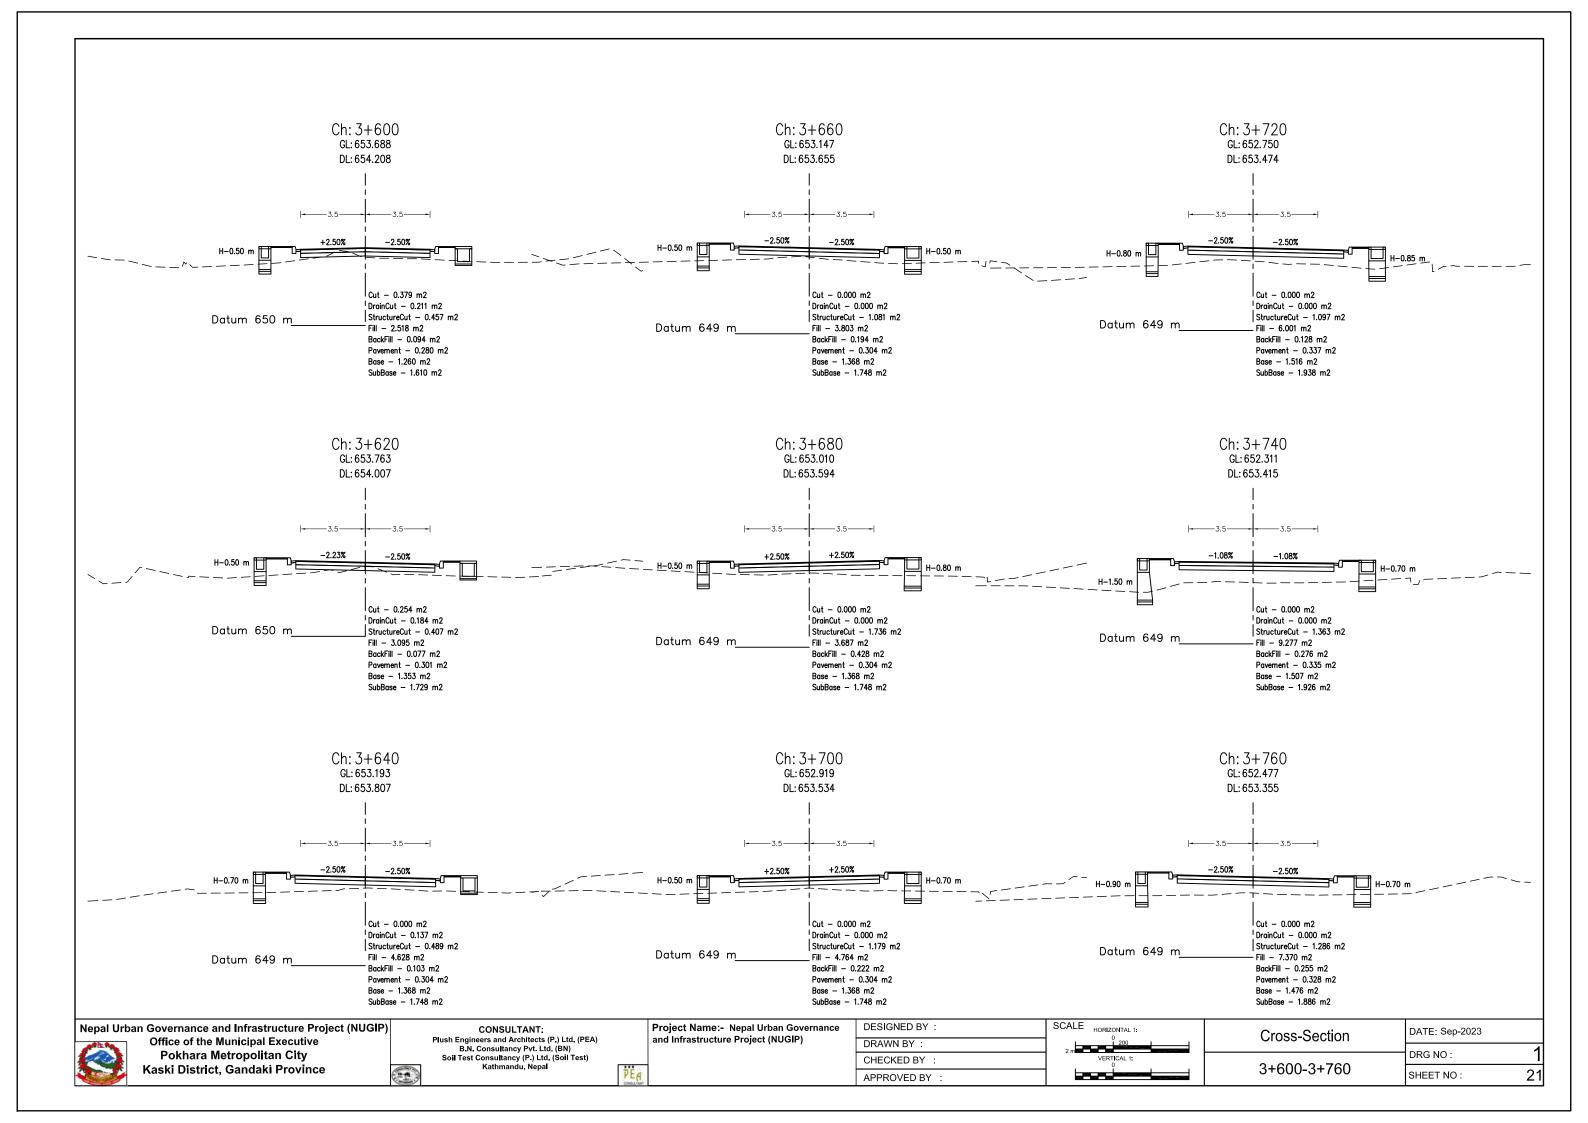


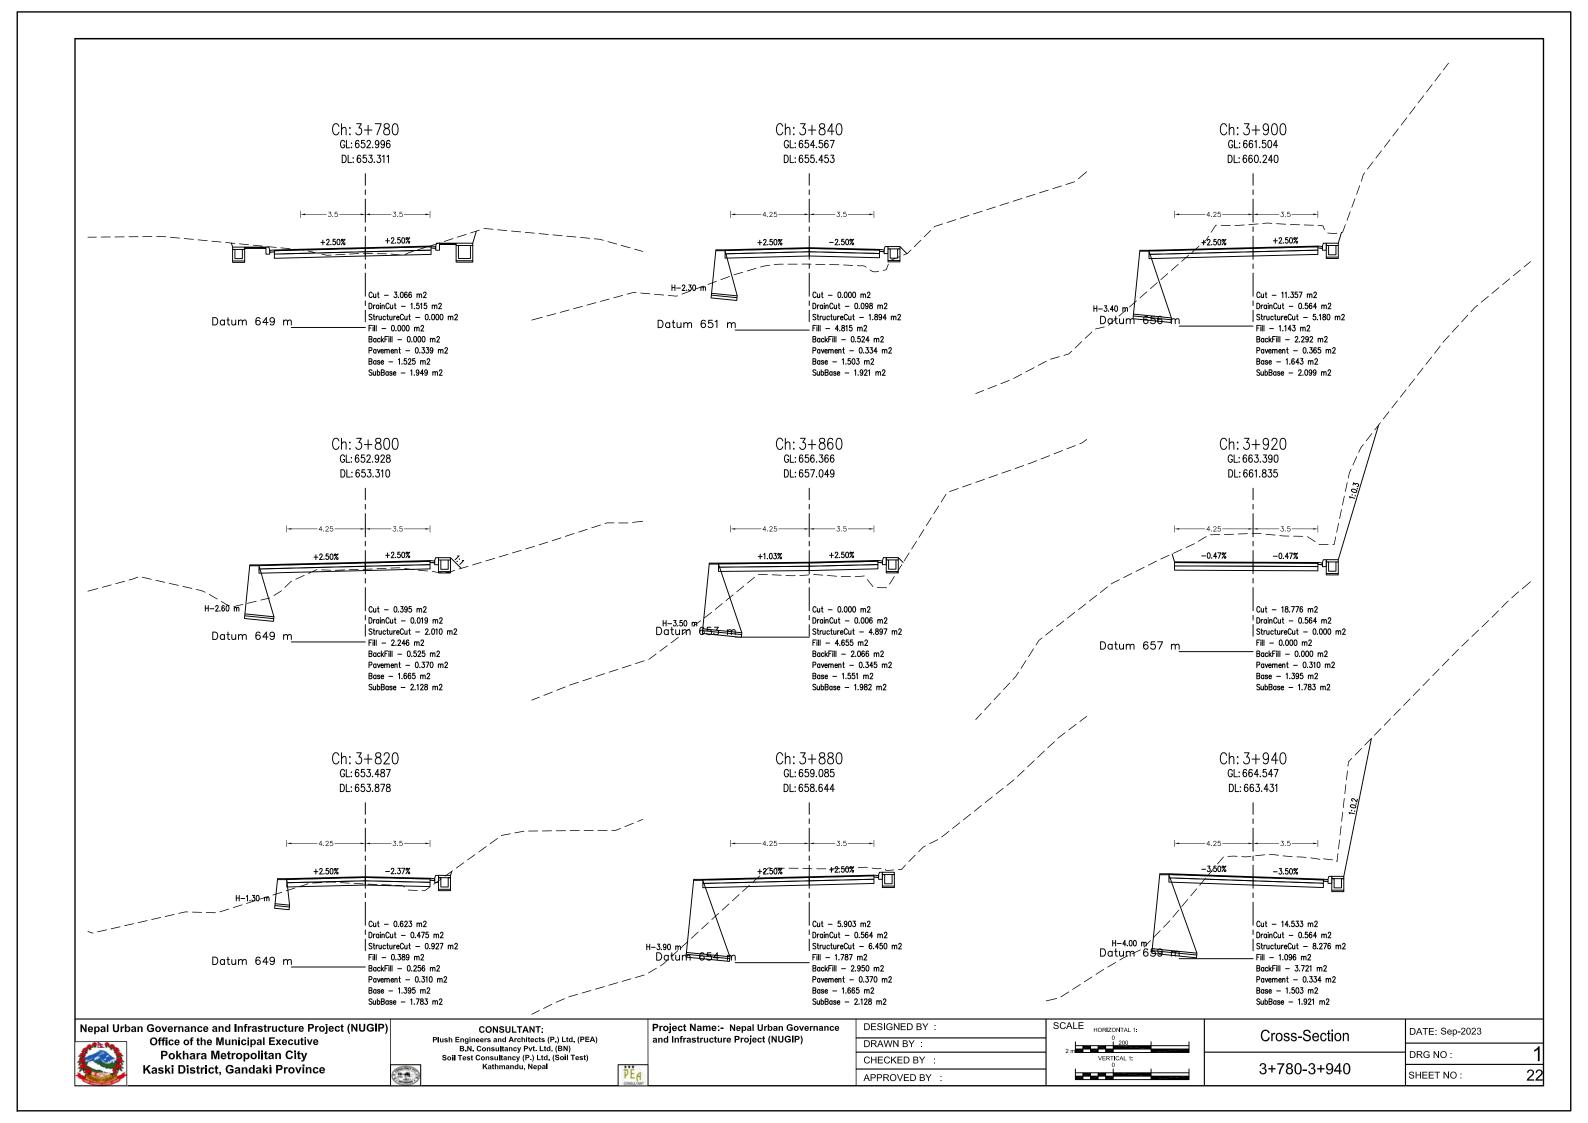


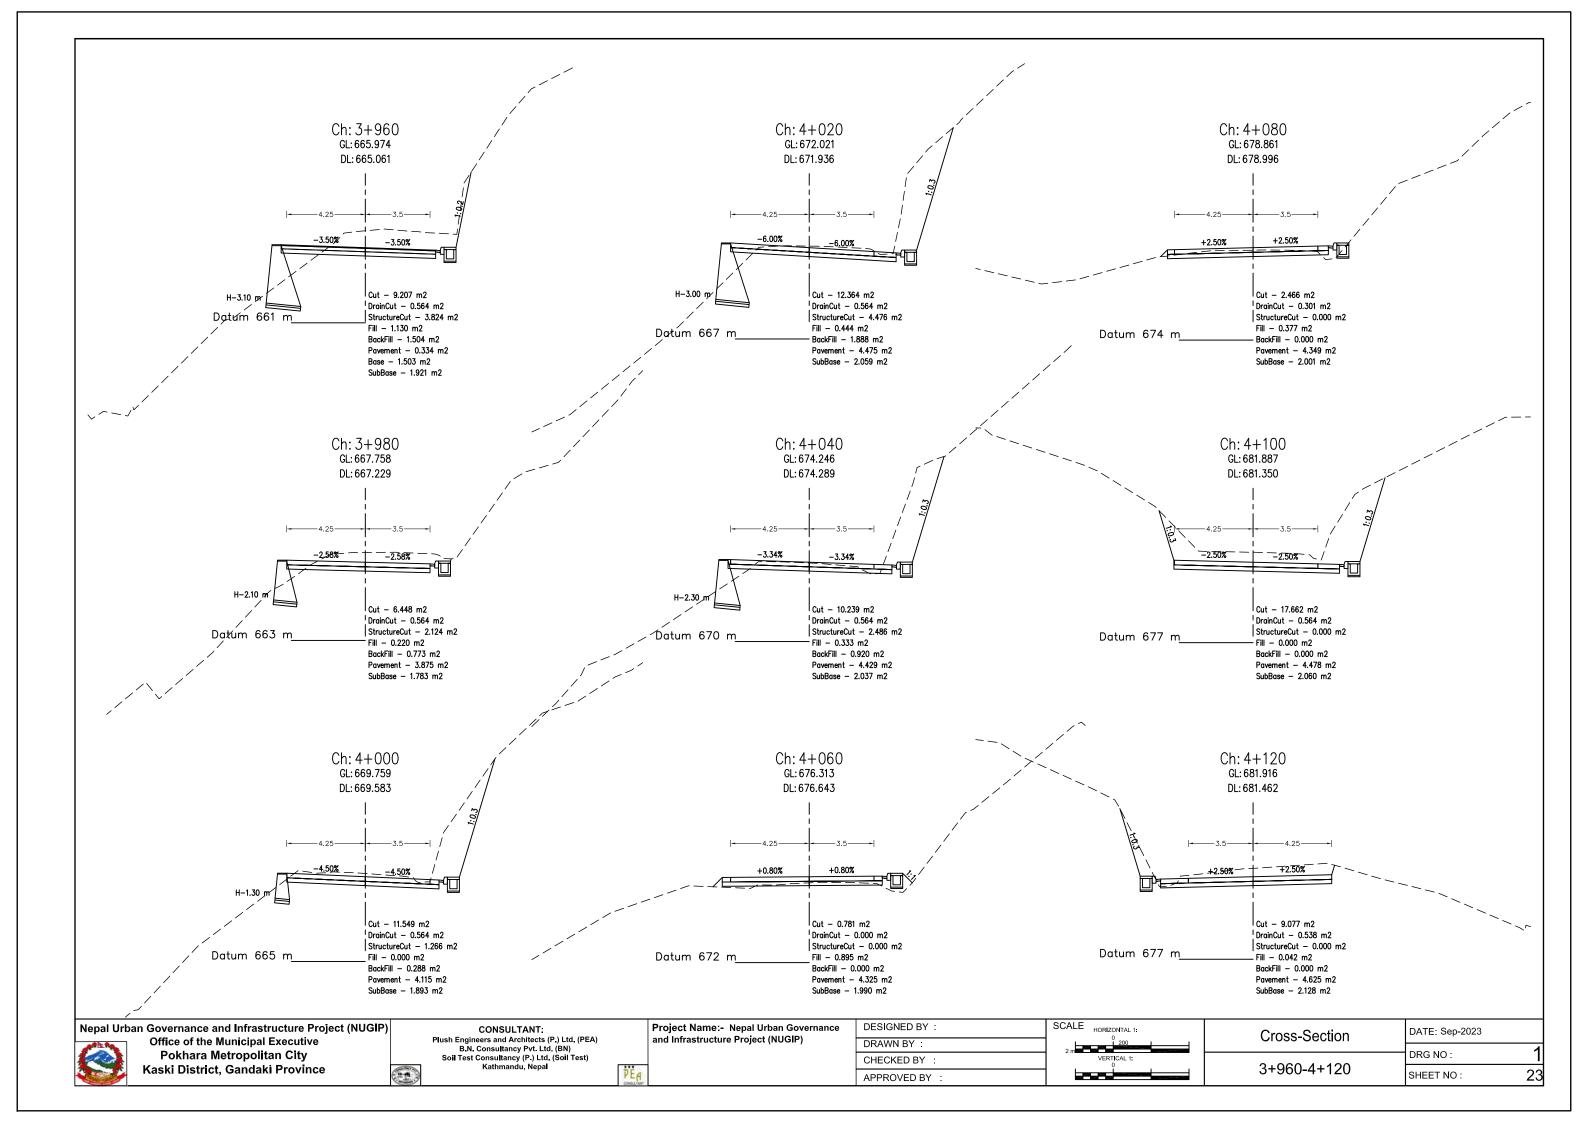


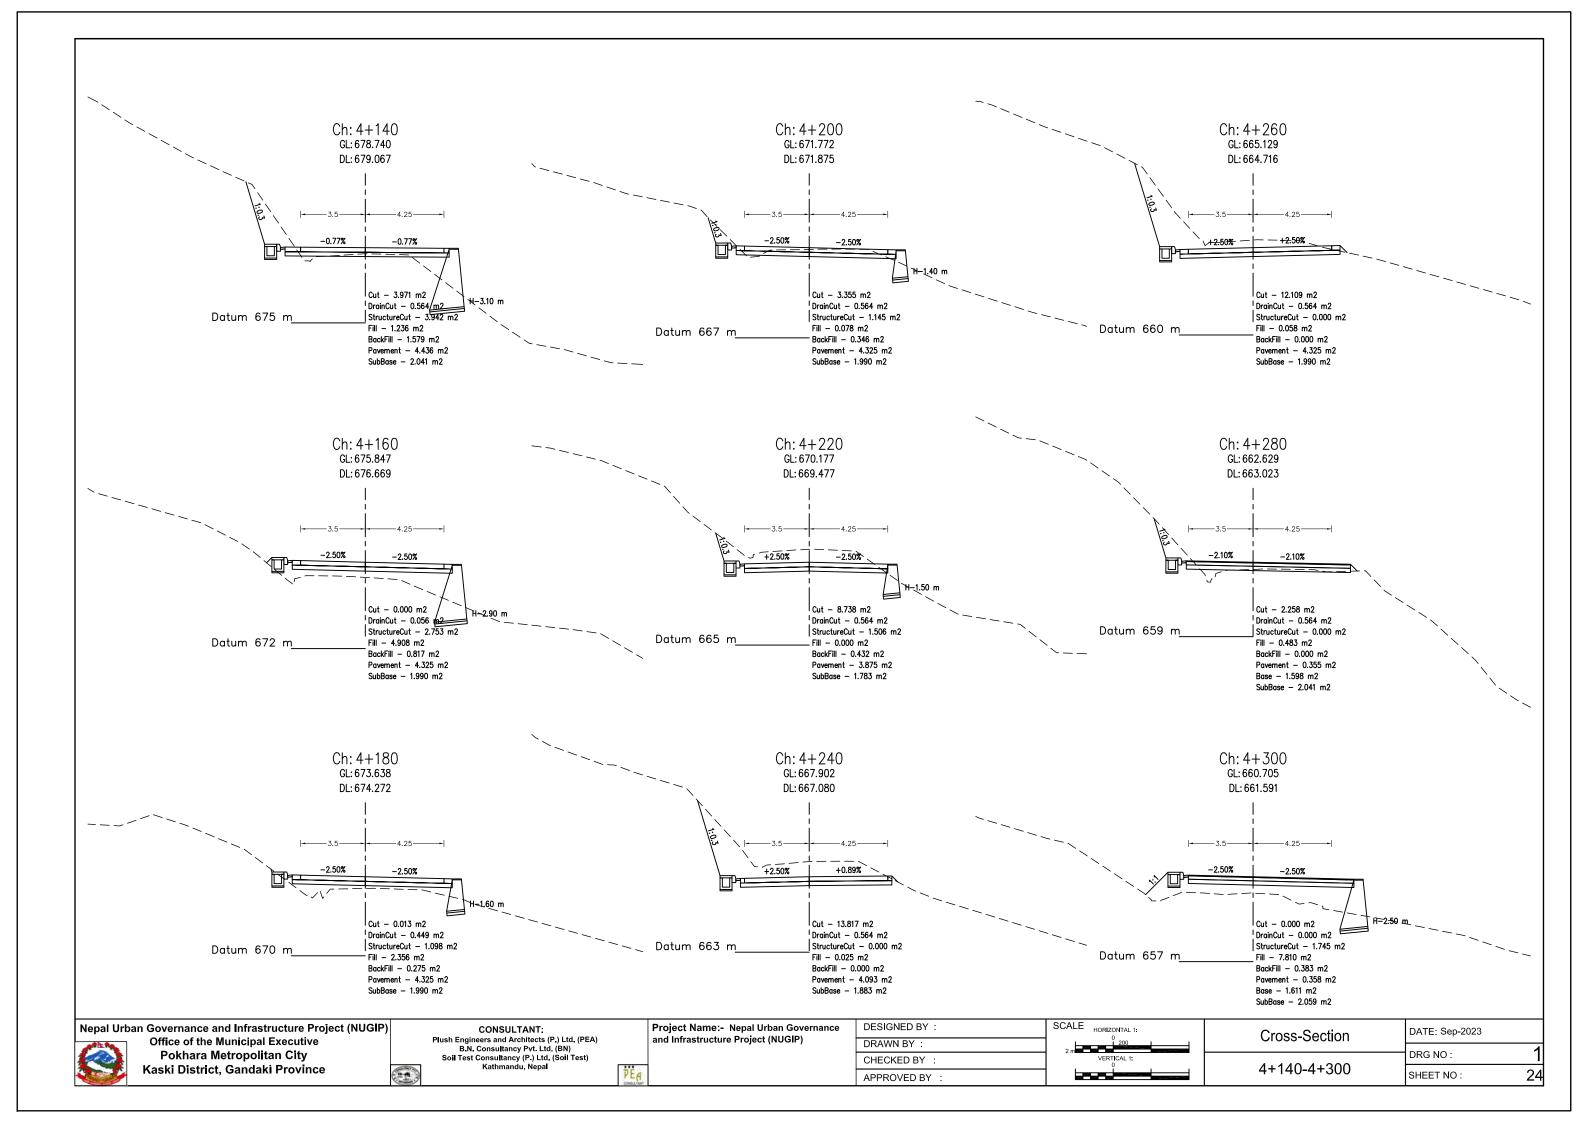


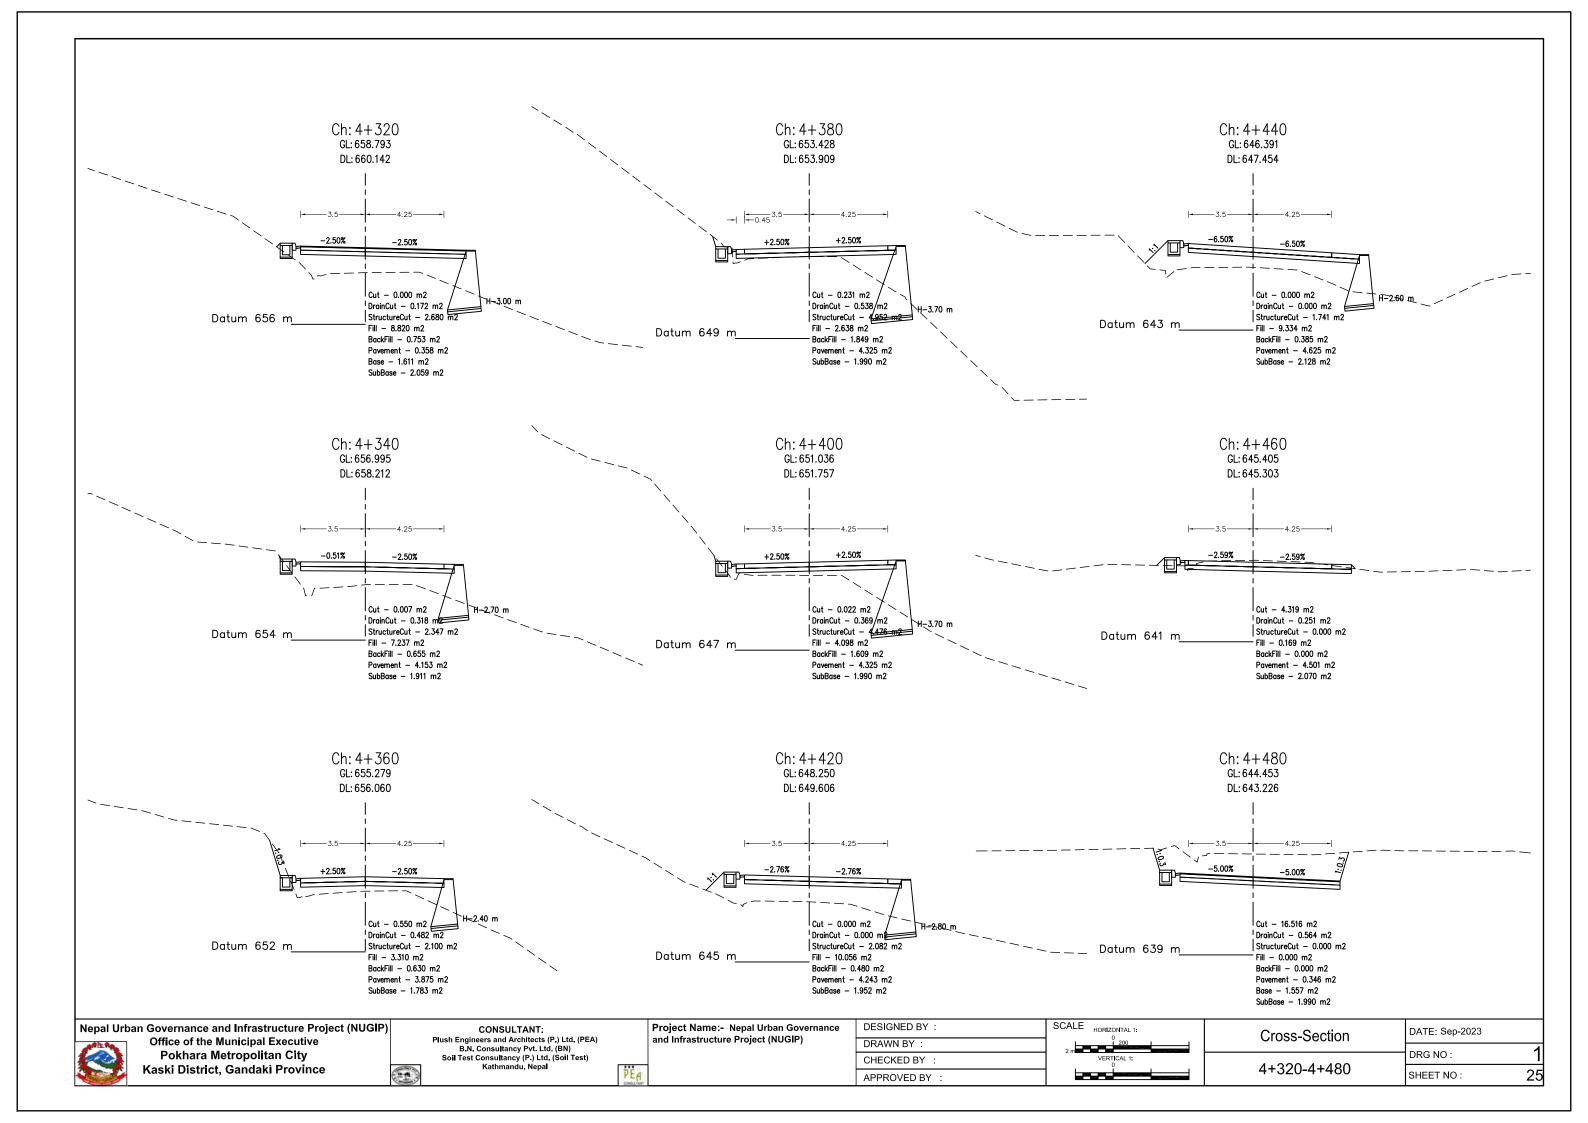


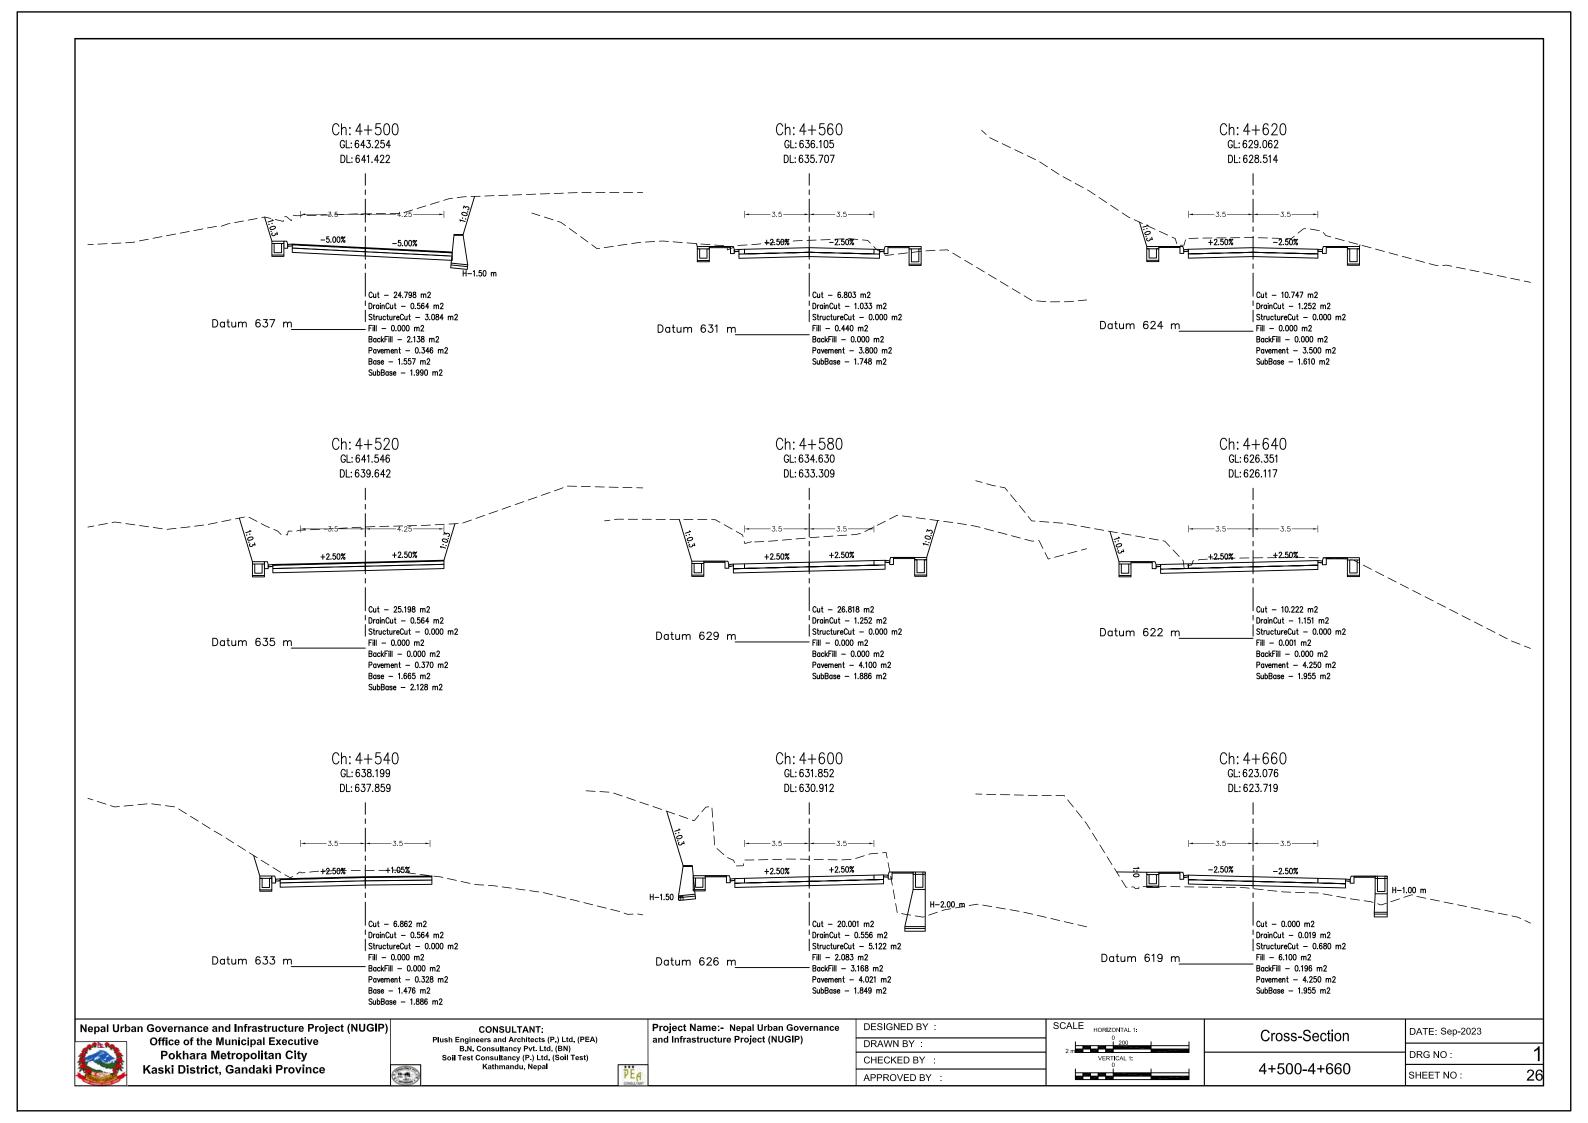


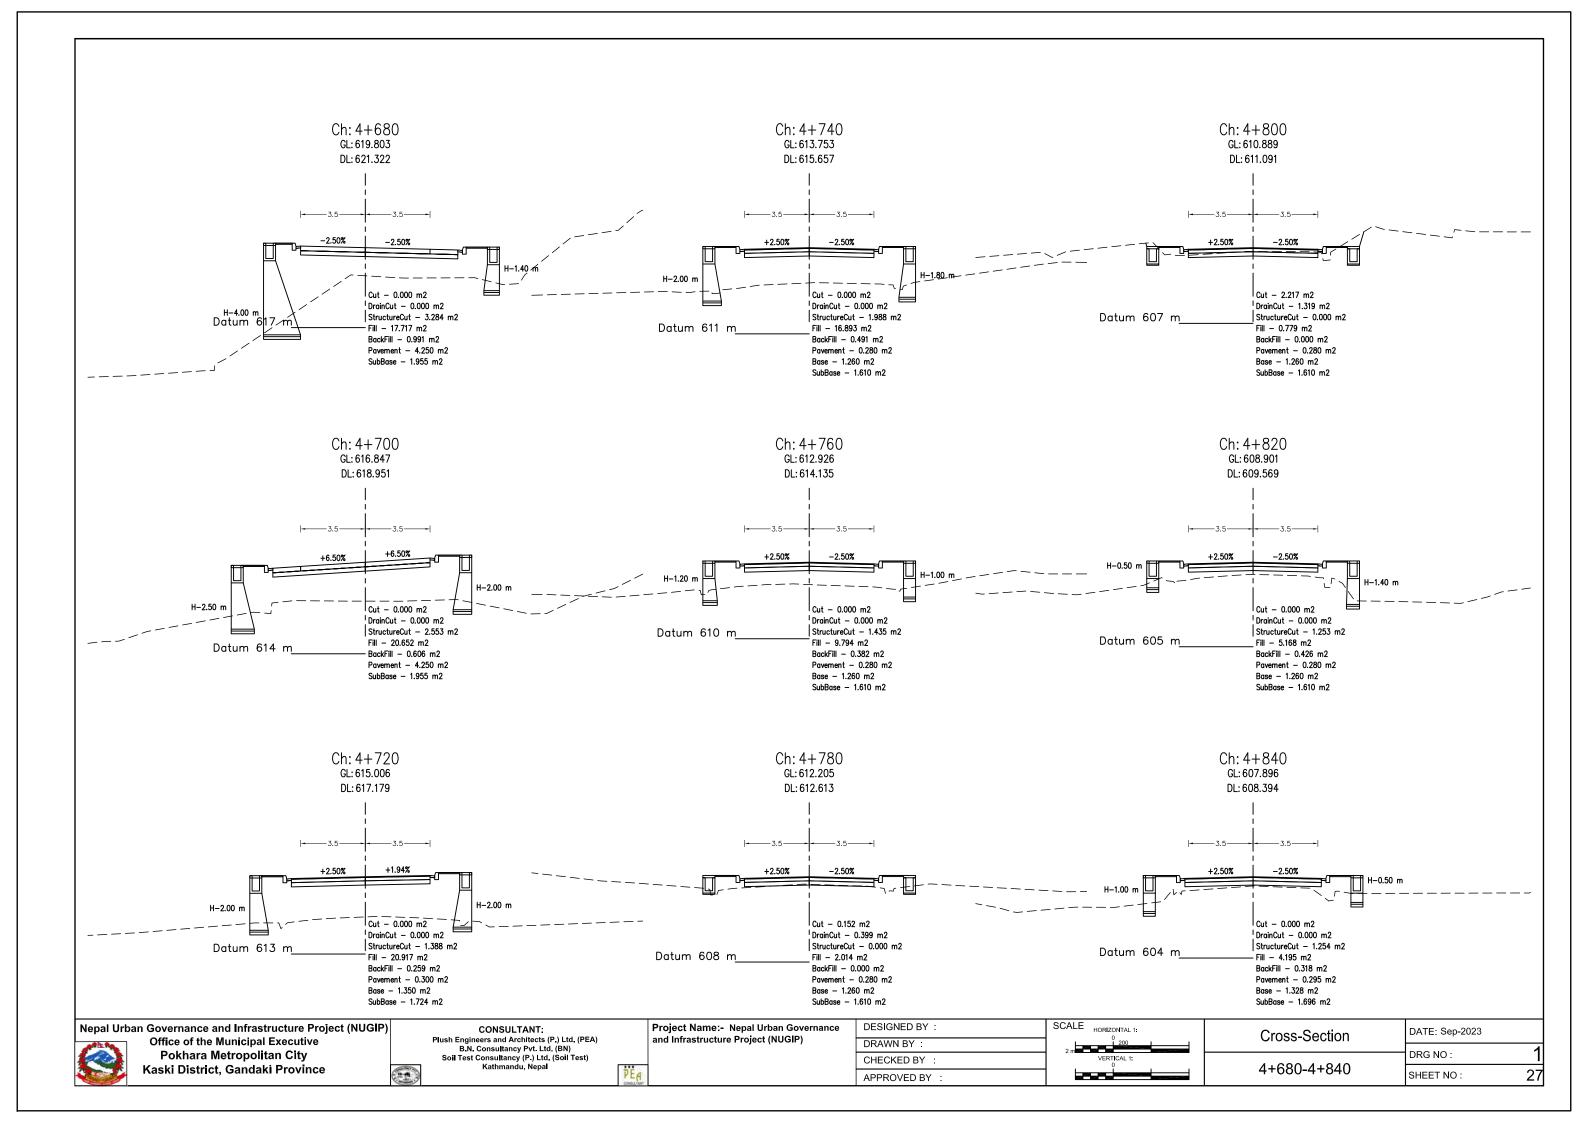


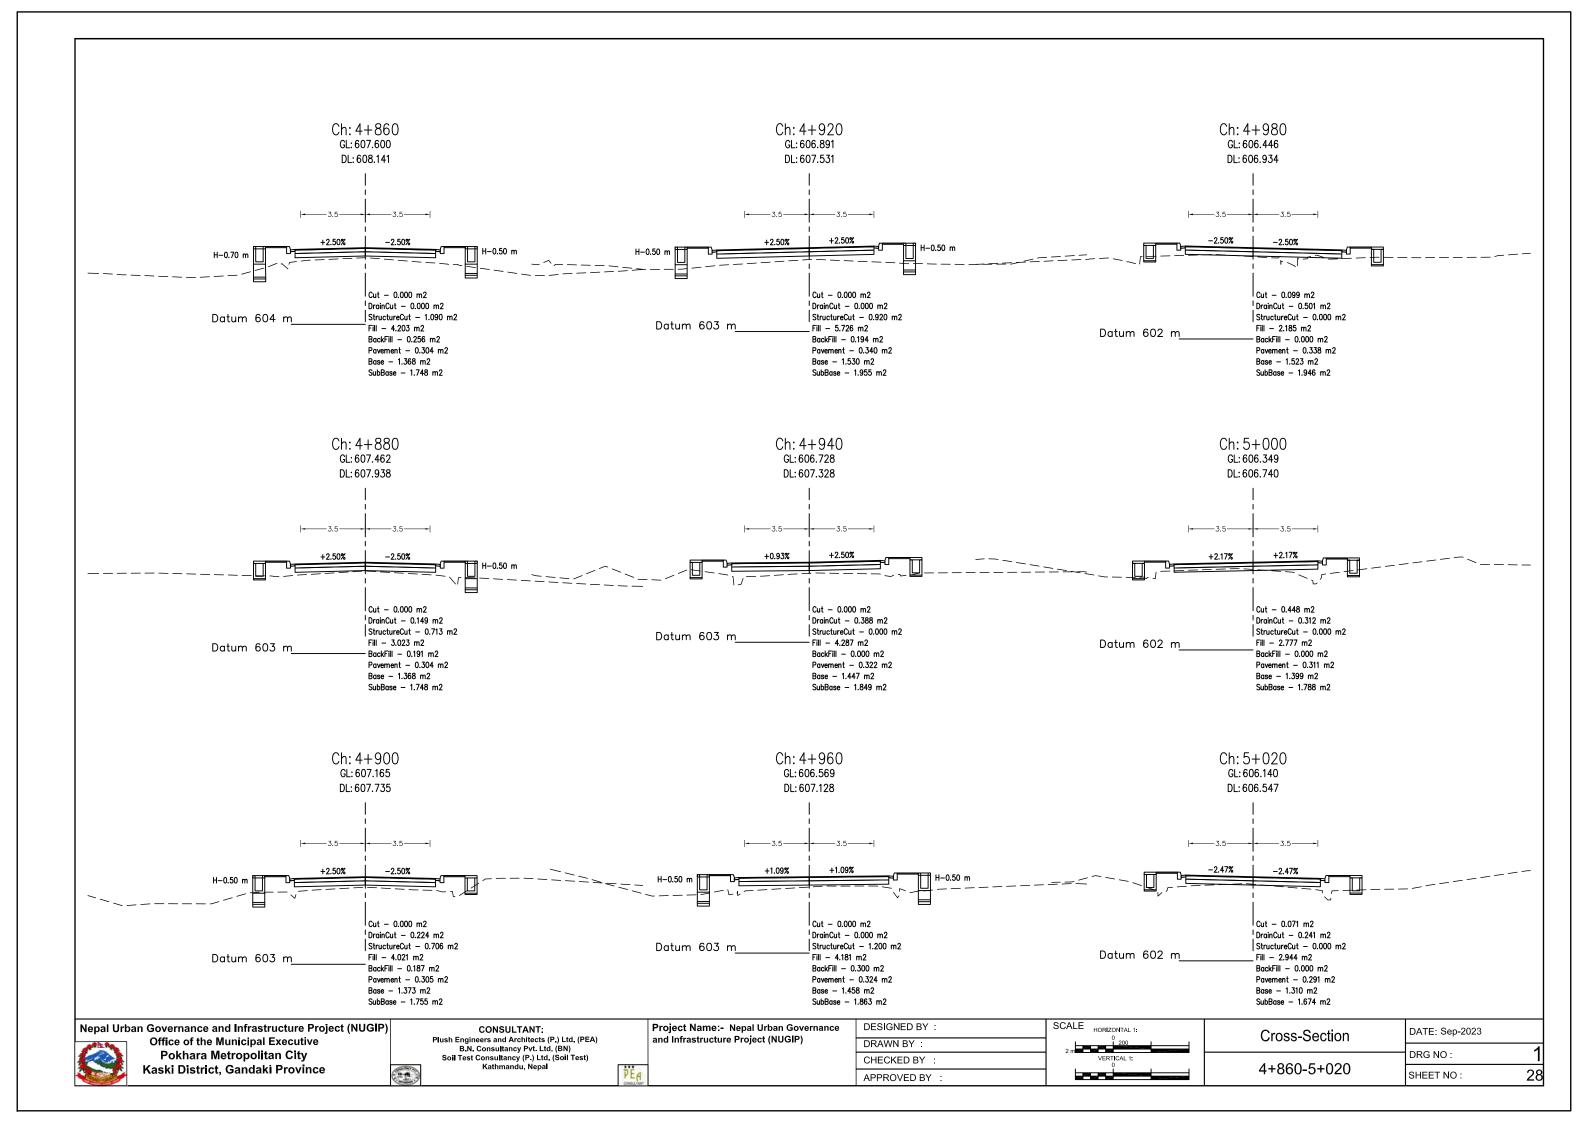


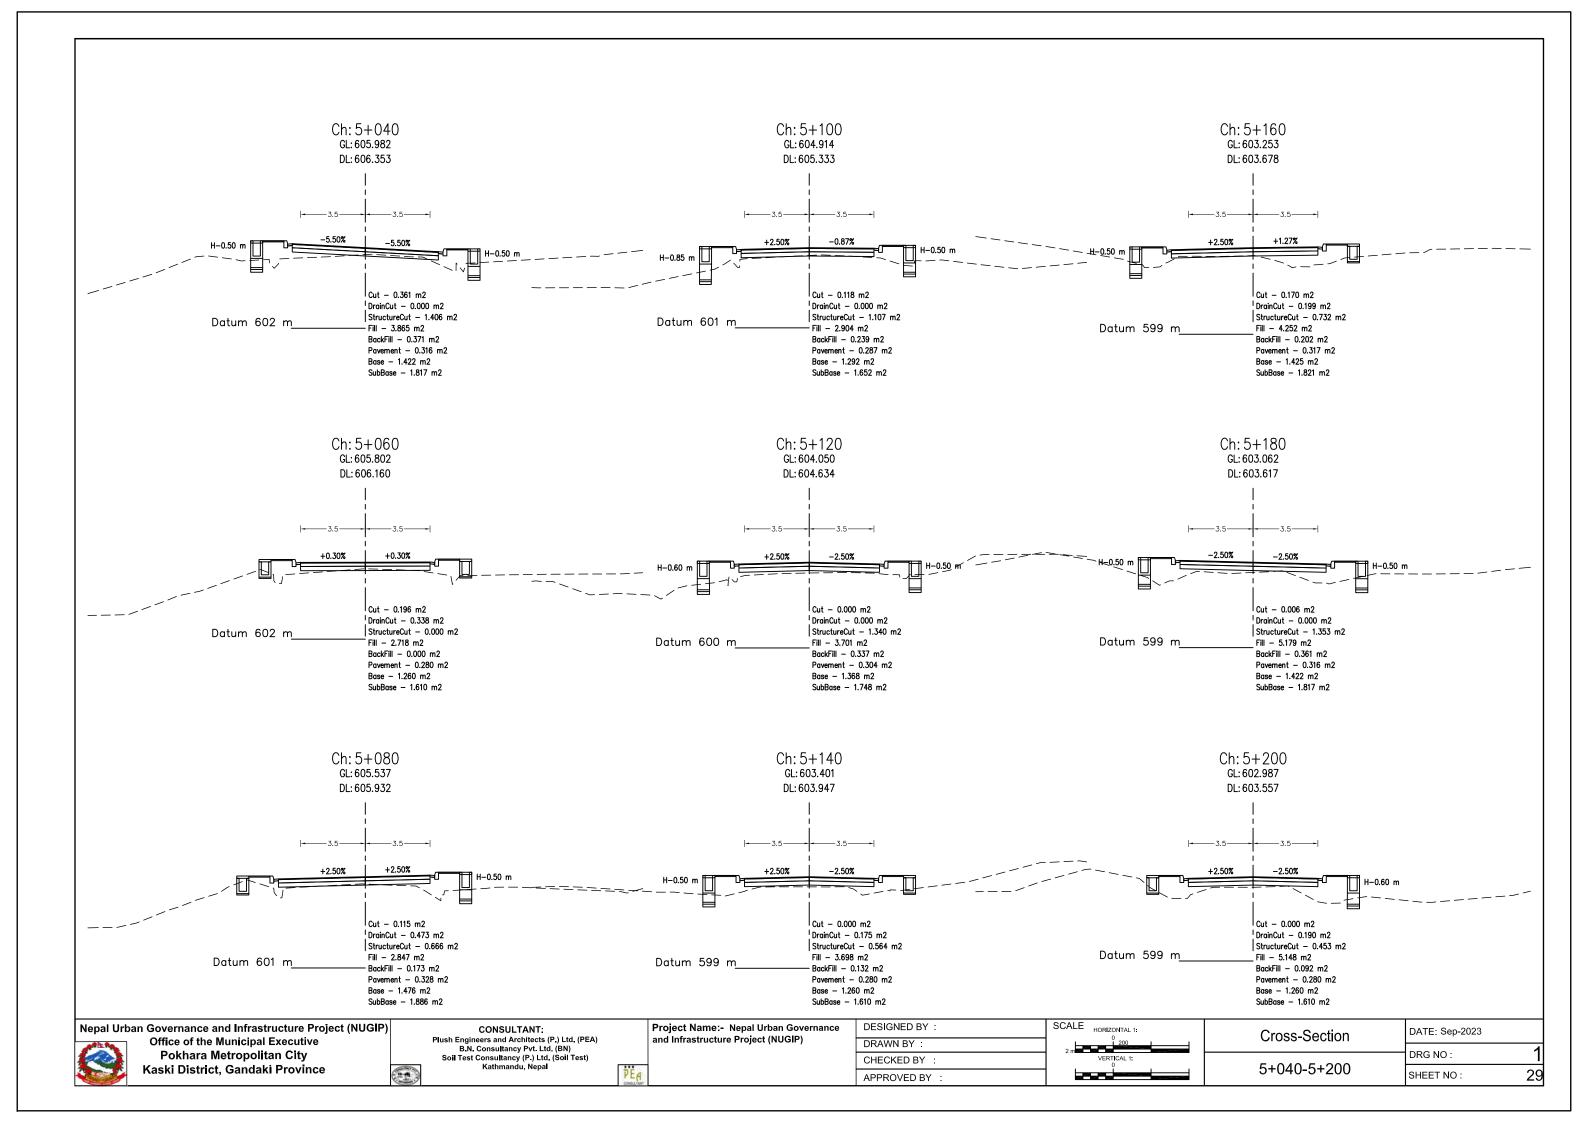


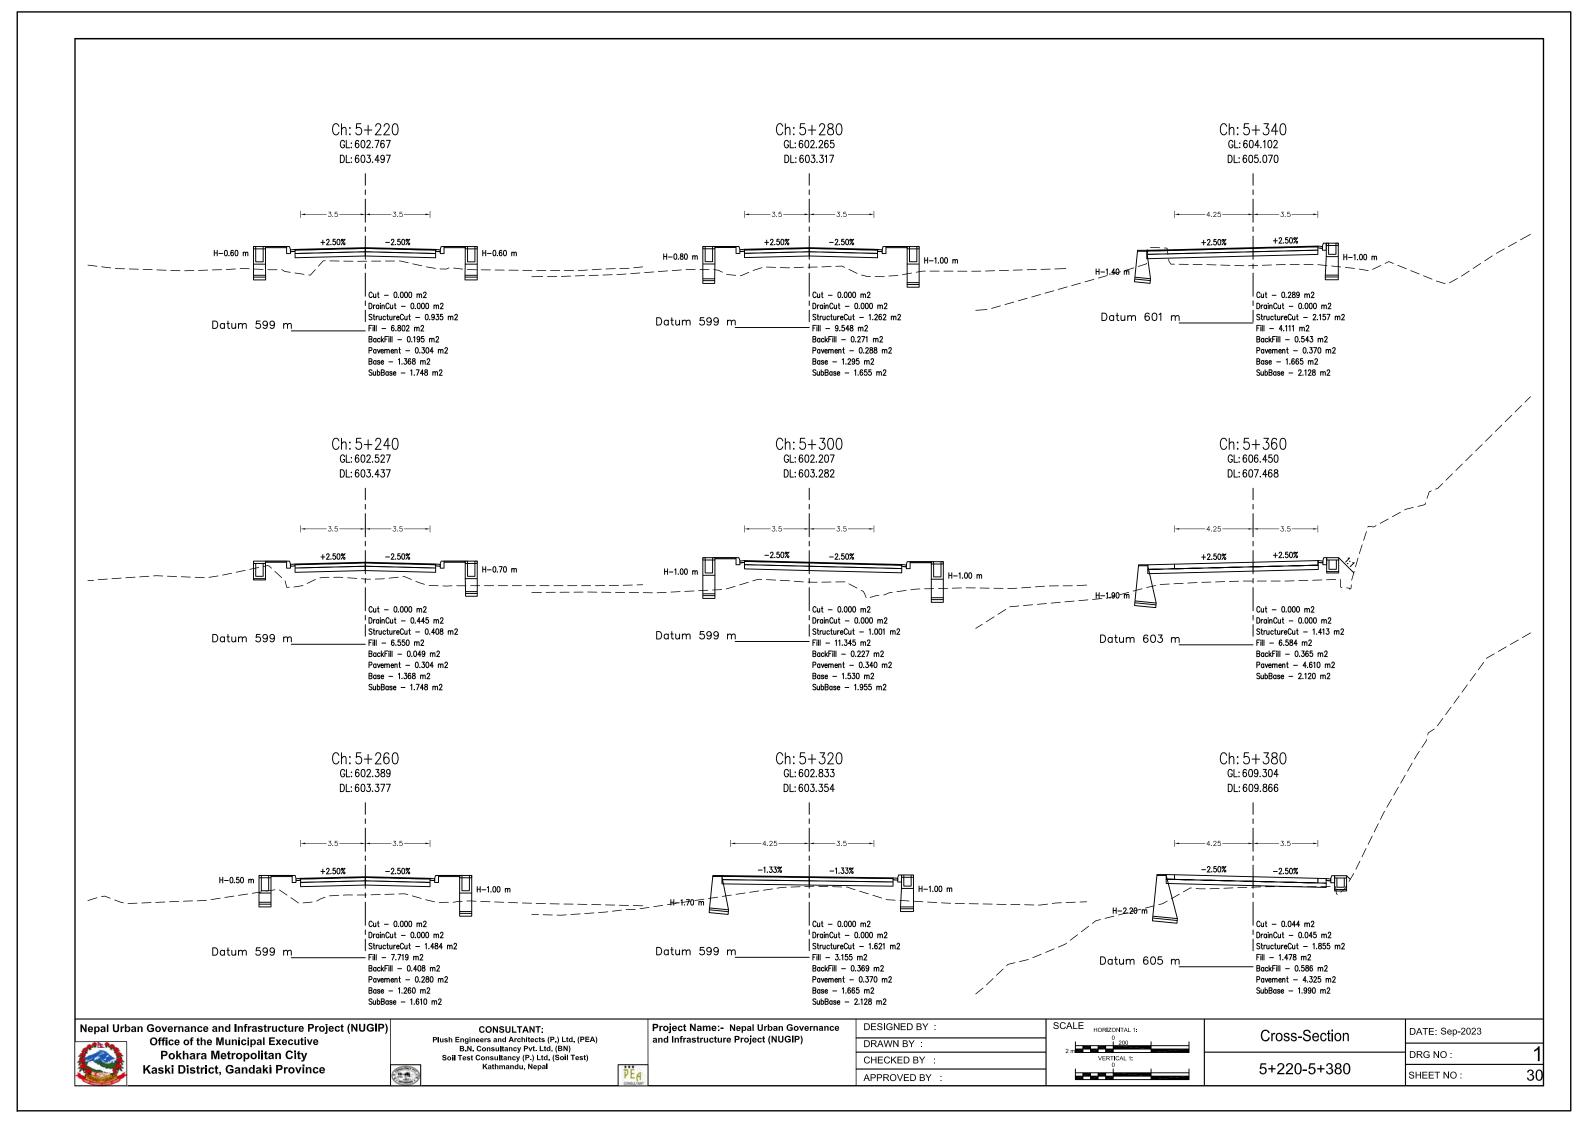


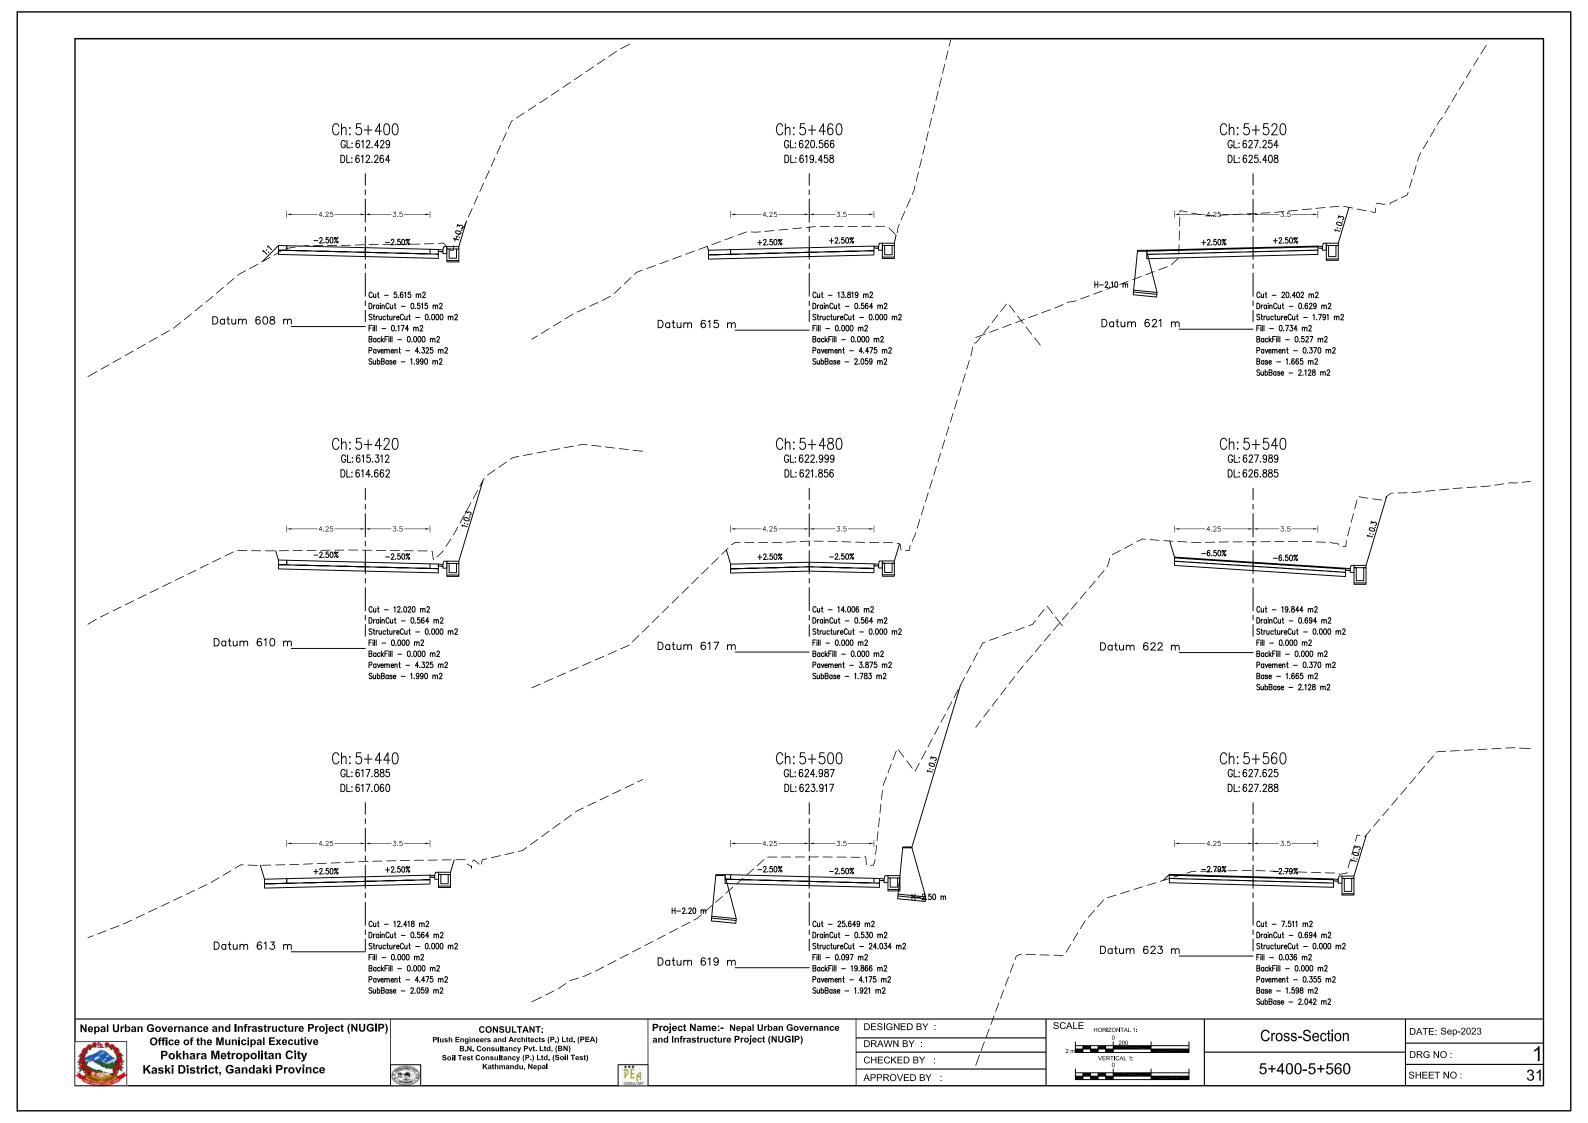


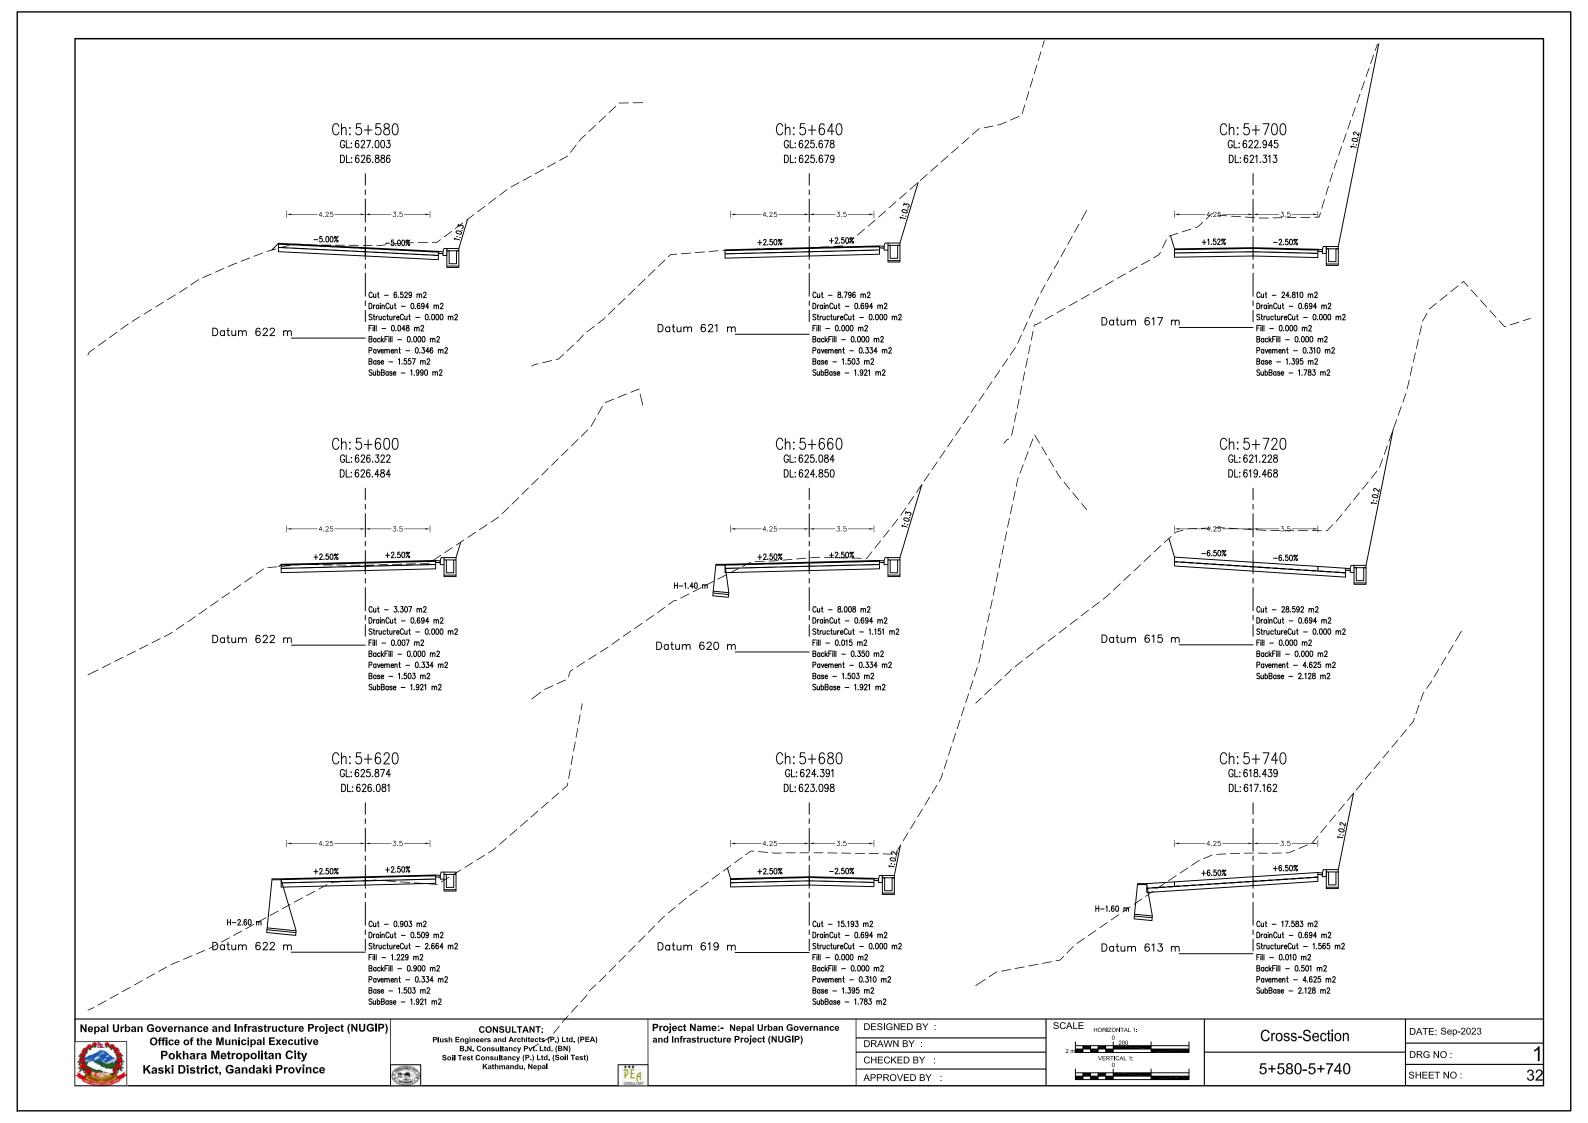


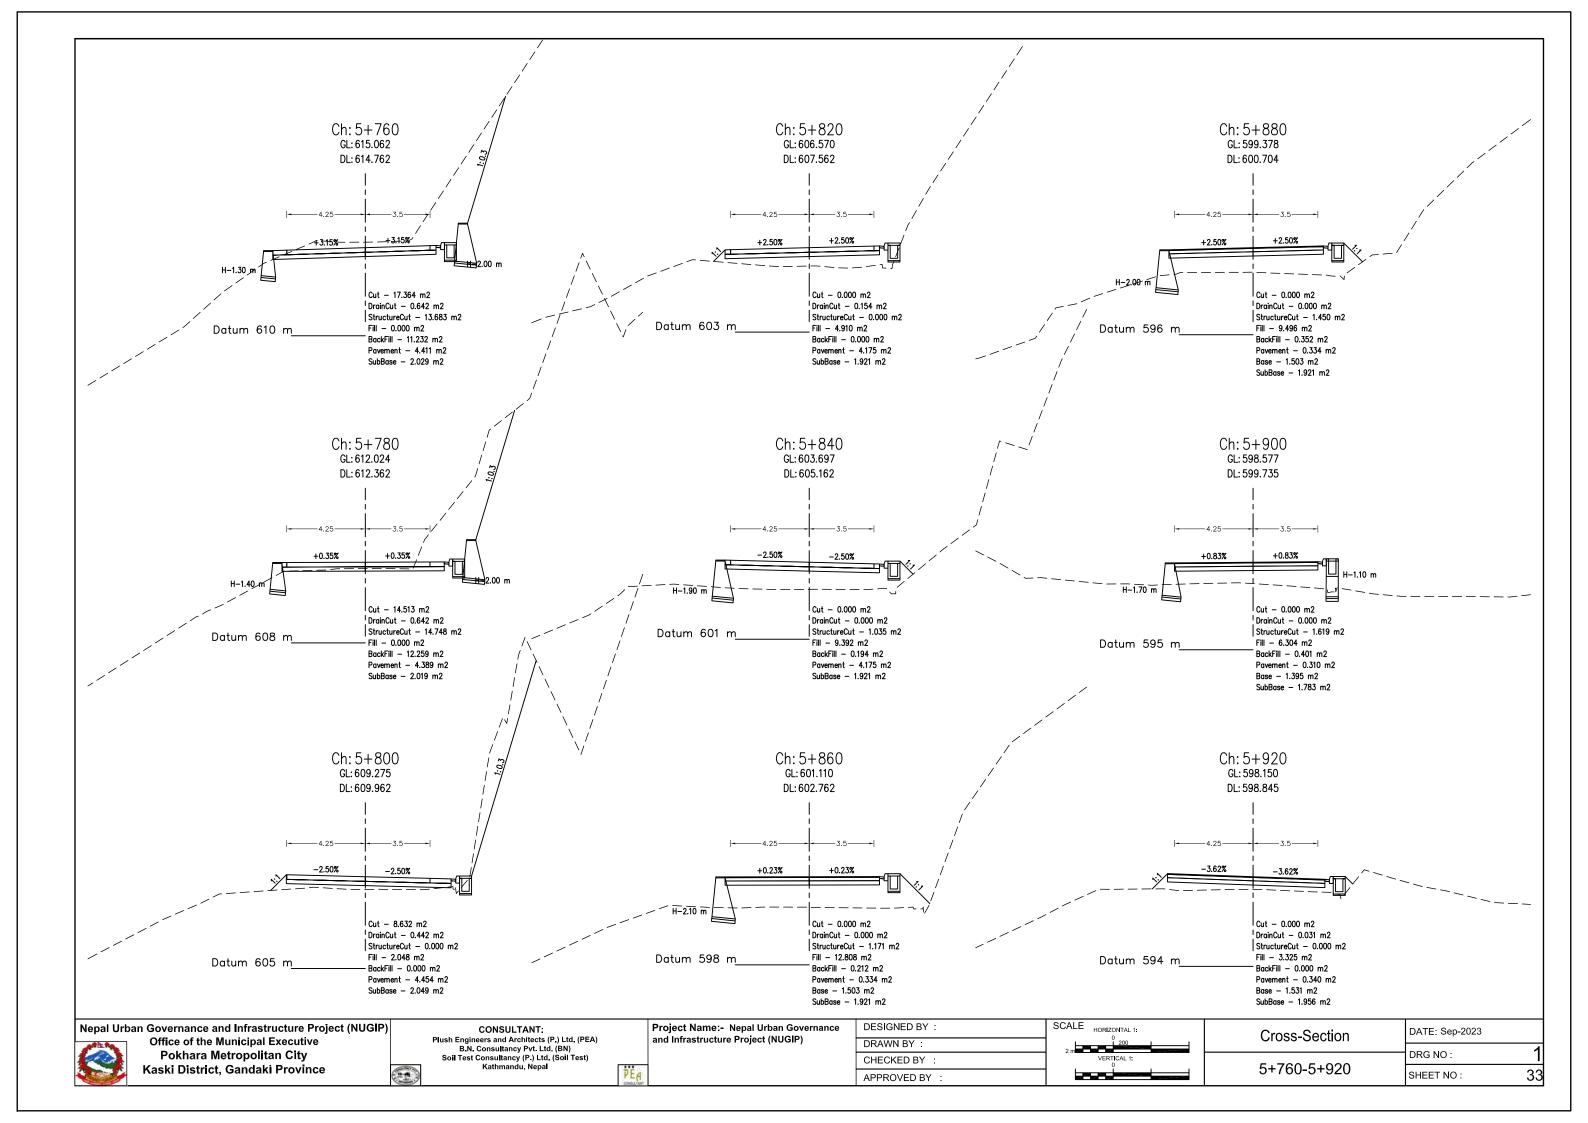


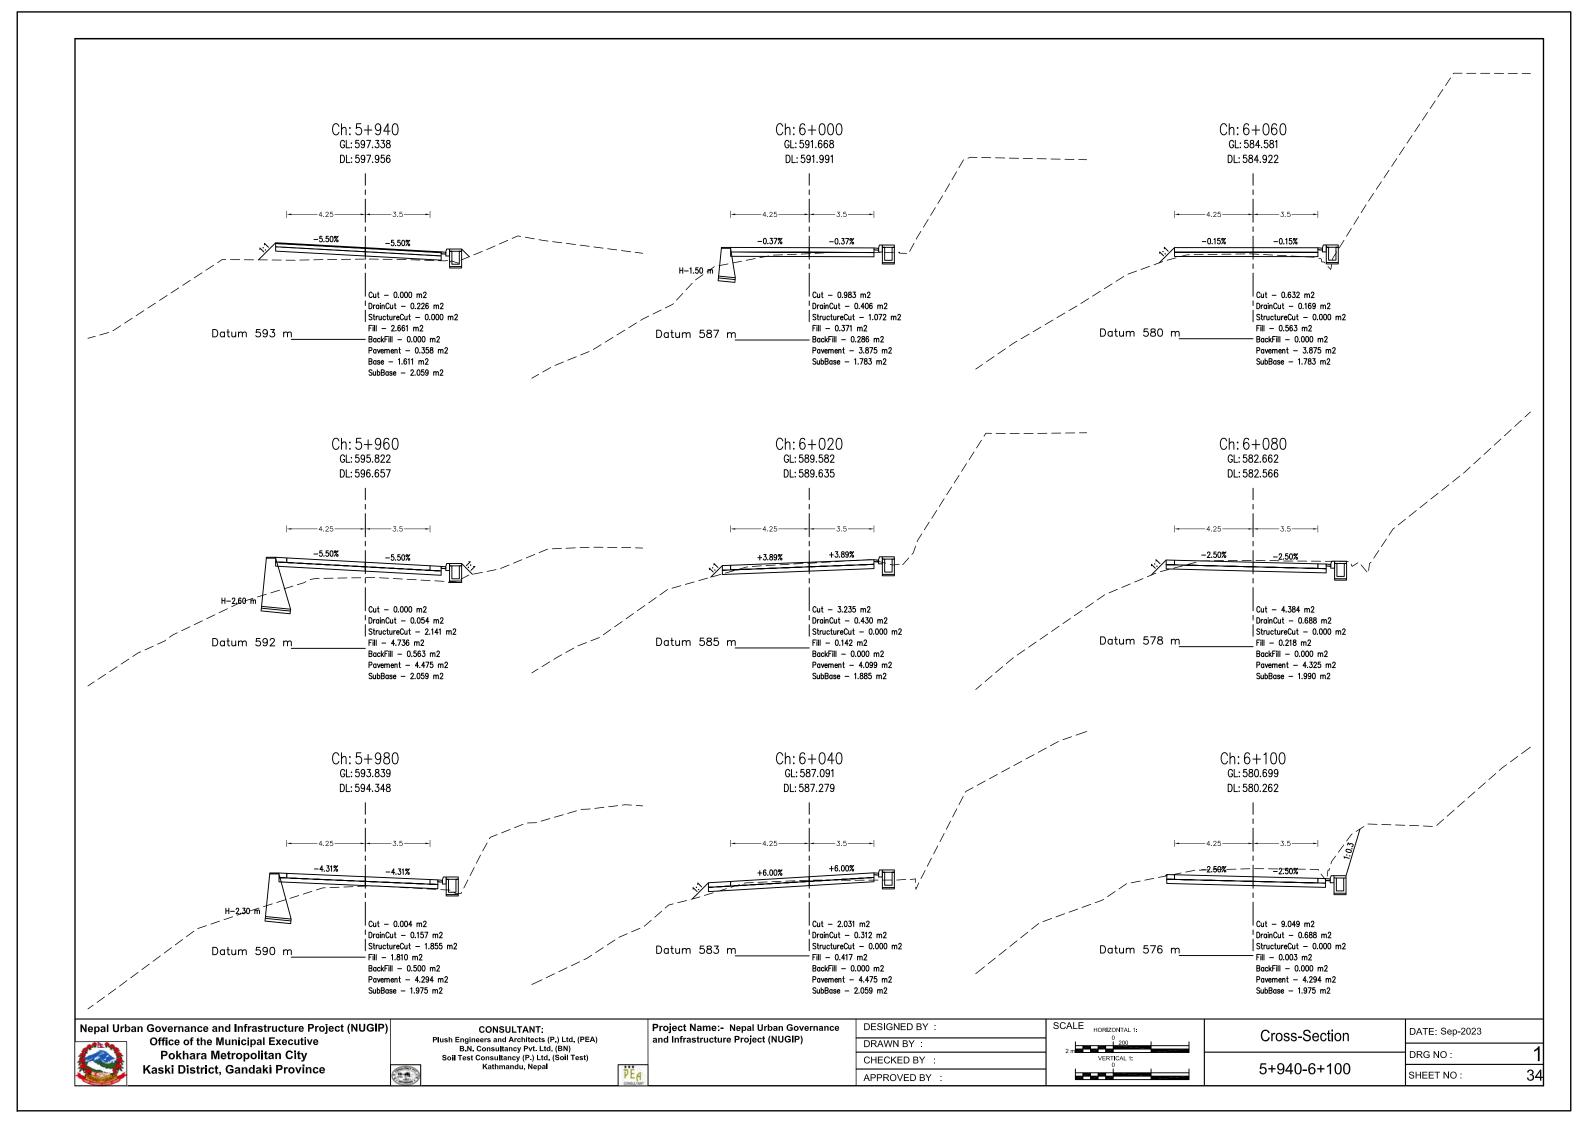


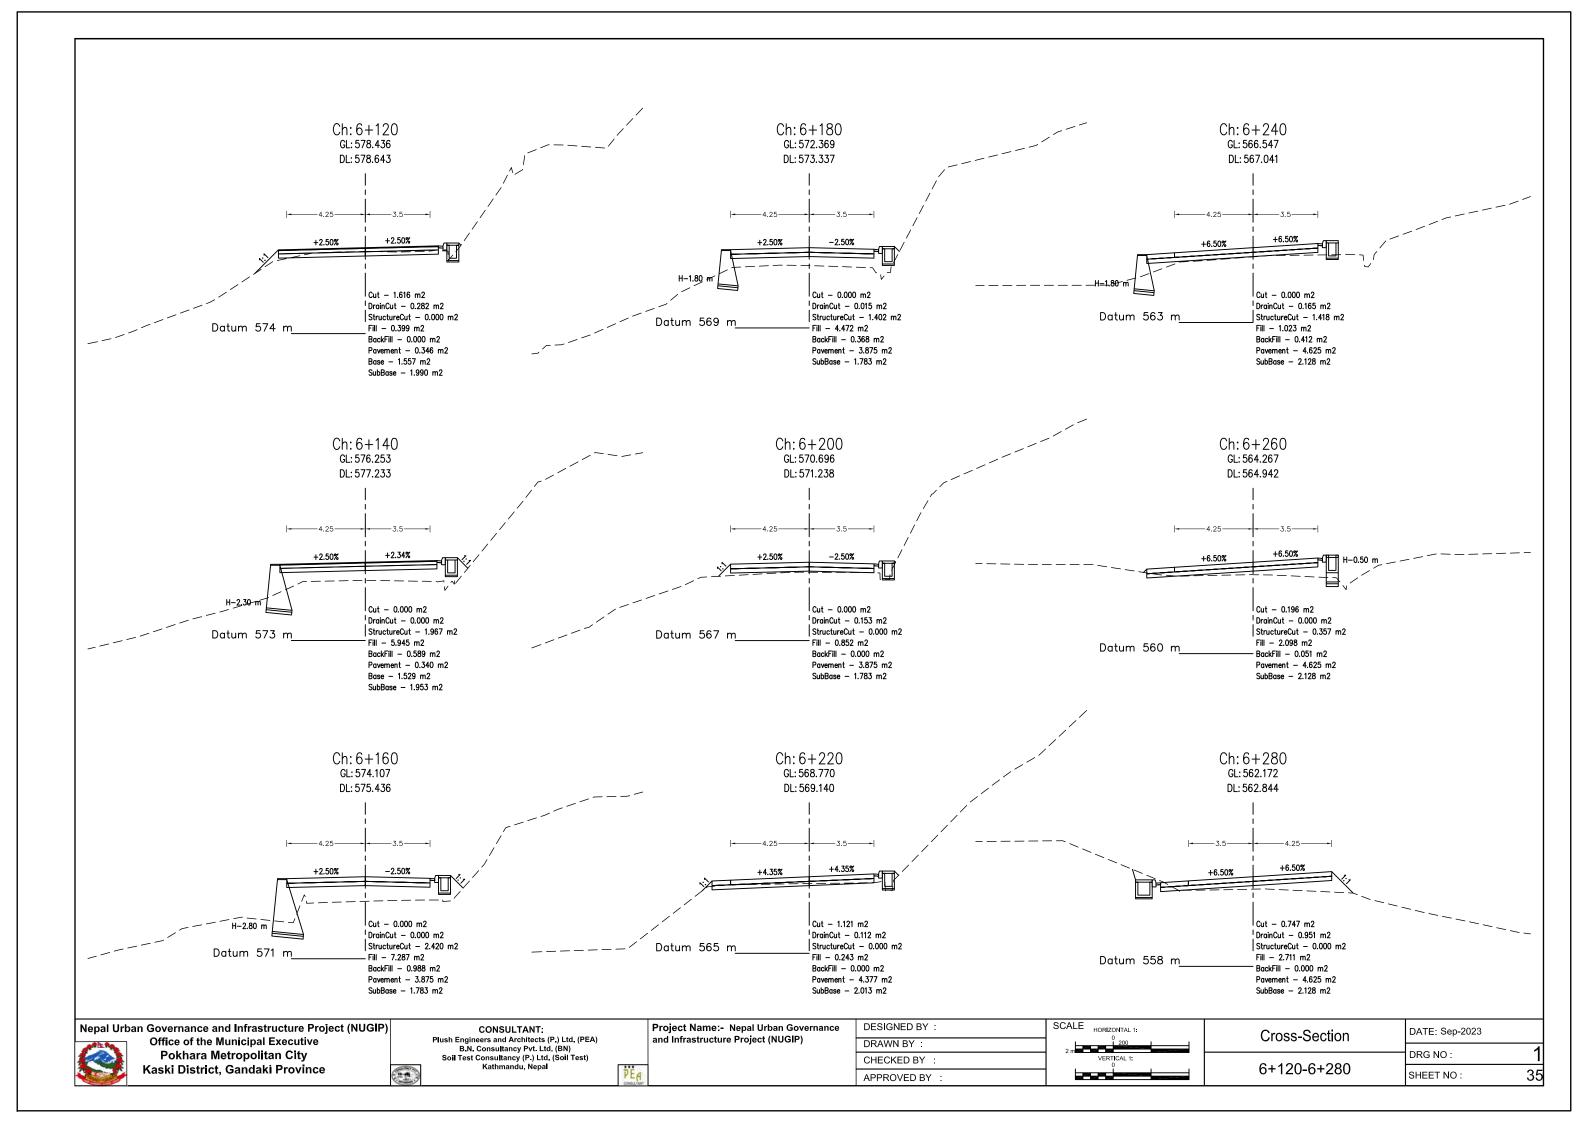


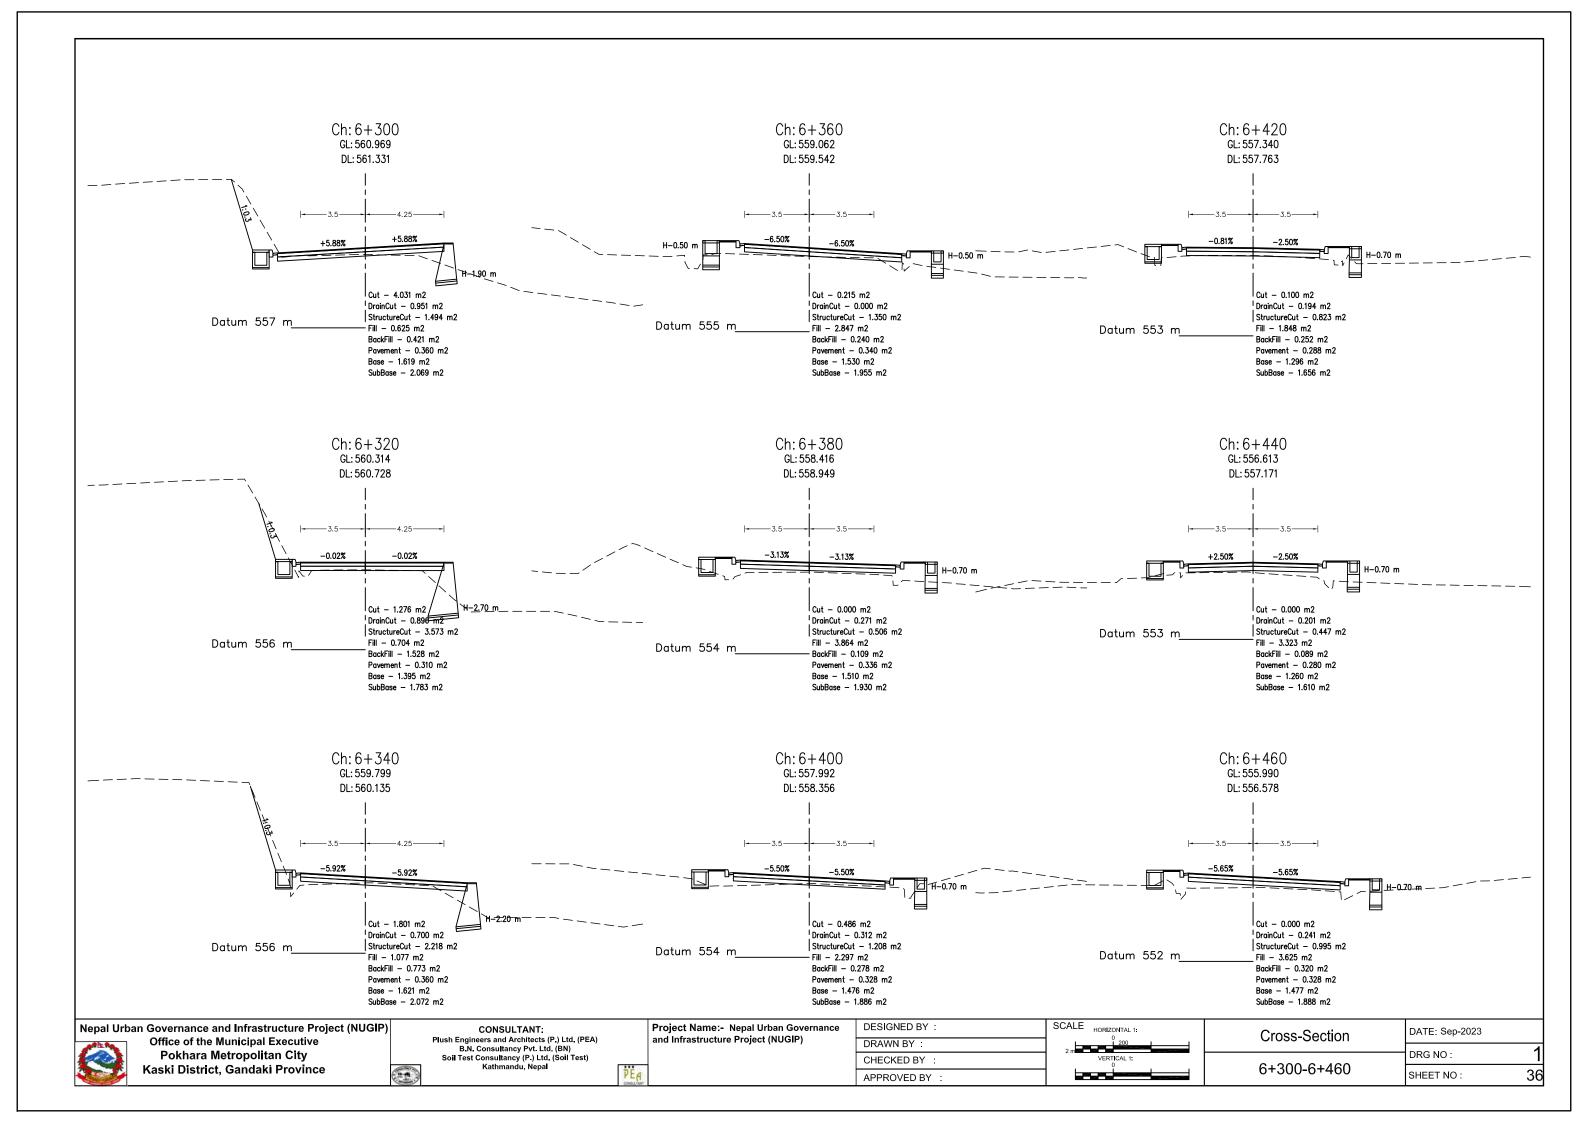


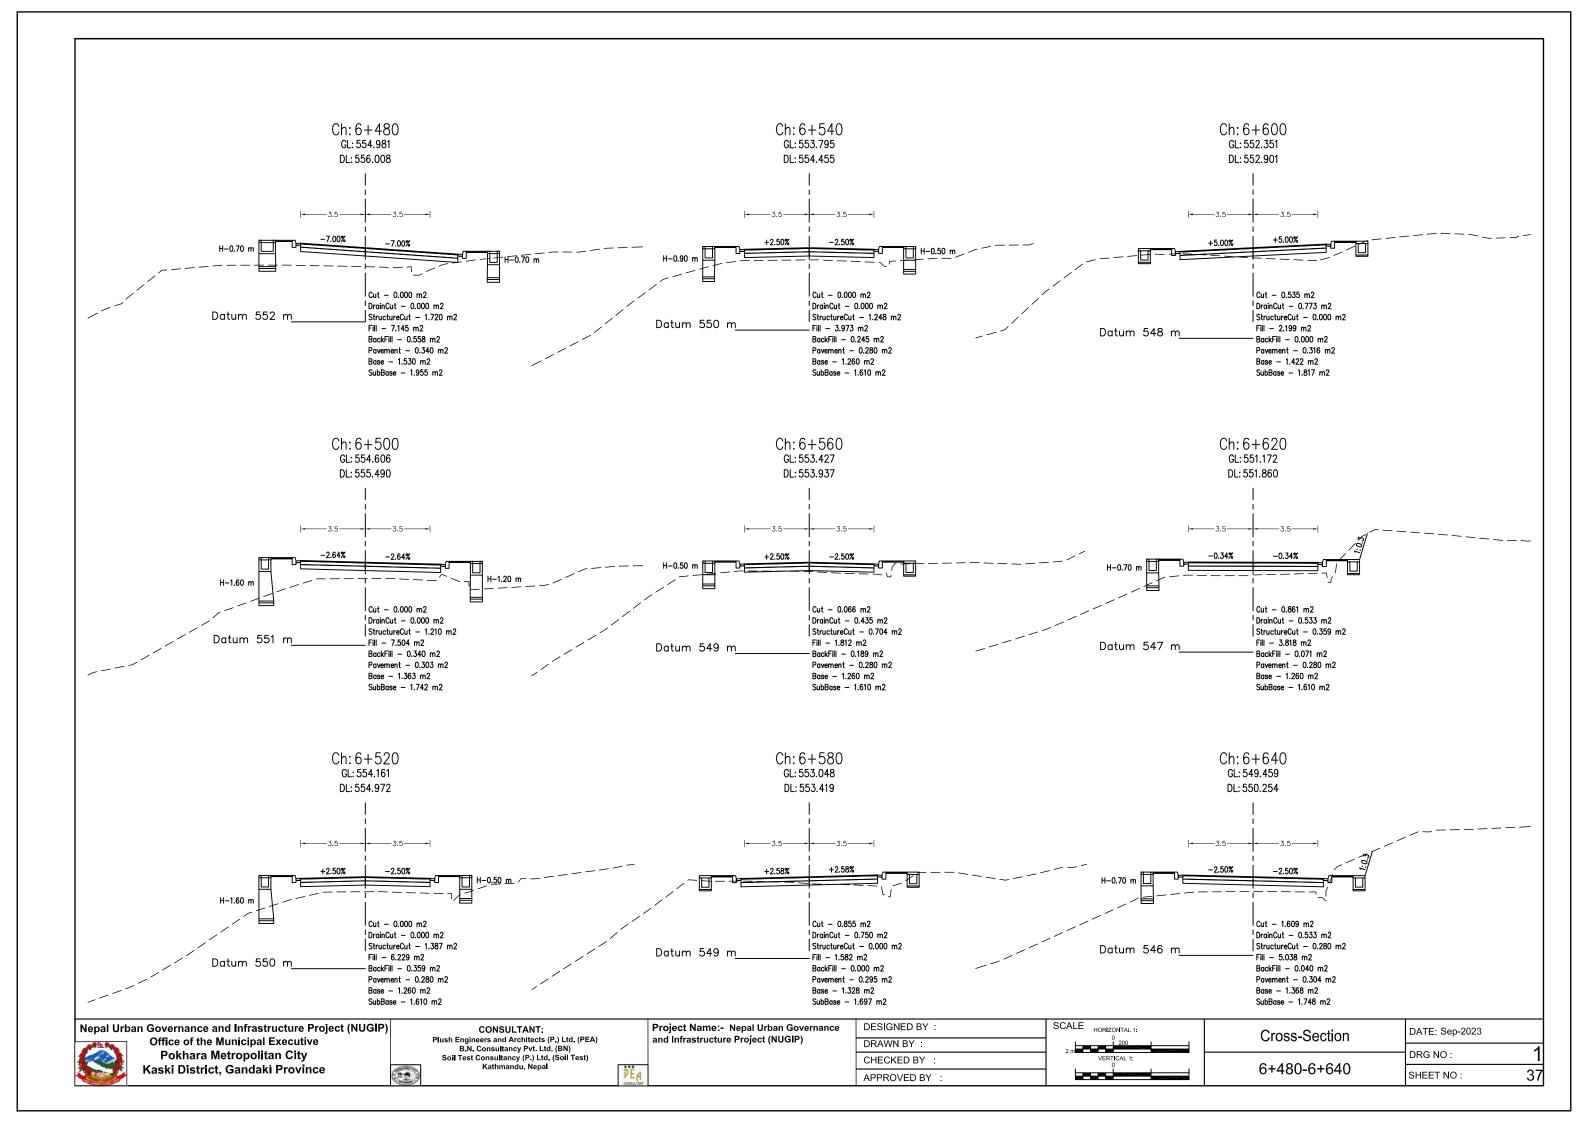


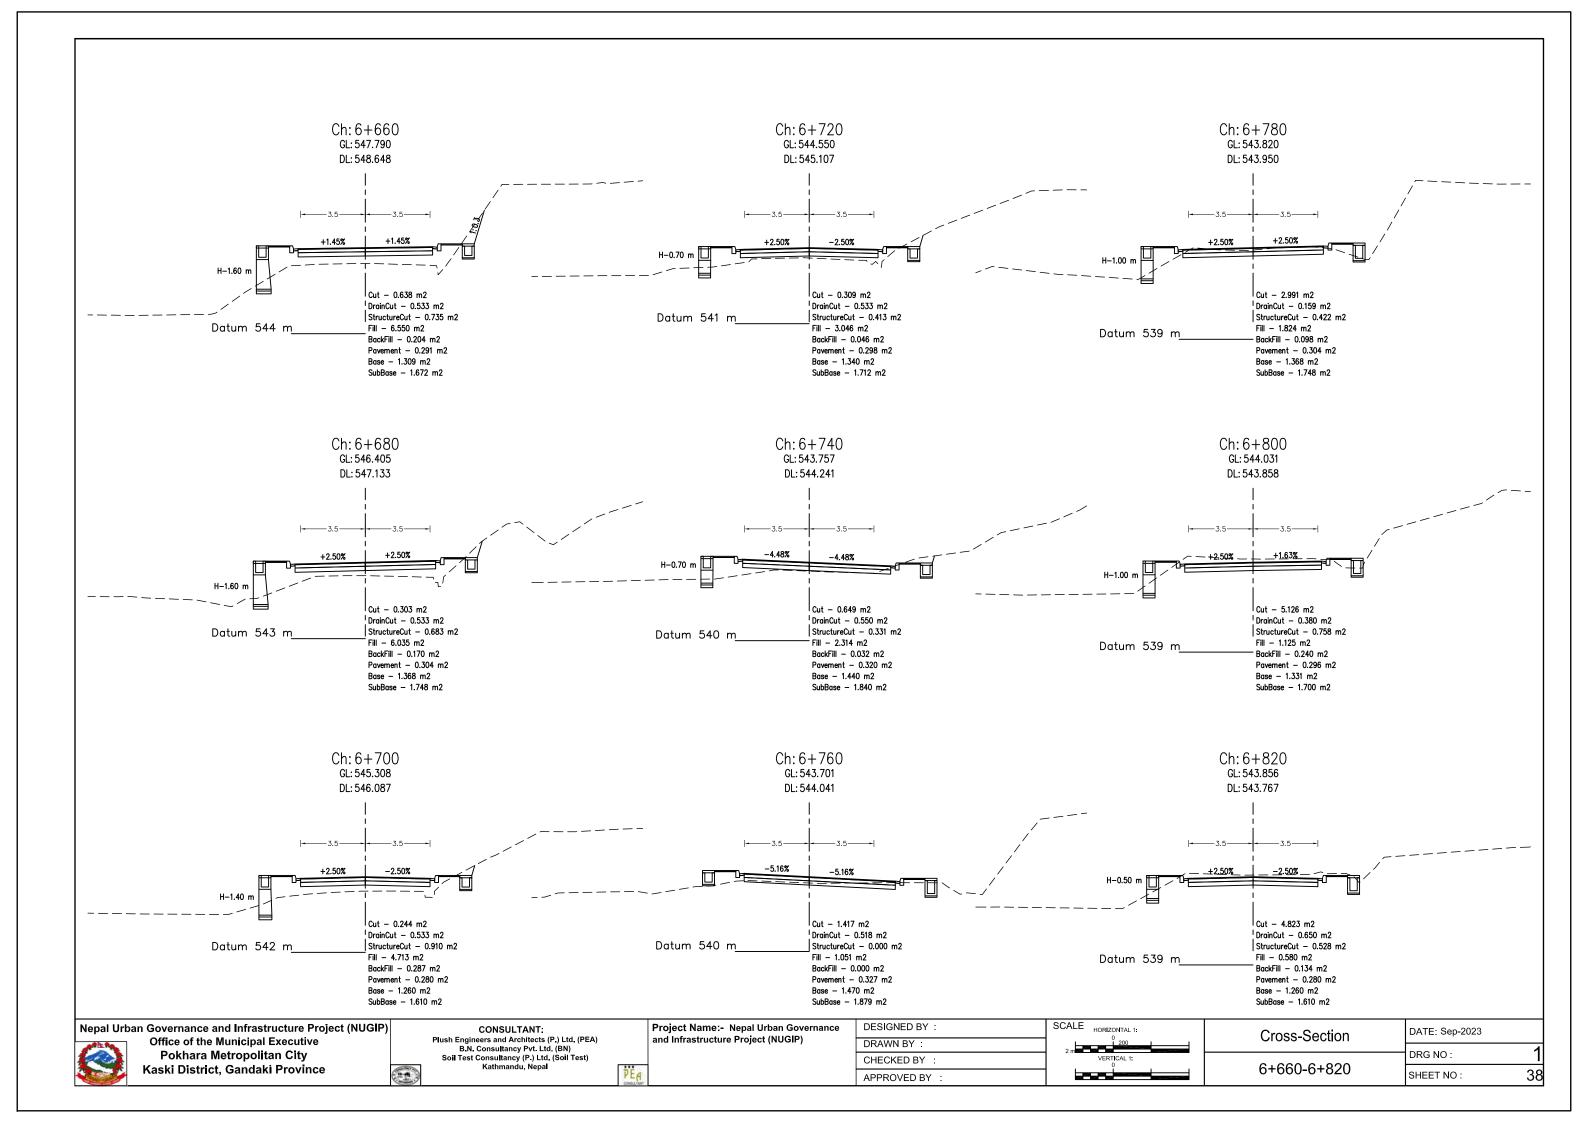


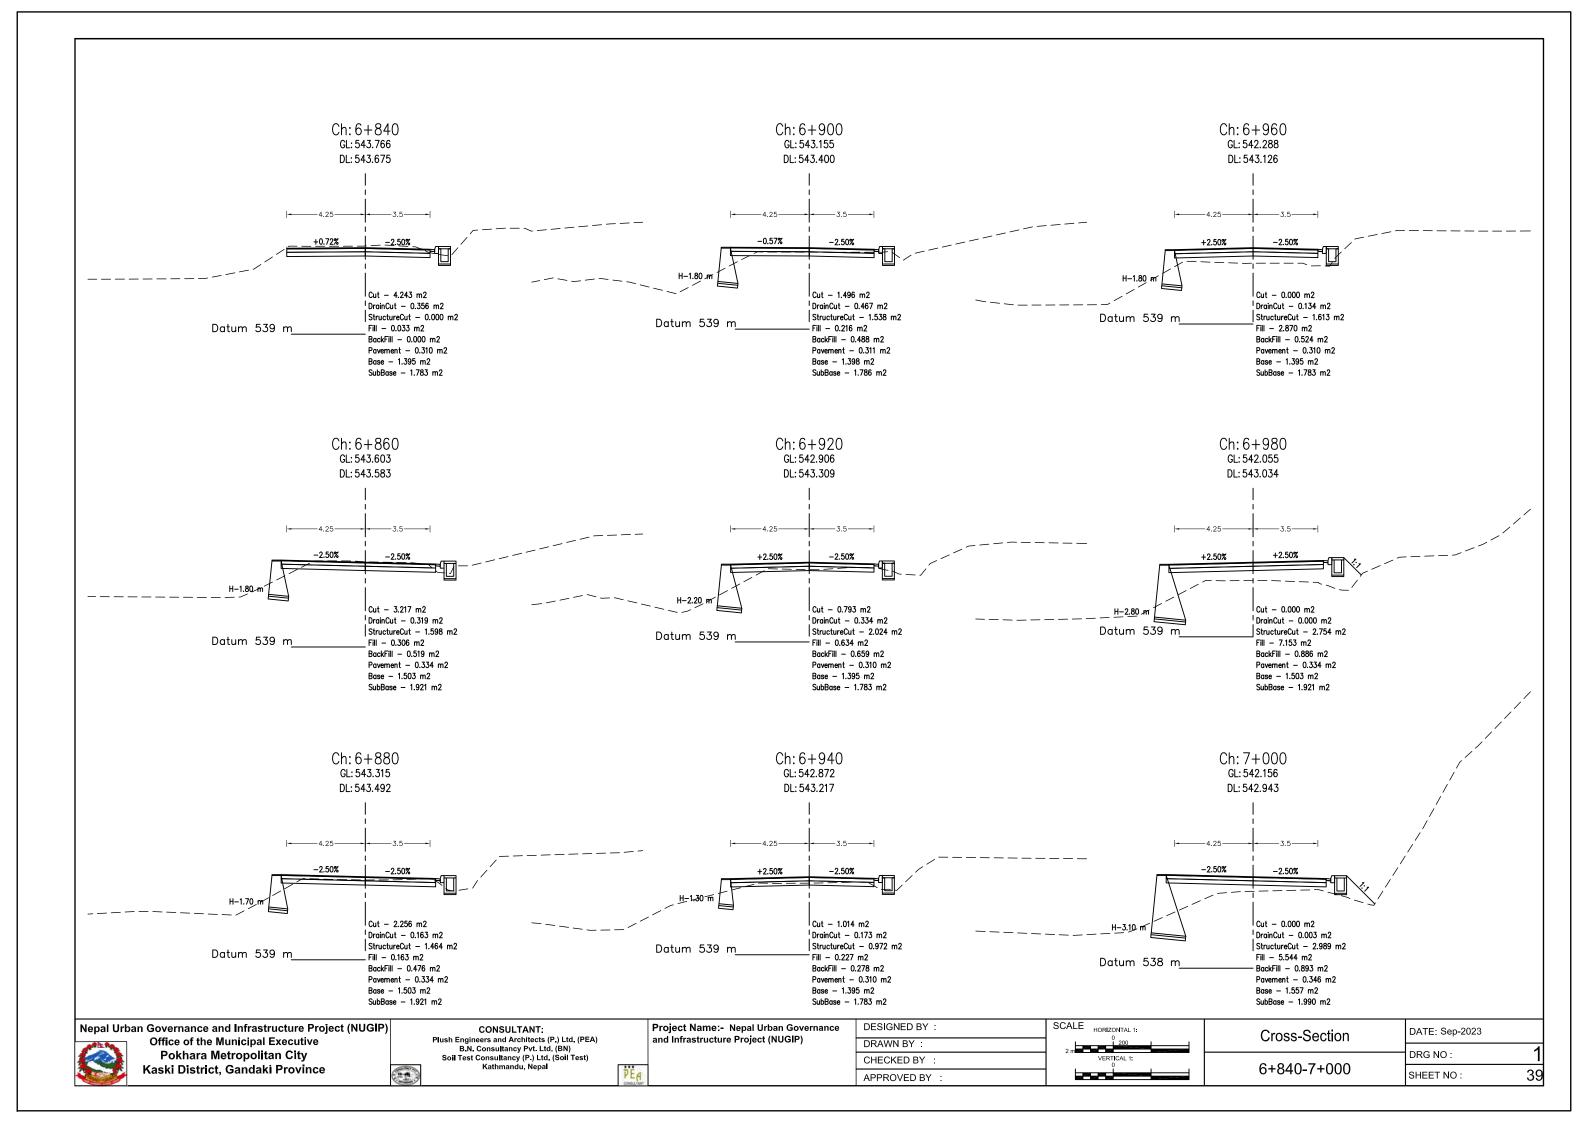


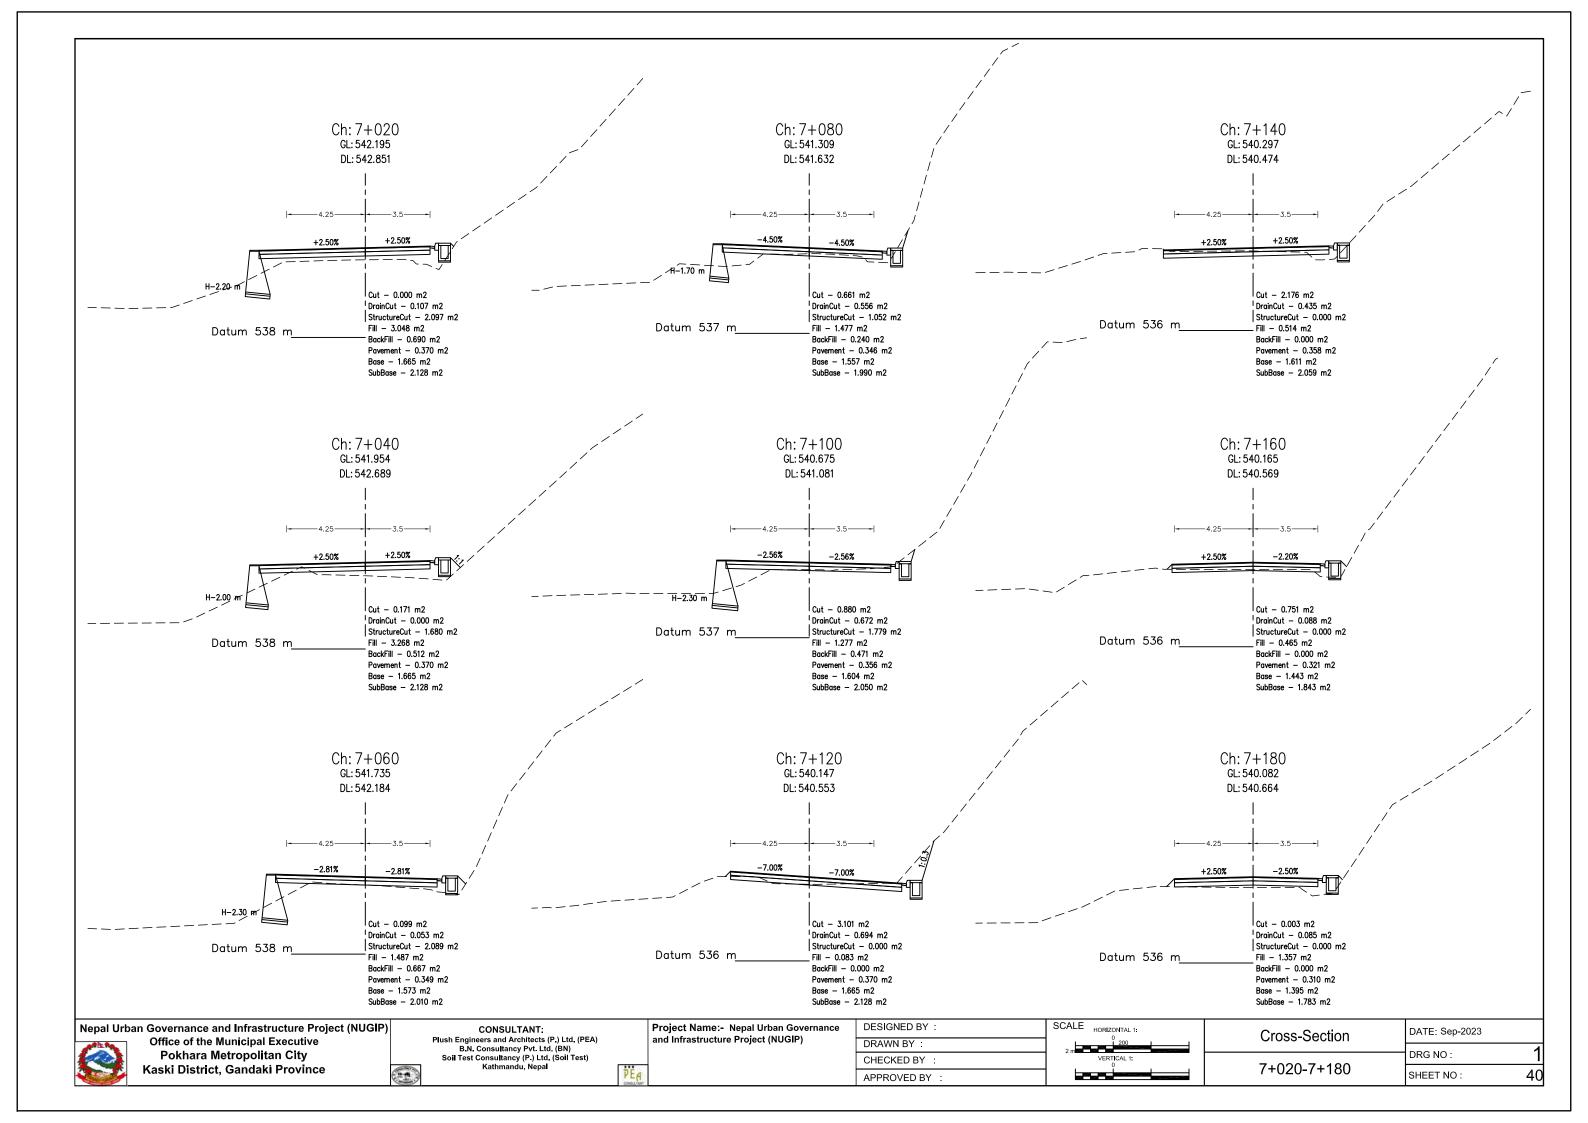


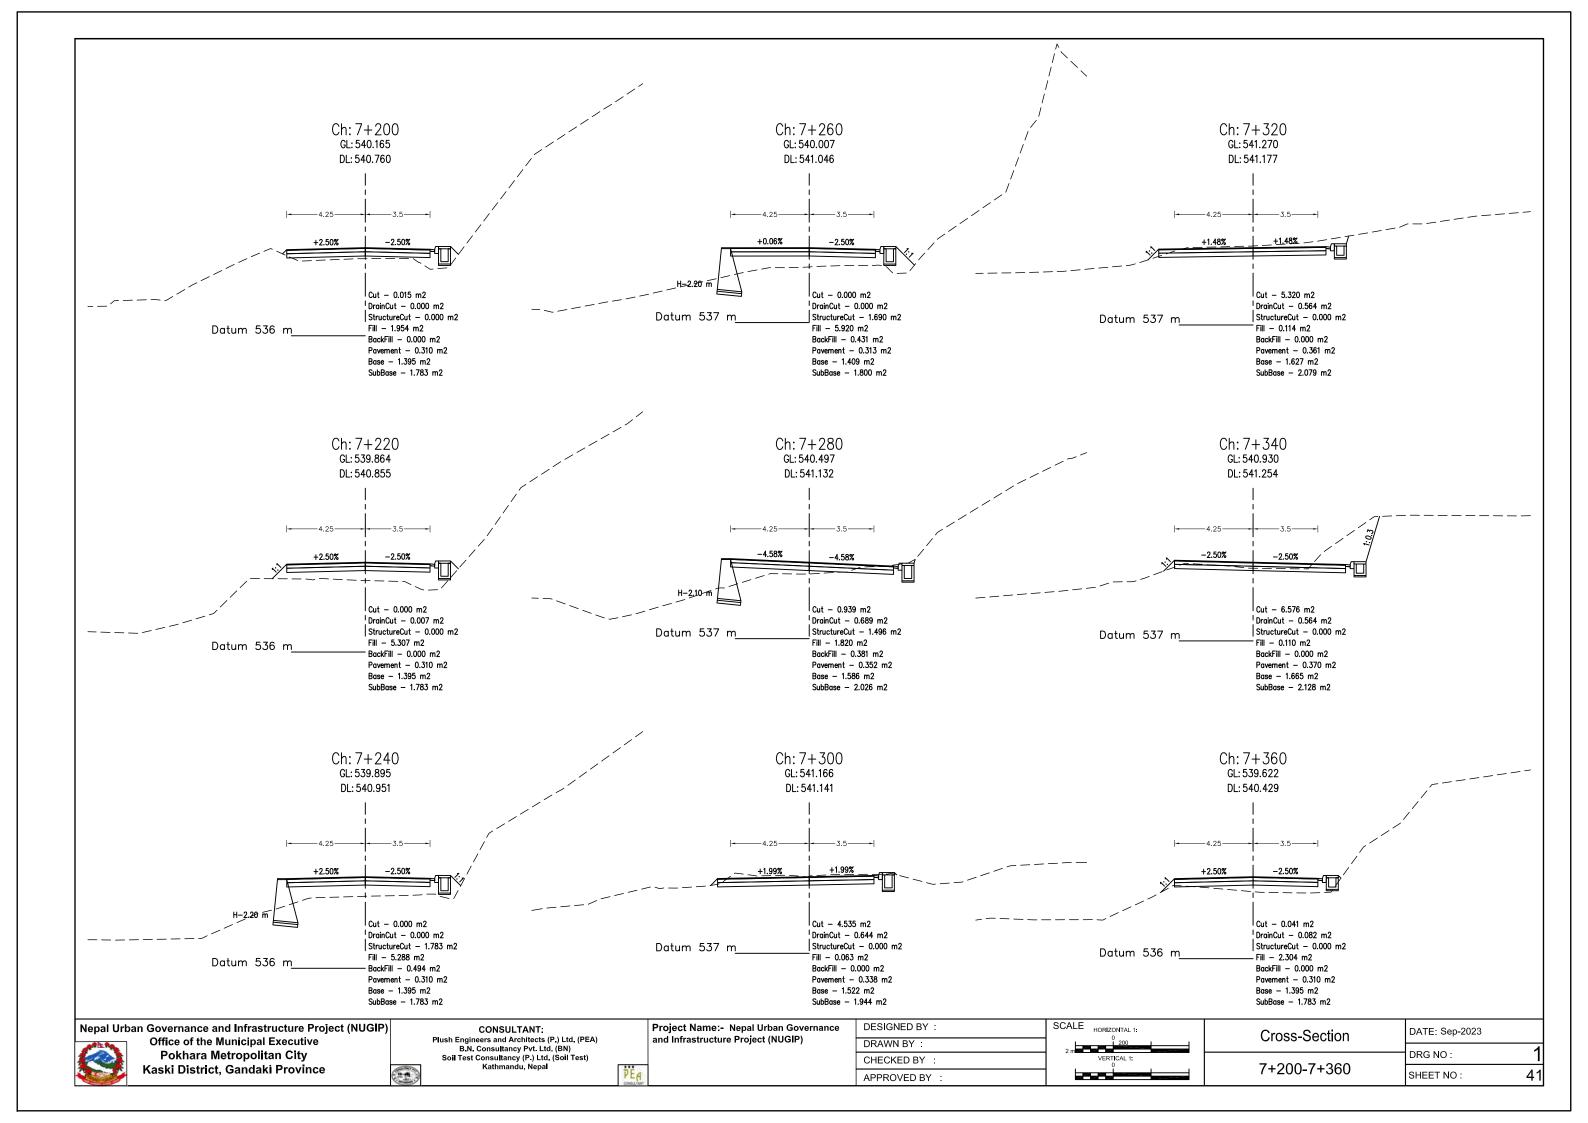


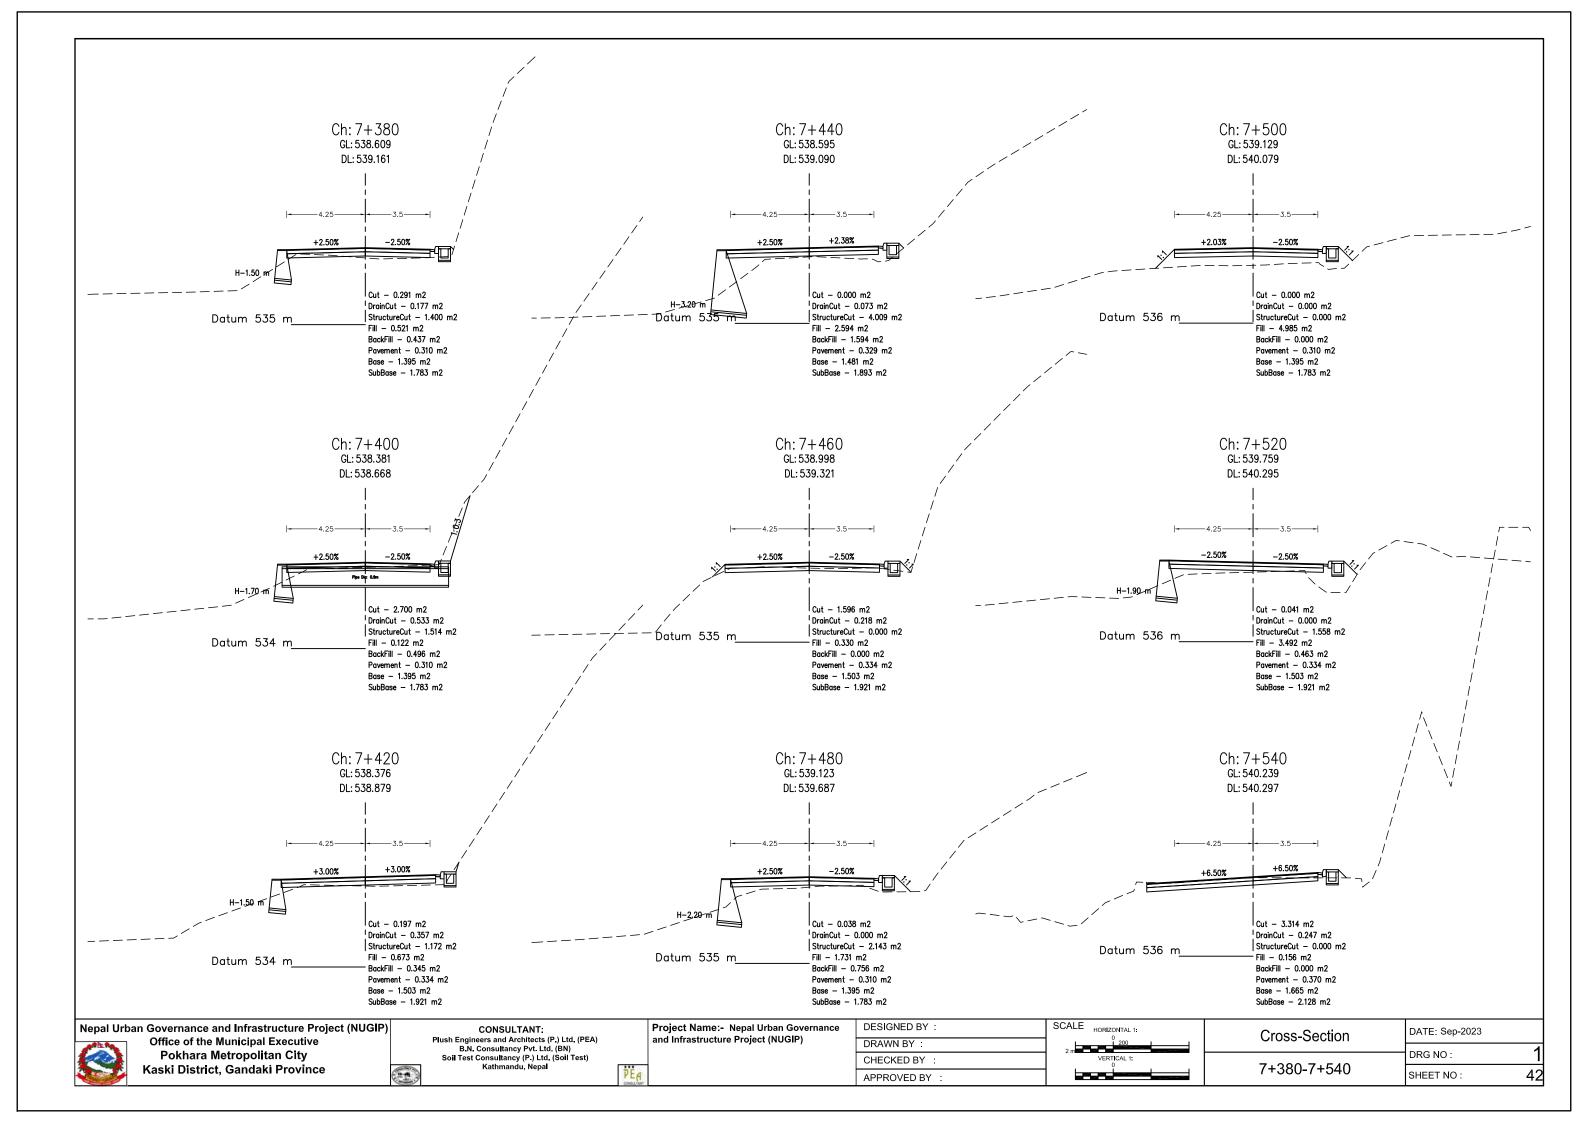


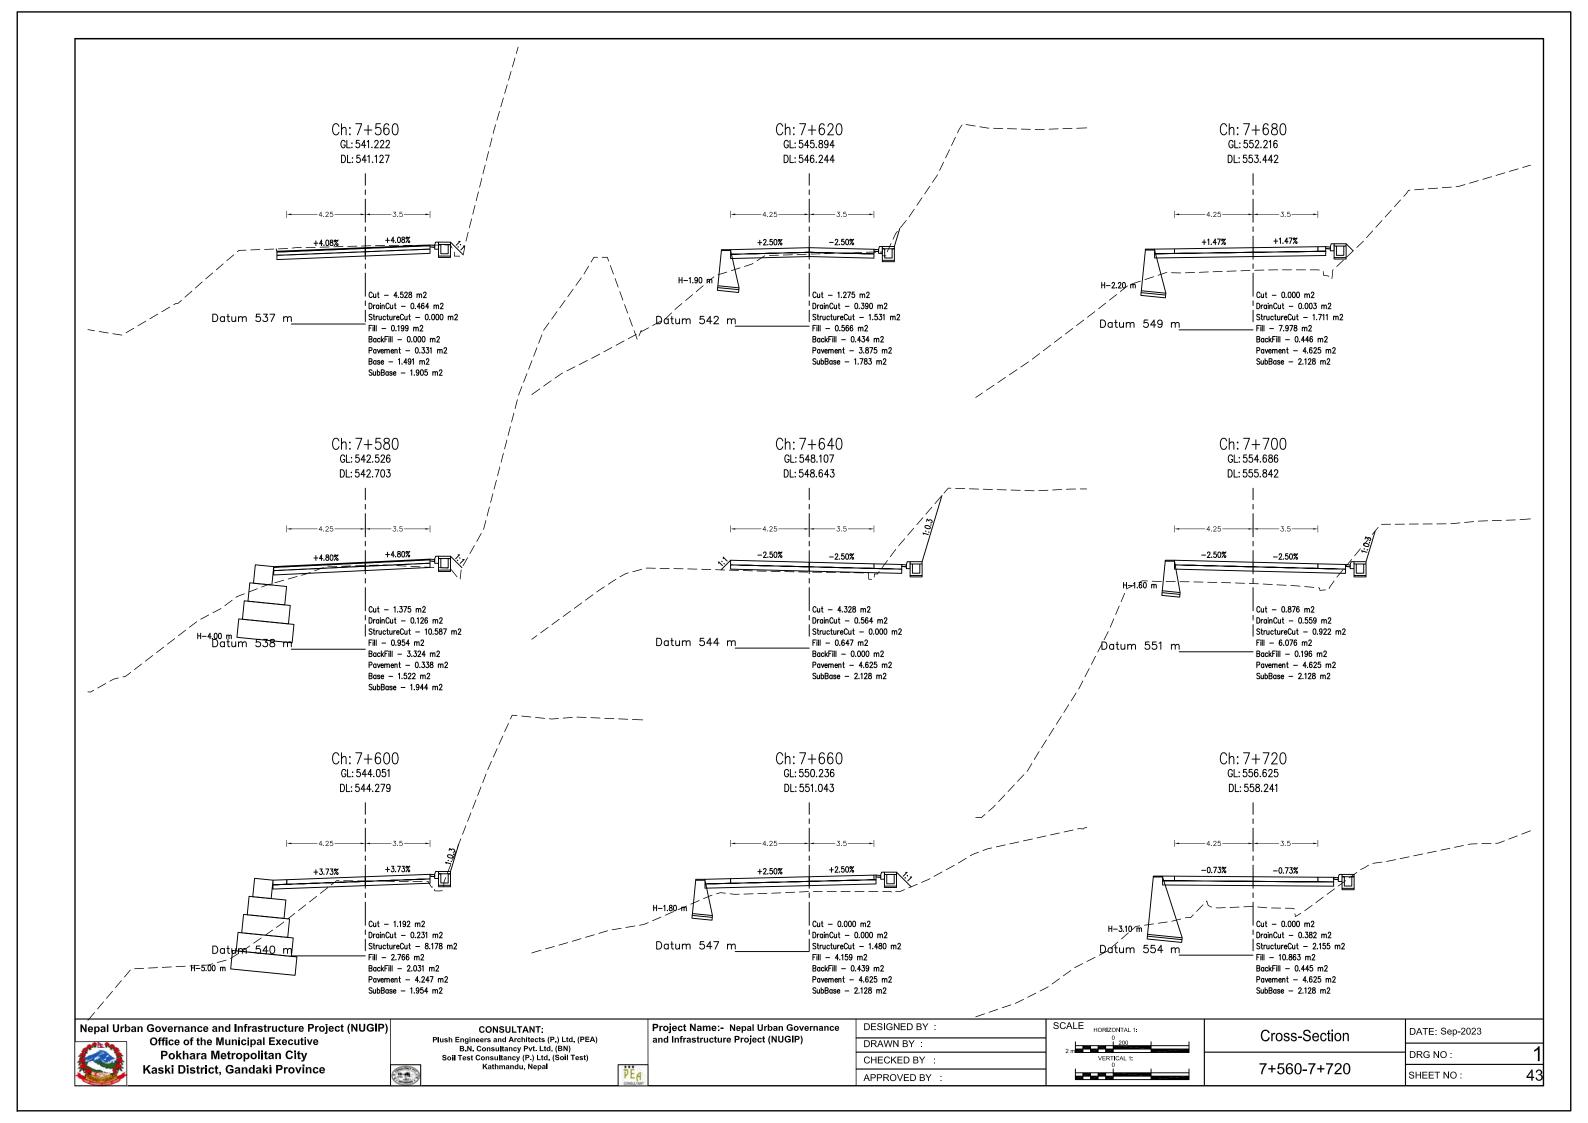


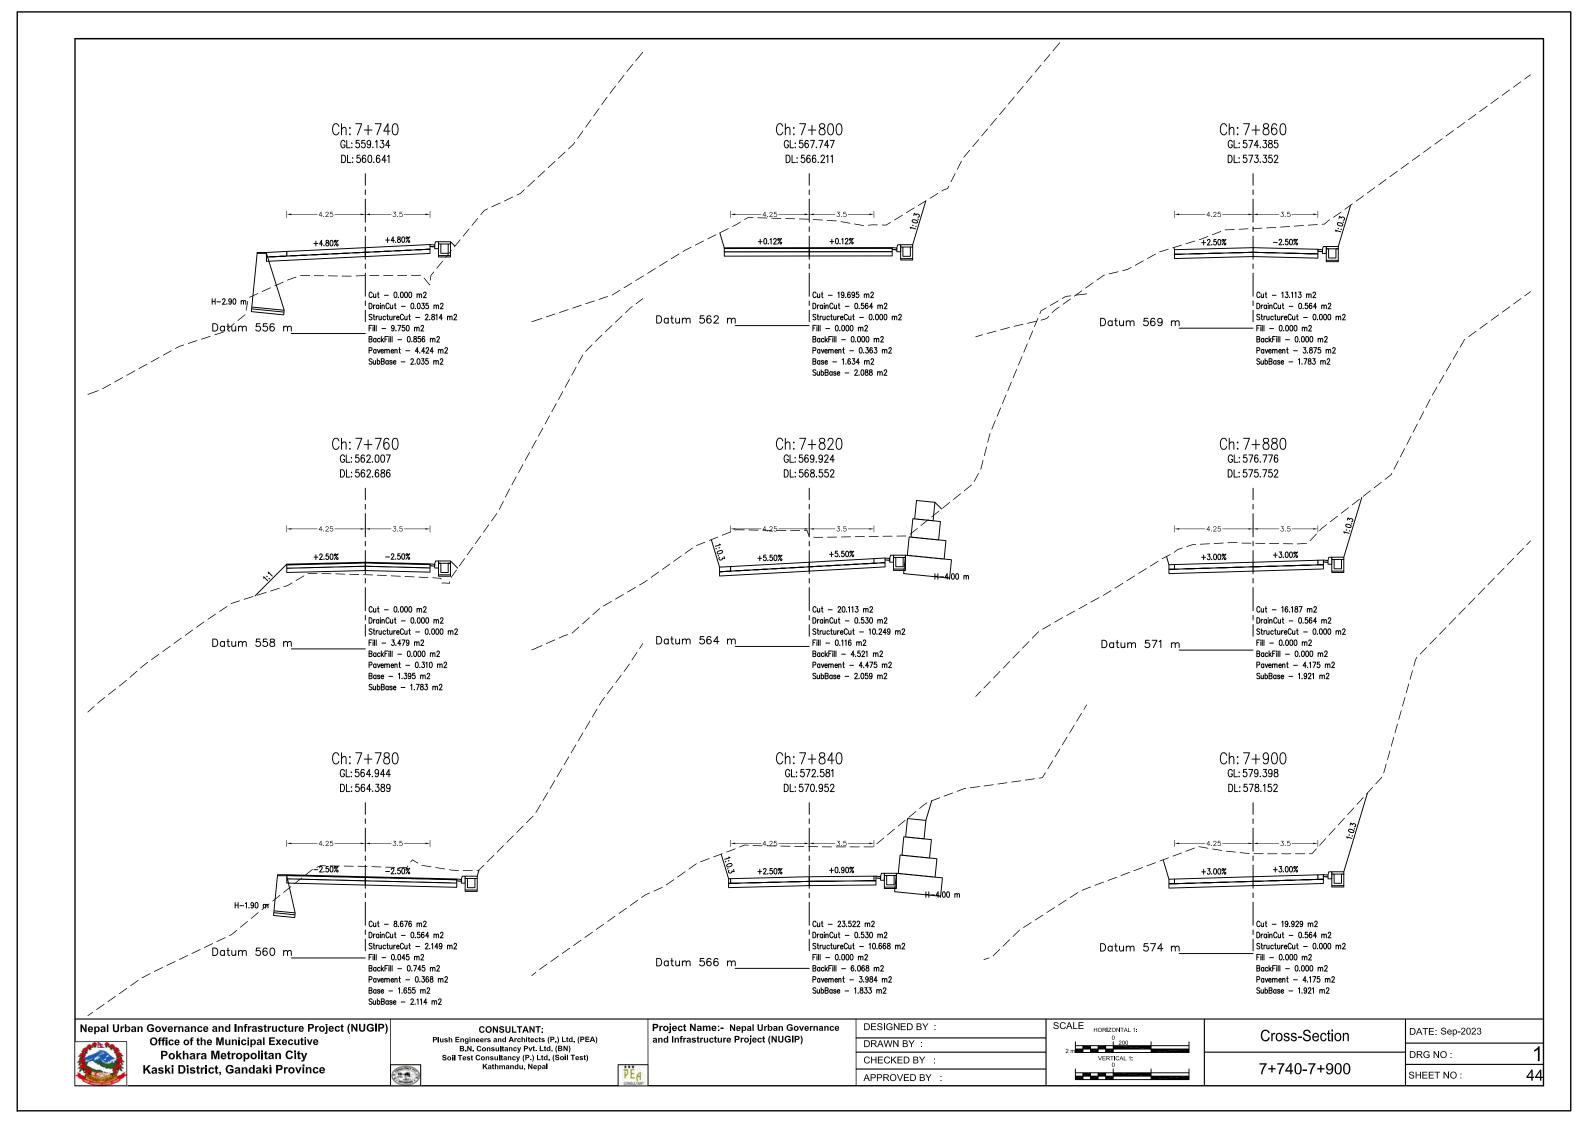


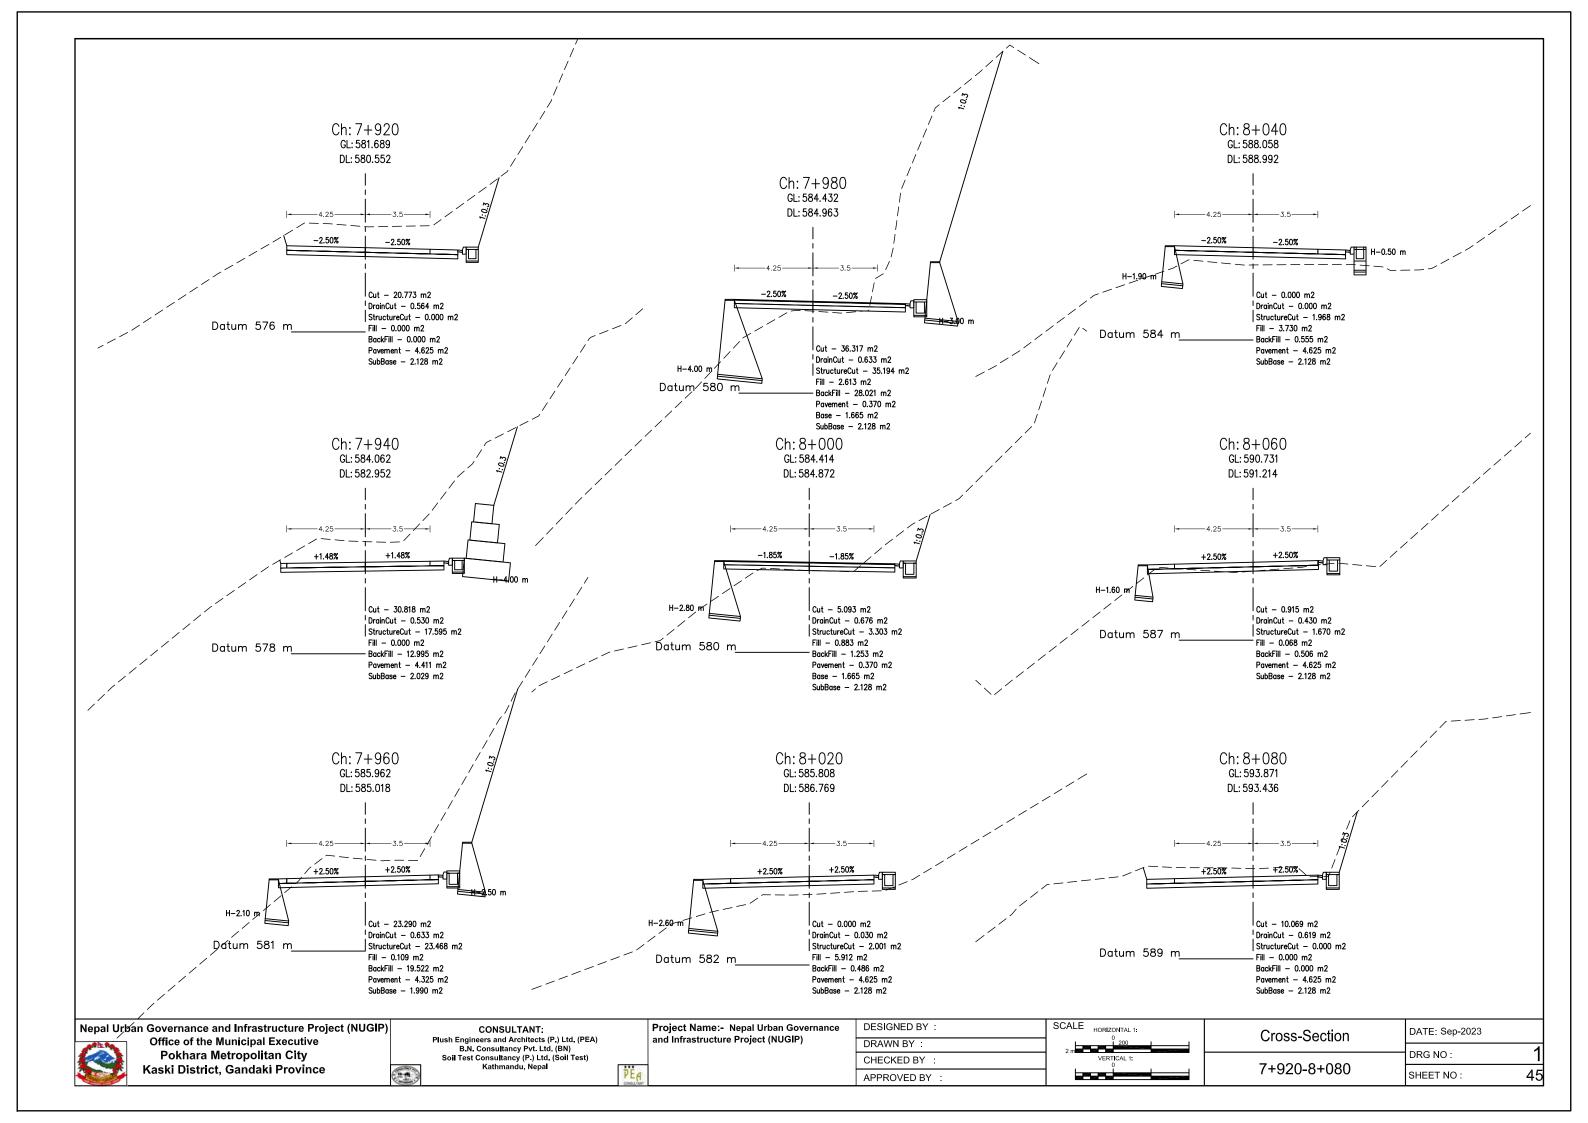


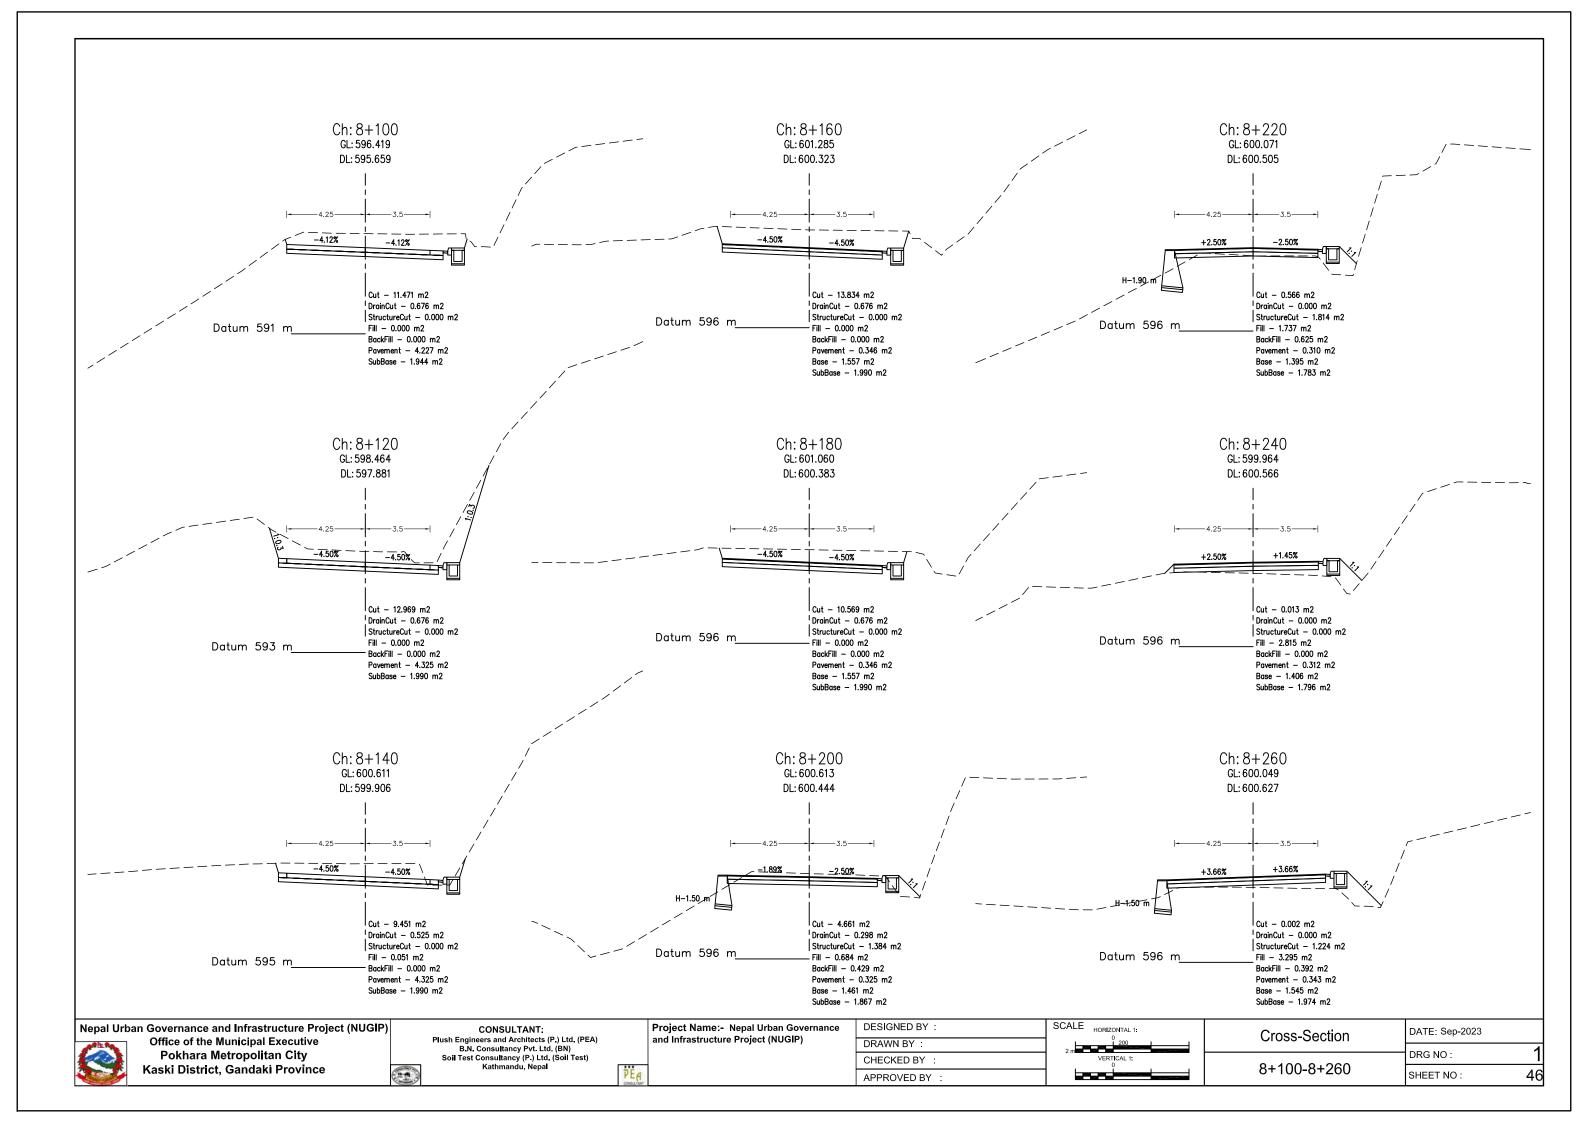


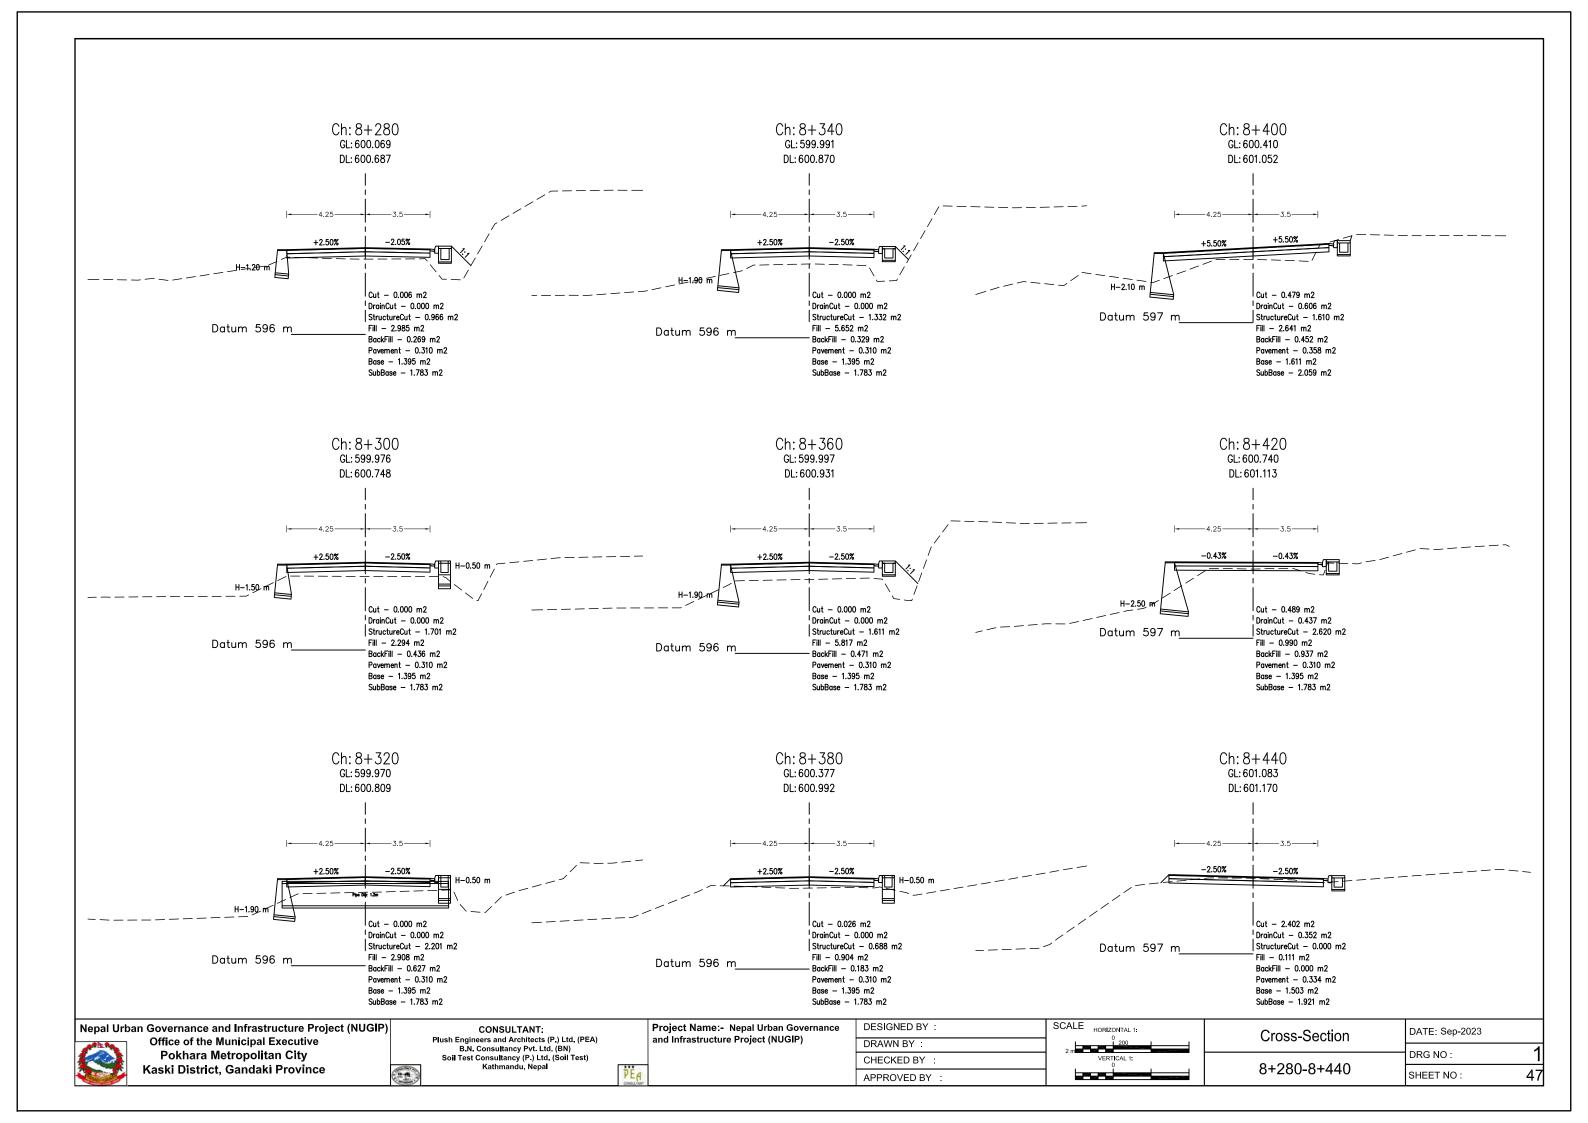


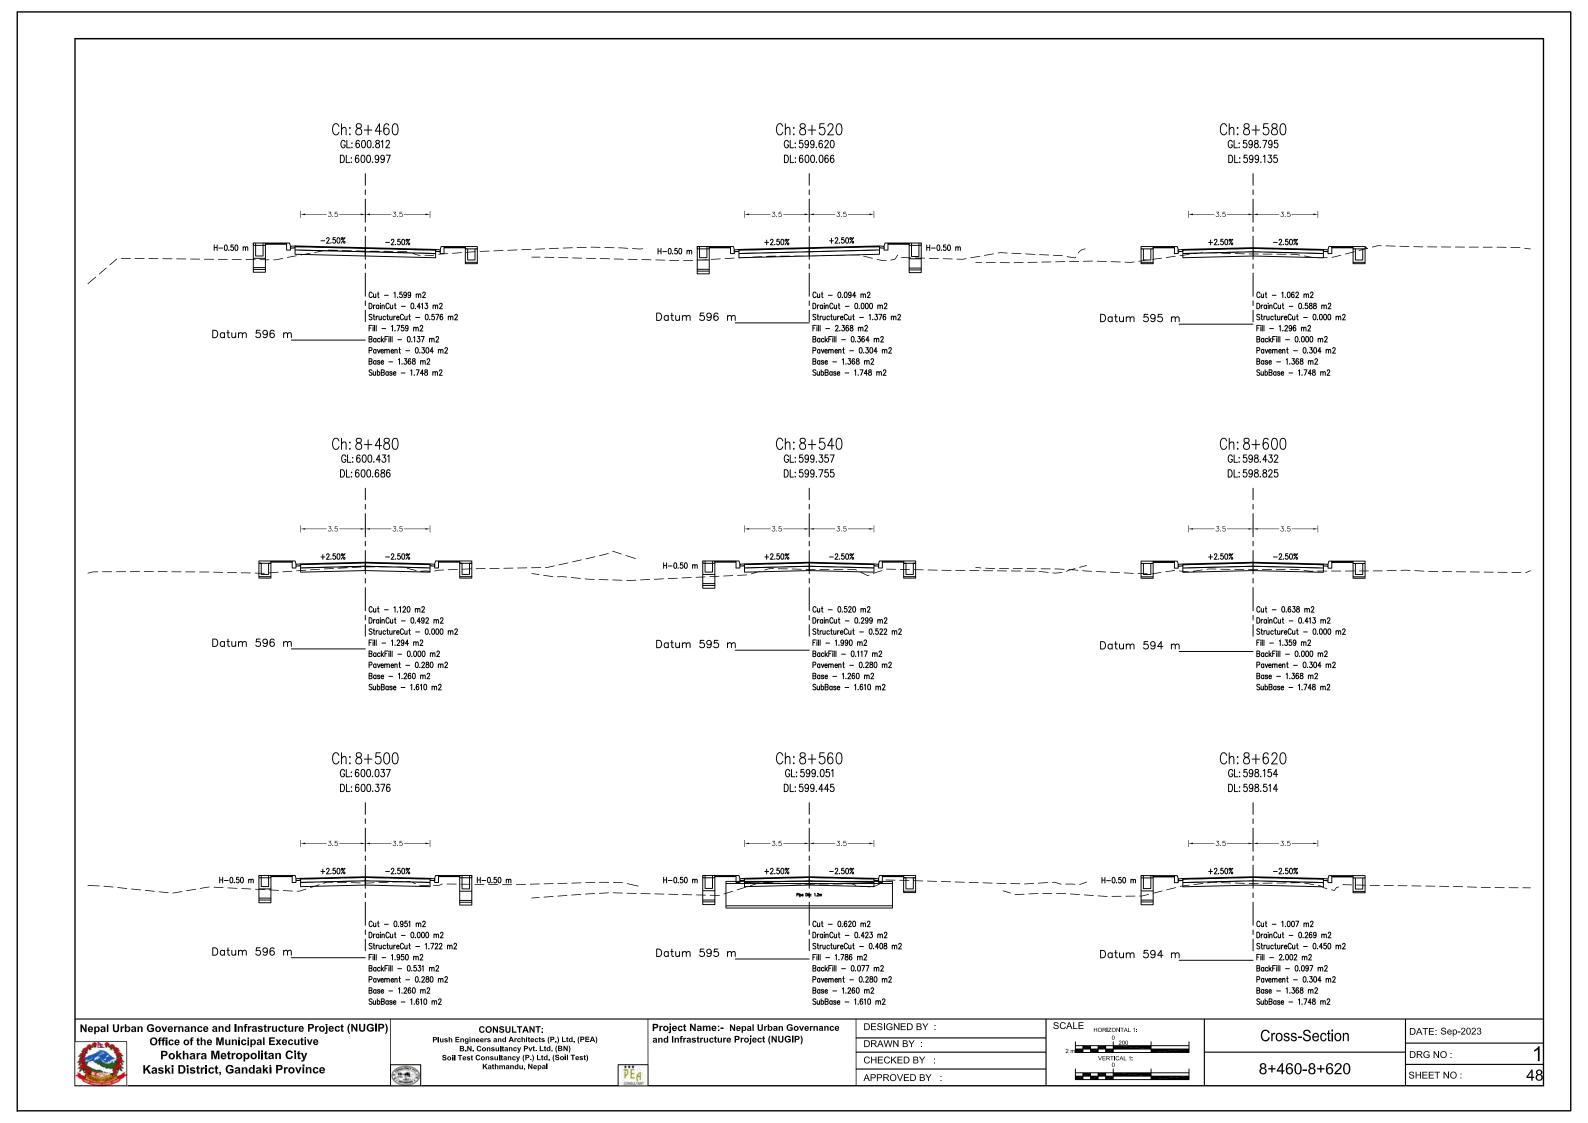


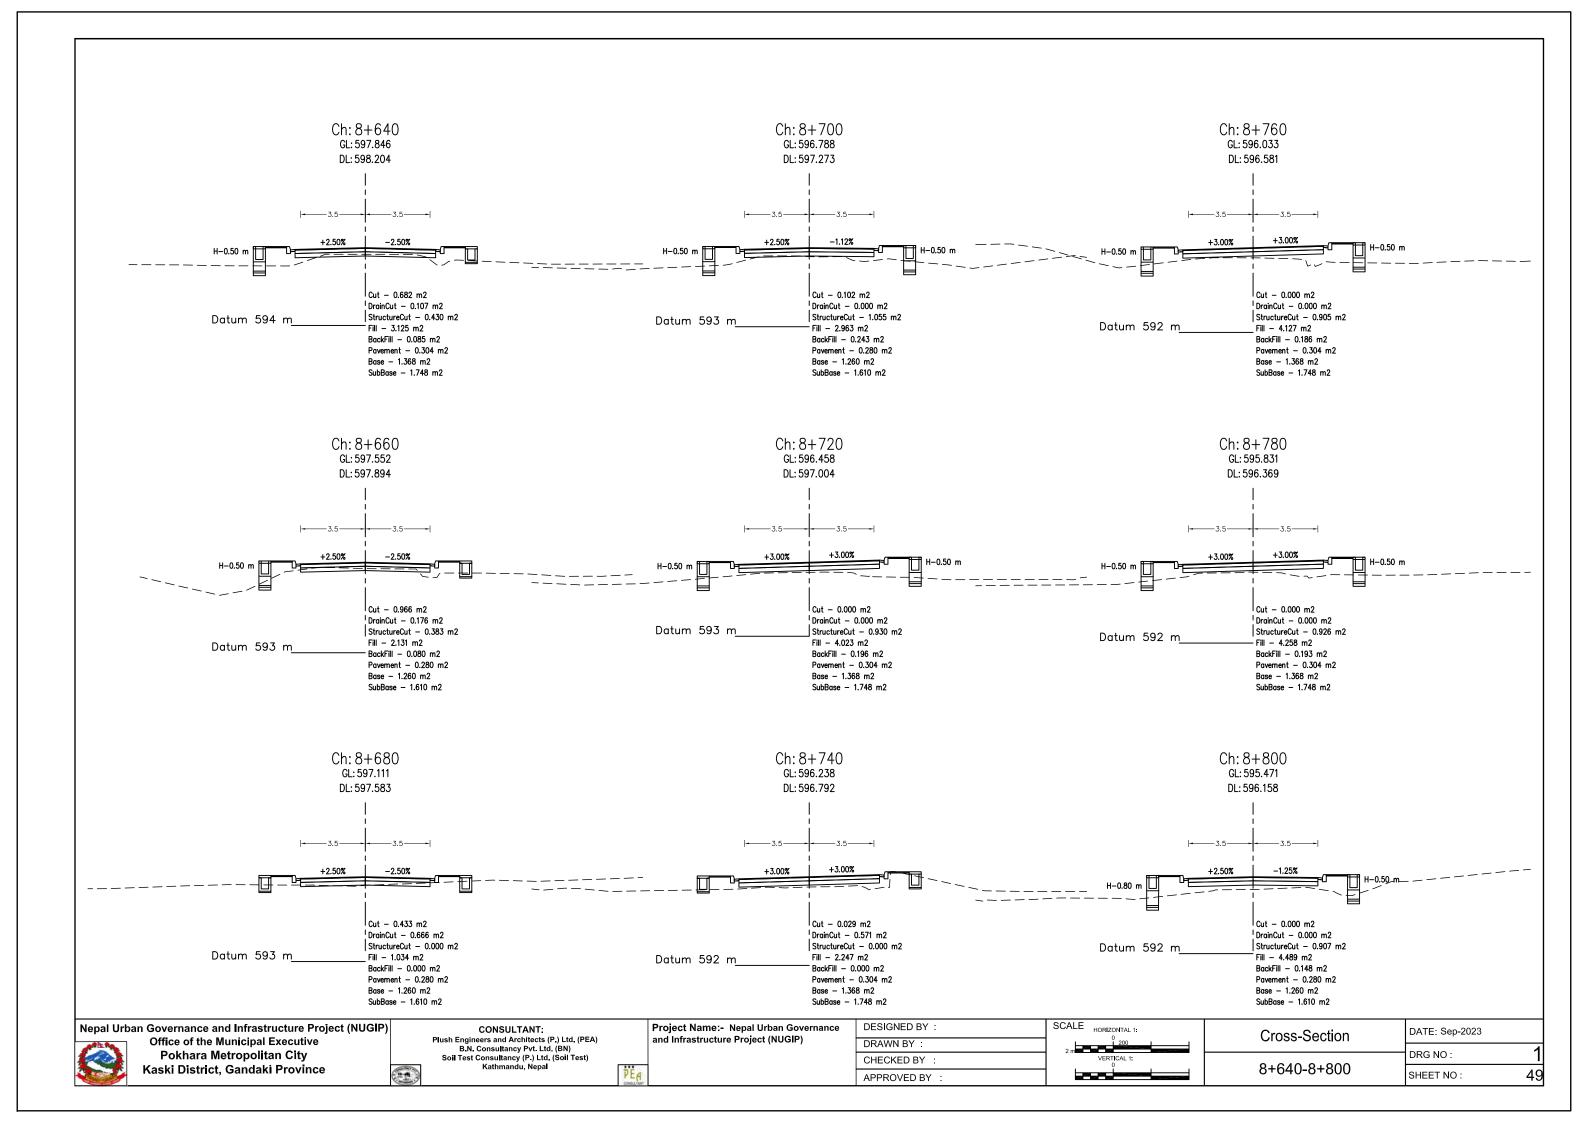


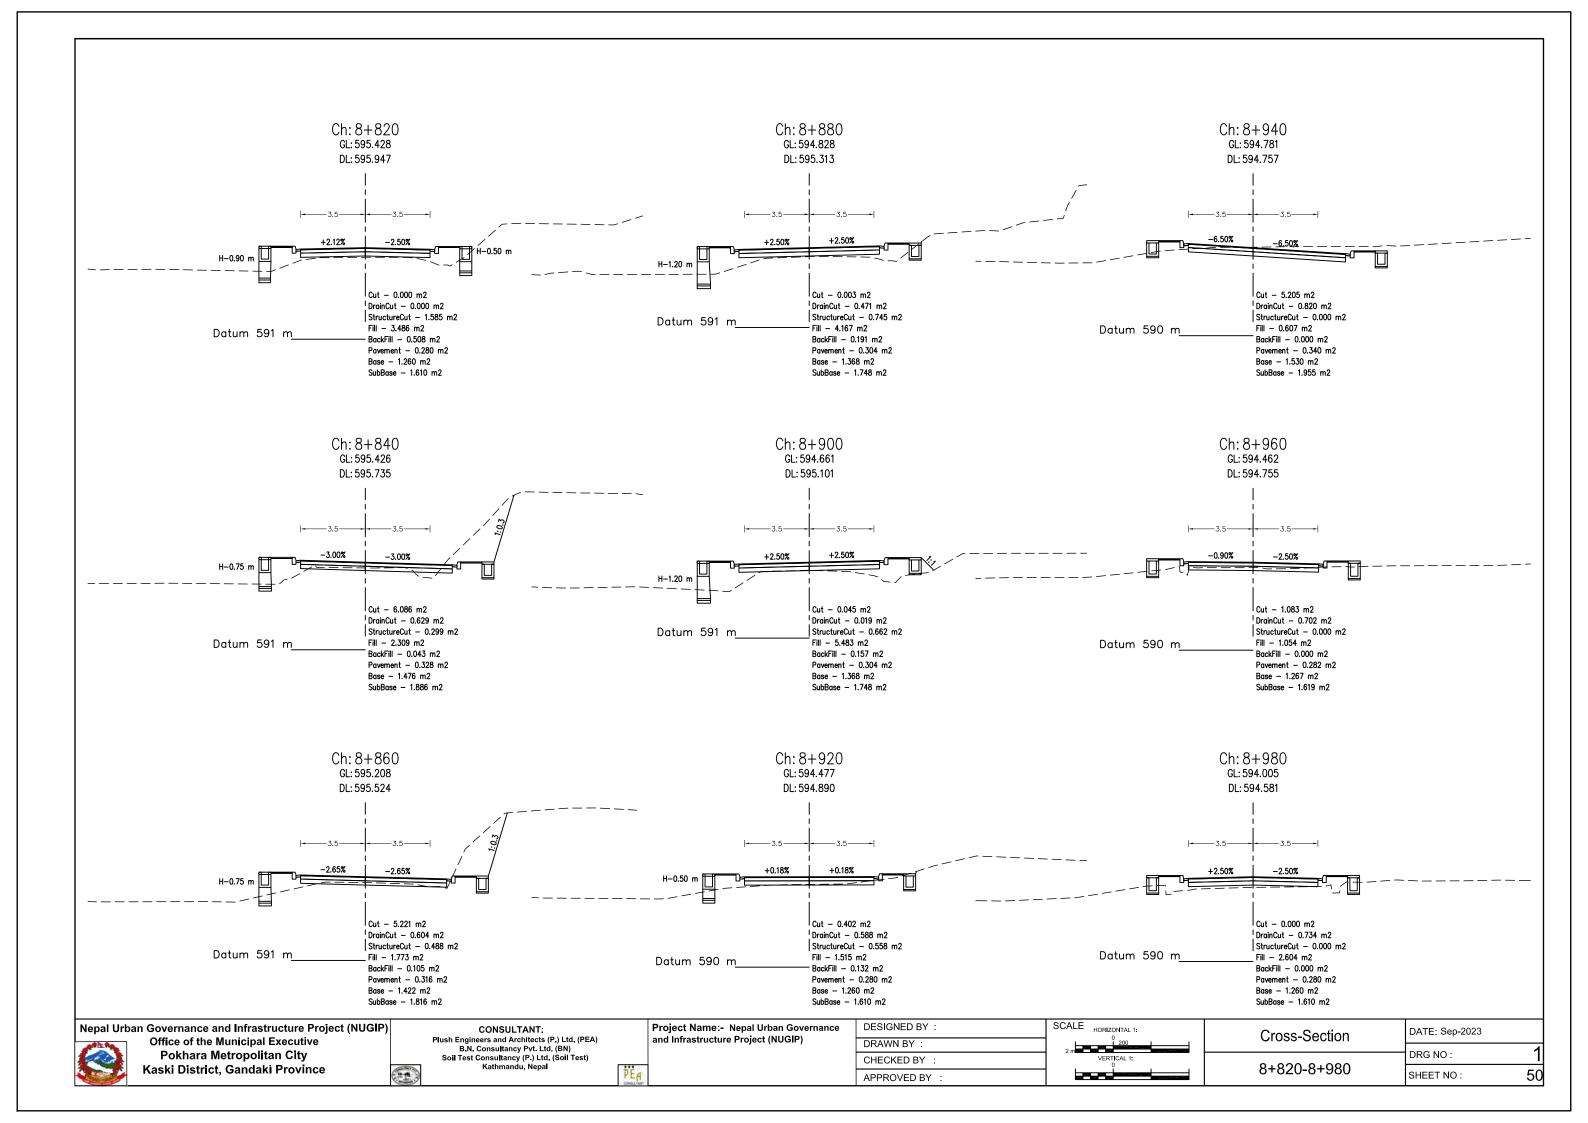

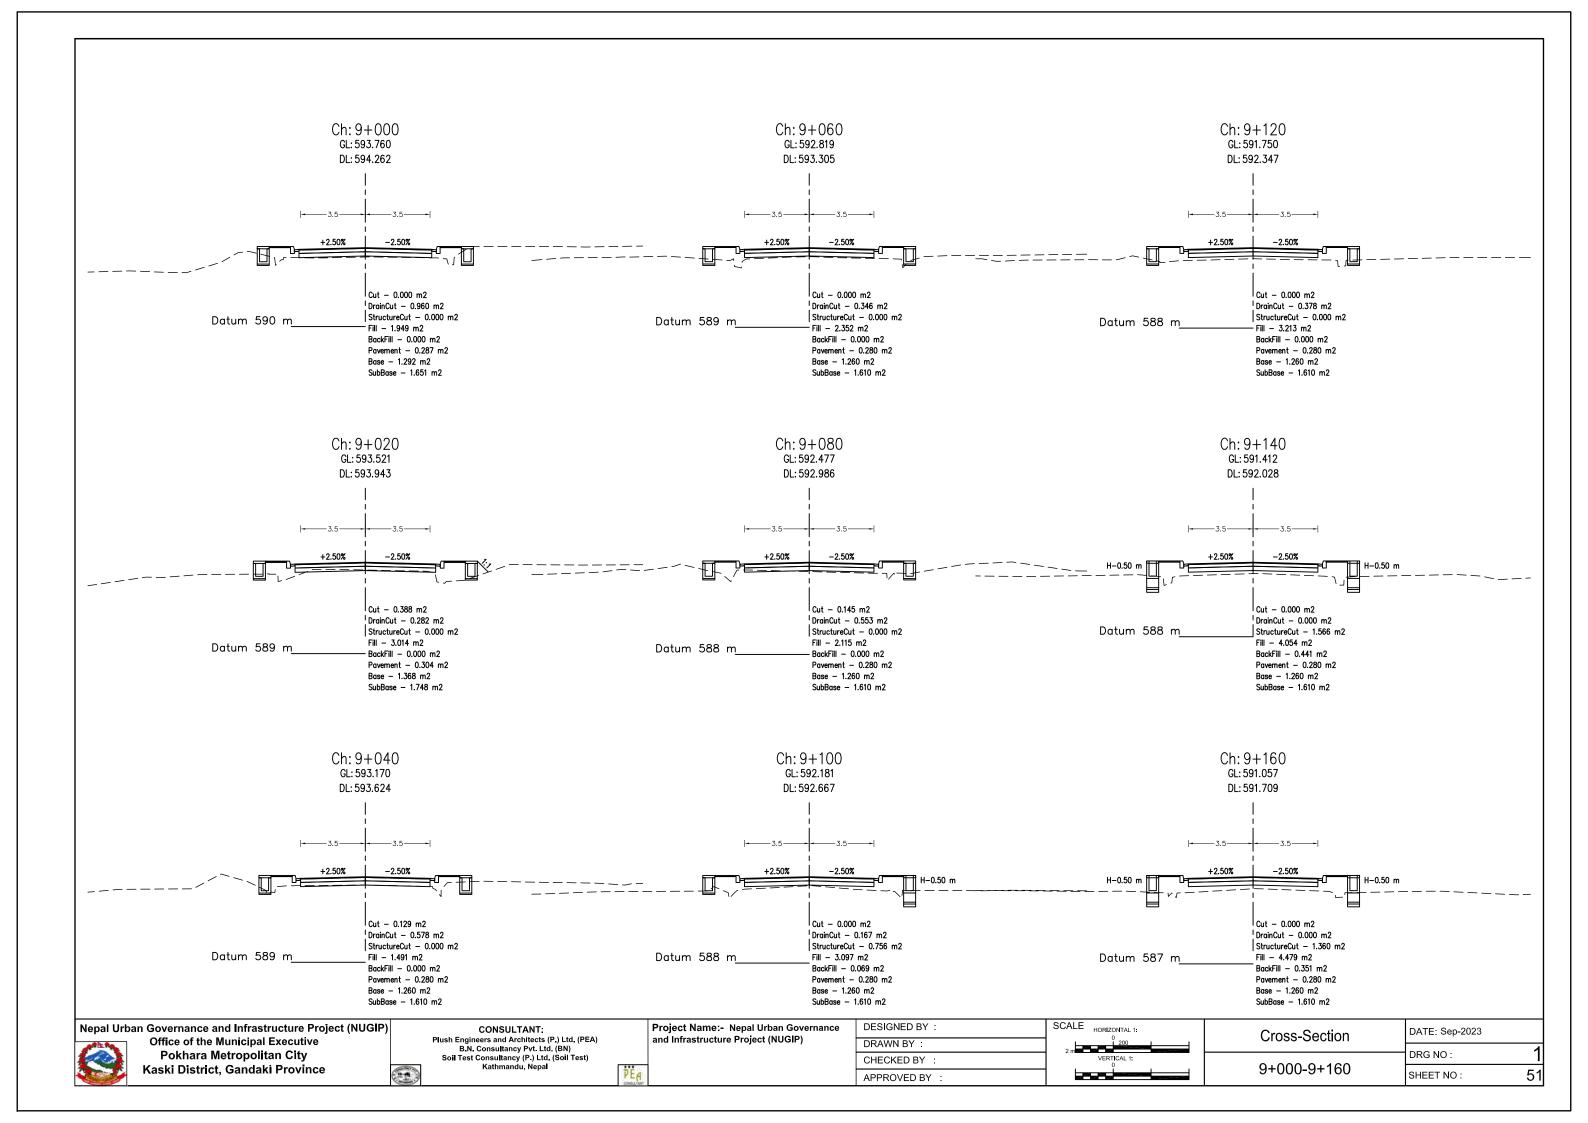

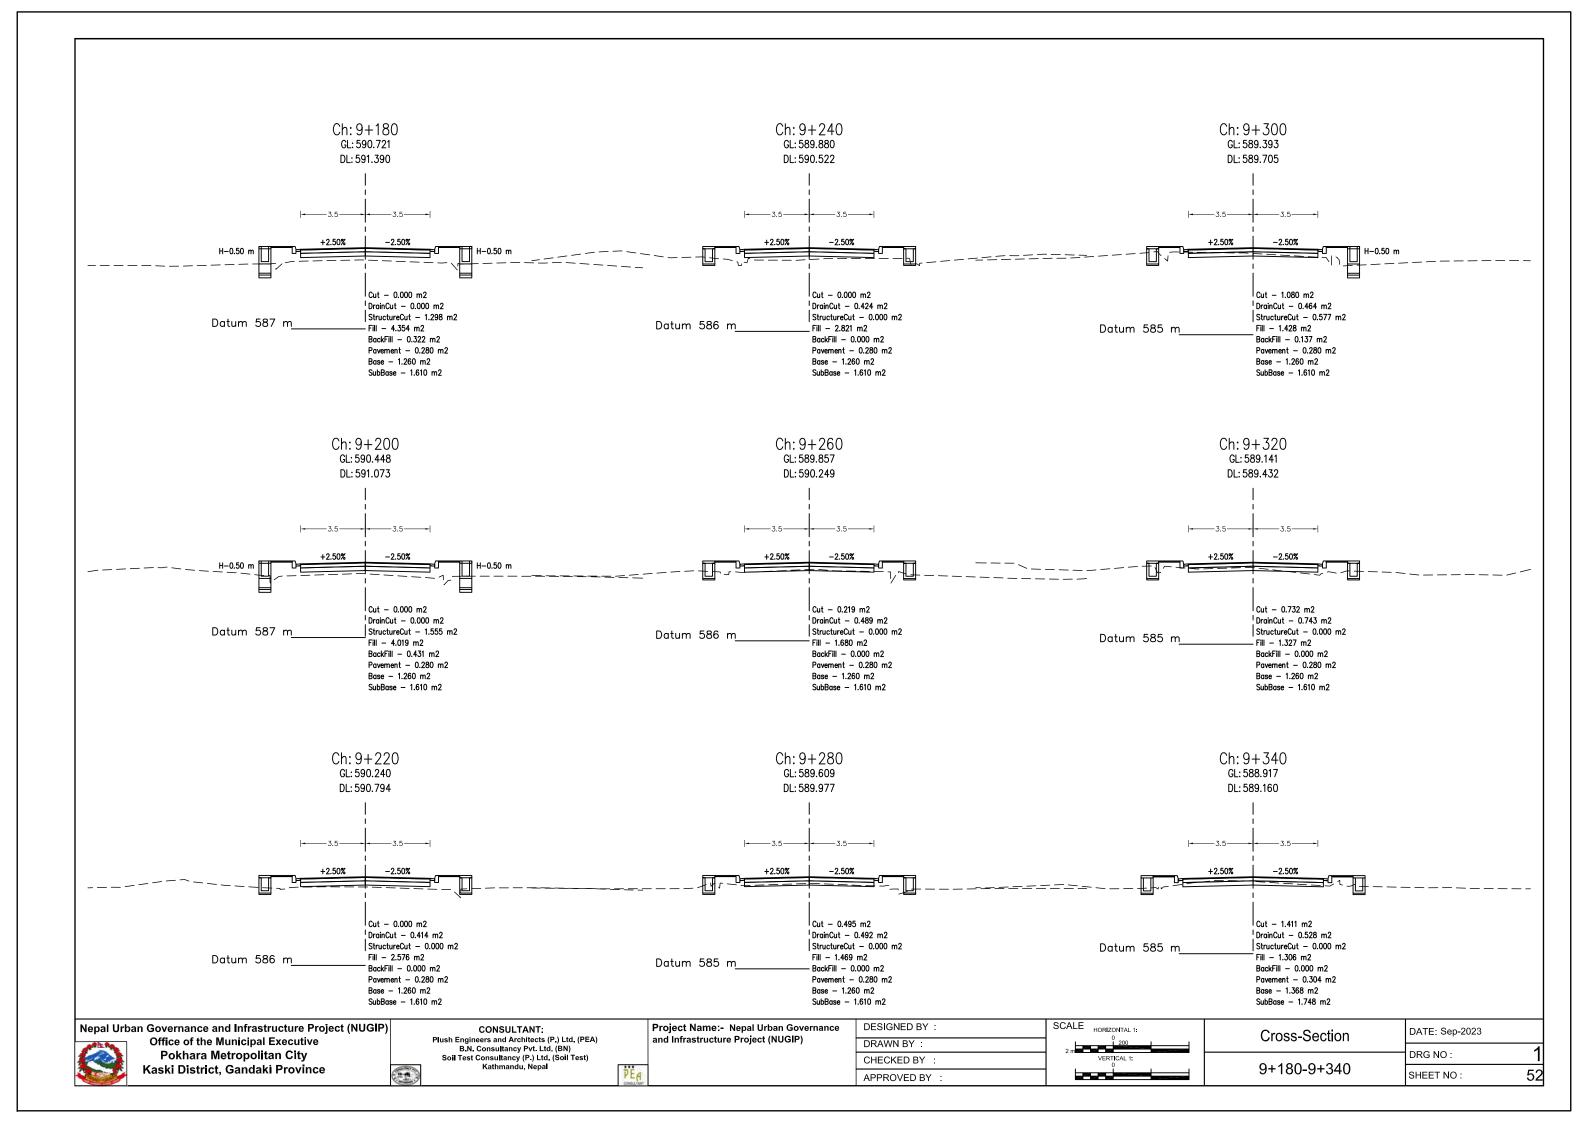

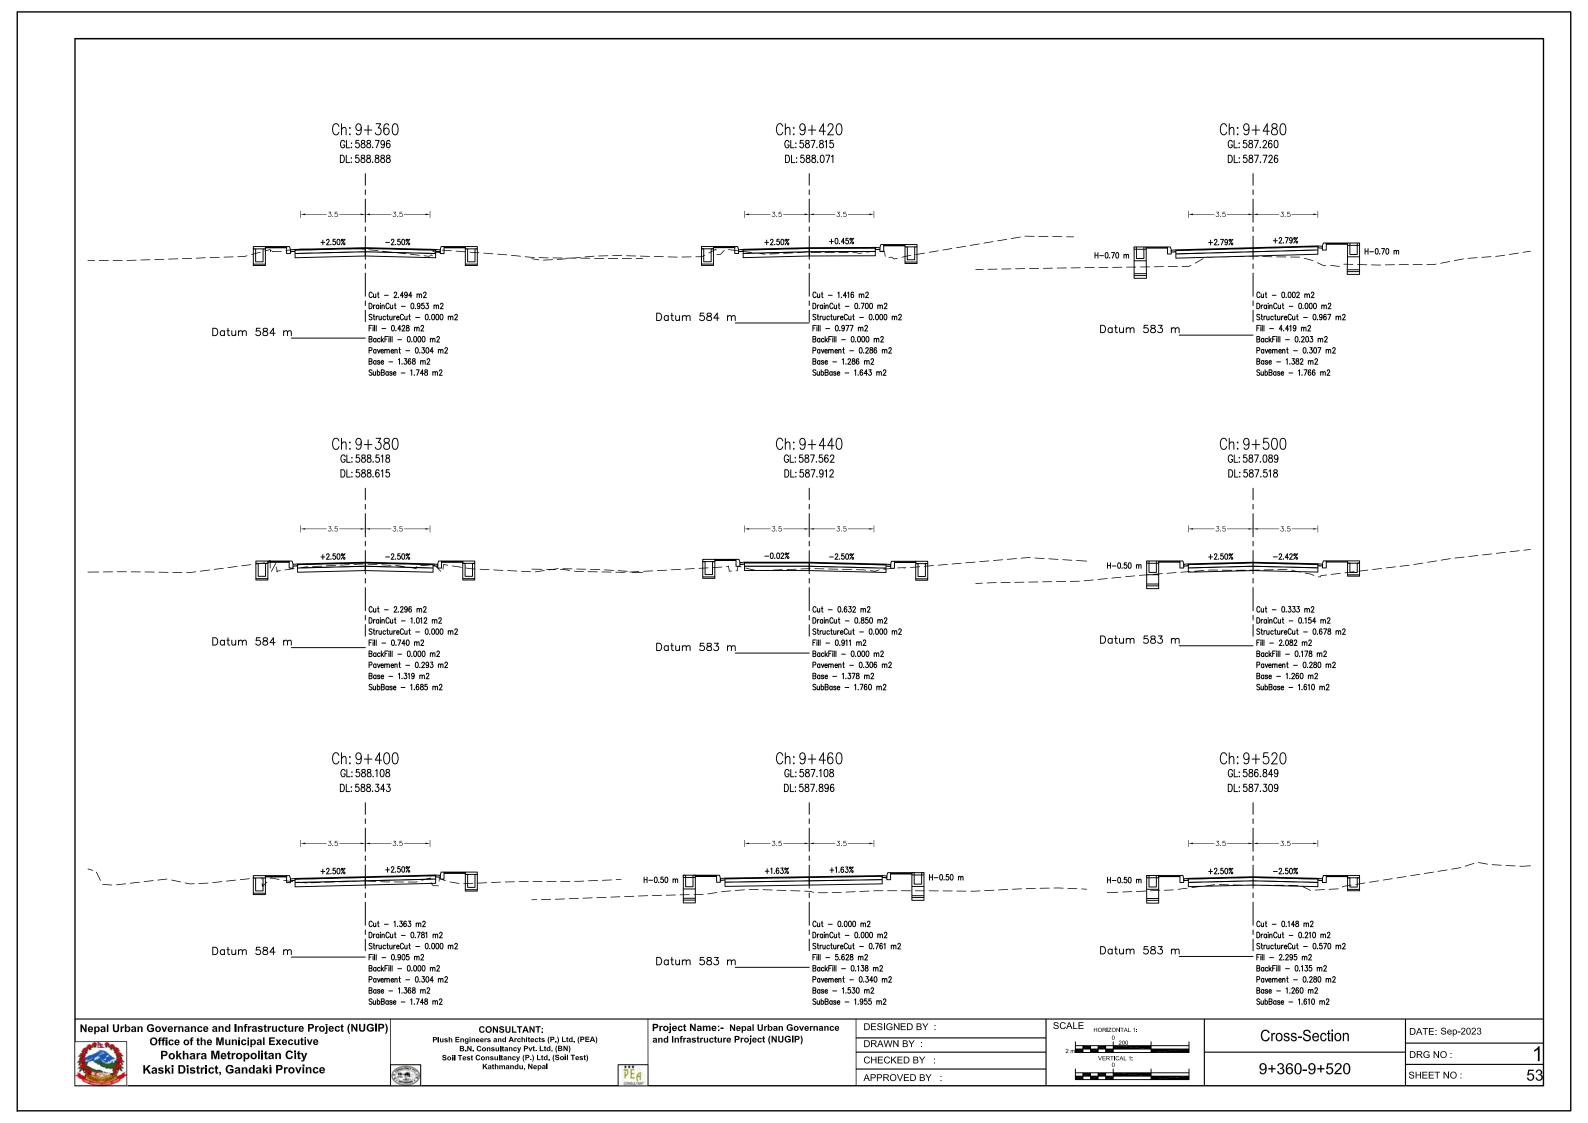

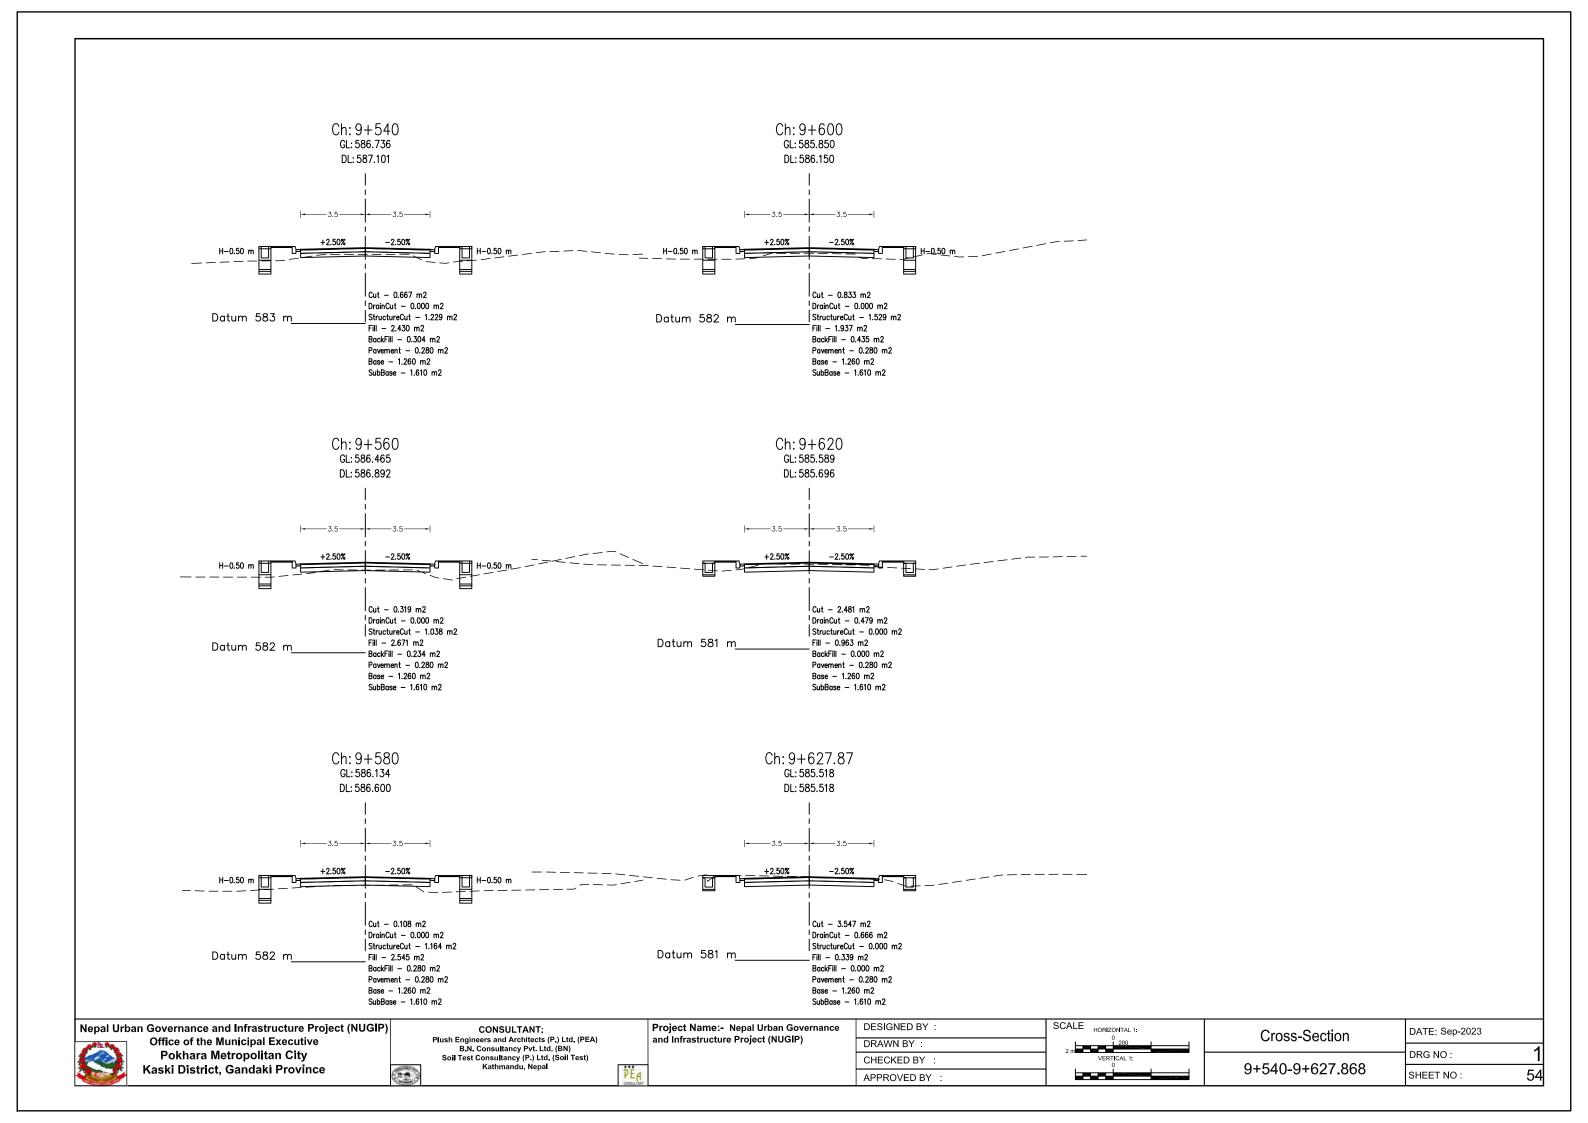



LEGEND	SYMBOL	Tick Drain	
Bench Mark	<u> BM-1</u>	Foot Path	
Houses		kerb stone	
Temple		Side Drain	
RCC Electric pole	<u>- T - </u>	Army Camp	
Pipe Culvert		School	
Eletric Pole	EP EP	Bamboo	
Wodden Pole	<u></u>		·
Centreline			
Chainage	— 1+030 — 1+020 — 1+010 — 1+000 — 0+990 — 0+980		

Nepal Urban Governance and Infrastructure Project (NUGIP)

Office of the Municipal Executive

Pokhara Metropolitan City

Kaski District, Gandaki Province

**Compound Wall** 

Chautara

Khola





Project Name:- Nepal Urban Governance and Infrastructure Project (NUGIP)


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DRAWN BY:	ĺ
CHECKED BY :	
APPROVED BY :	l


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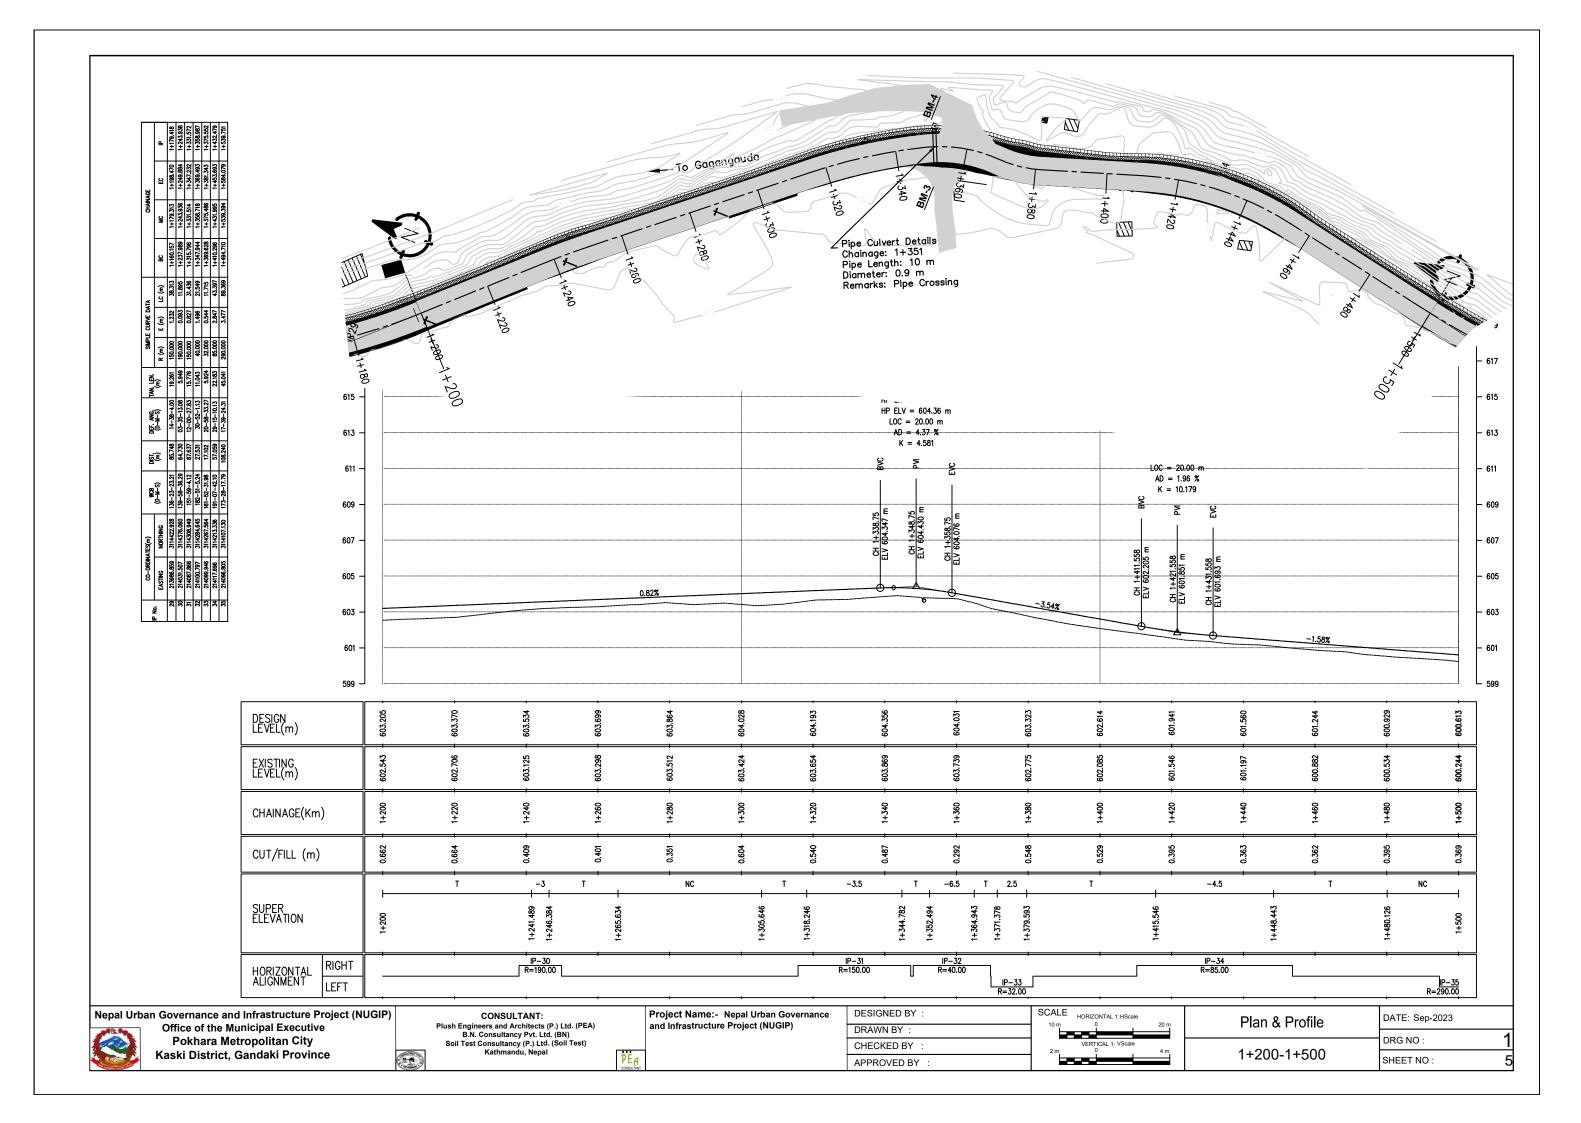
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•	DRG NO :
	SHEET NO:




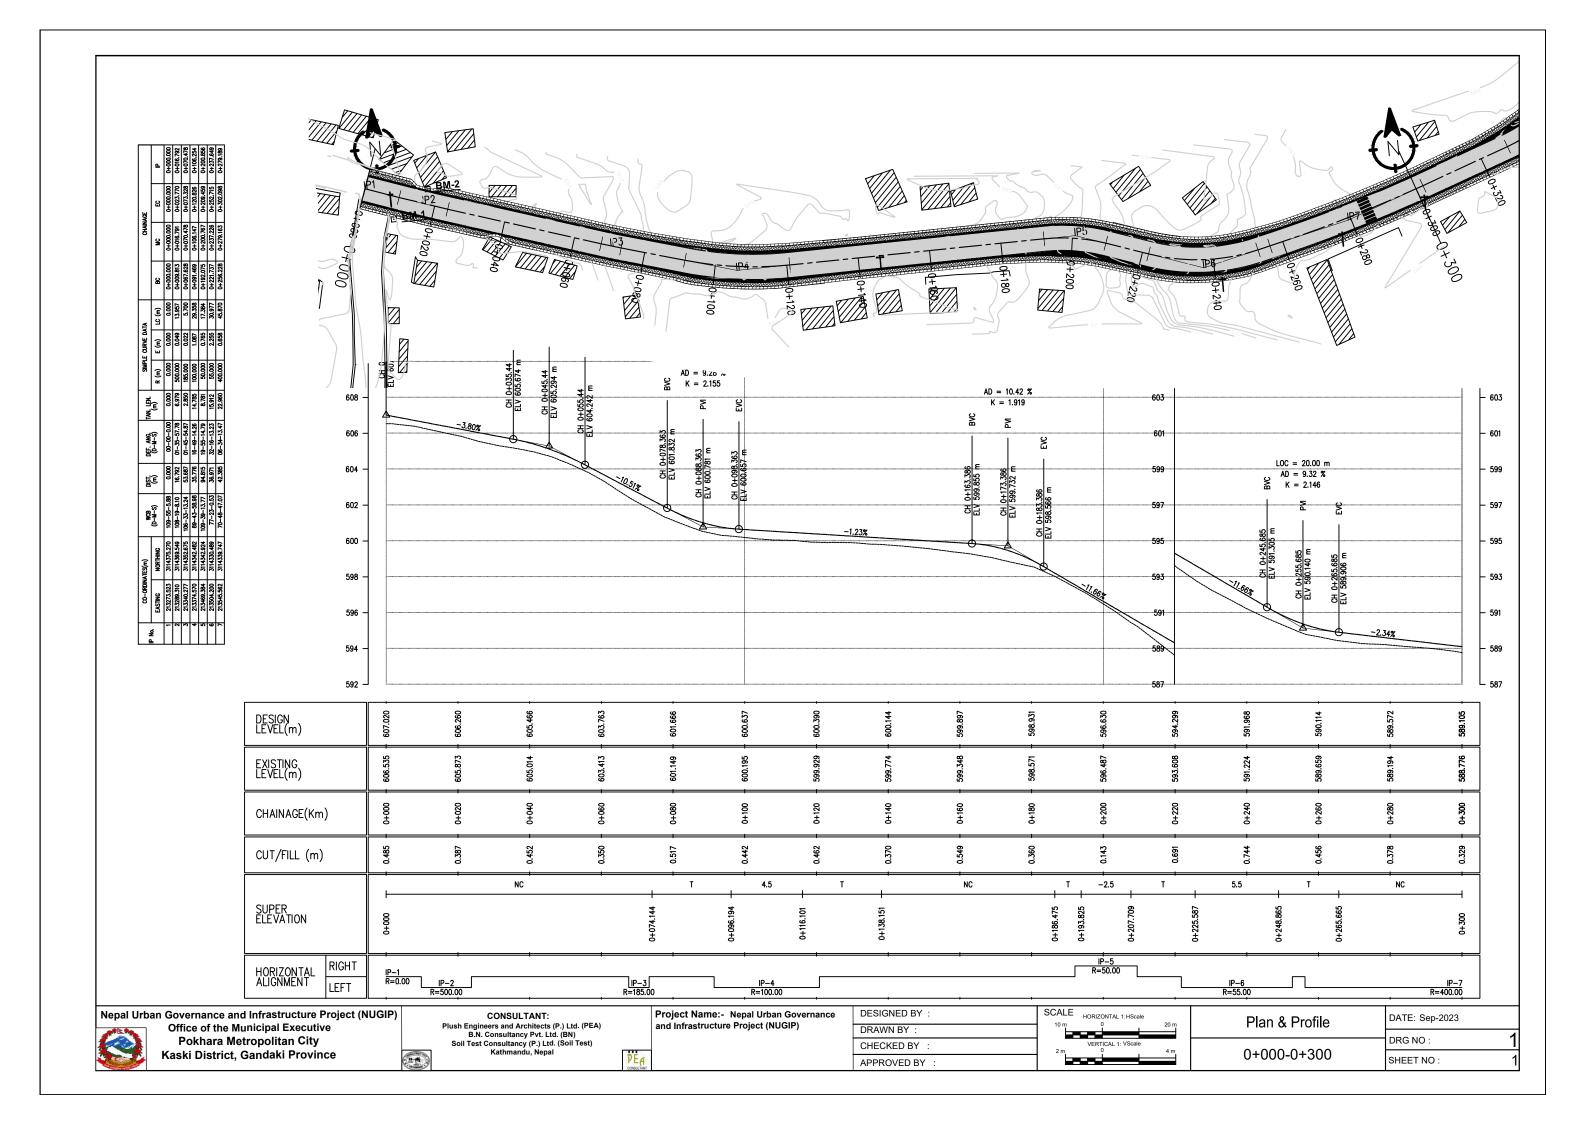


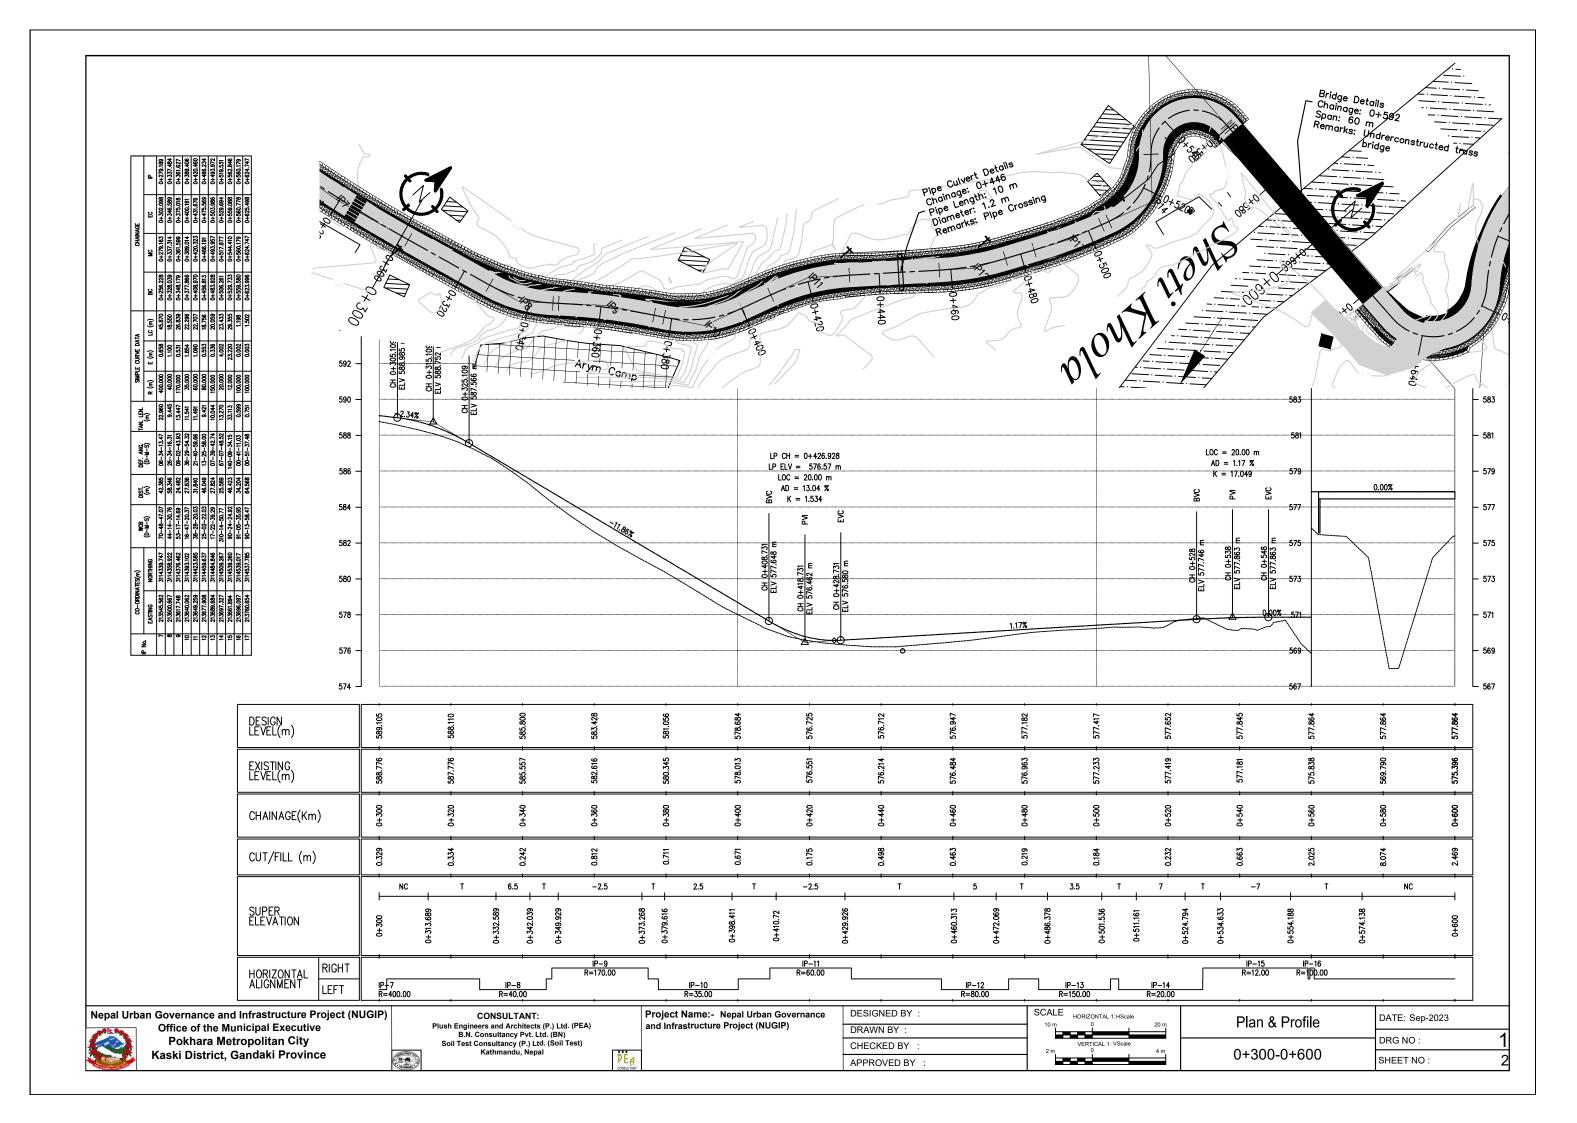


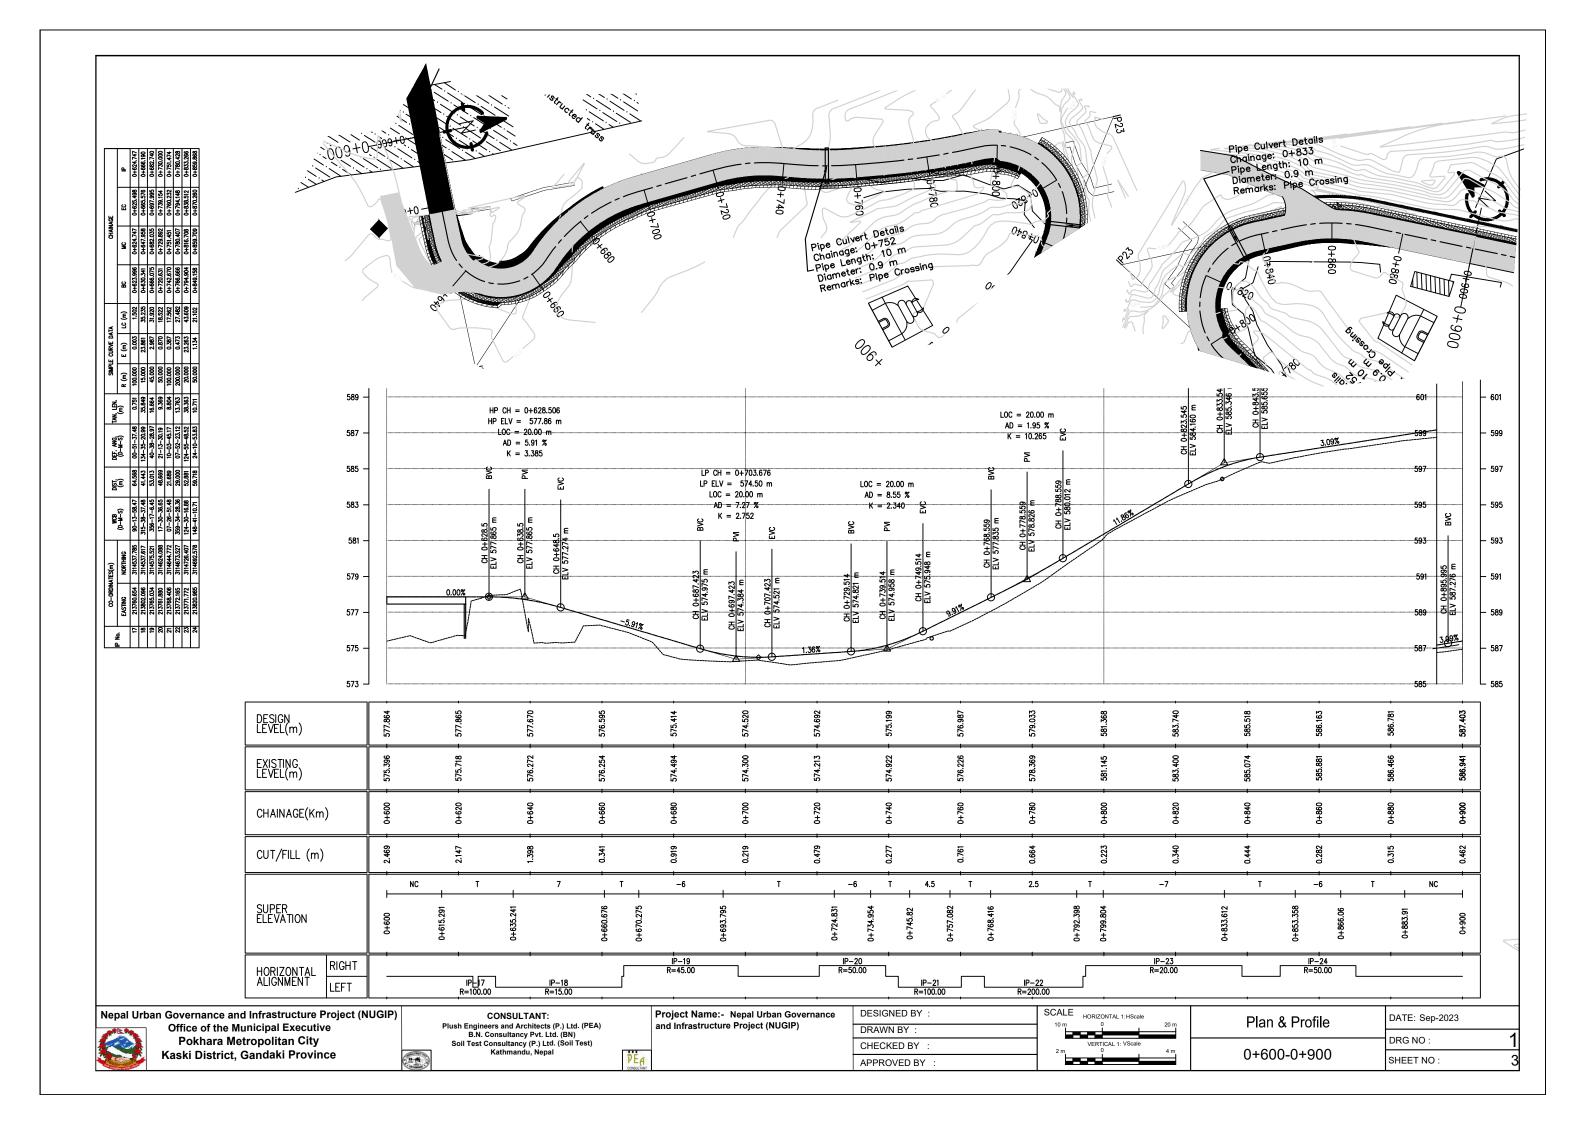


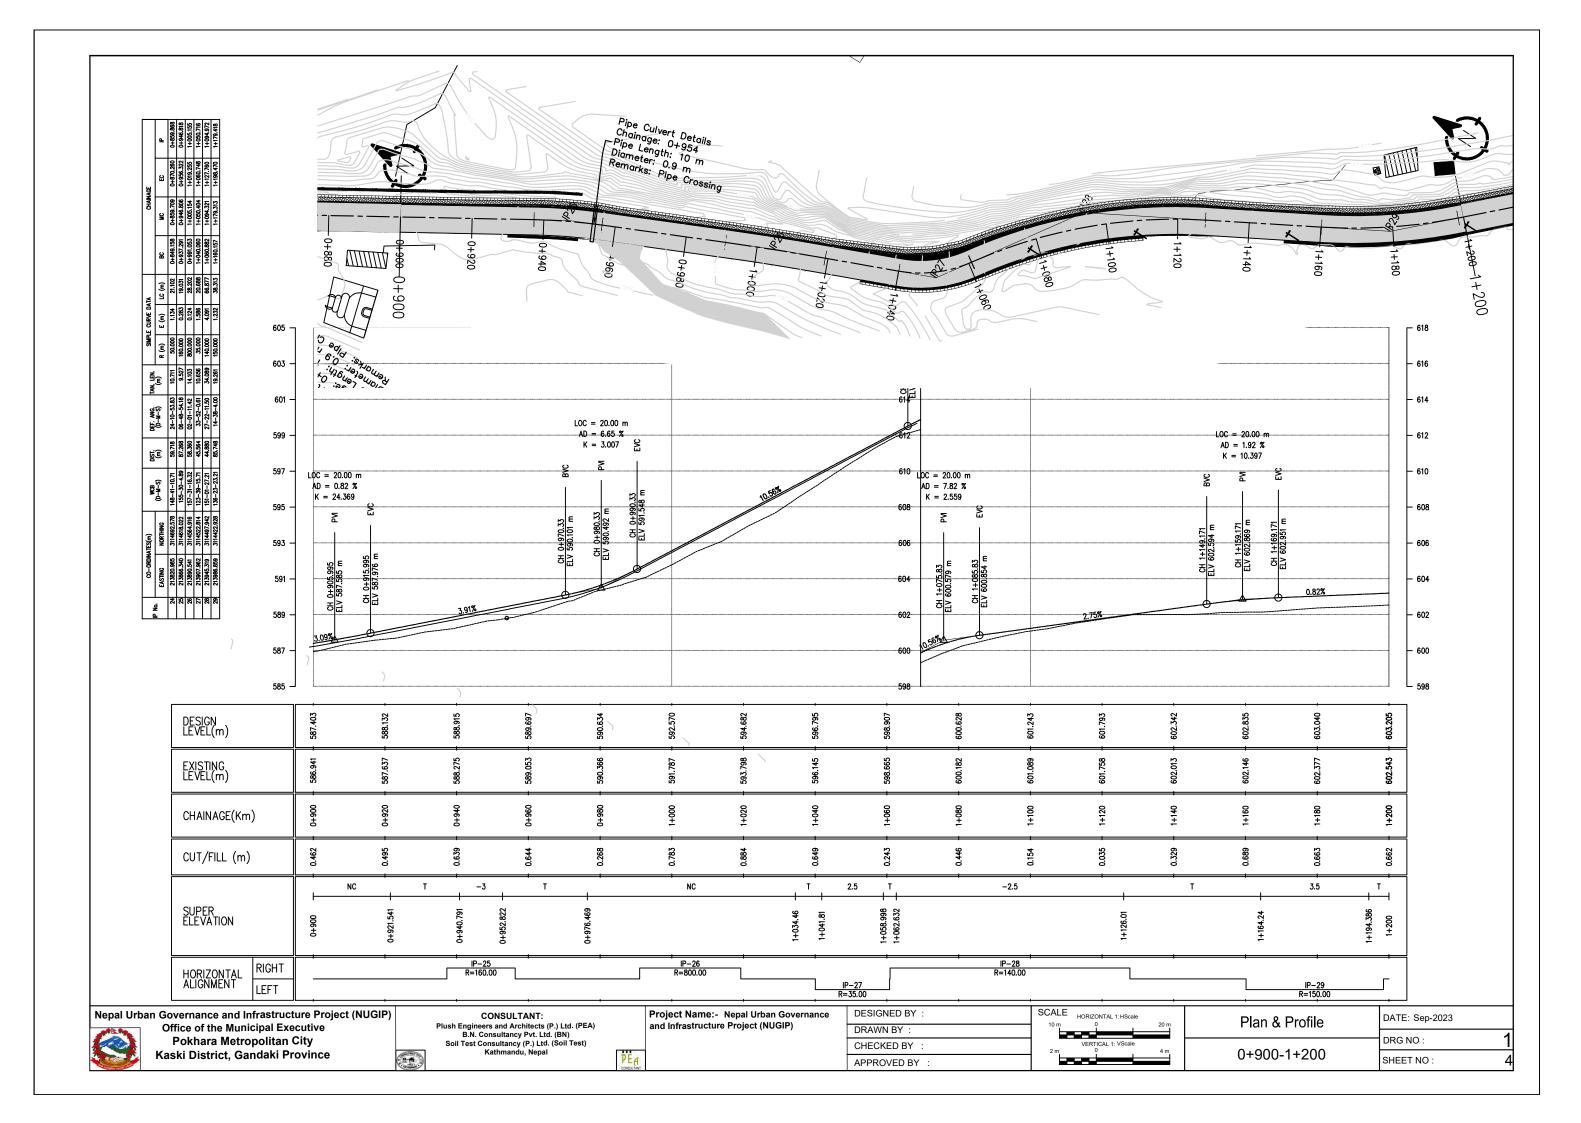


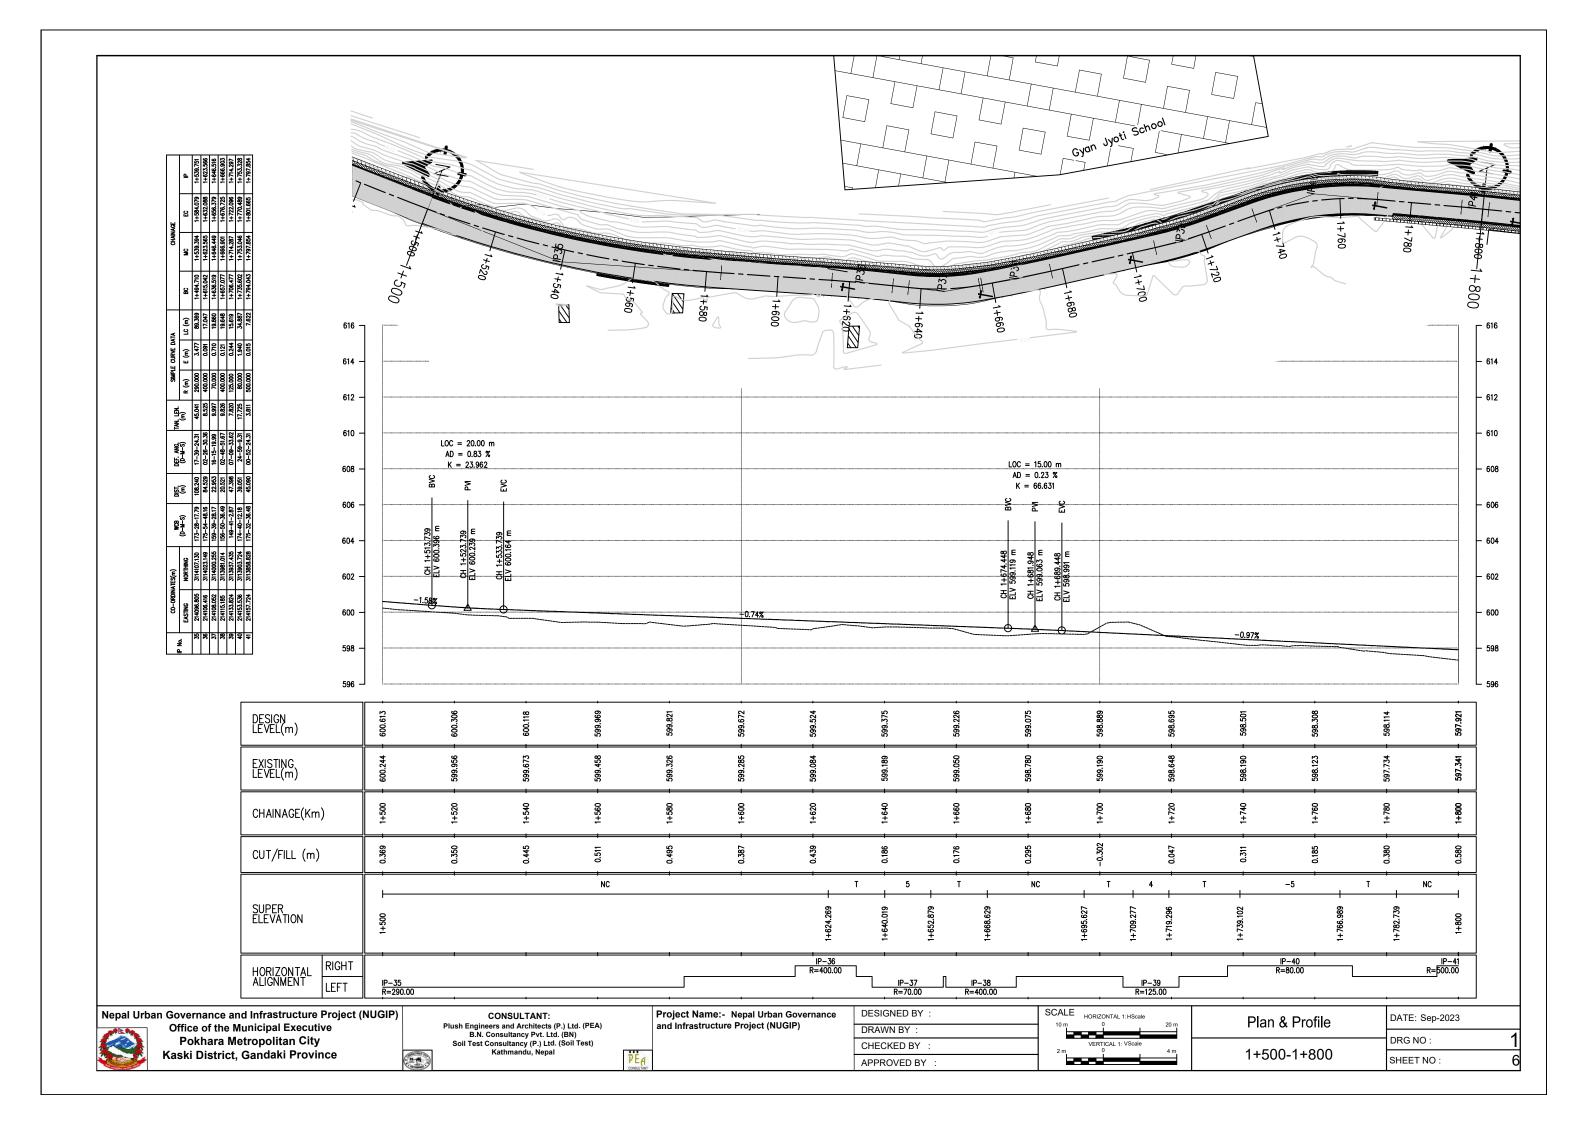

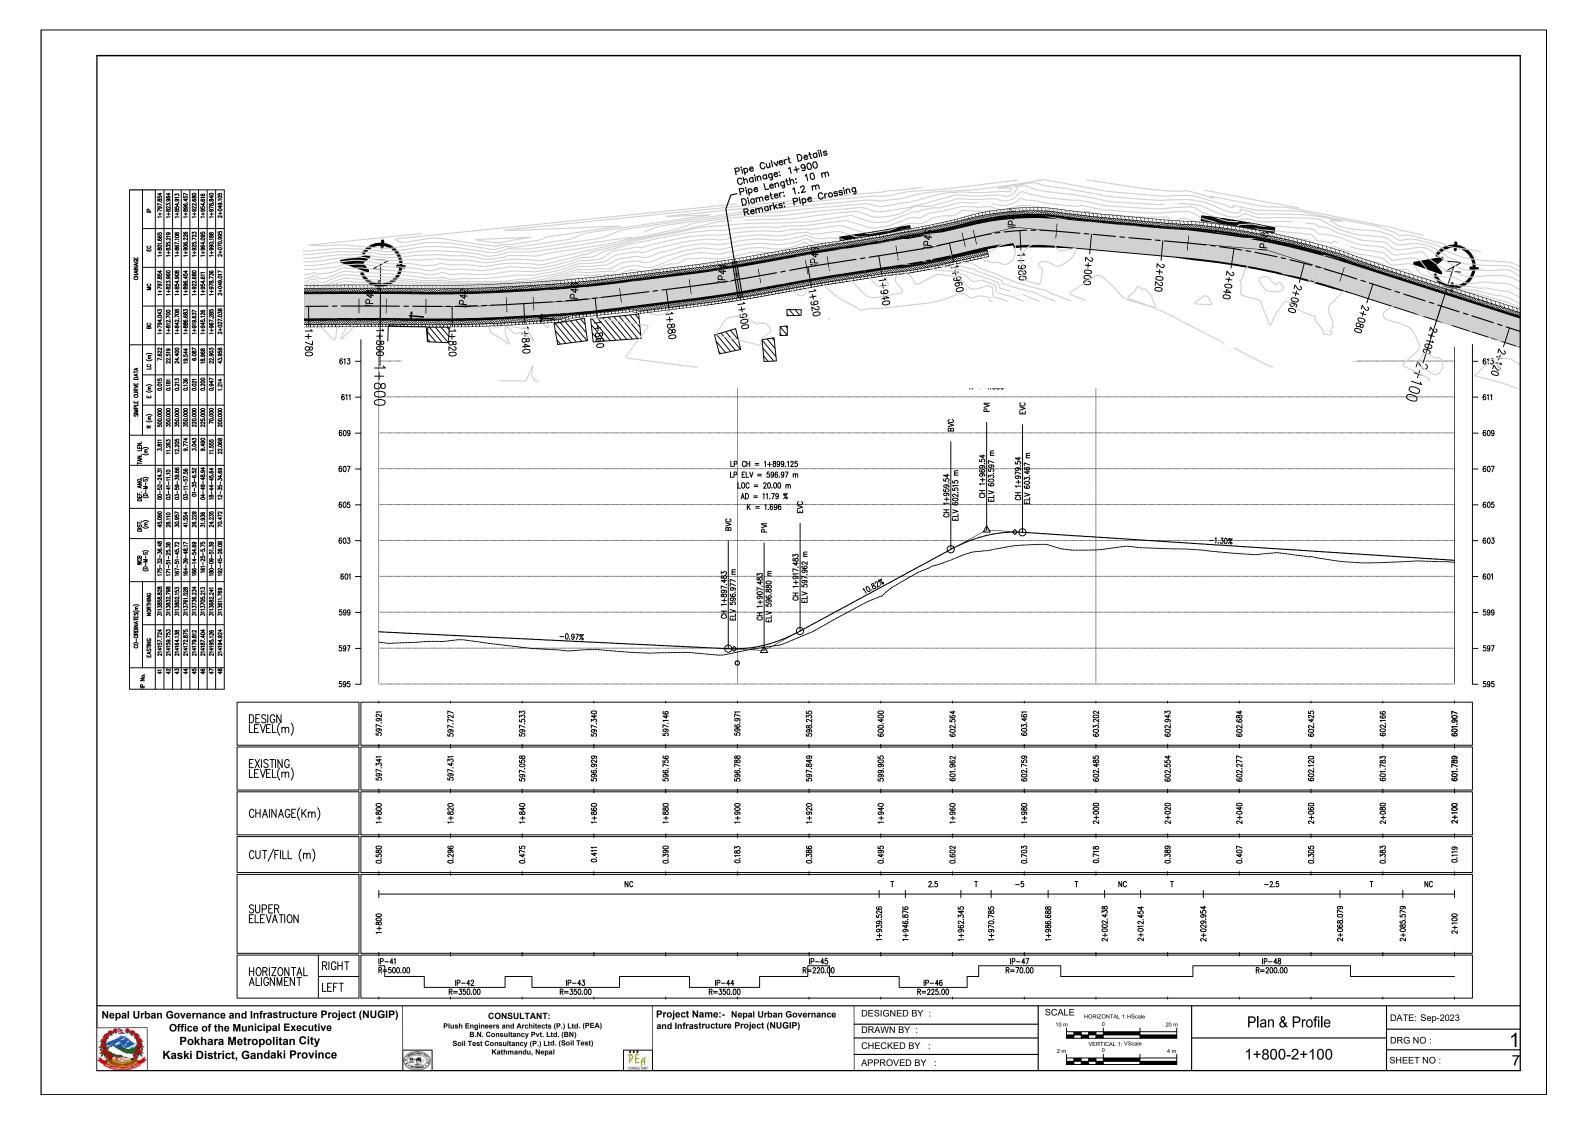

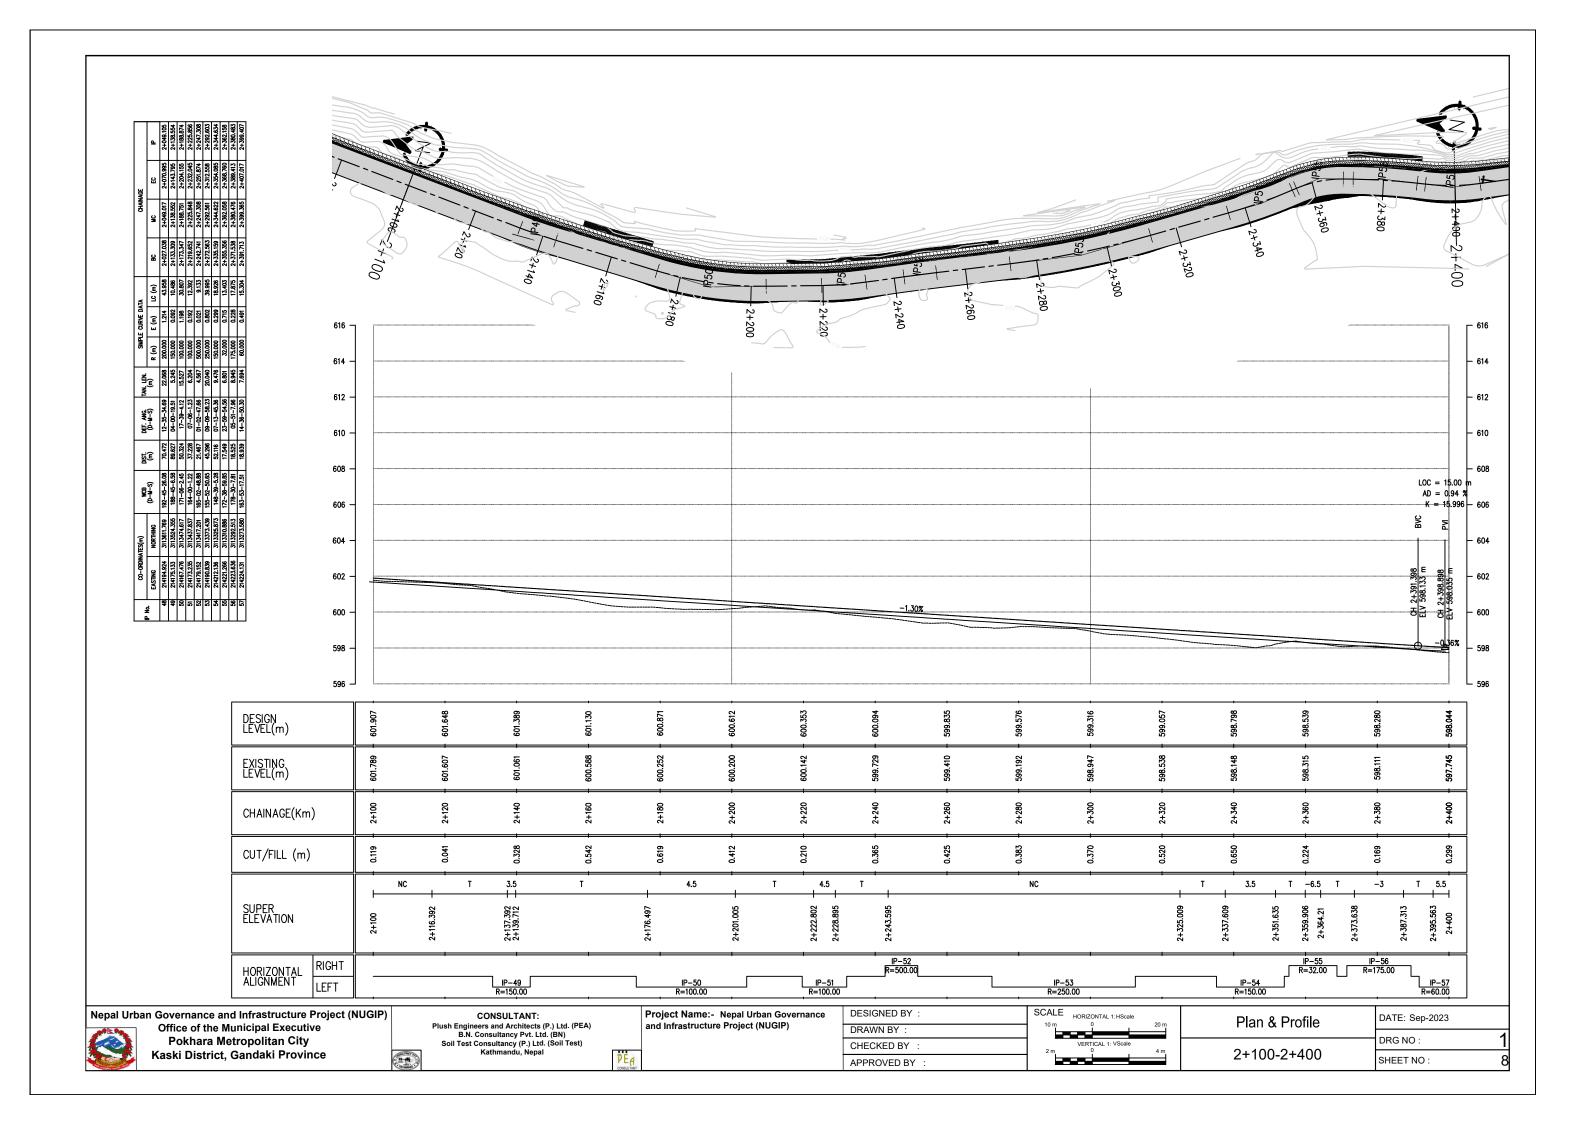

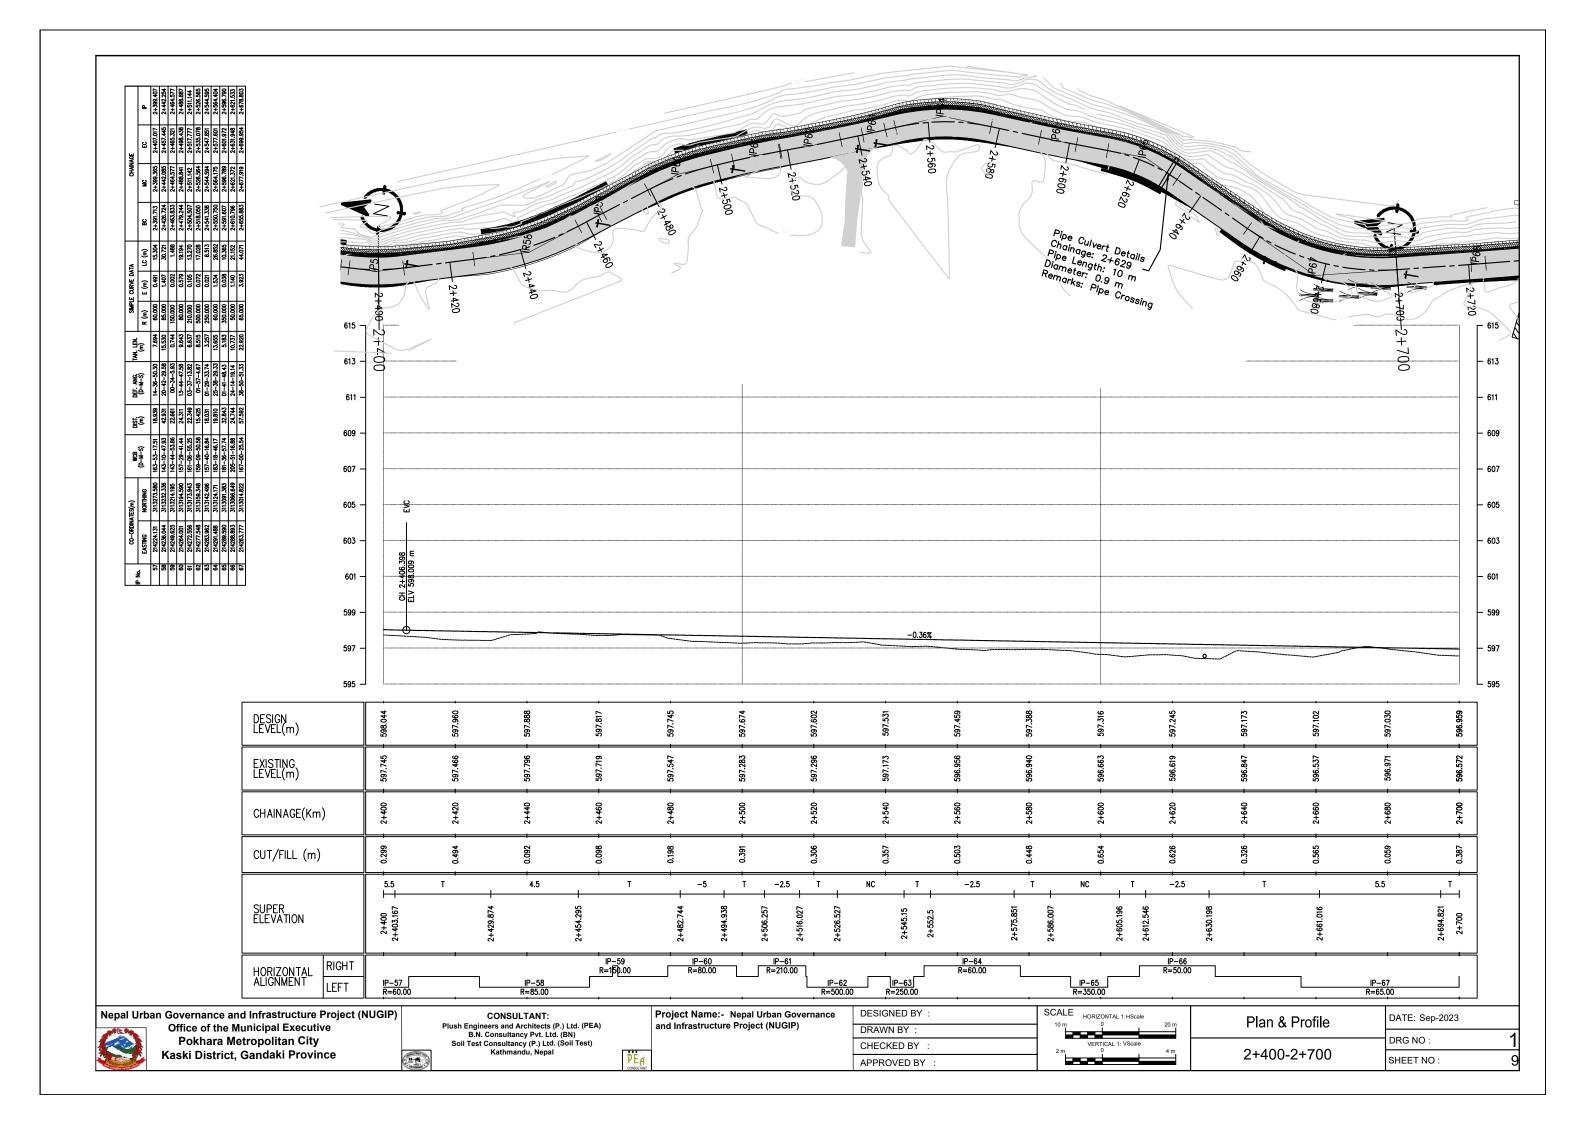

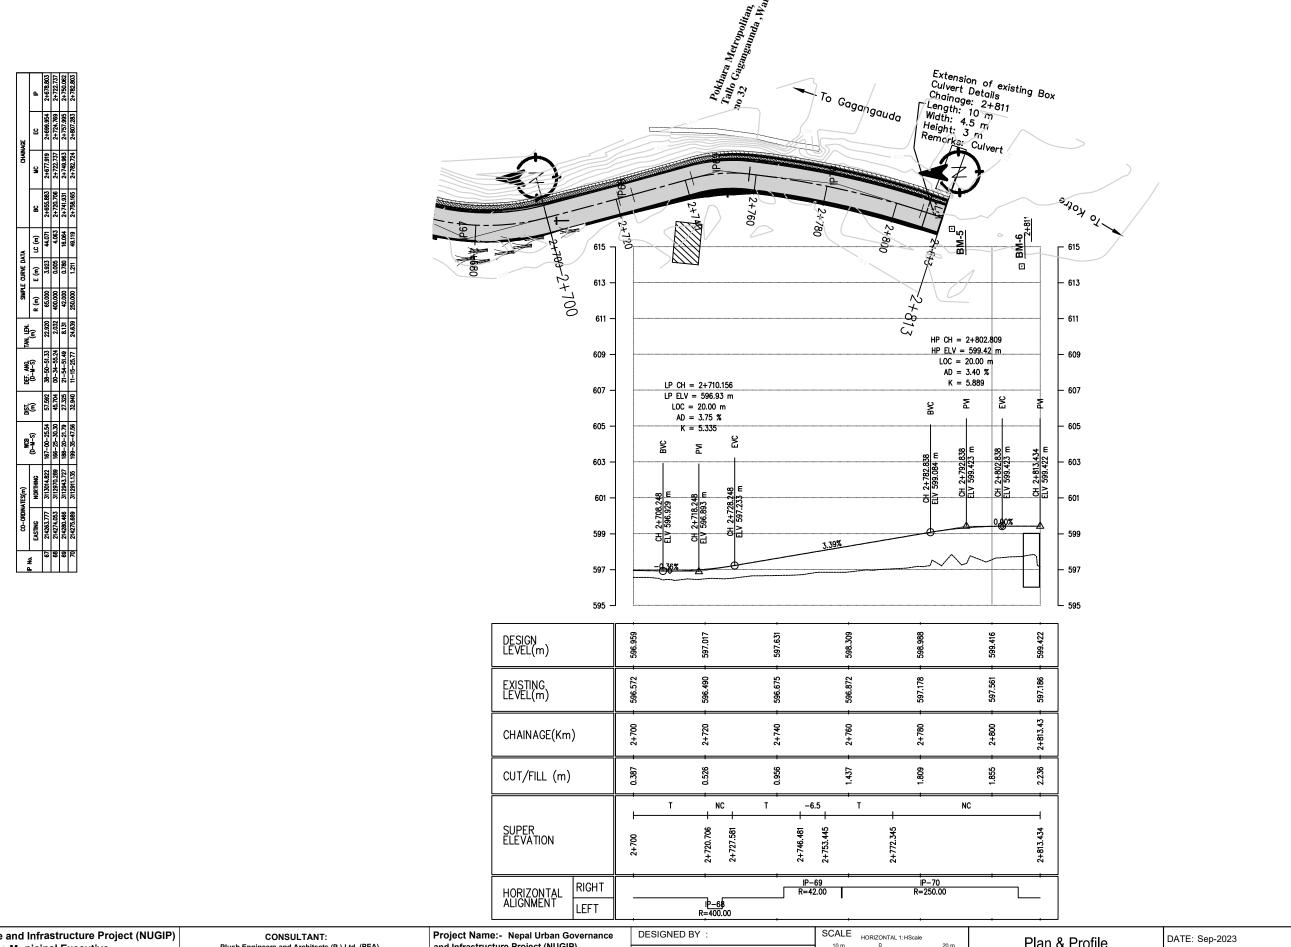

Nepal Urban Governance and Infrastructure Project (NUGIP) Office of the Municipal Executive Pokhara Metropolitan City Kaski District, Gandaki Province

Plush Engineers and Architects (P.) Ltd. (PEA)
B.N. Consultancy Pvt. Ltd. (BN)
Soil Test Consultancy (P.) Ltd. (Soil Test)
Kathmandu, Nepal

and Infrastructure Project (NUGIP)


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APPROVED BY ·		


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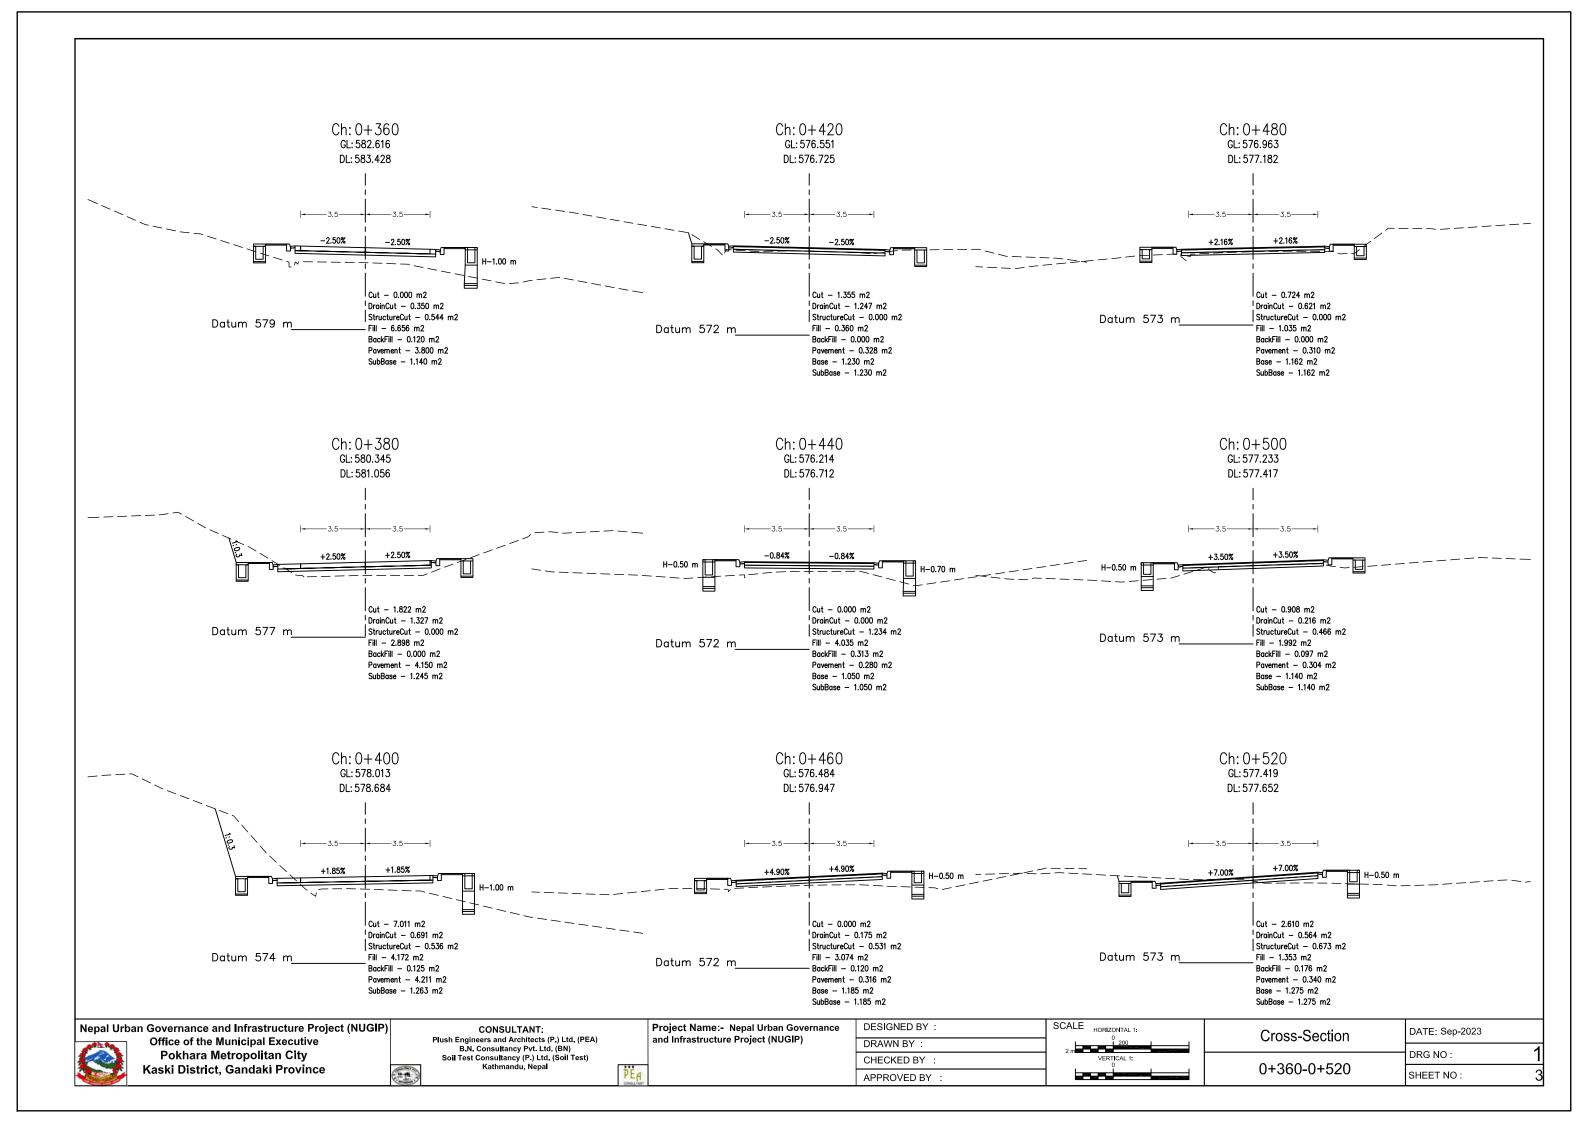
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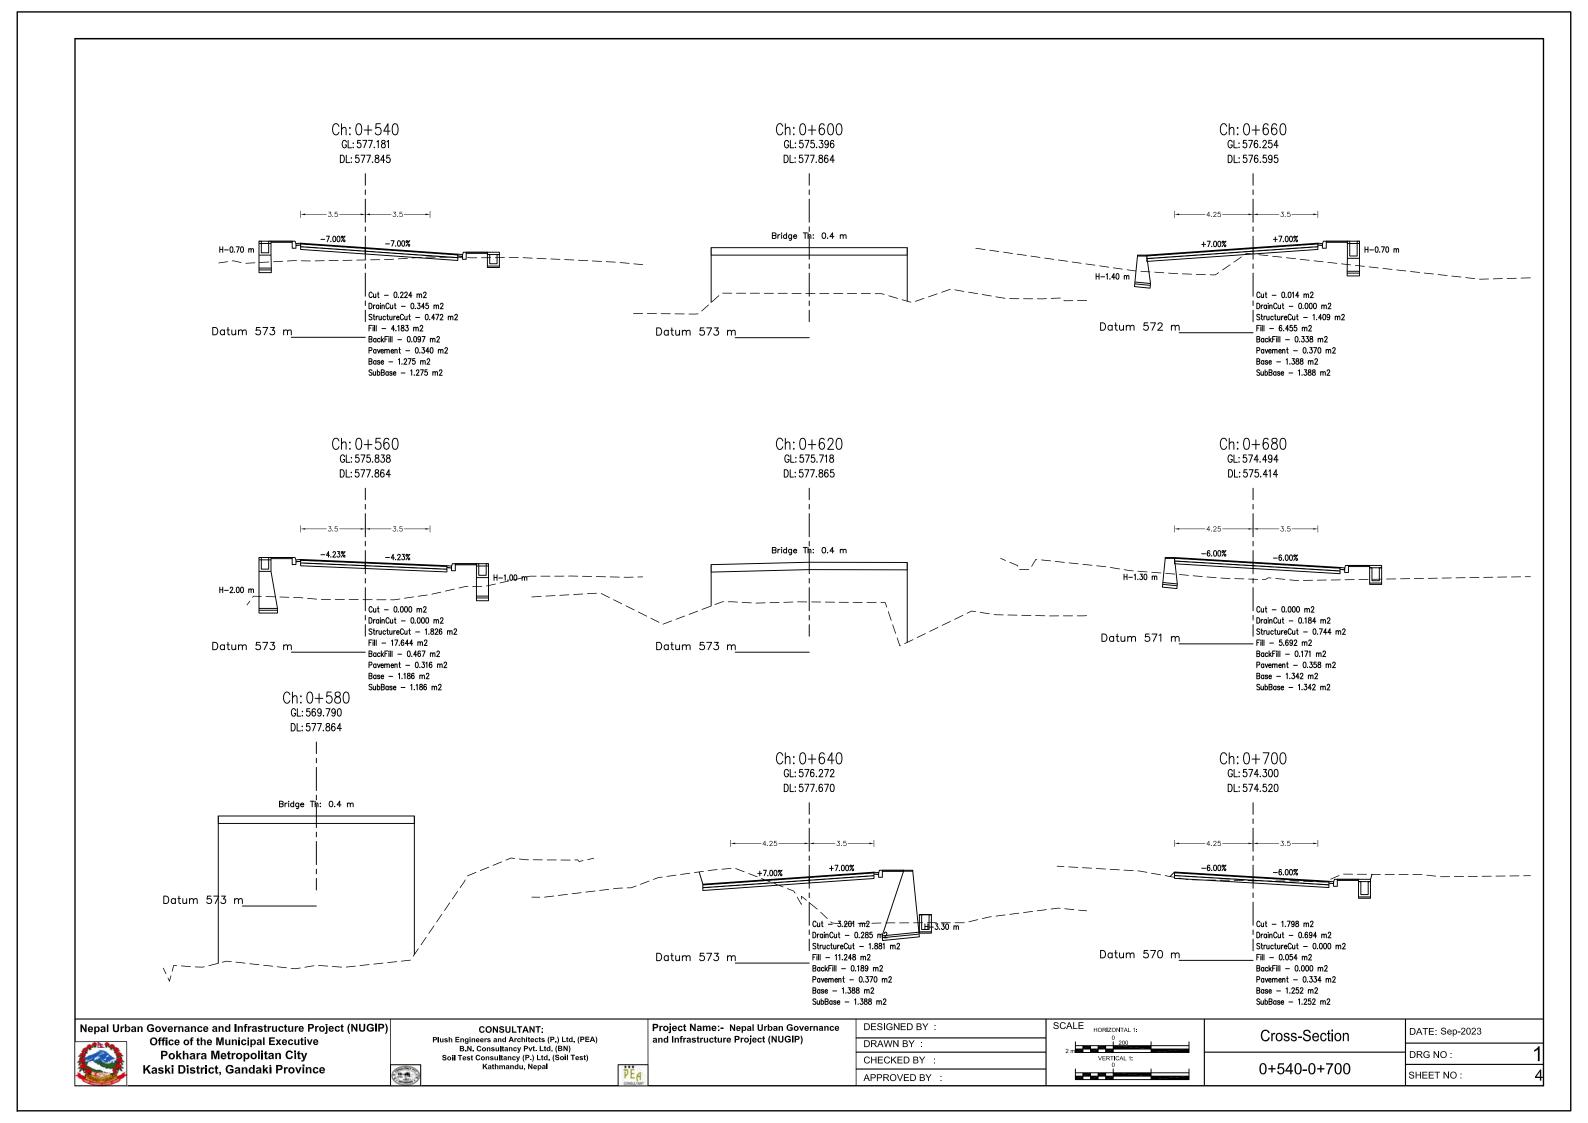
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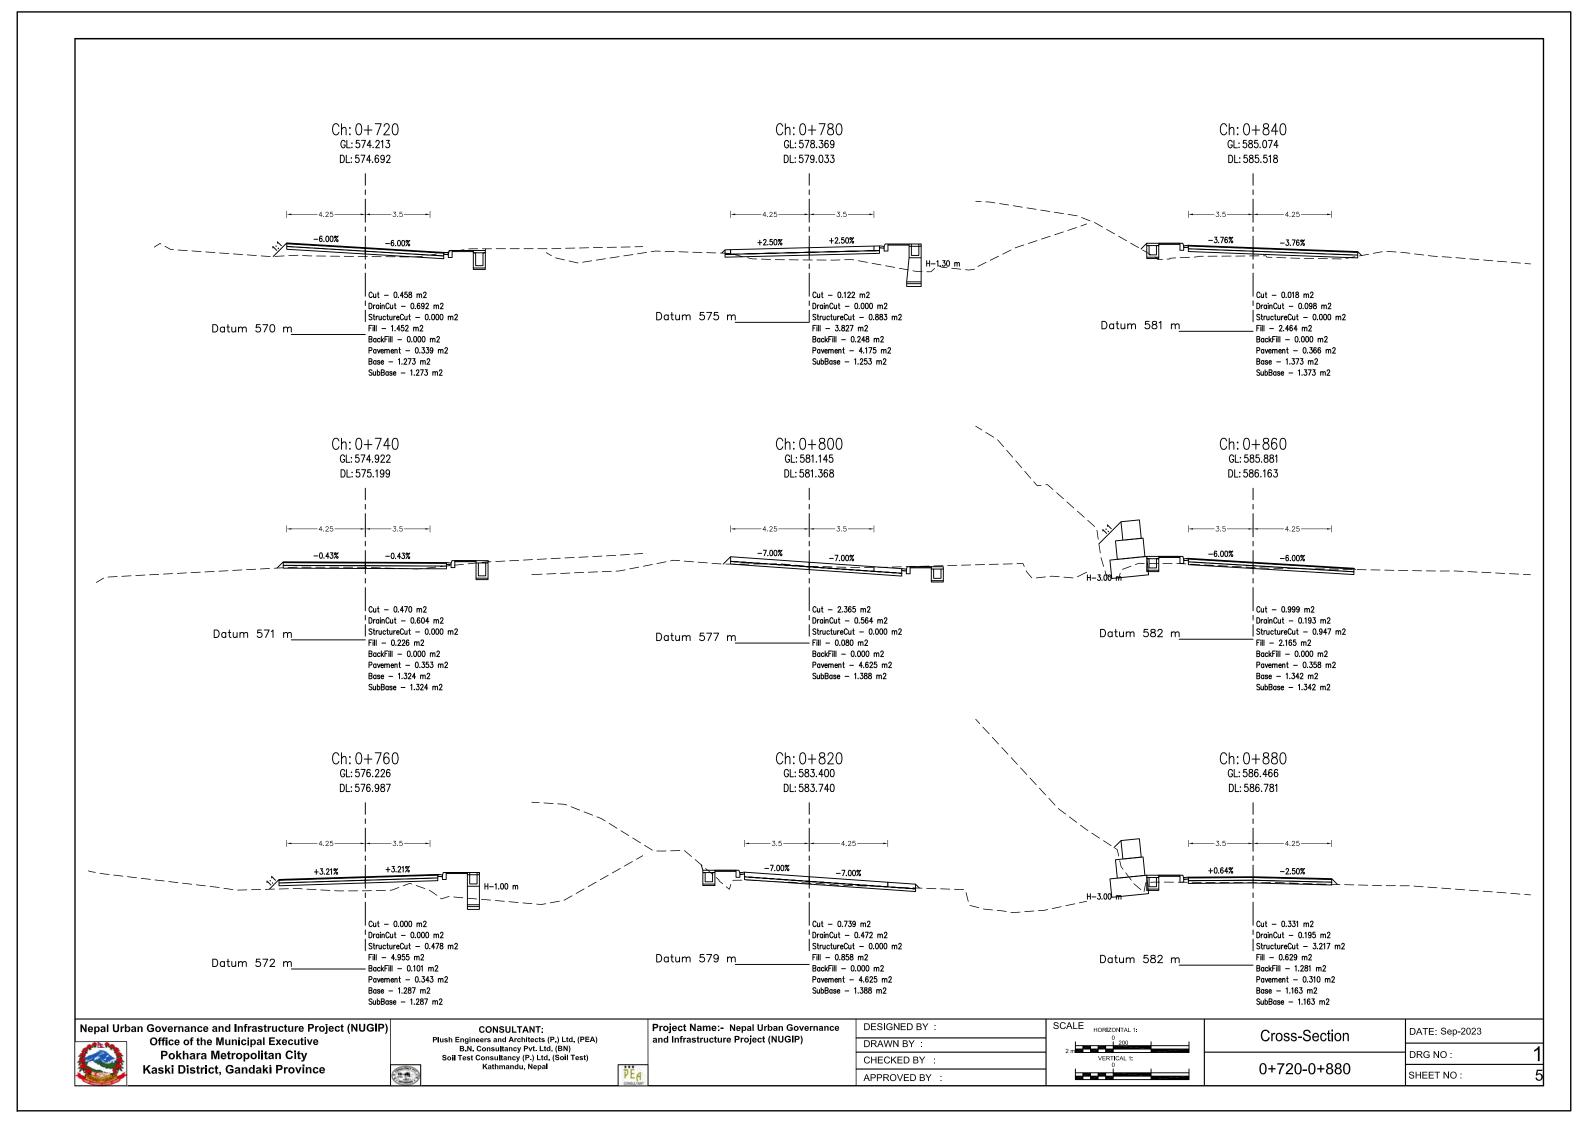
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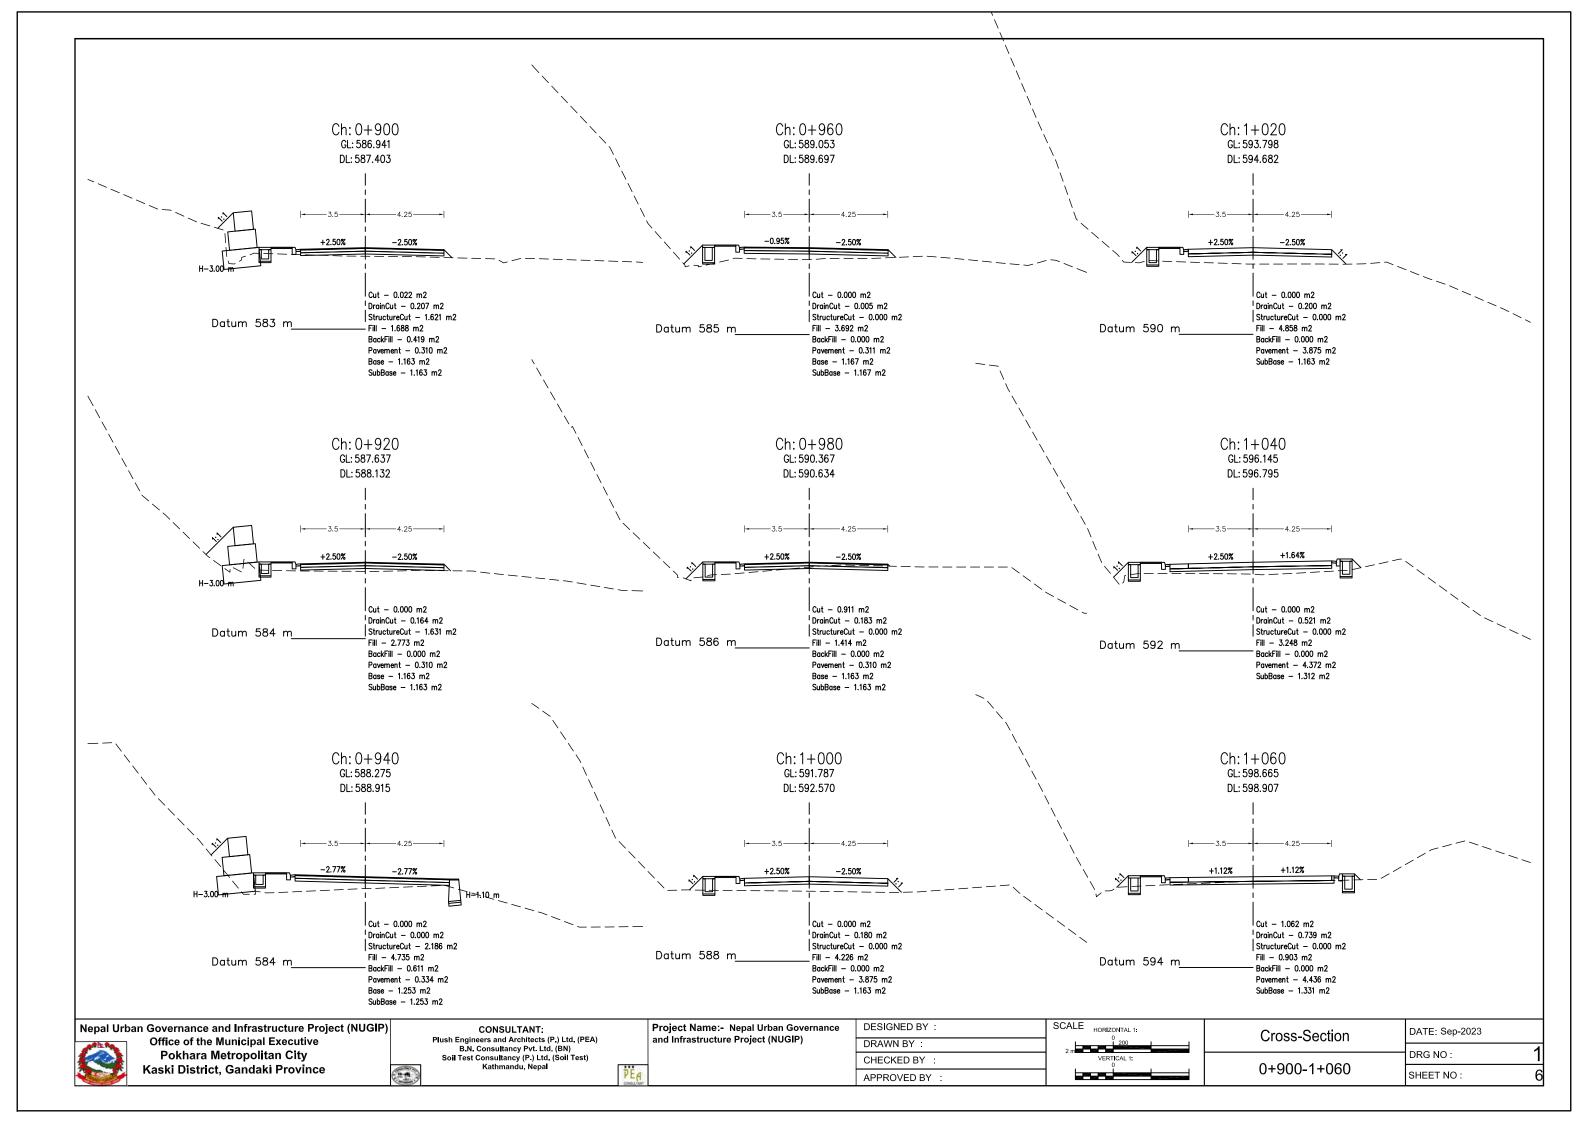











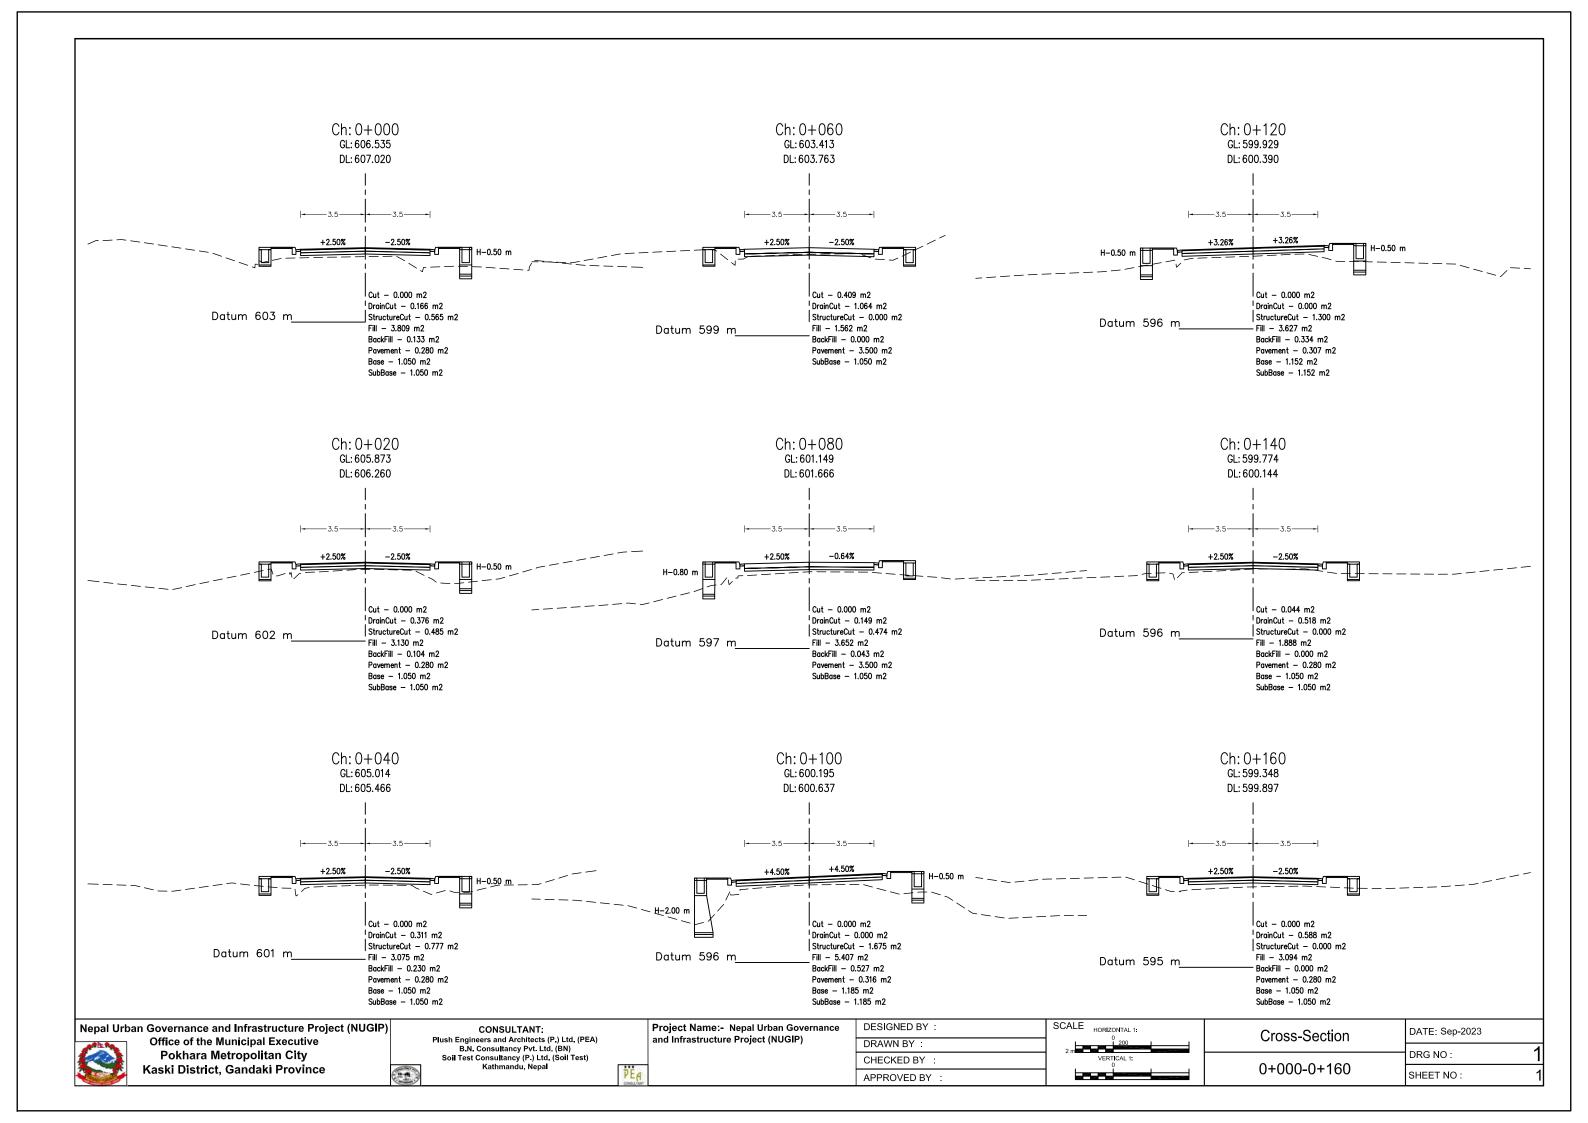


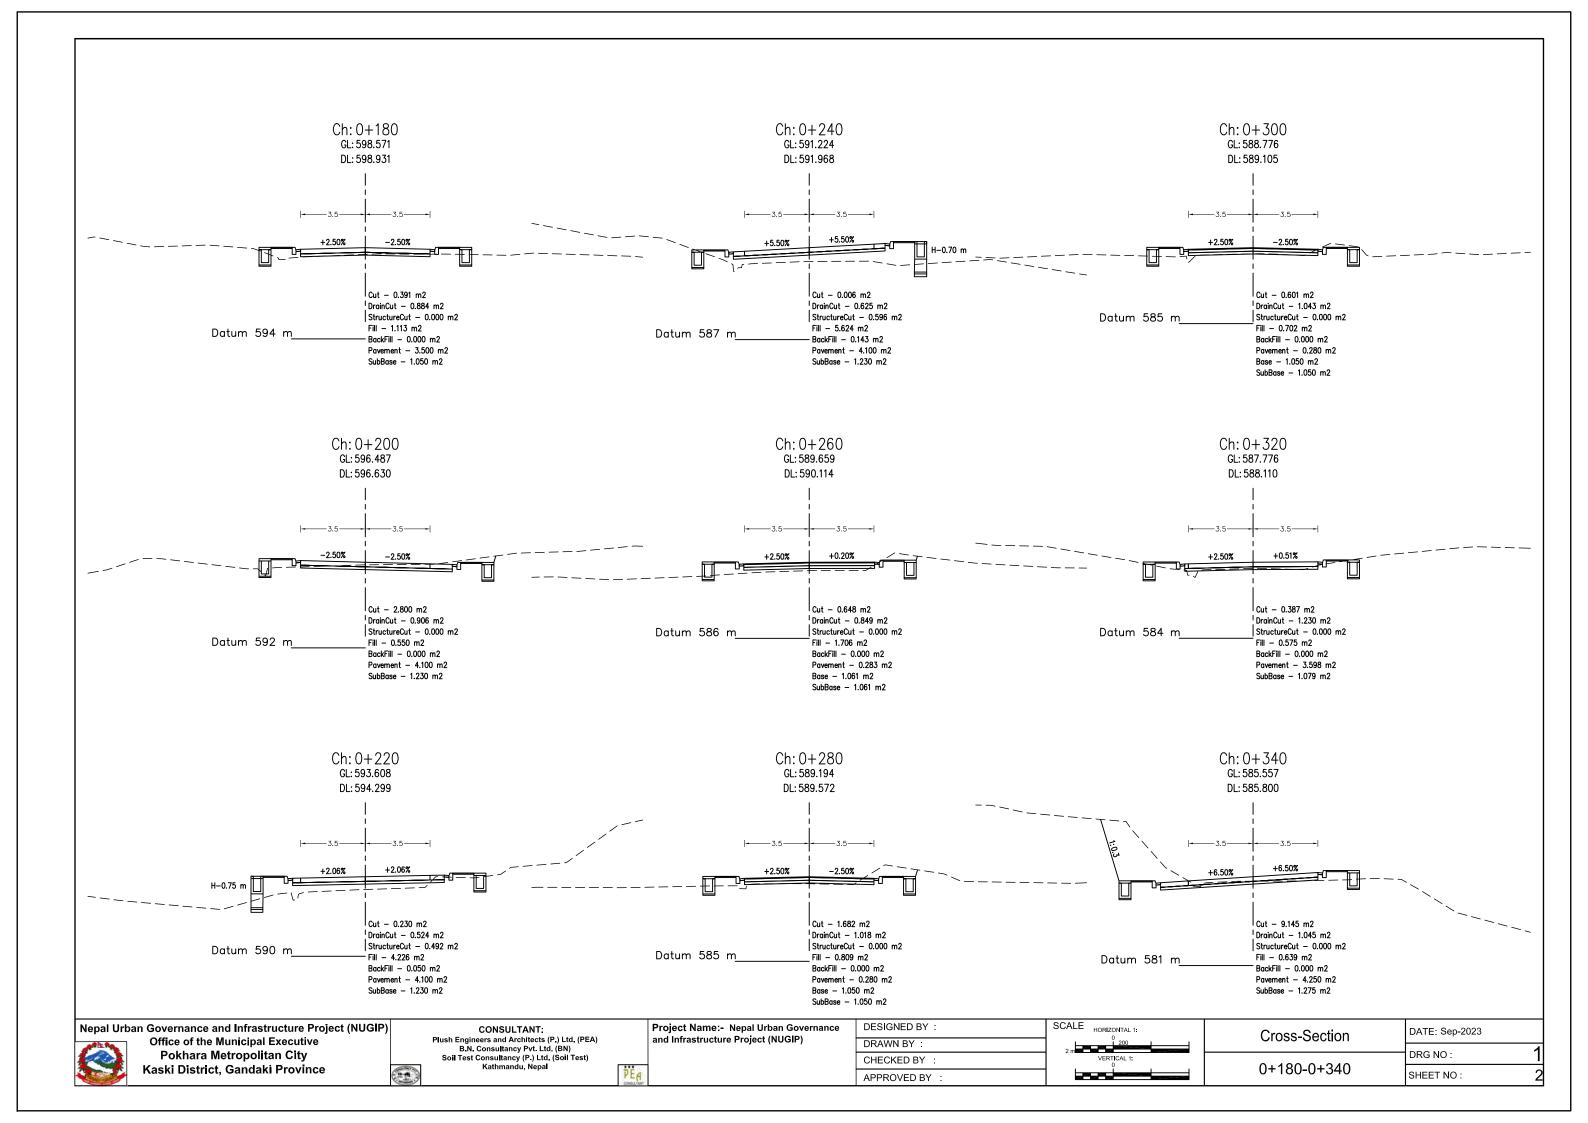


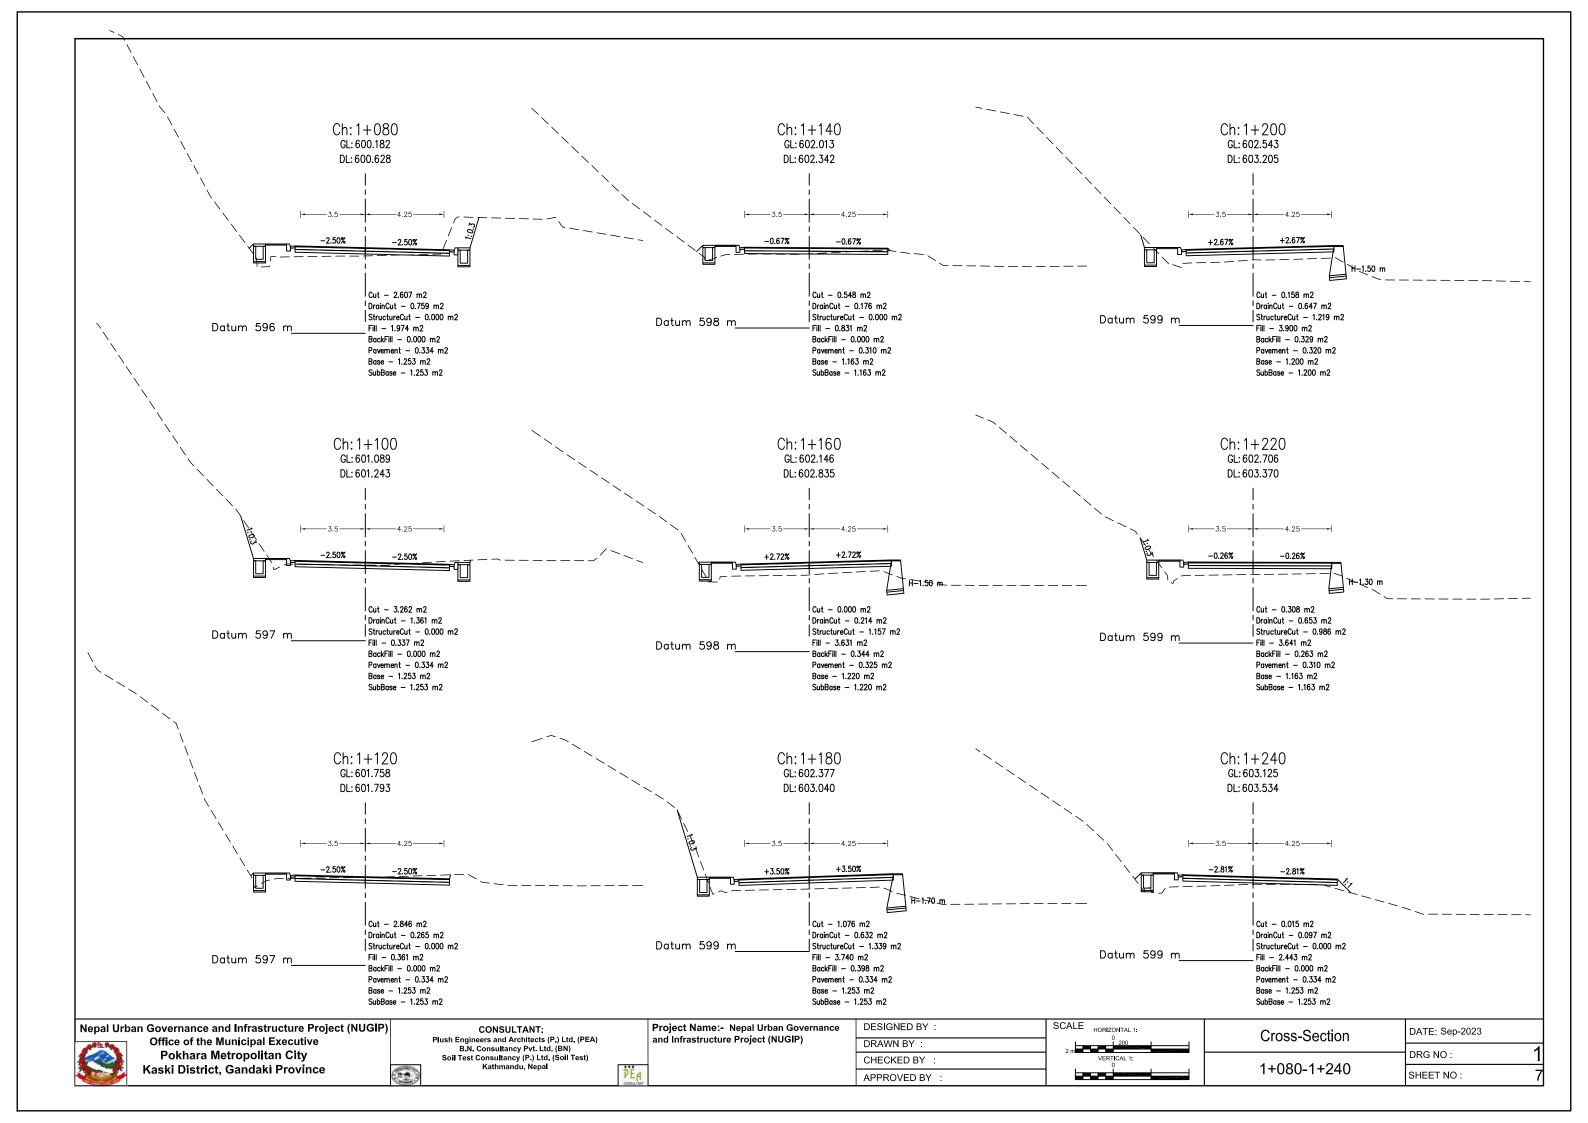


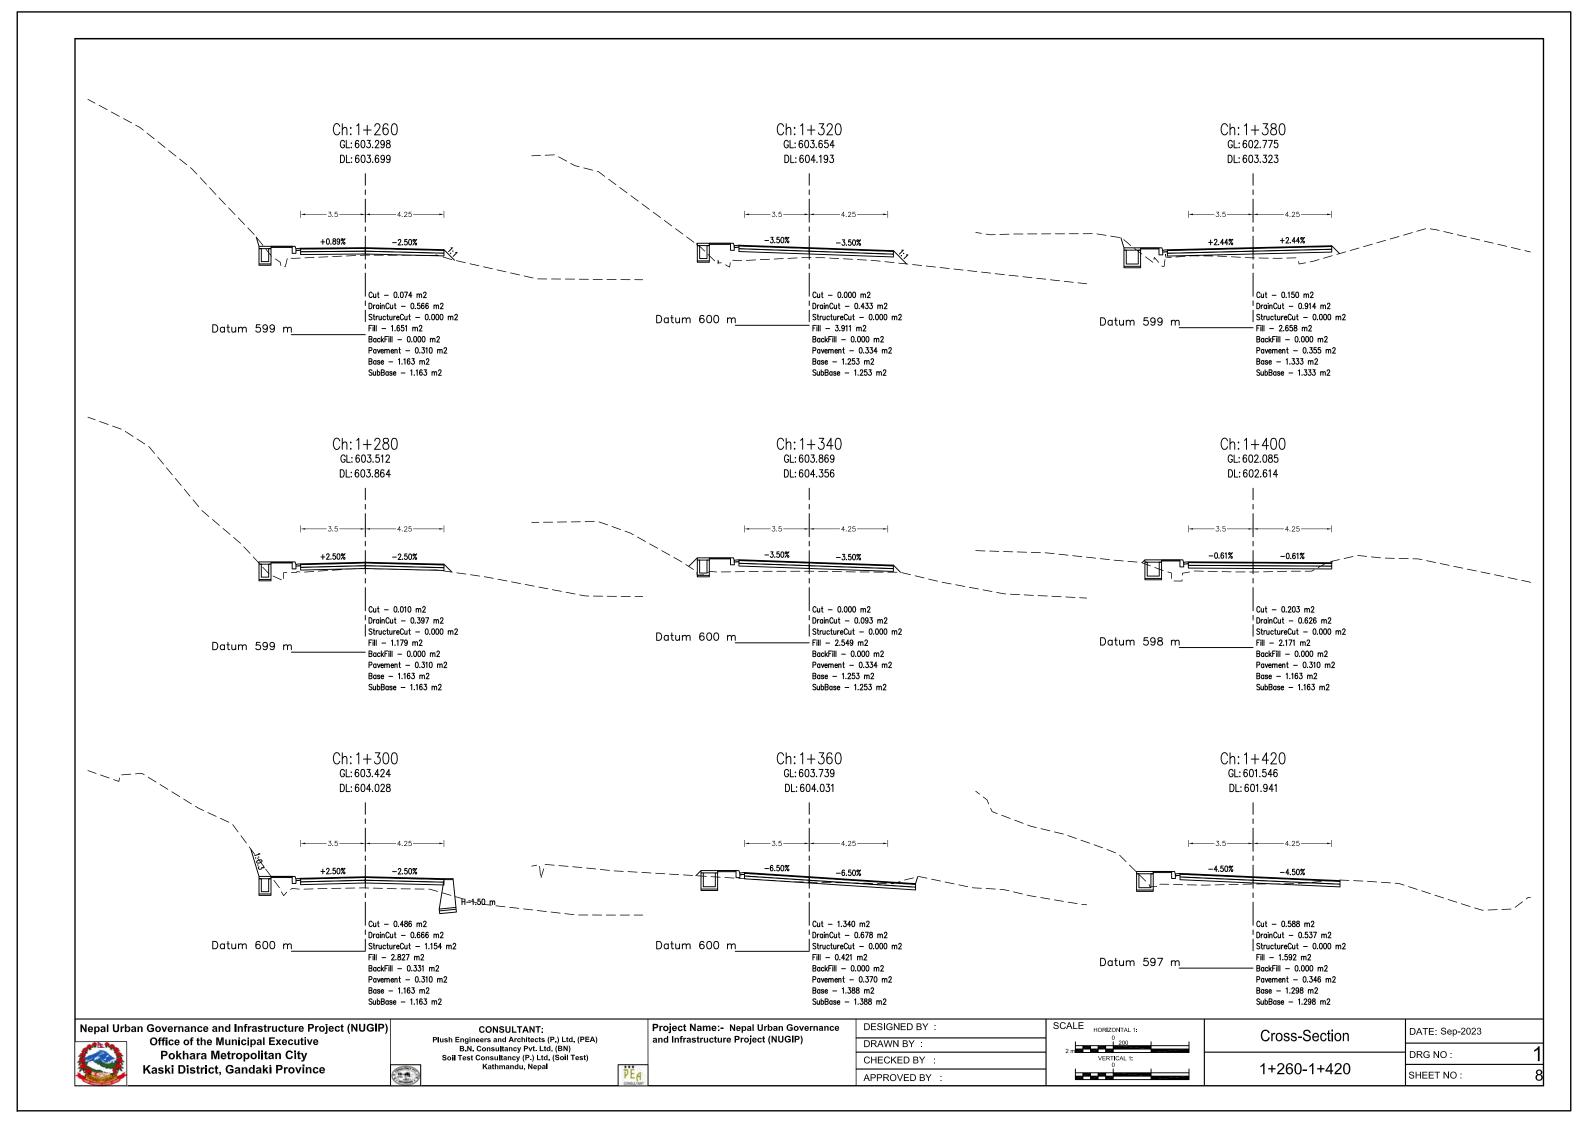


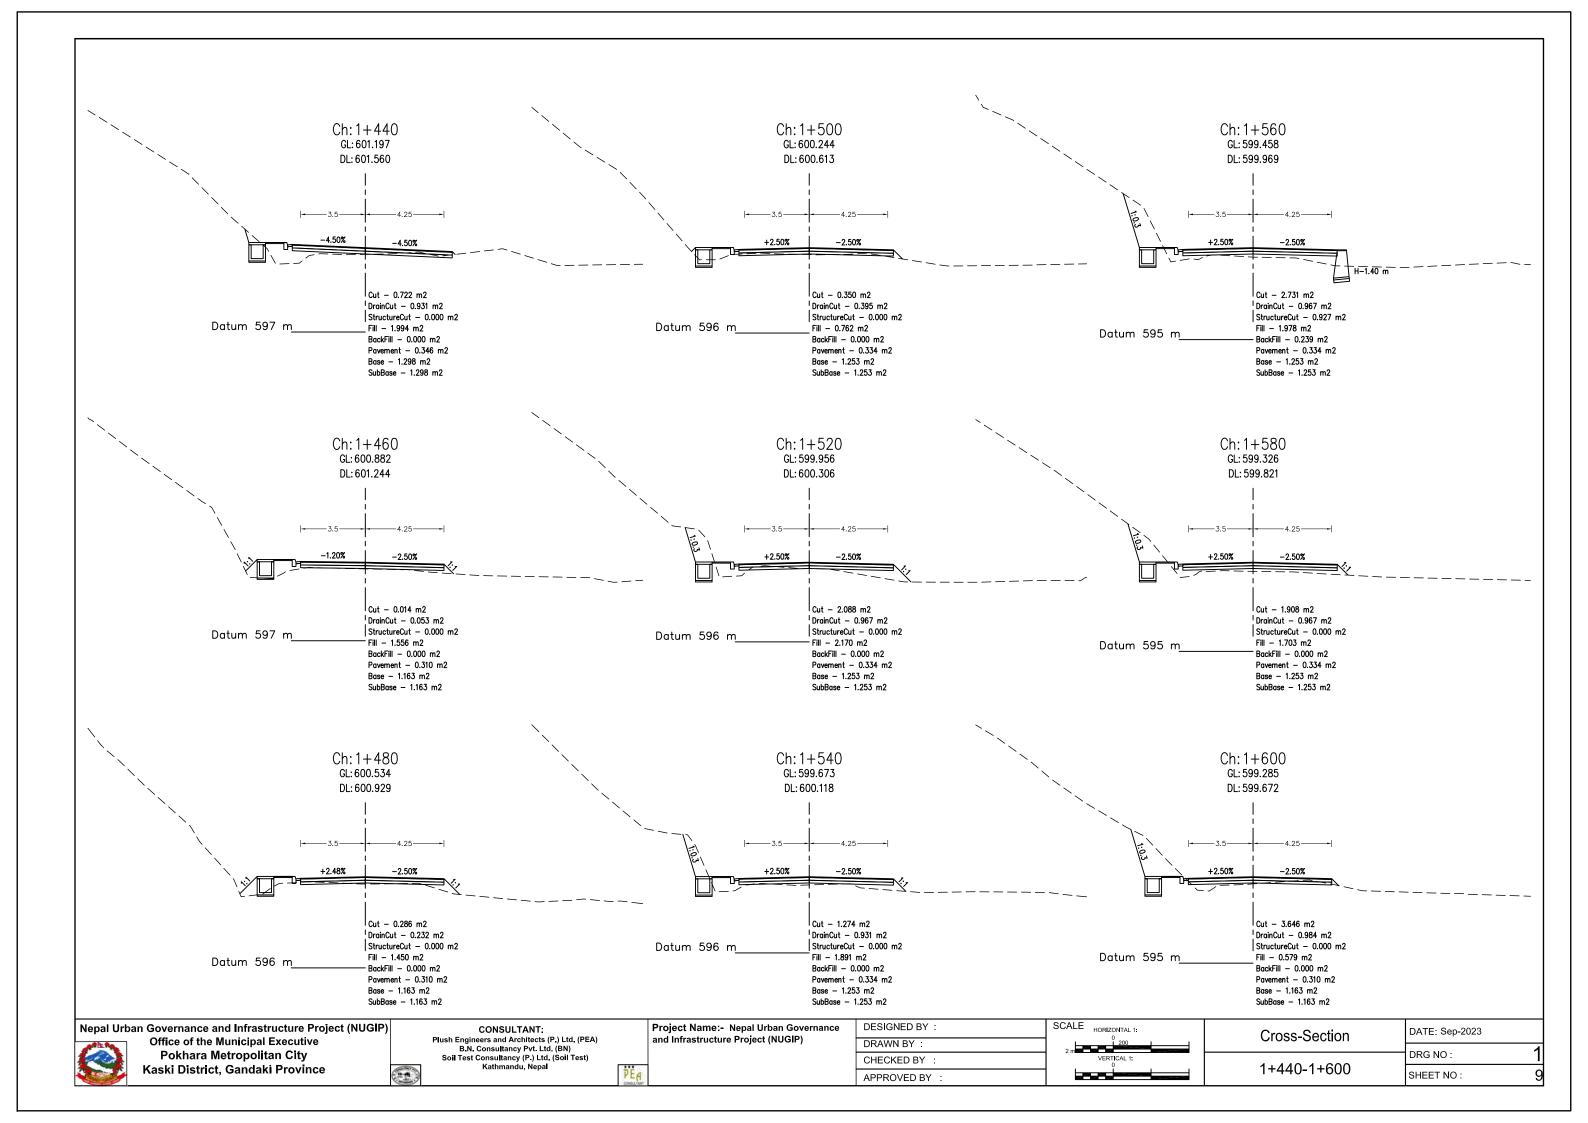


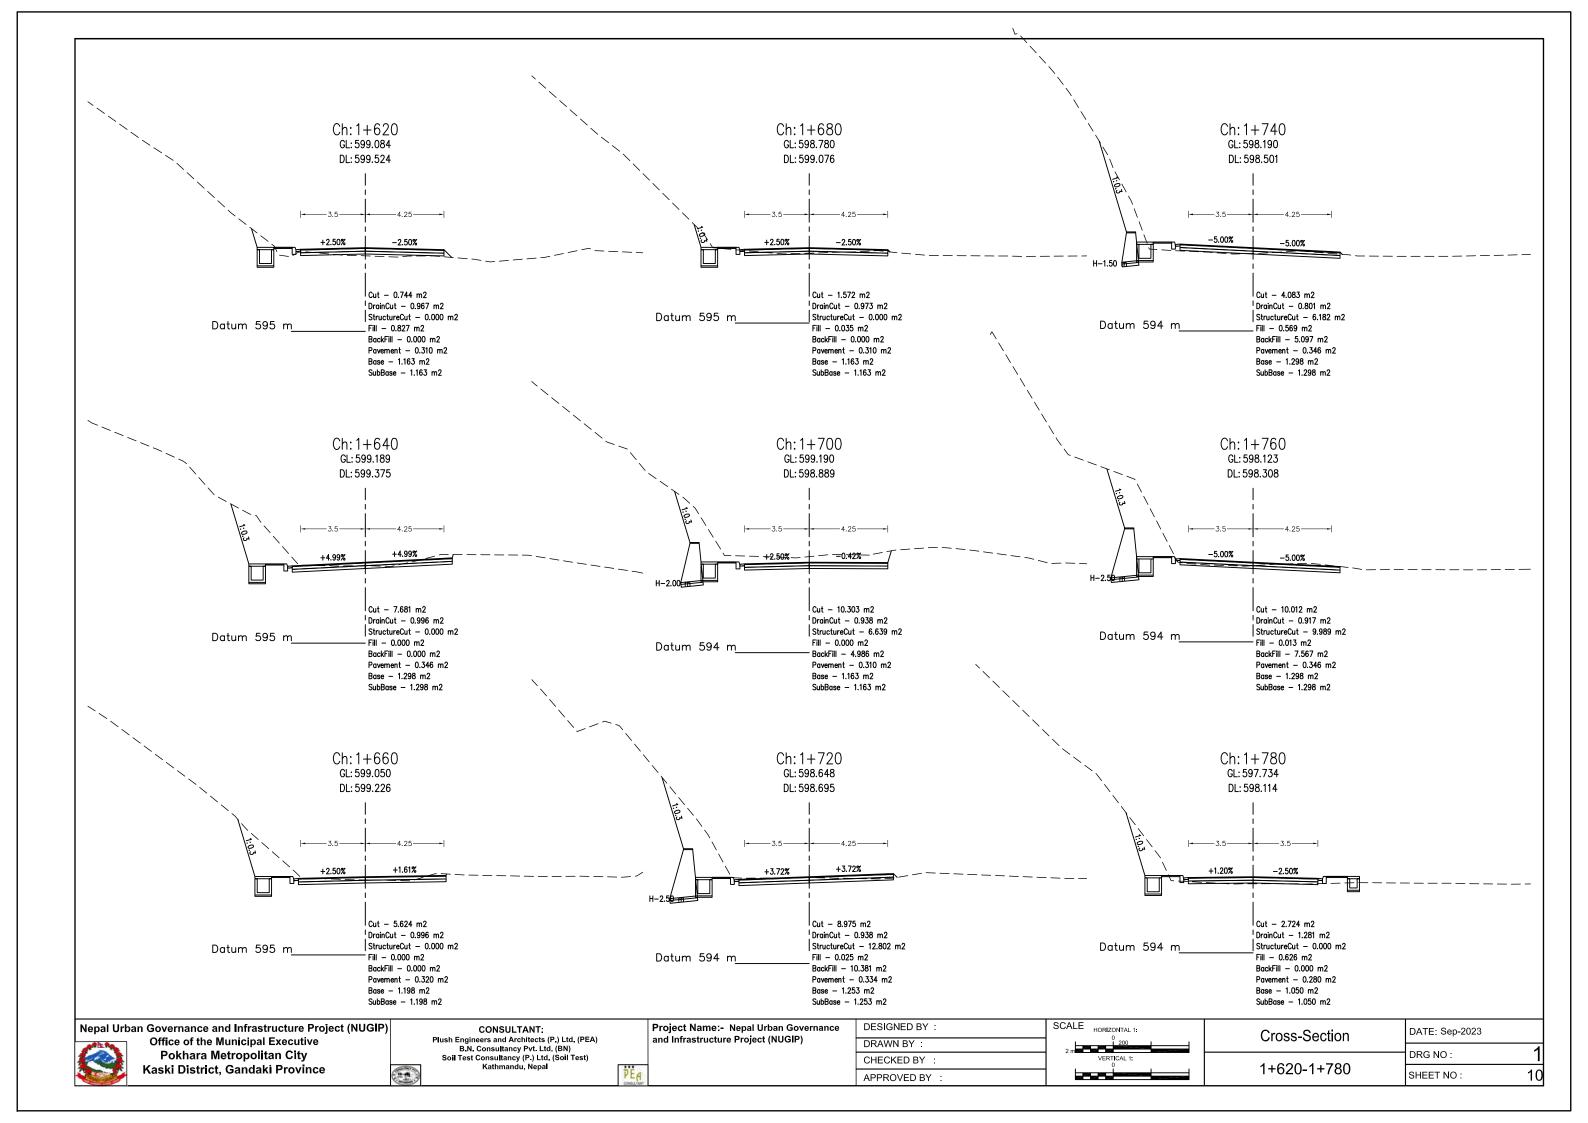


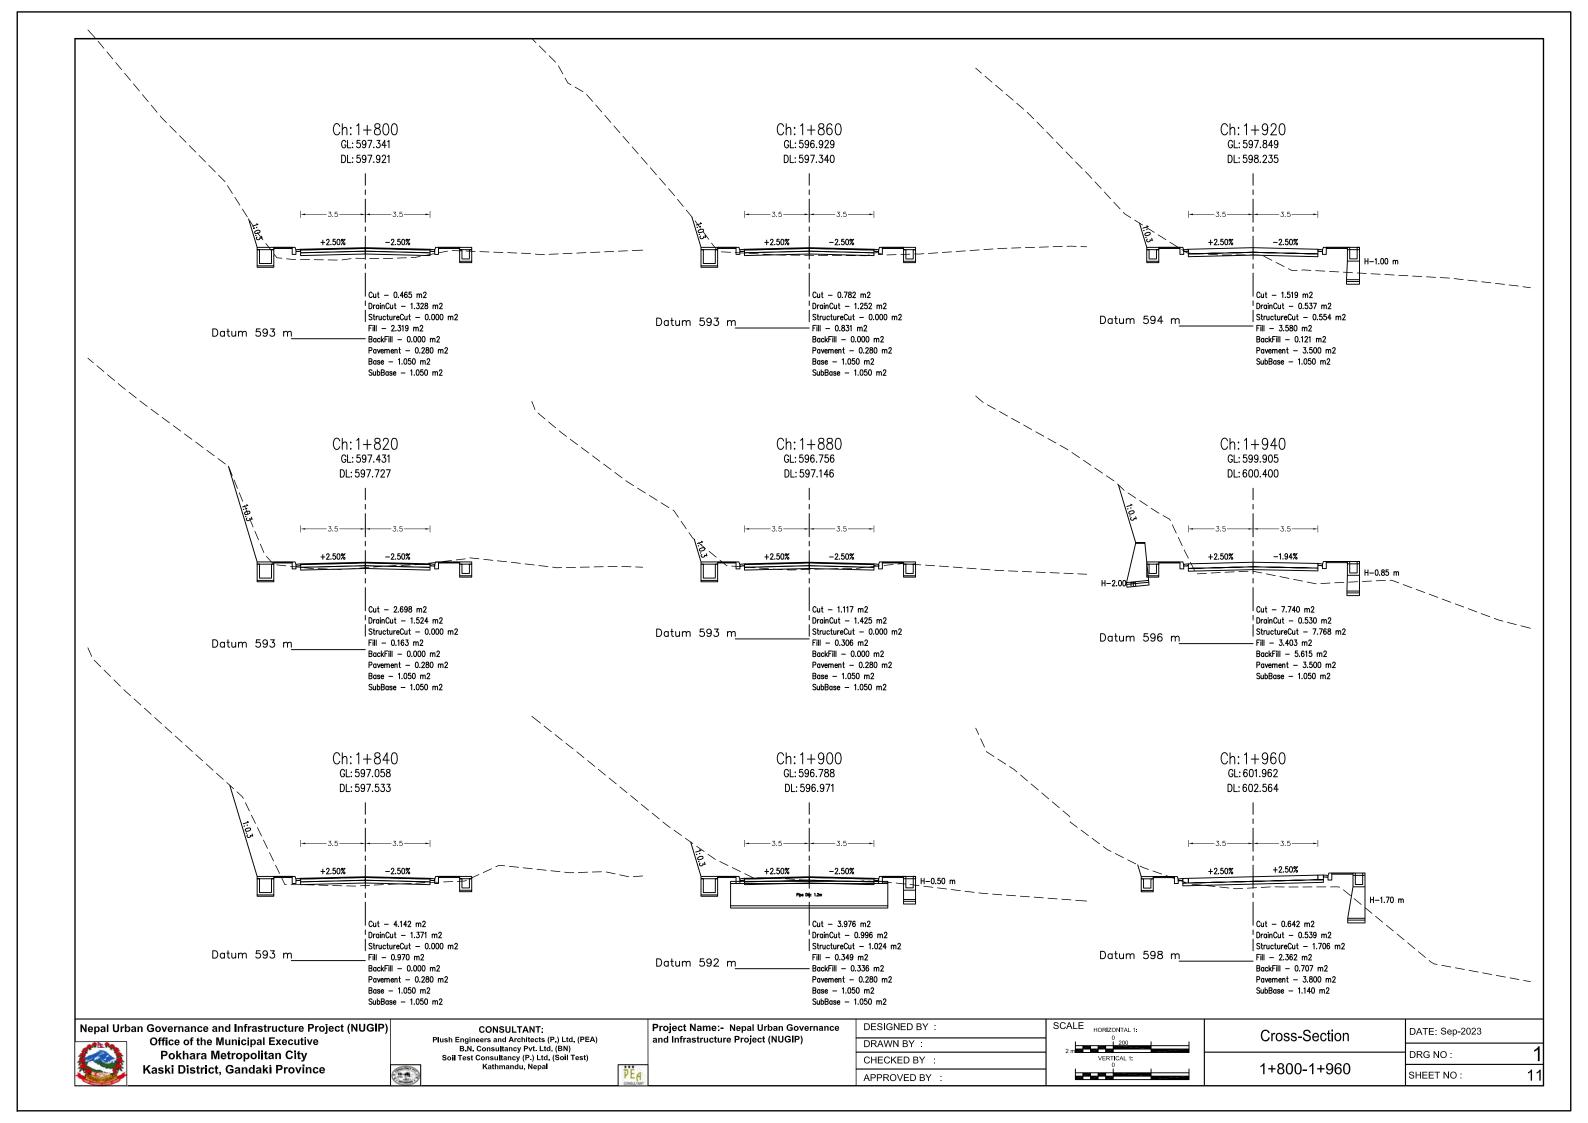


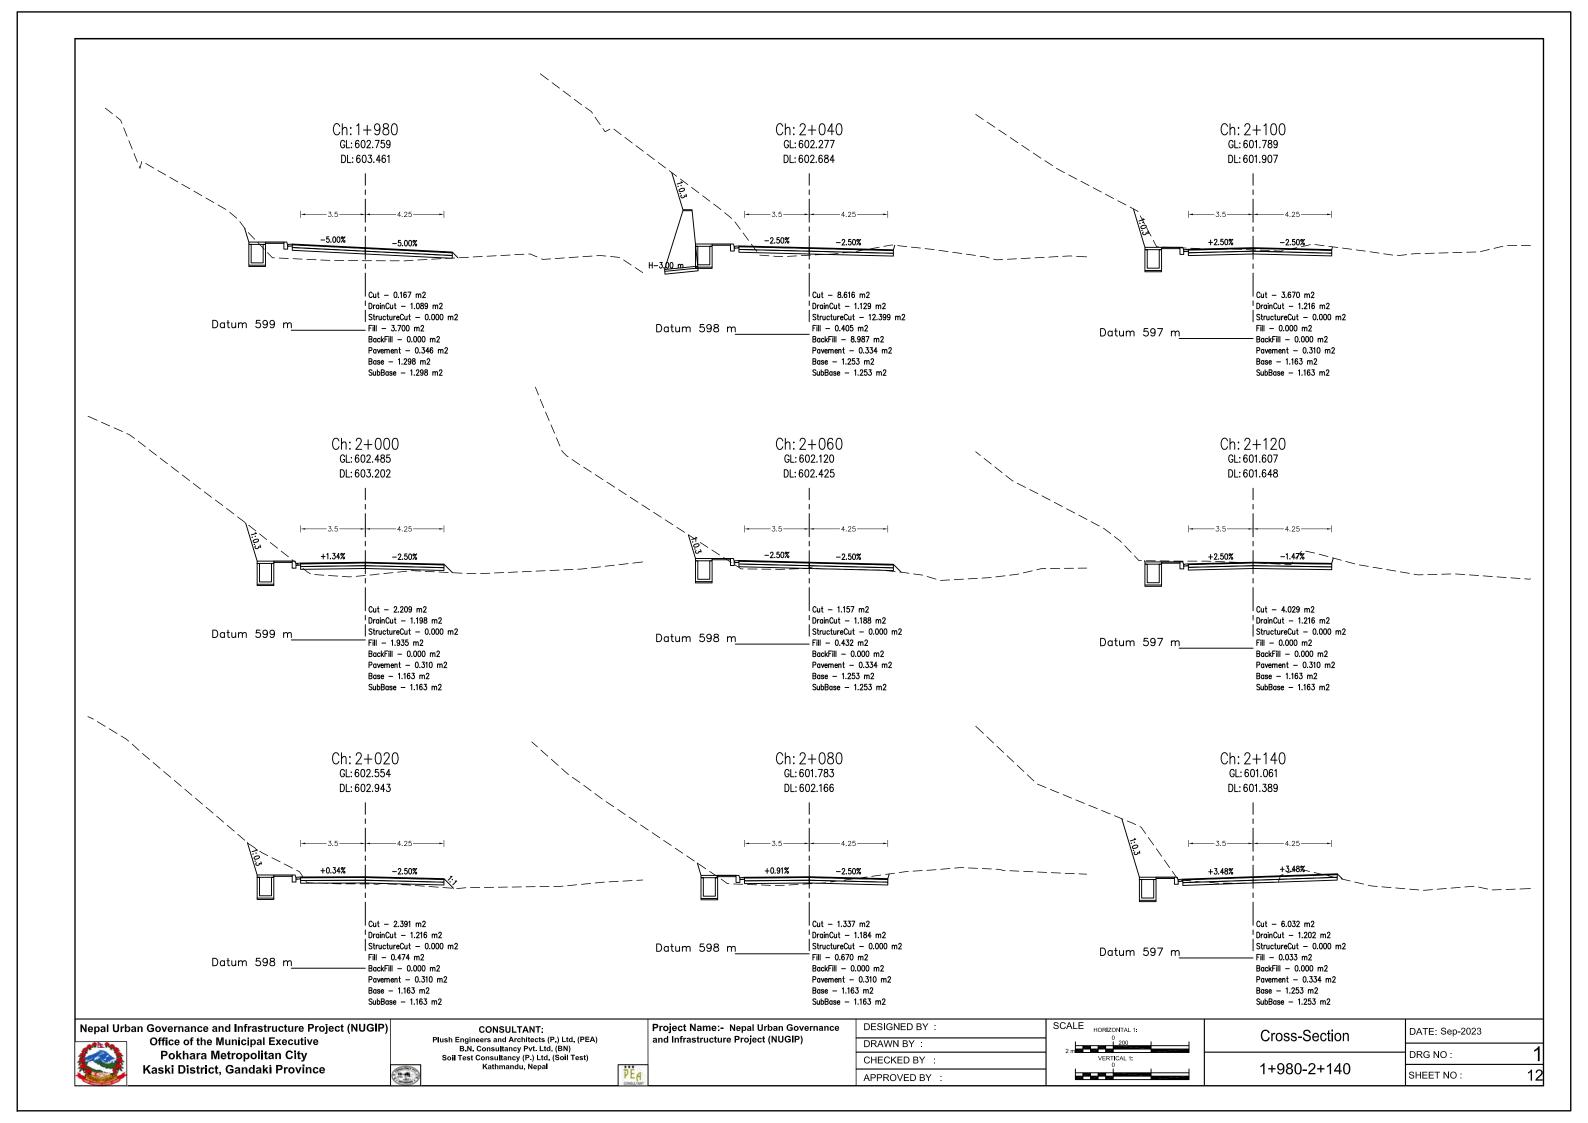


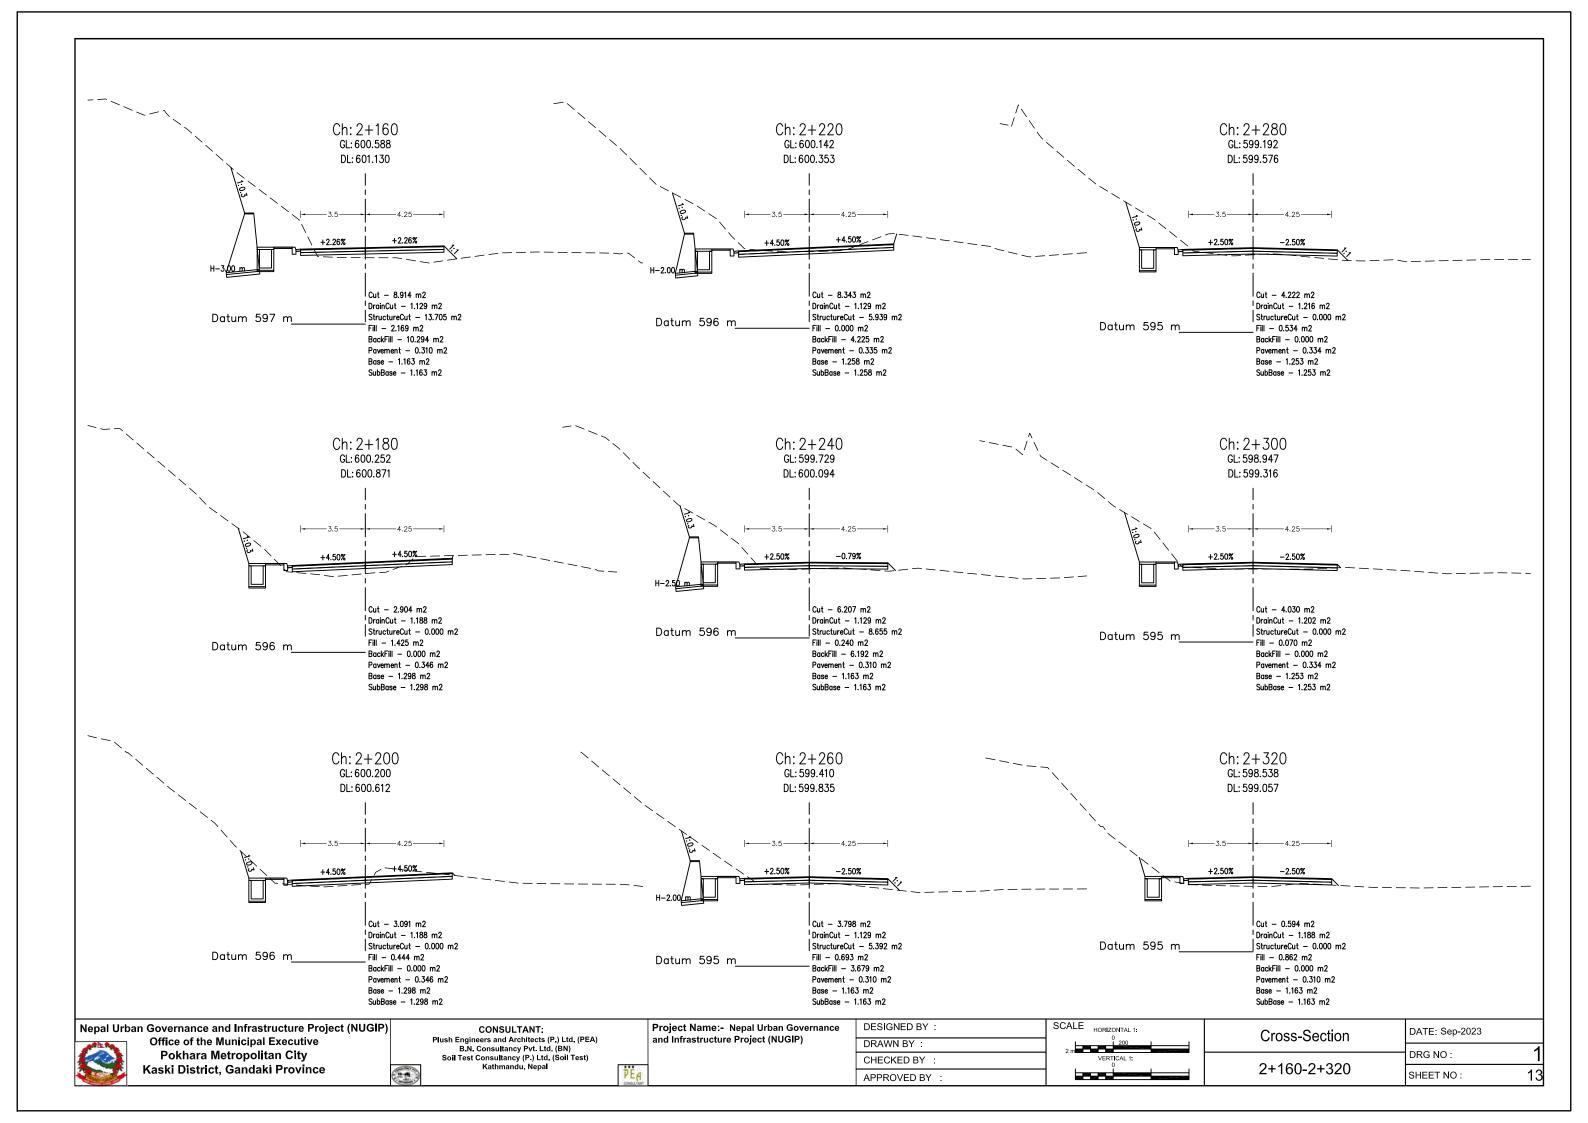


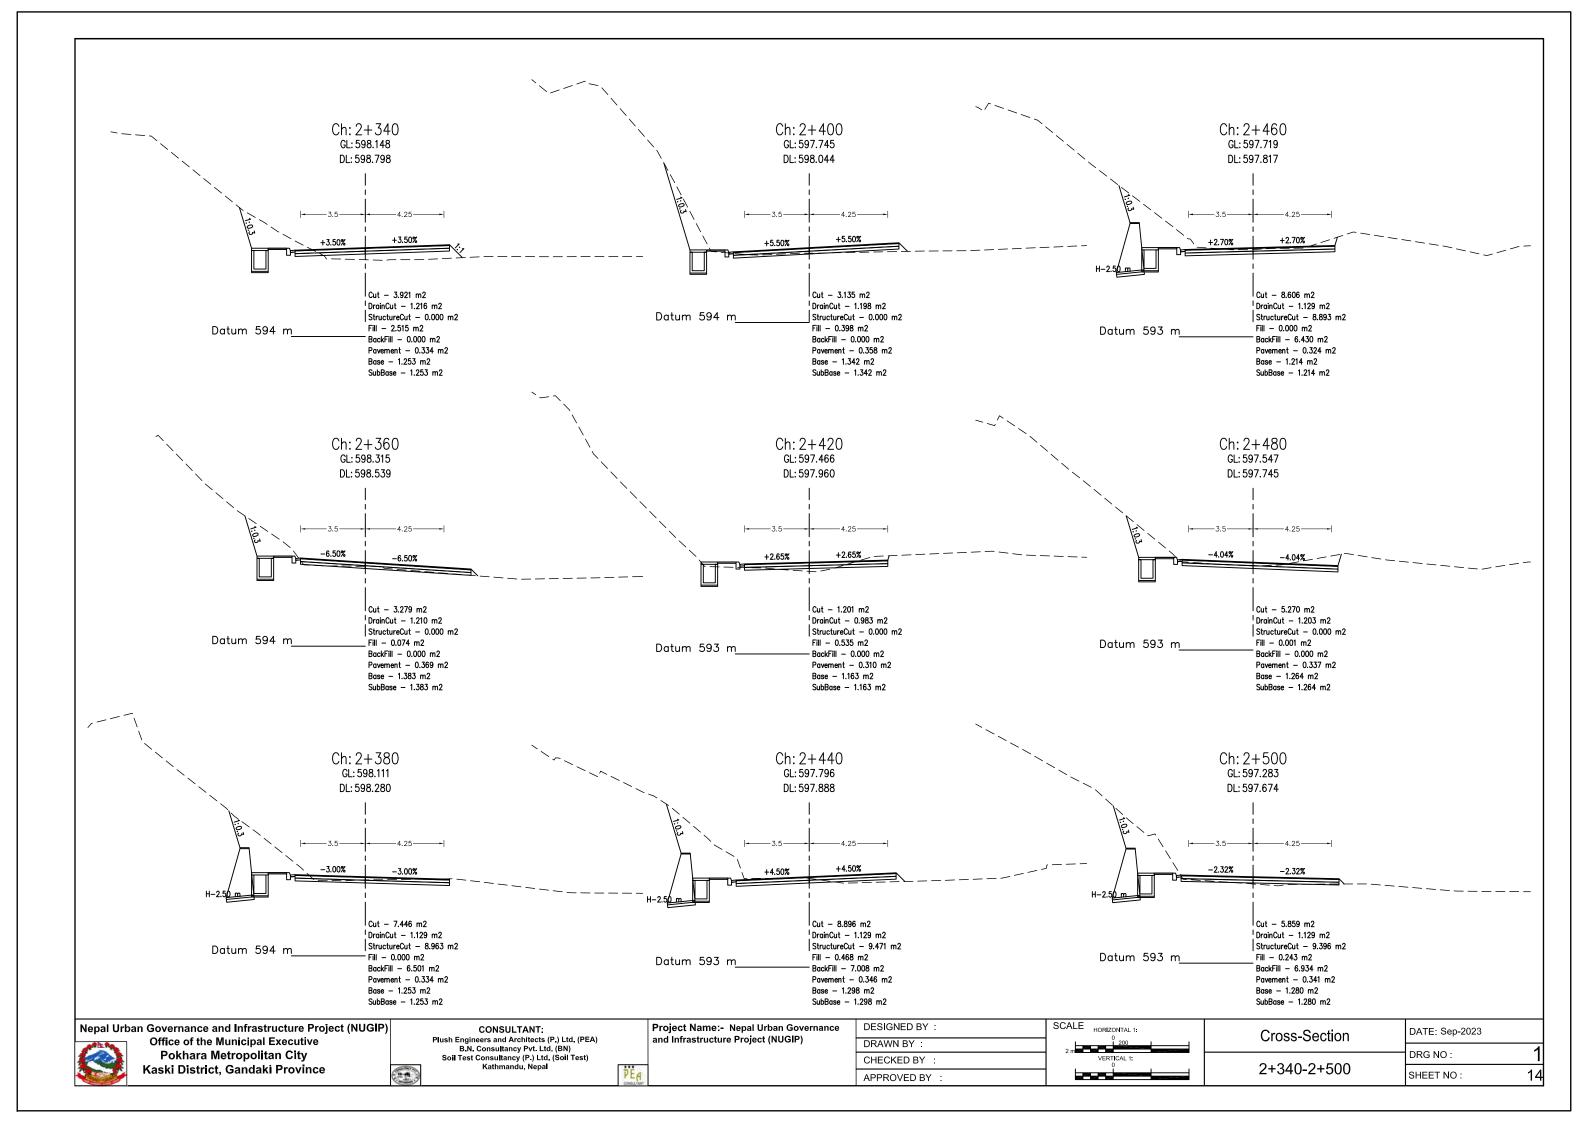


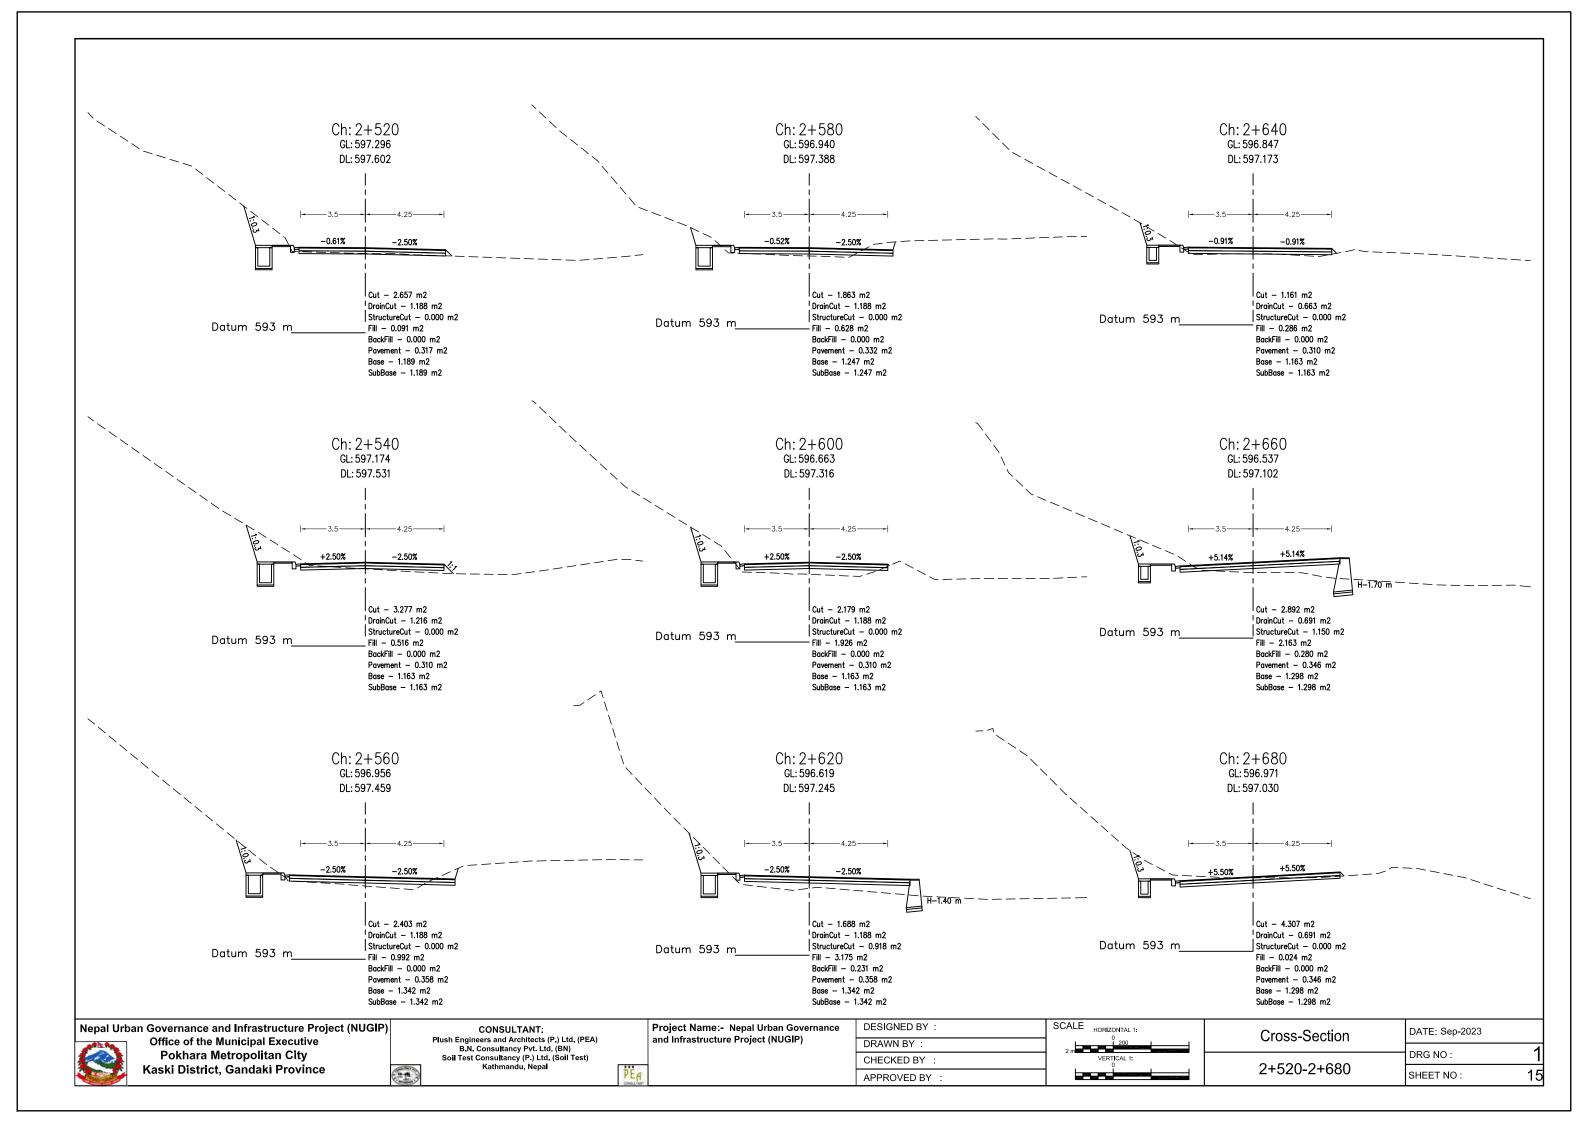


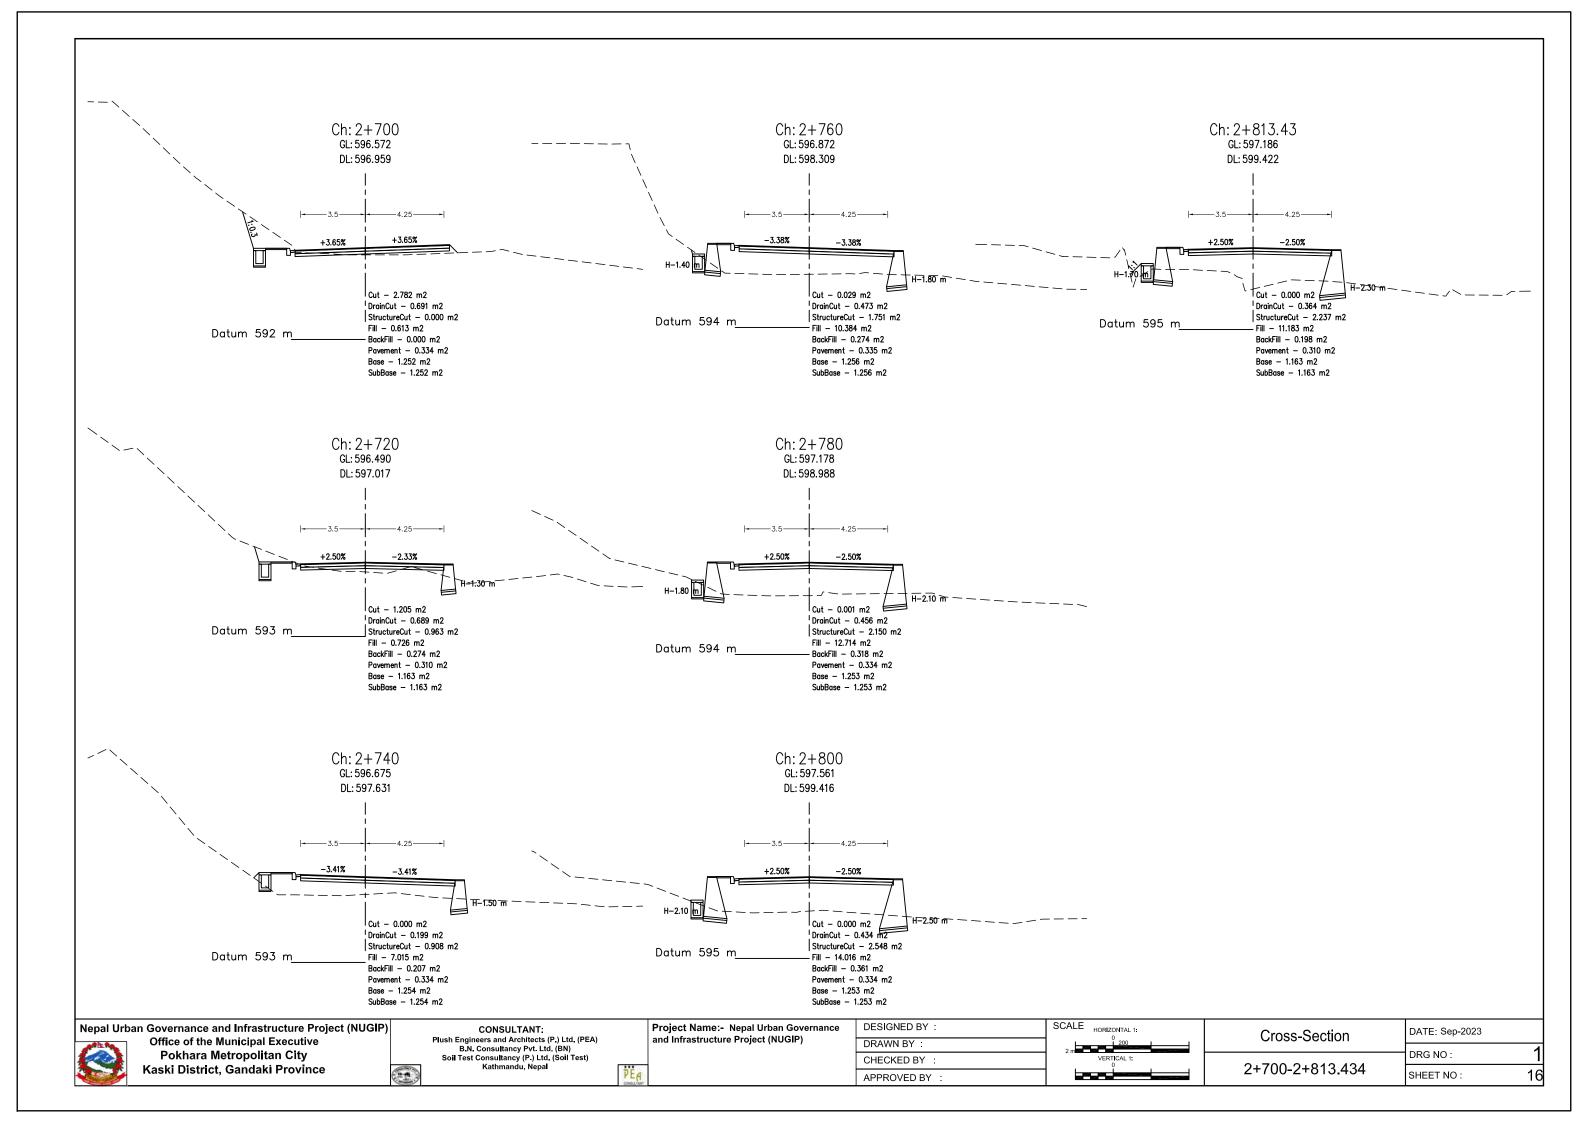


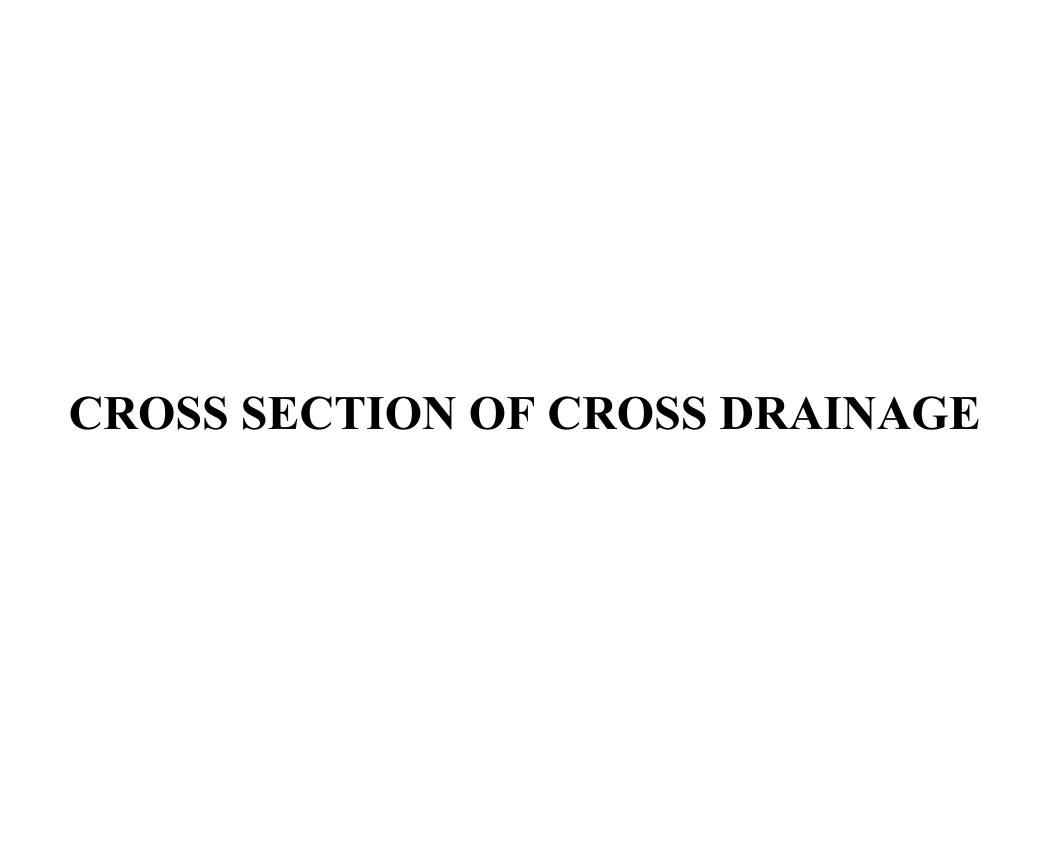


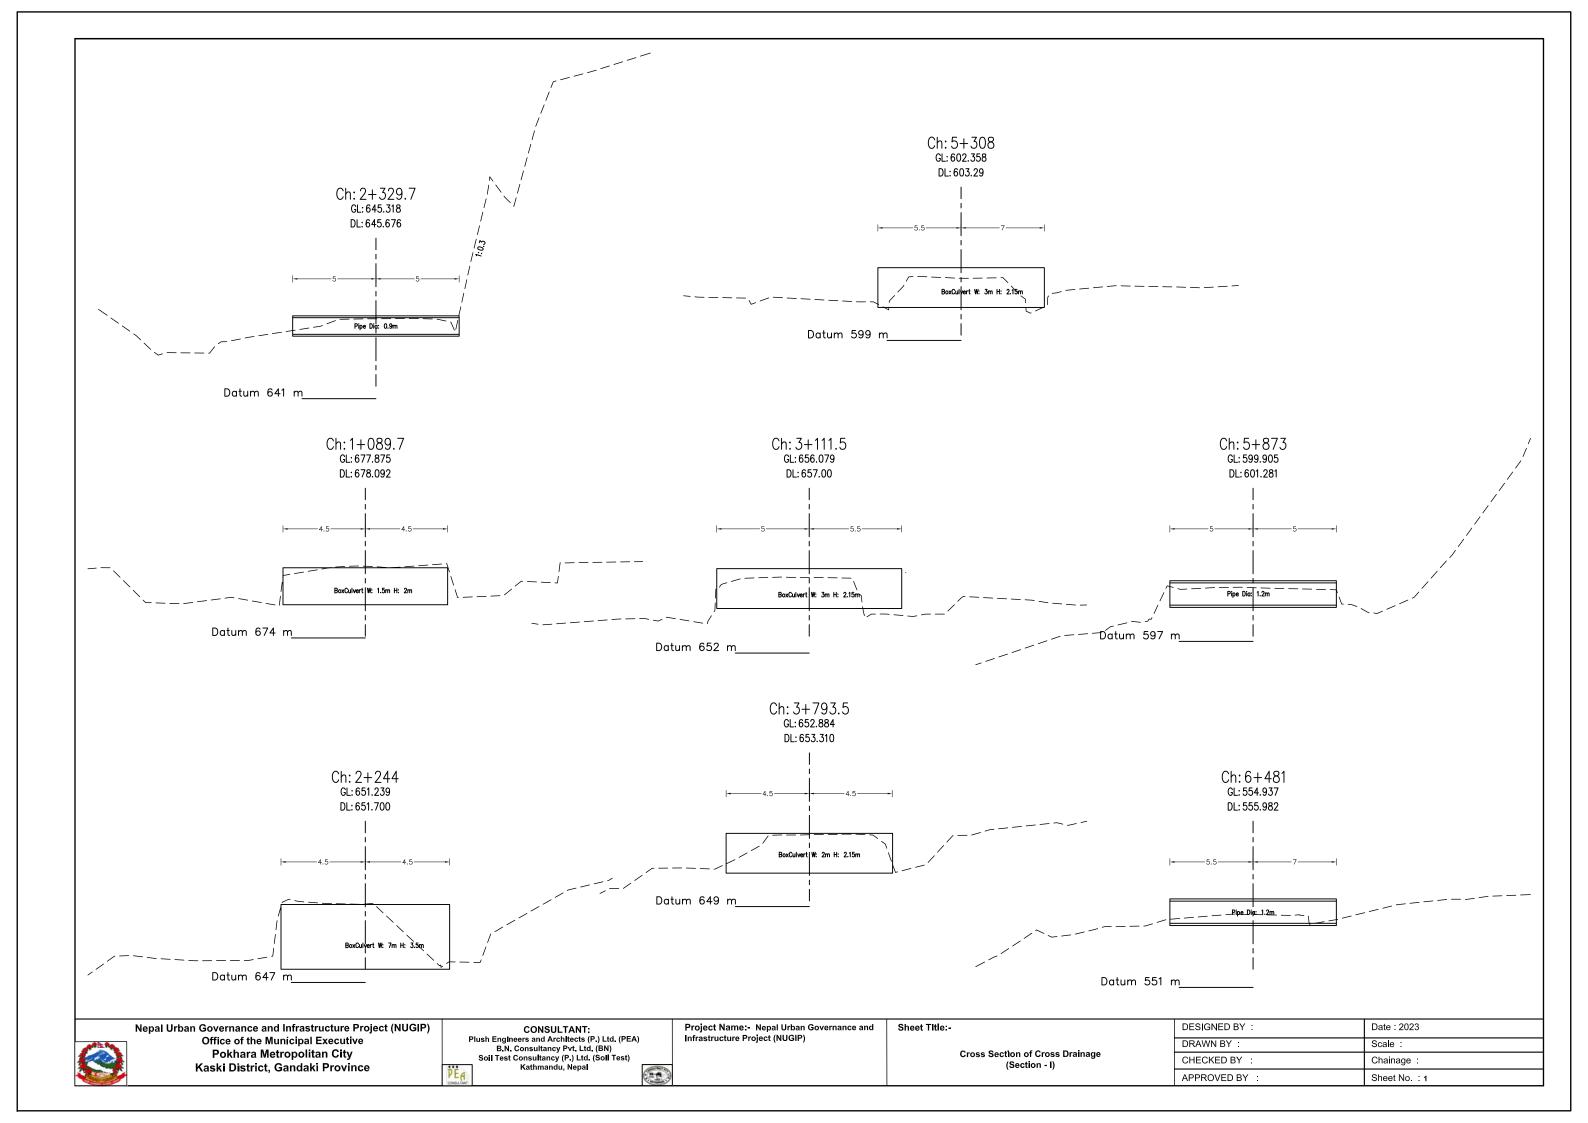

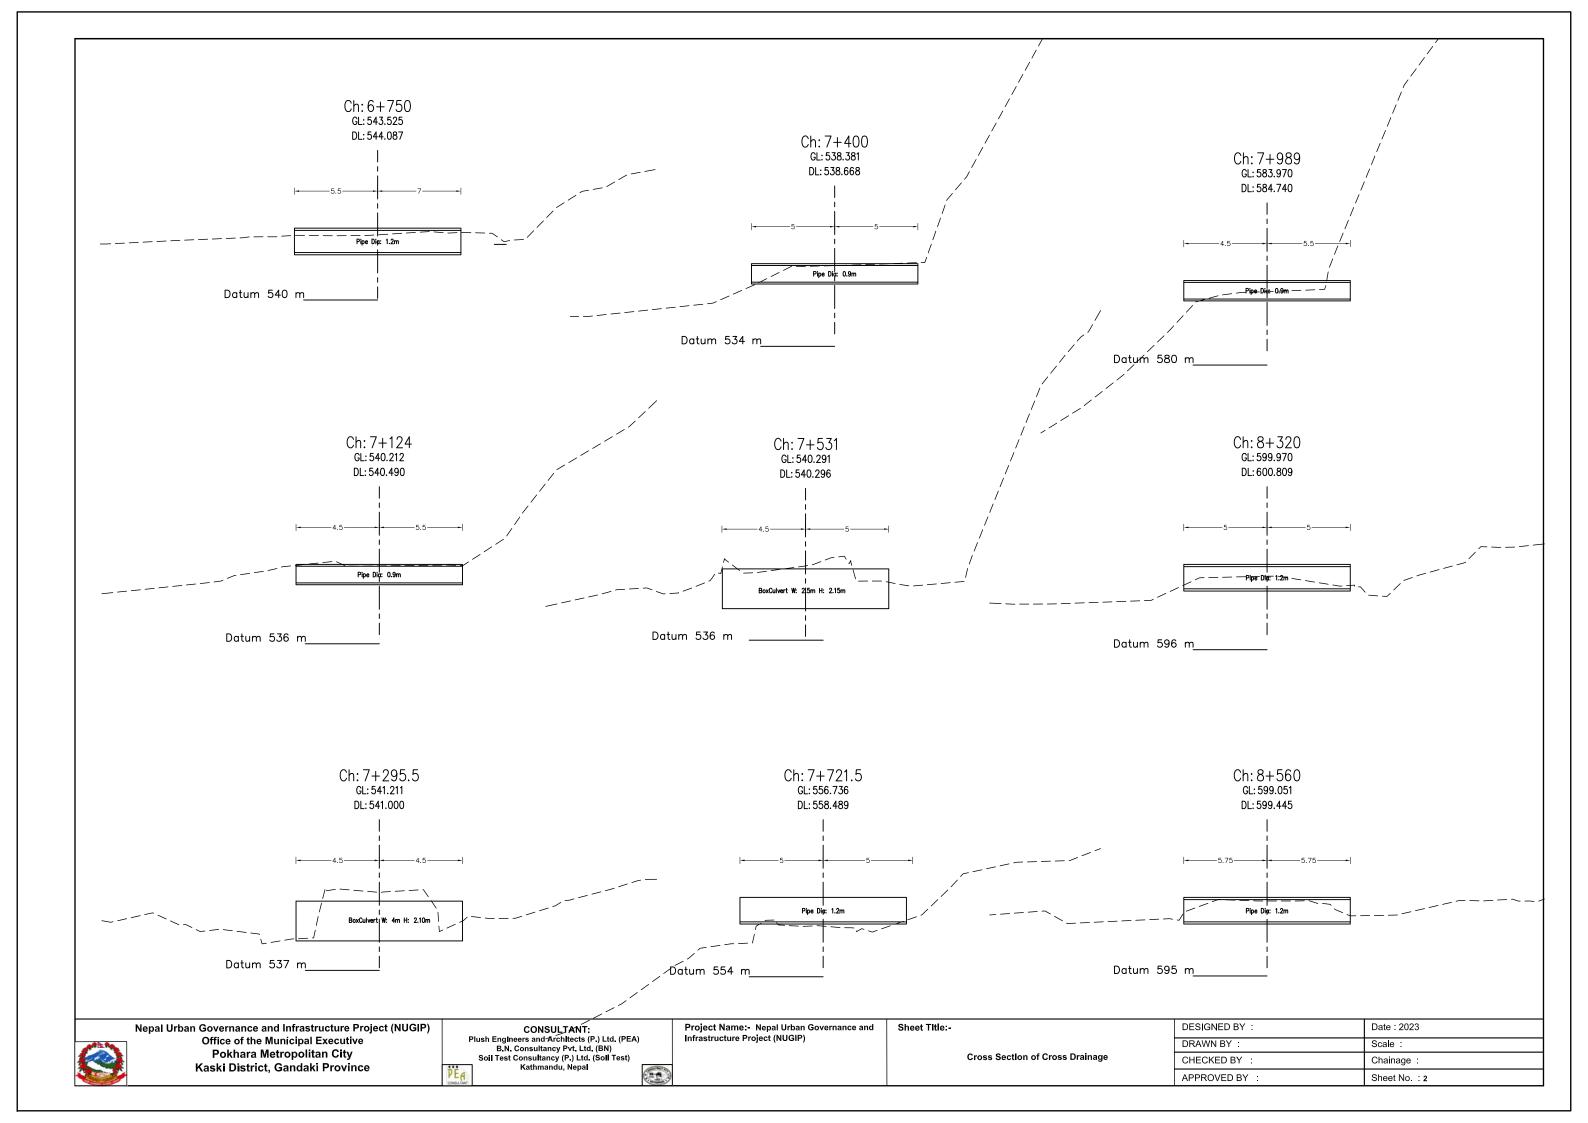

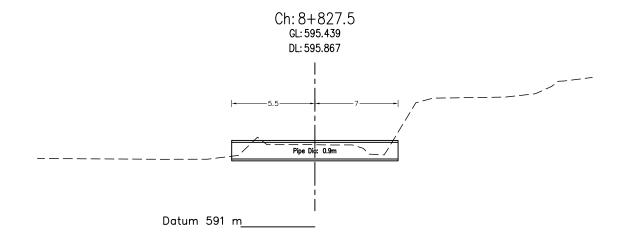

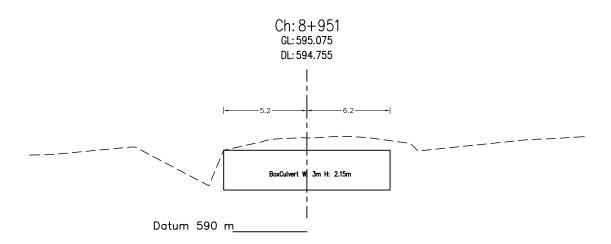

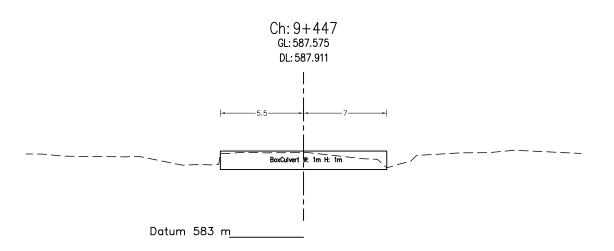



Nepal Urban Governance and Infrastructure Project (NUGIP)
Office of the Municipal Executive
Pokhara Metropolitan City
Kaski District, Gandaki Province

CONSULTANT:
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B.N. Consultancy Pvt. Ltd. (BN)
Soil Test Consultancy (P.) Ltd. (Soil Test)
Kathmandu, Nepal


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Project Name:- Nepal Urban Governance and Infrastructure Project (NUGIP)


Sheet Title:-

Cross Section of Cross Drainage

DESIGNED BY:	Date : 2023
DRAWN BY:	Scale:
CHECKED BY :	Chainage:
APPROVED BY :	Sheet No.: 3

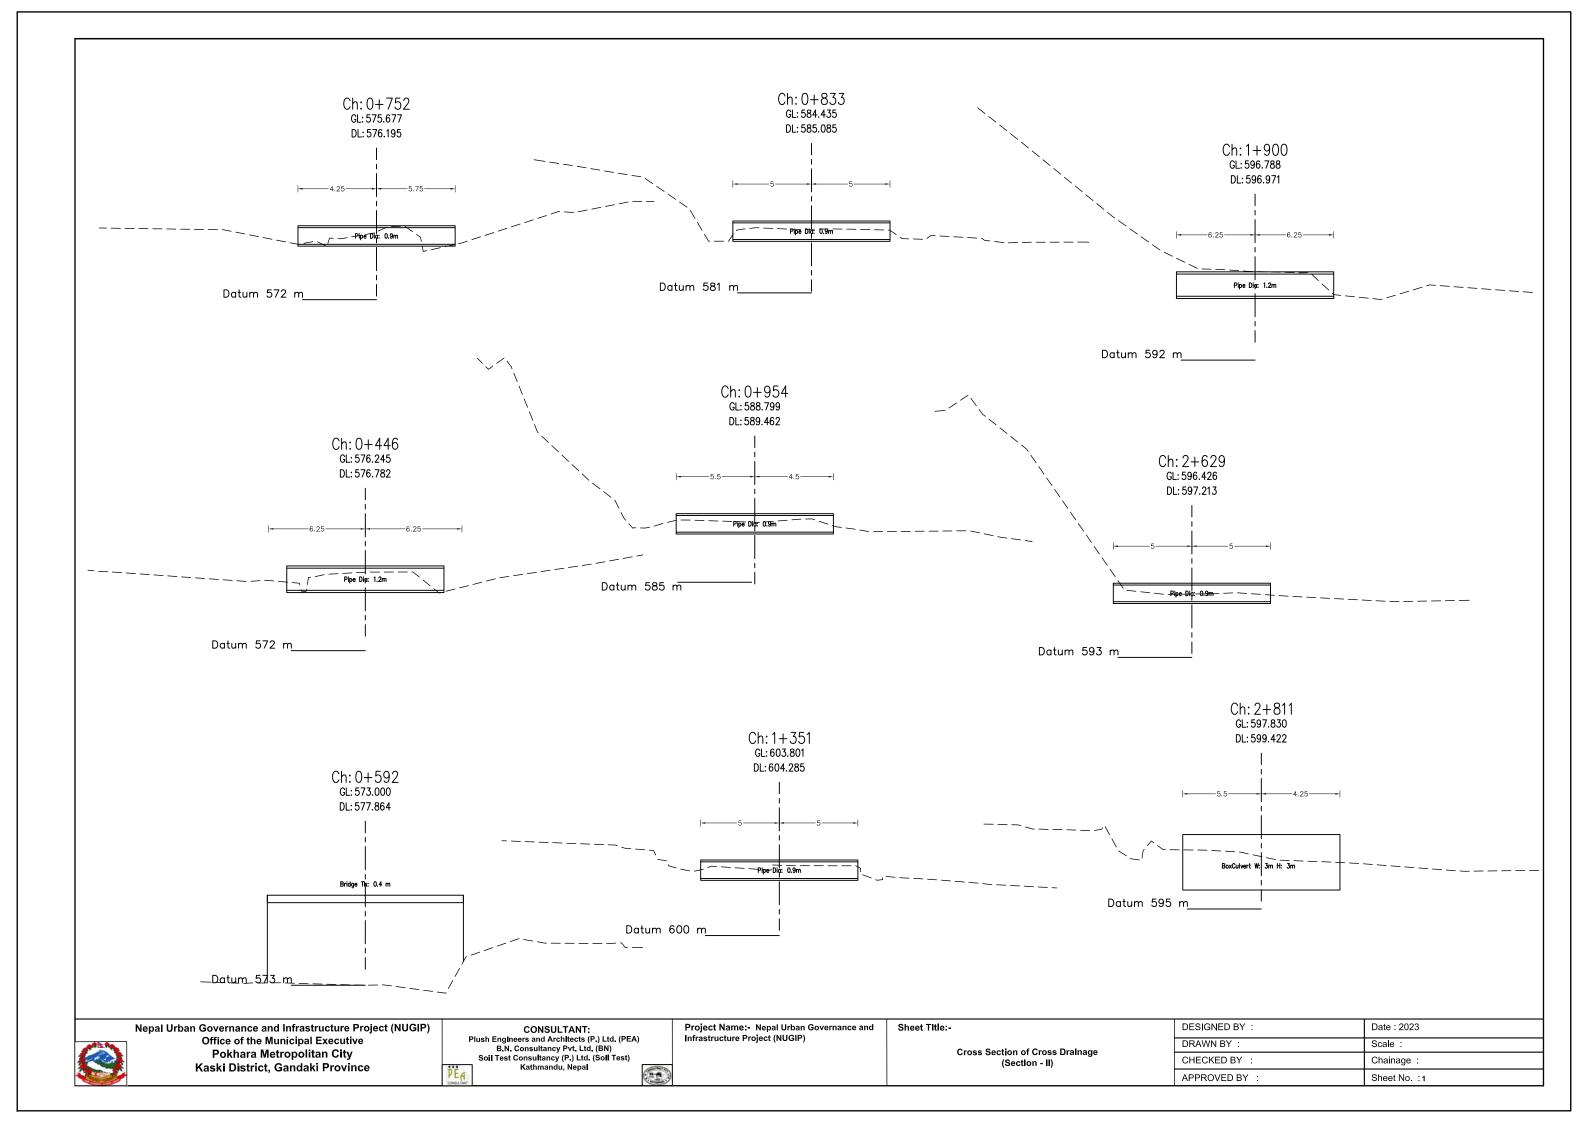

## SIDE DRAIN PLAN AND PROFILE SECTION - I

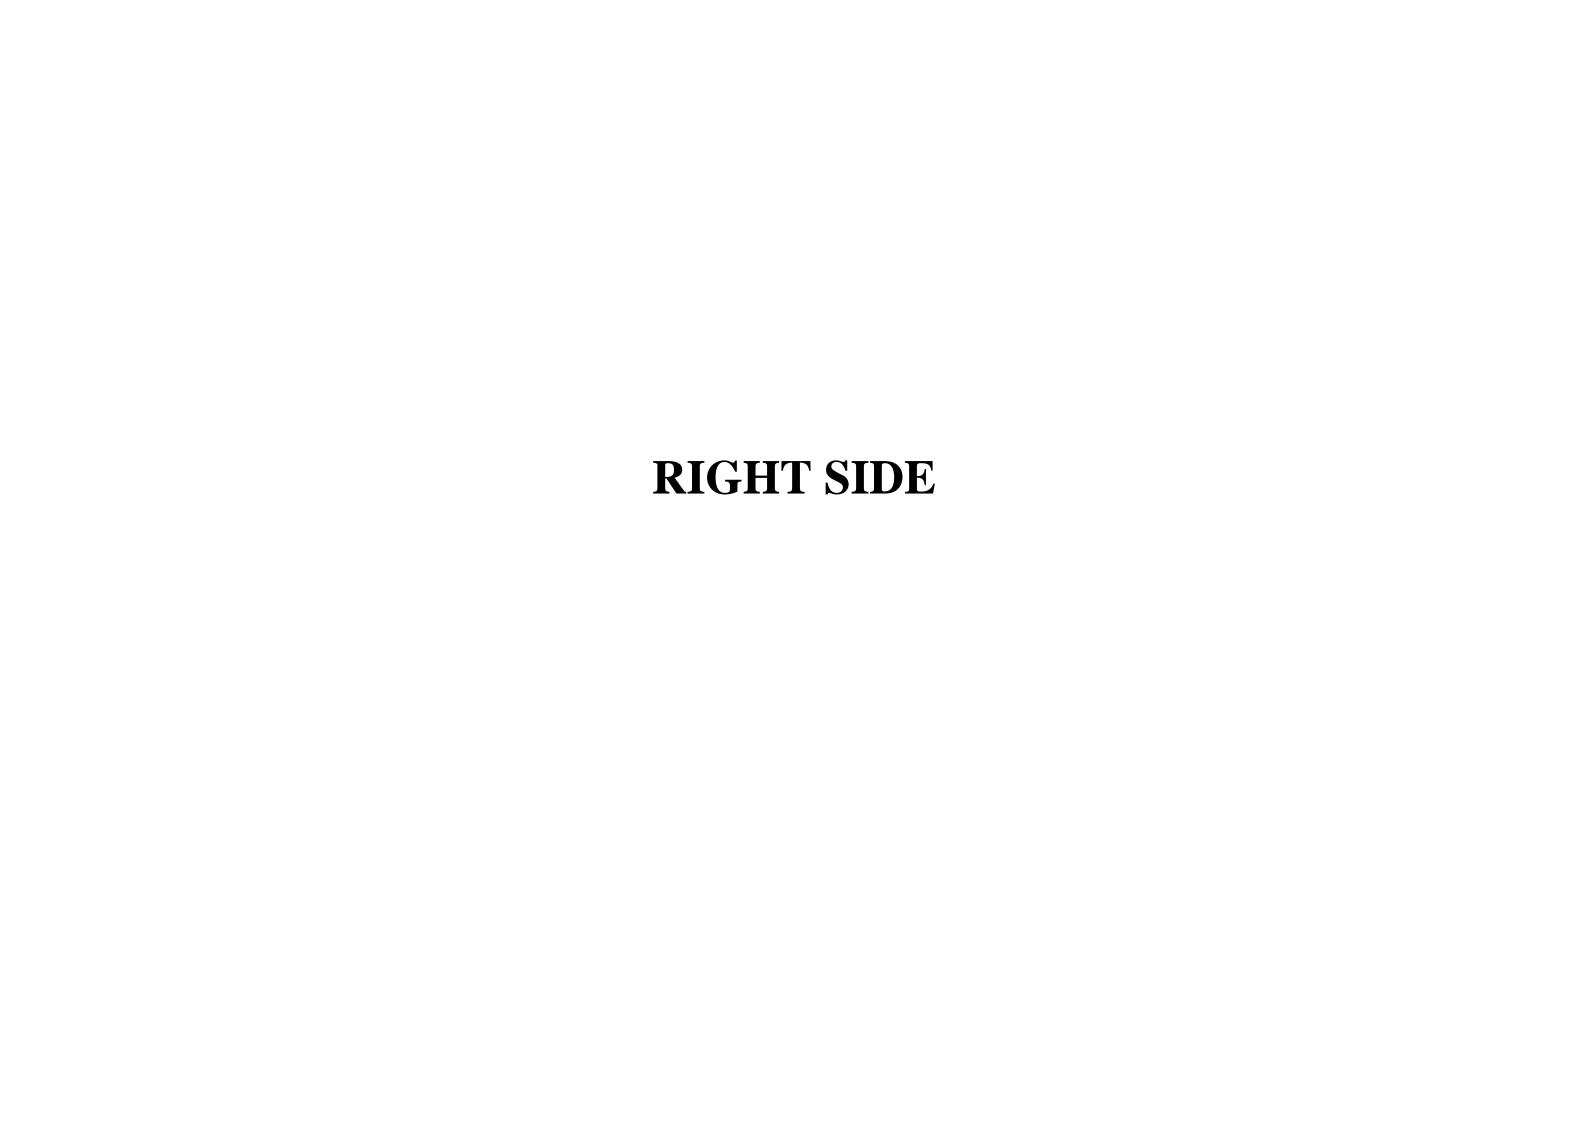

LEGEND	SYMBOL	LEGEND	SYMBOL
Bench Mark	⊠ <u>BM-1</u>	Land slide	
Houses		Rock area	
Temporary house		Water tank	
Road center		Masonry wall	
Chainage	0+040 0+030 0+020 0+010	Retaining wall	
School		Gabion wall	
Chautari		RCC wall	
Partikshyalaya	£ <u>₹₹₹₹</u> ₹		
Box Culvert			
Pipe Culvert			
Compound wall			
Gate			
Wooden Pole			
Electric Pole			
RCC Pole	†		
Bamboo	A		
Masonry wall			
Temple			
Index Contour	D		
Tick Drain			
Kerbstone			
Footpath			
Drain			
Fence bar	+++++++++++++++++++++++++++++++++++++++		

Nepal Urban Governance and Infrastructure Project (NUGIP)

Office of the Municipal Executive

Pokhara Metropolitan City

Kaski District, Gandaki Province





Project Name:- Nepal Urban Governance and Infrastructure Project (NUGIP)


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APPROVED BY :		


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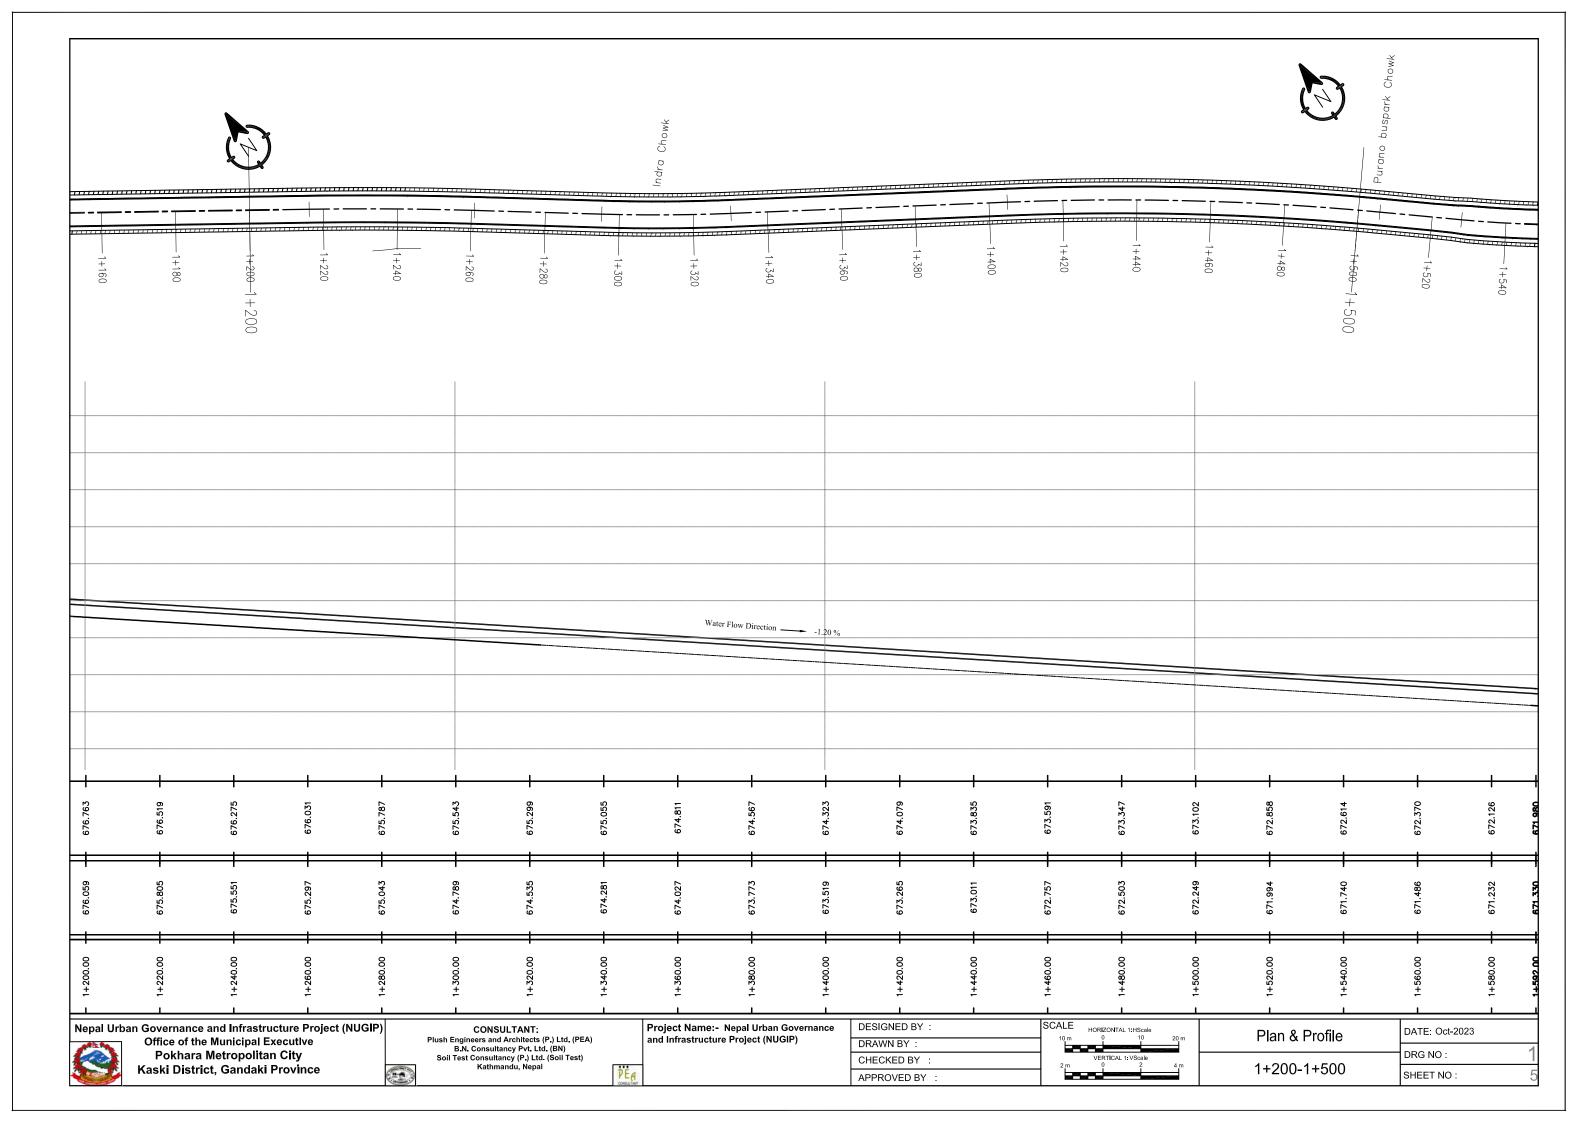
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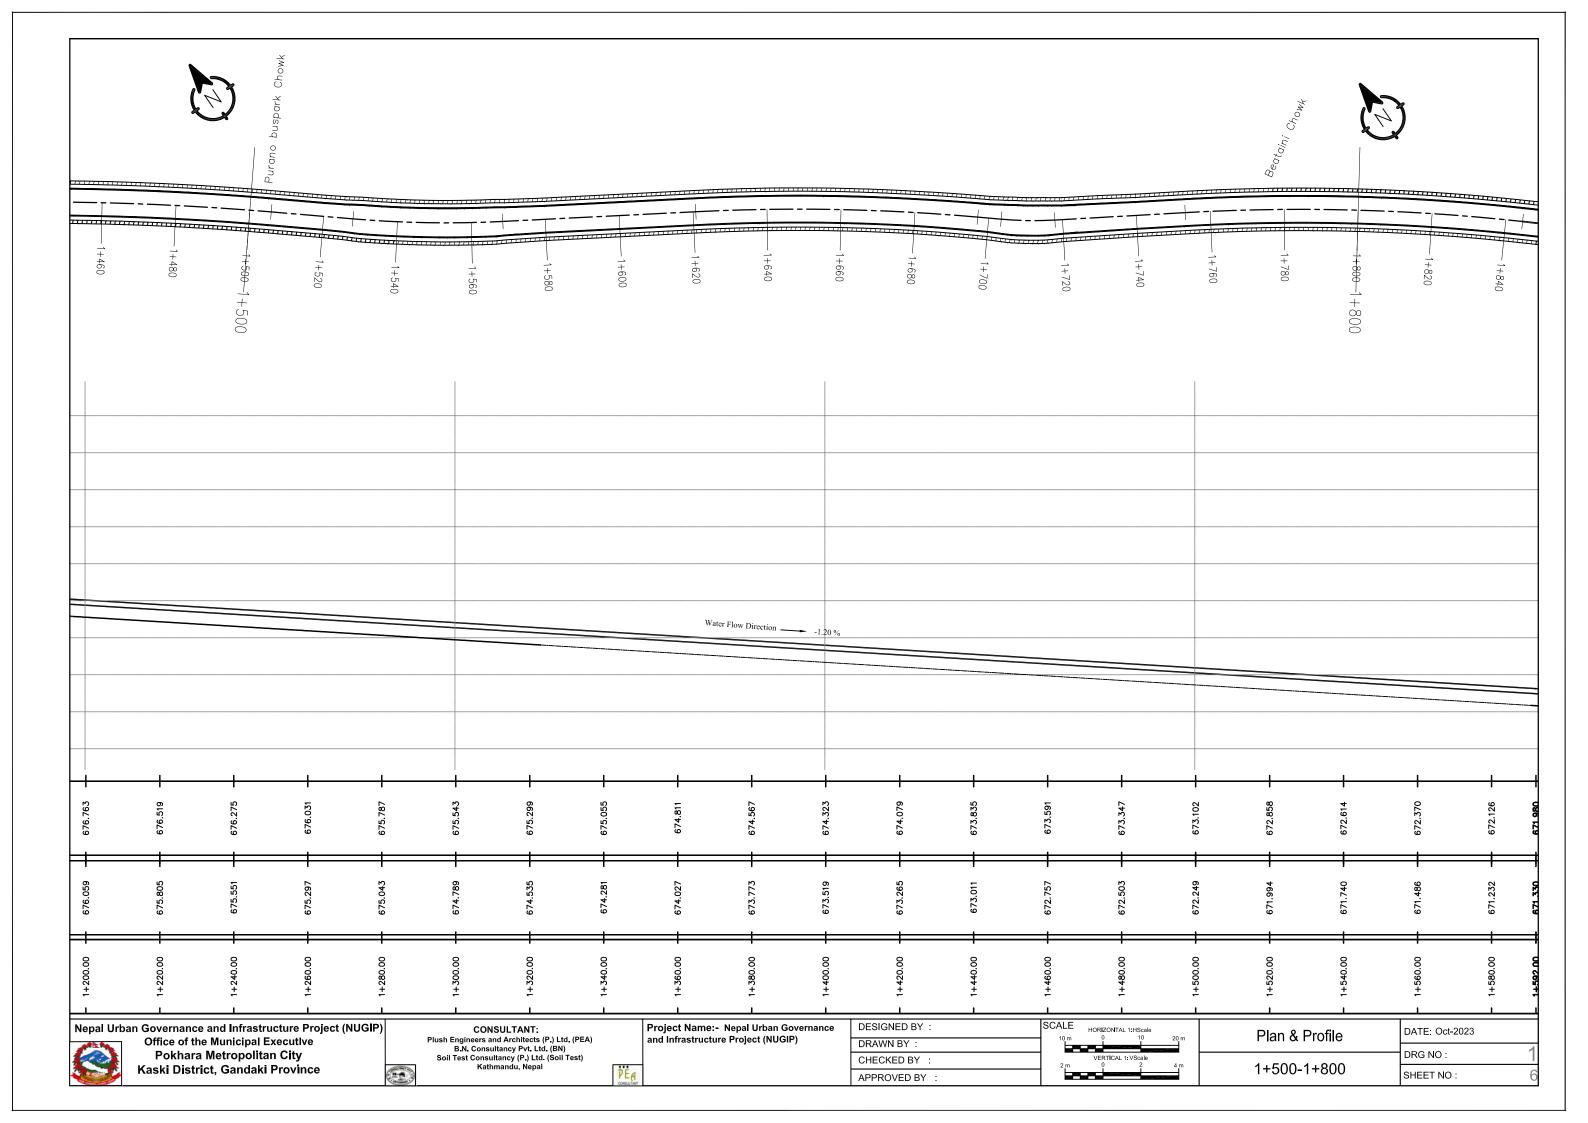





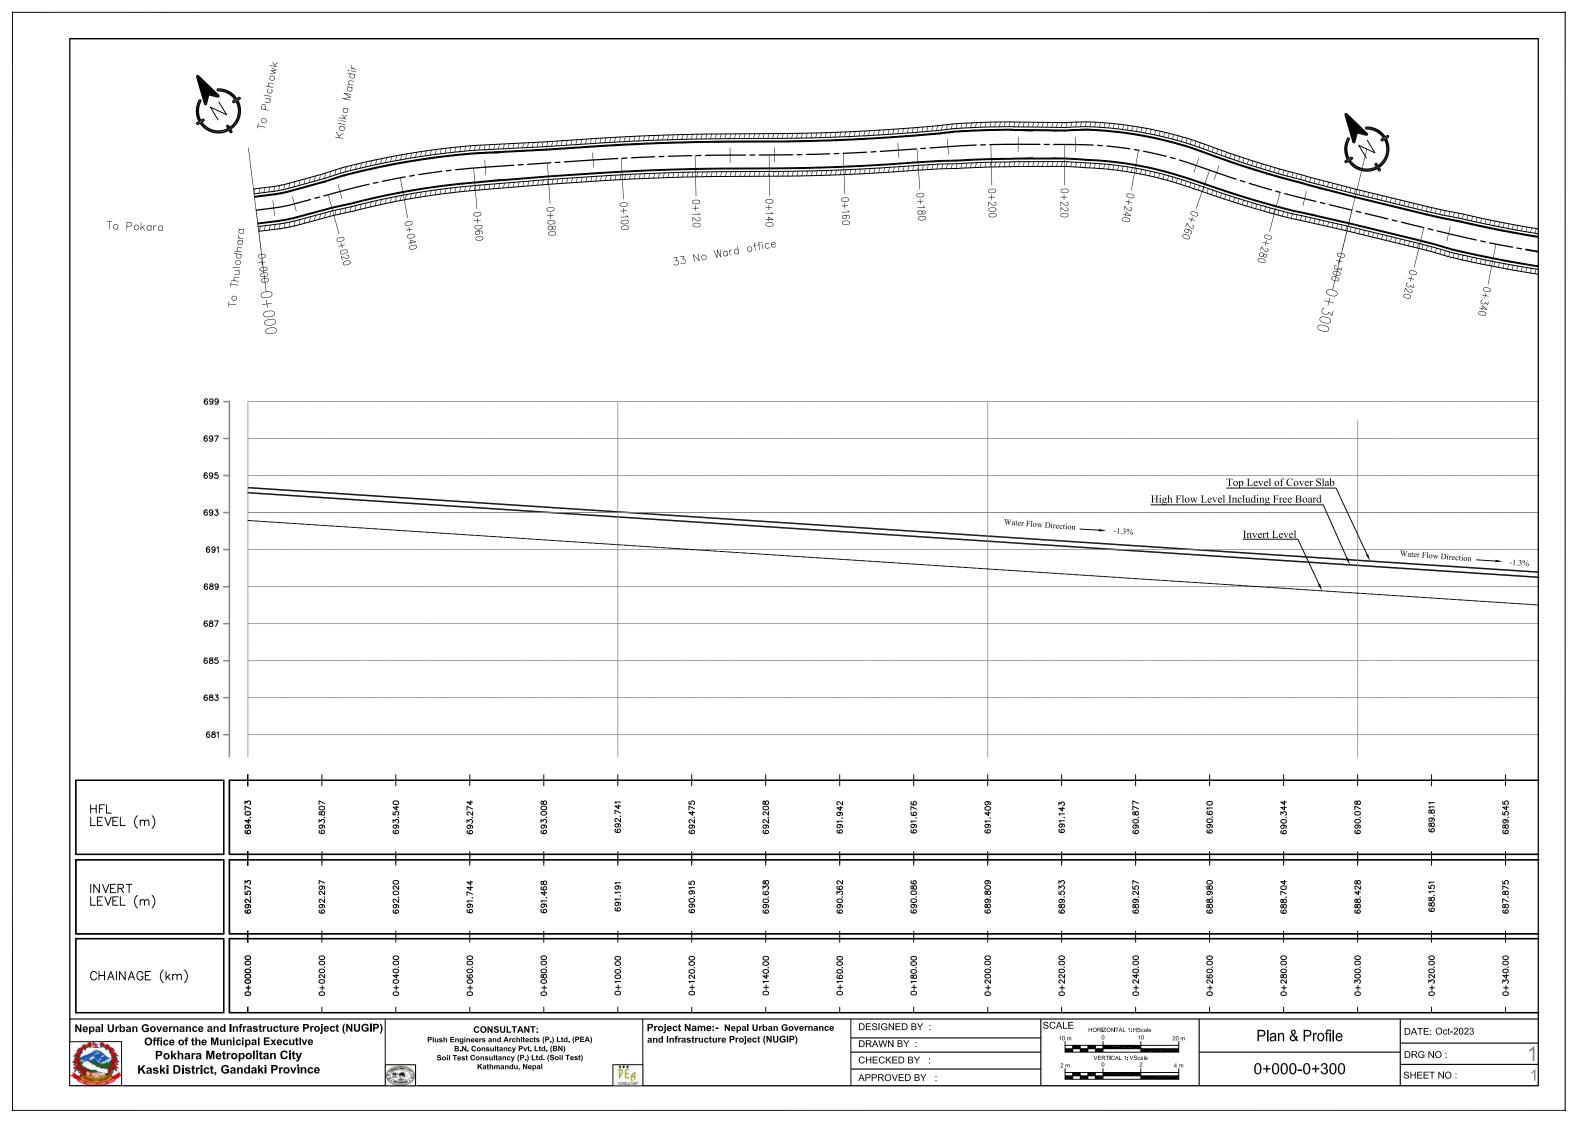


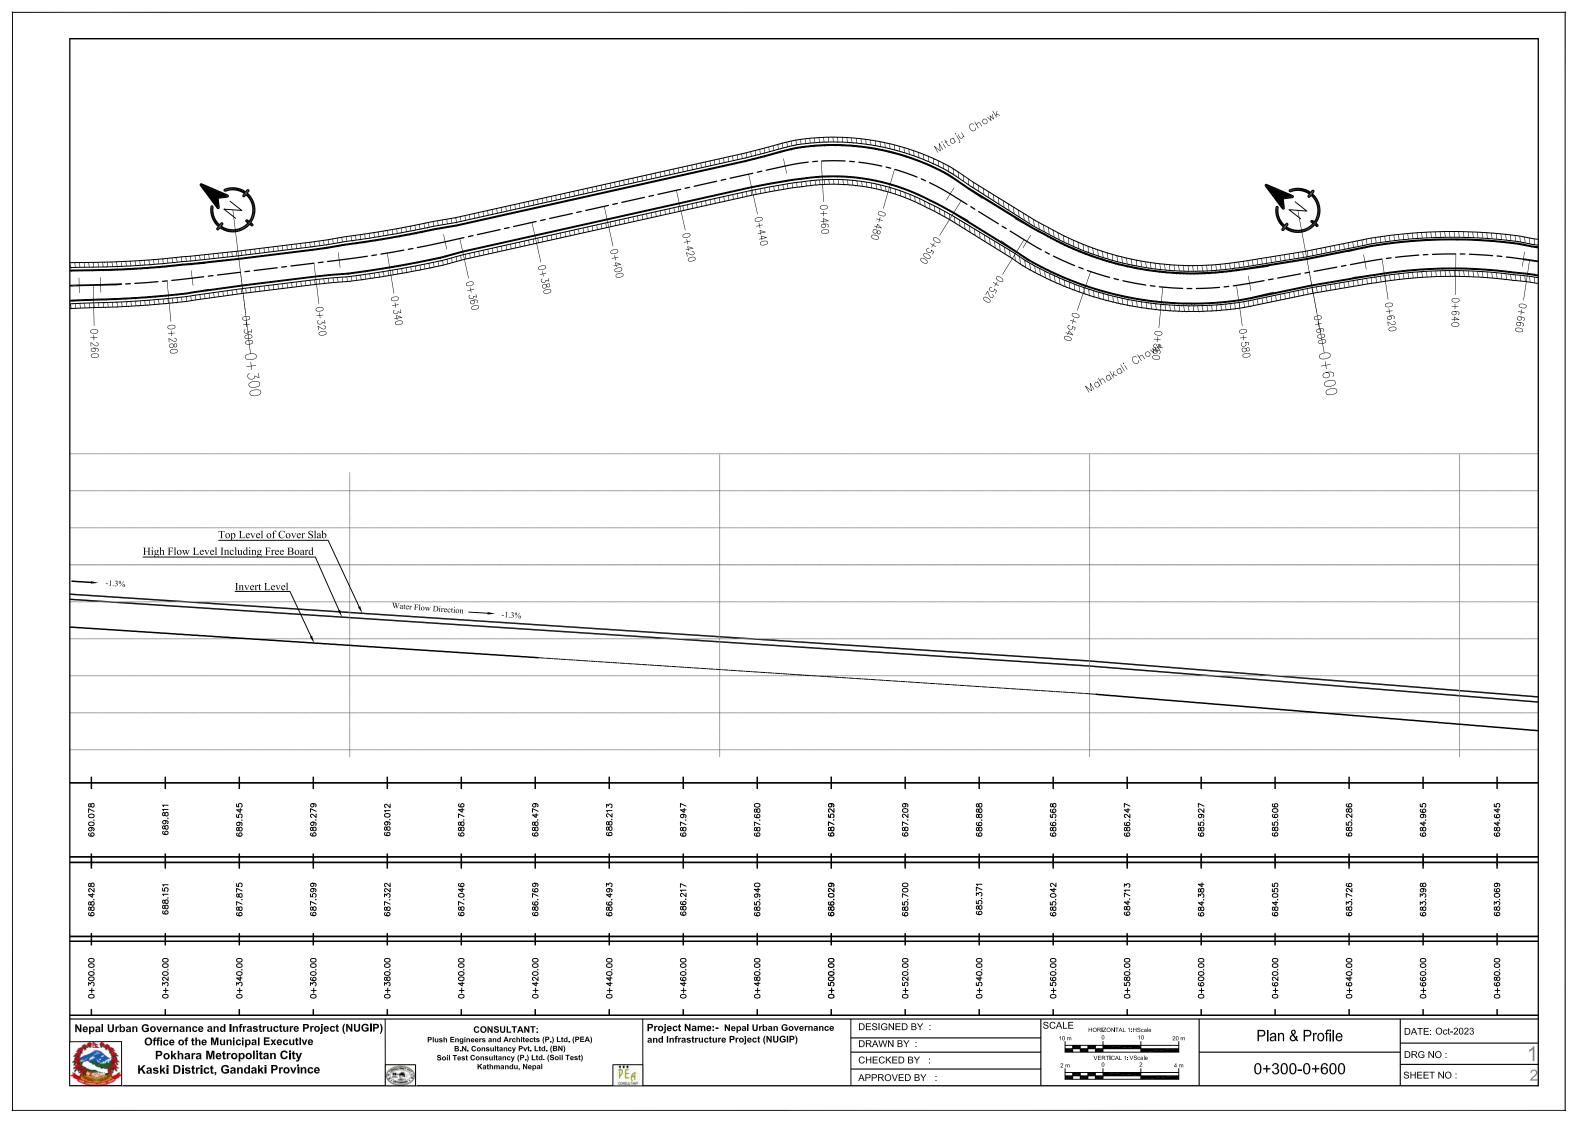


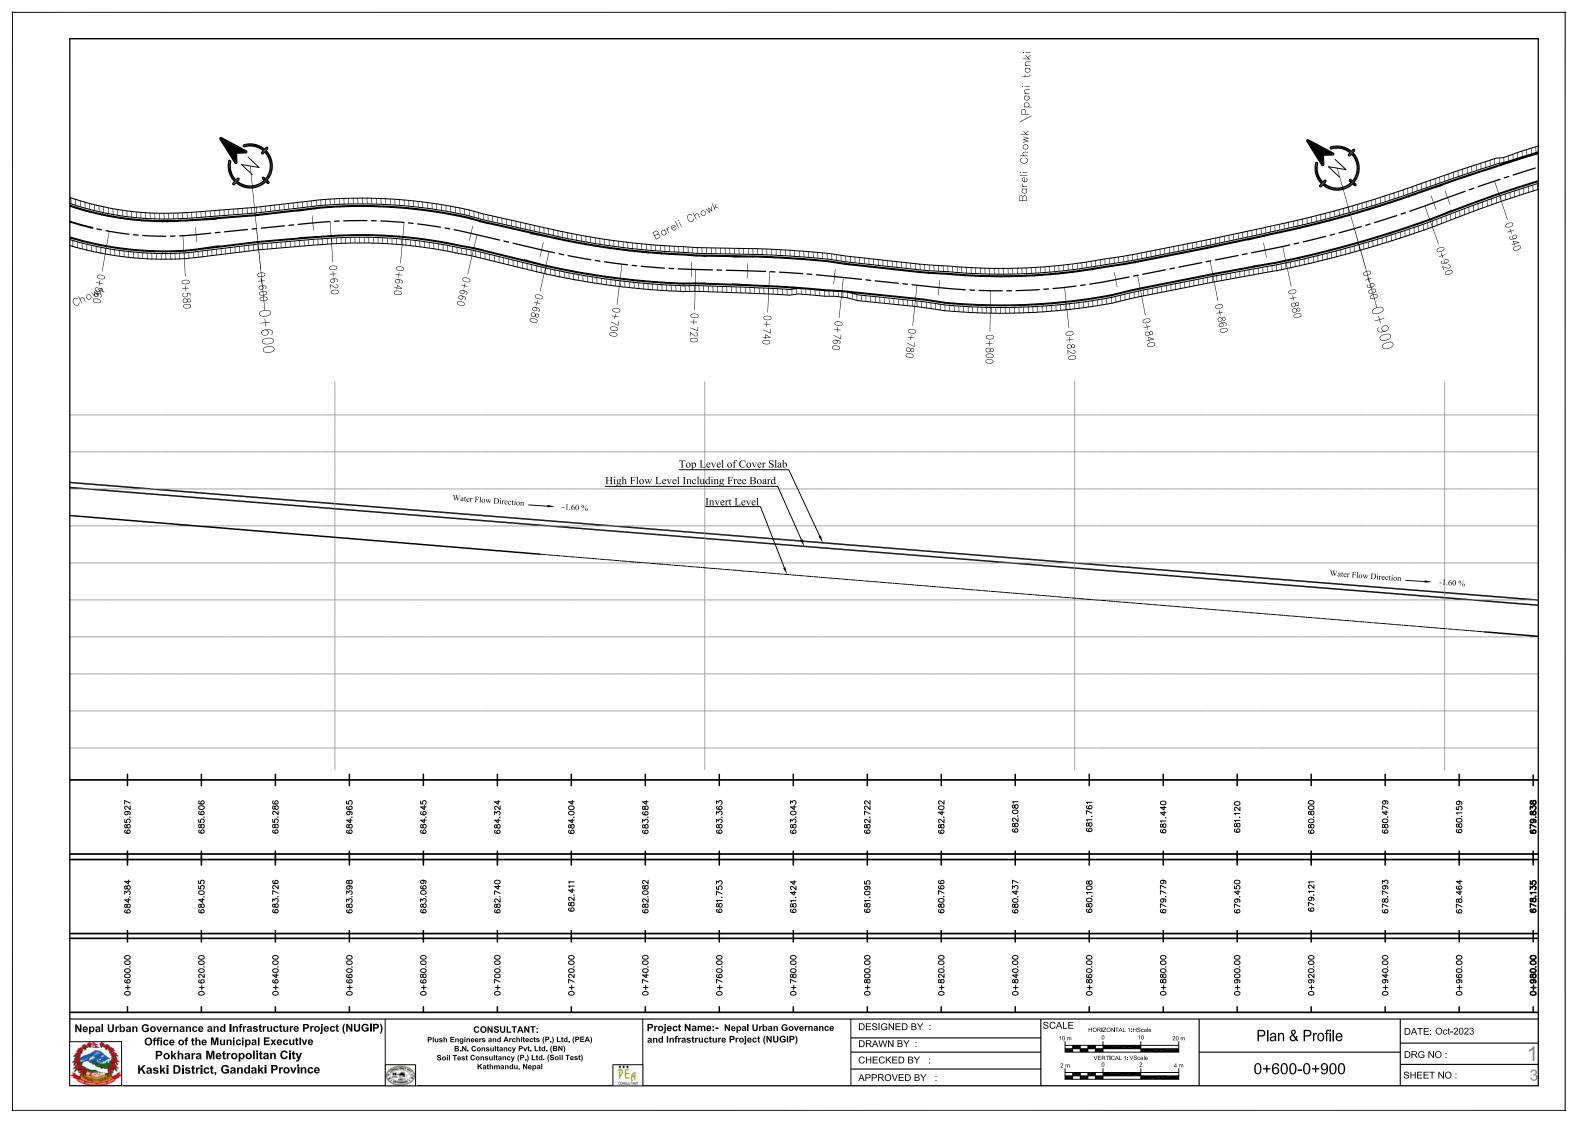


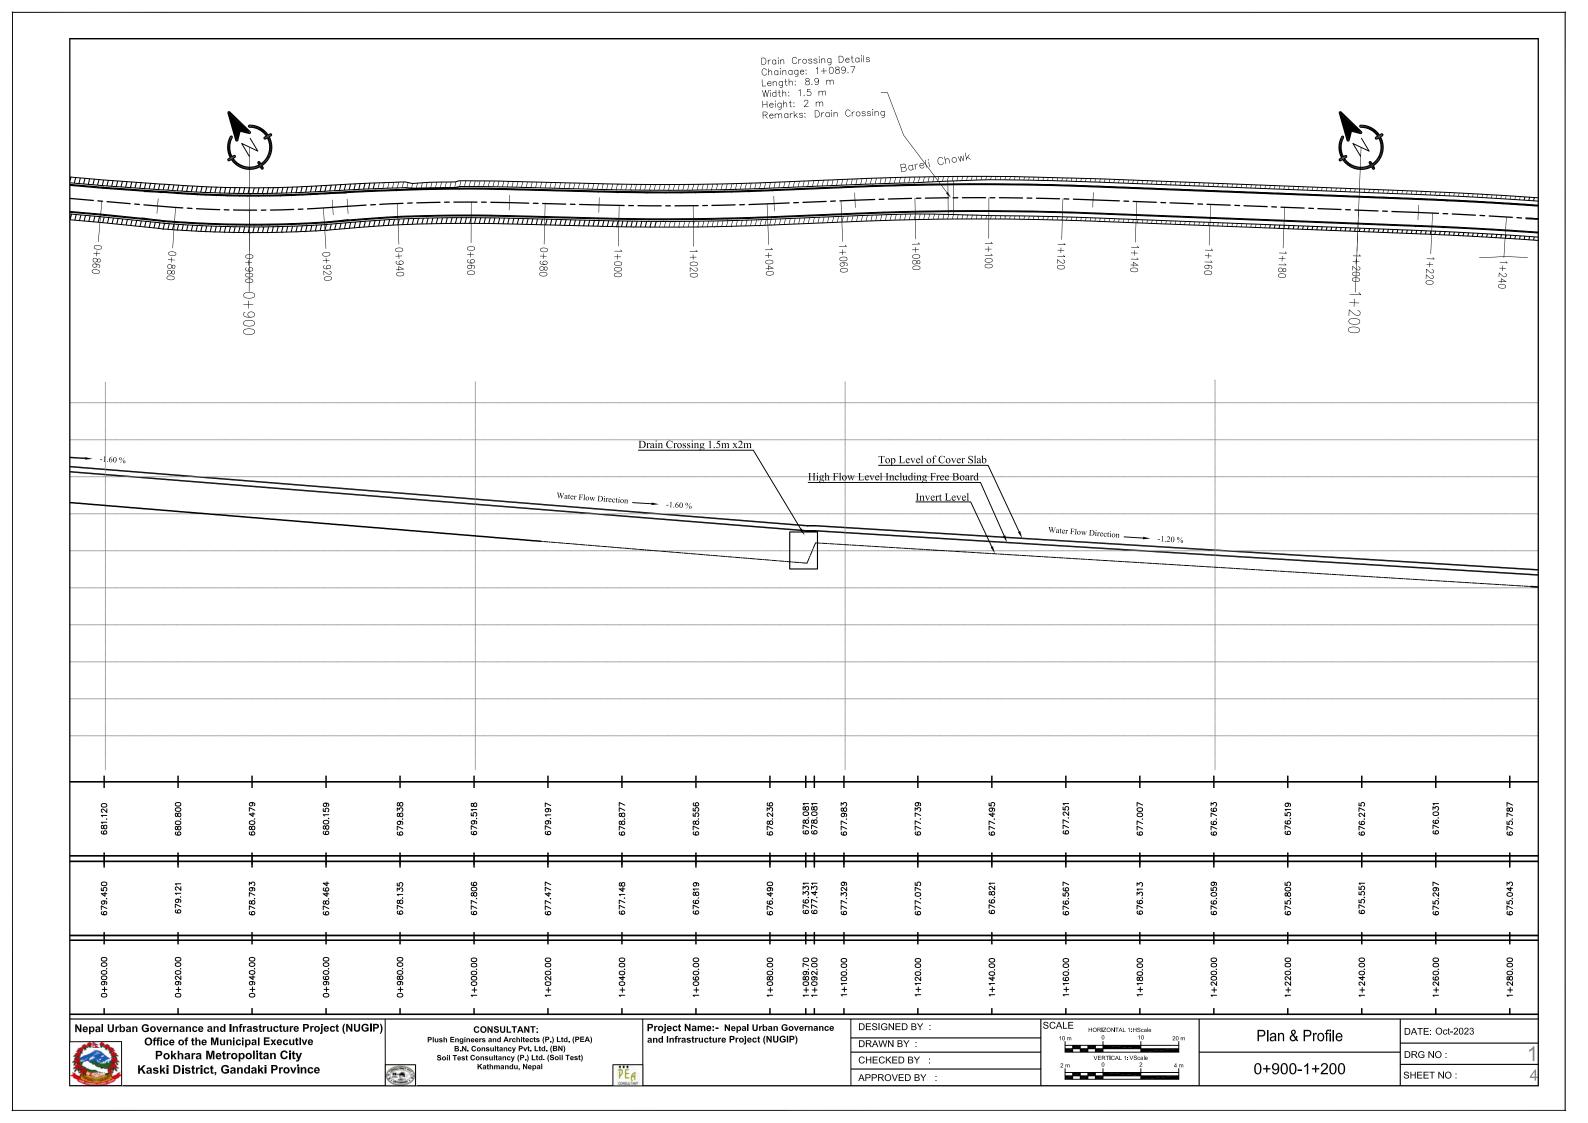


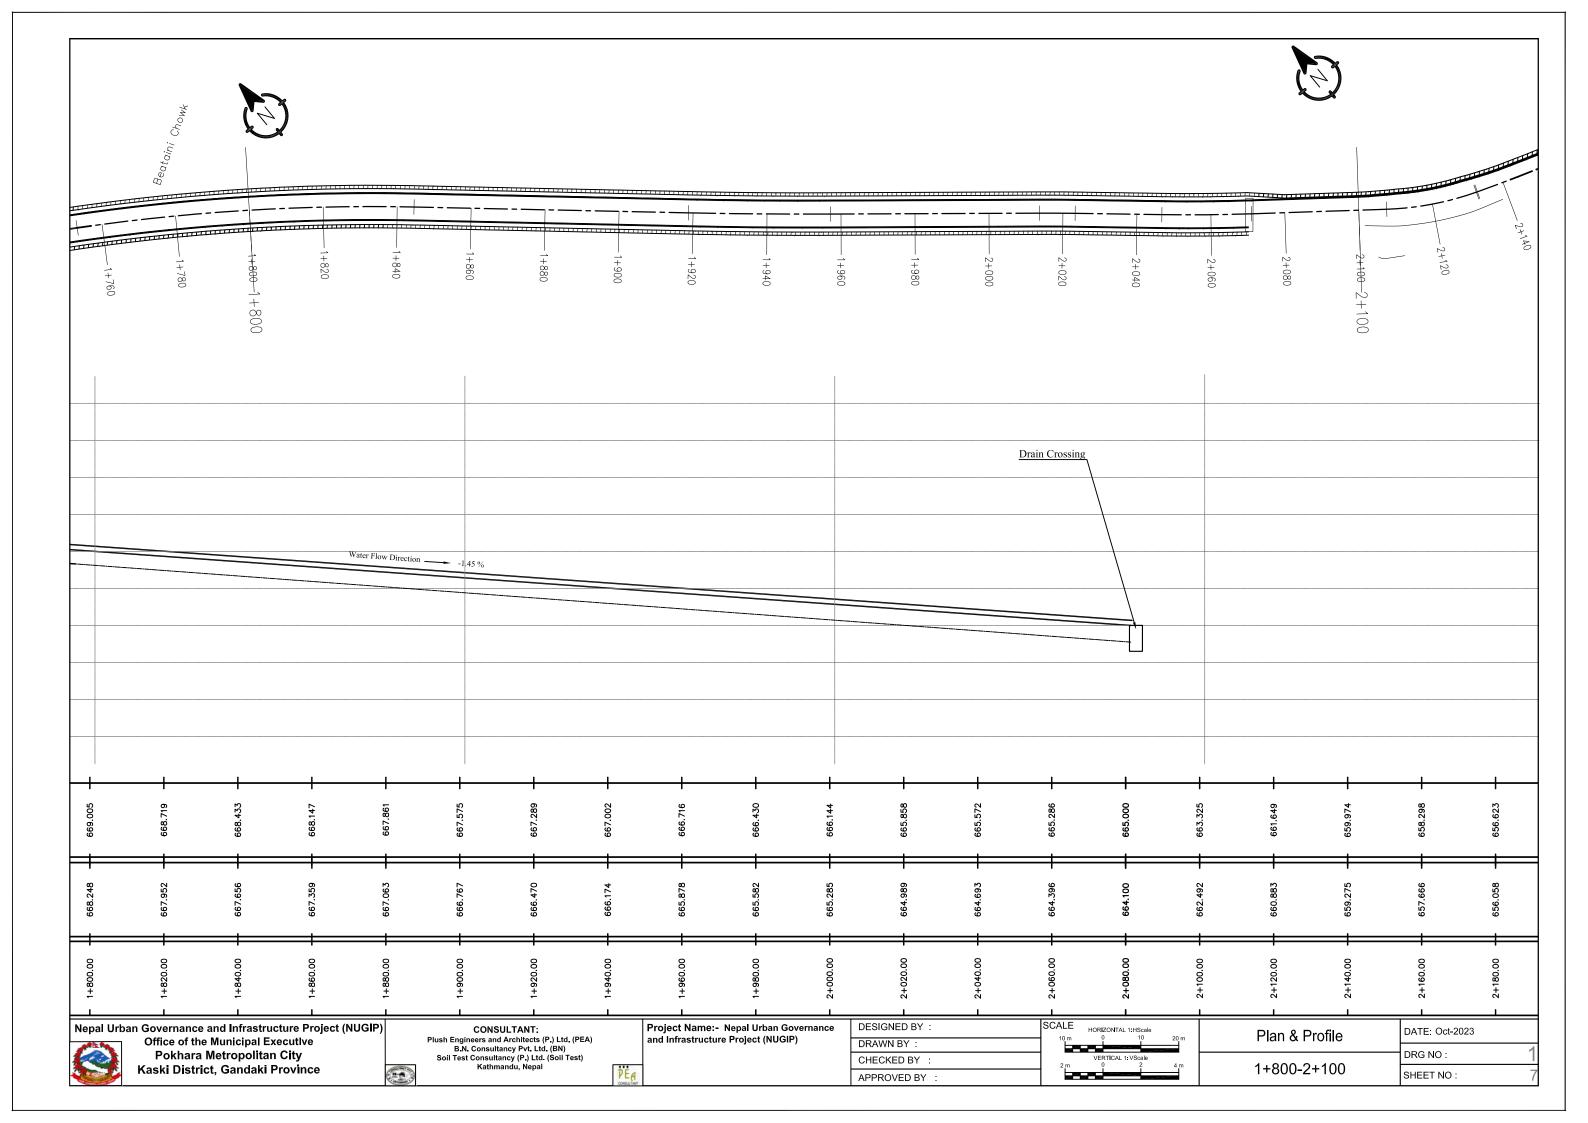


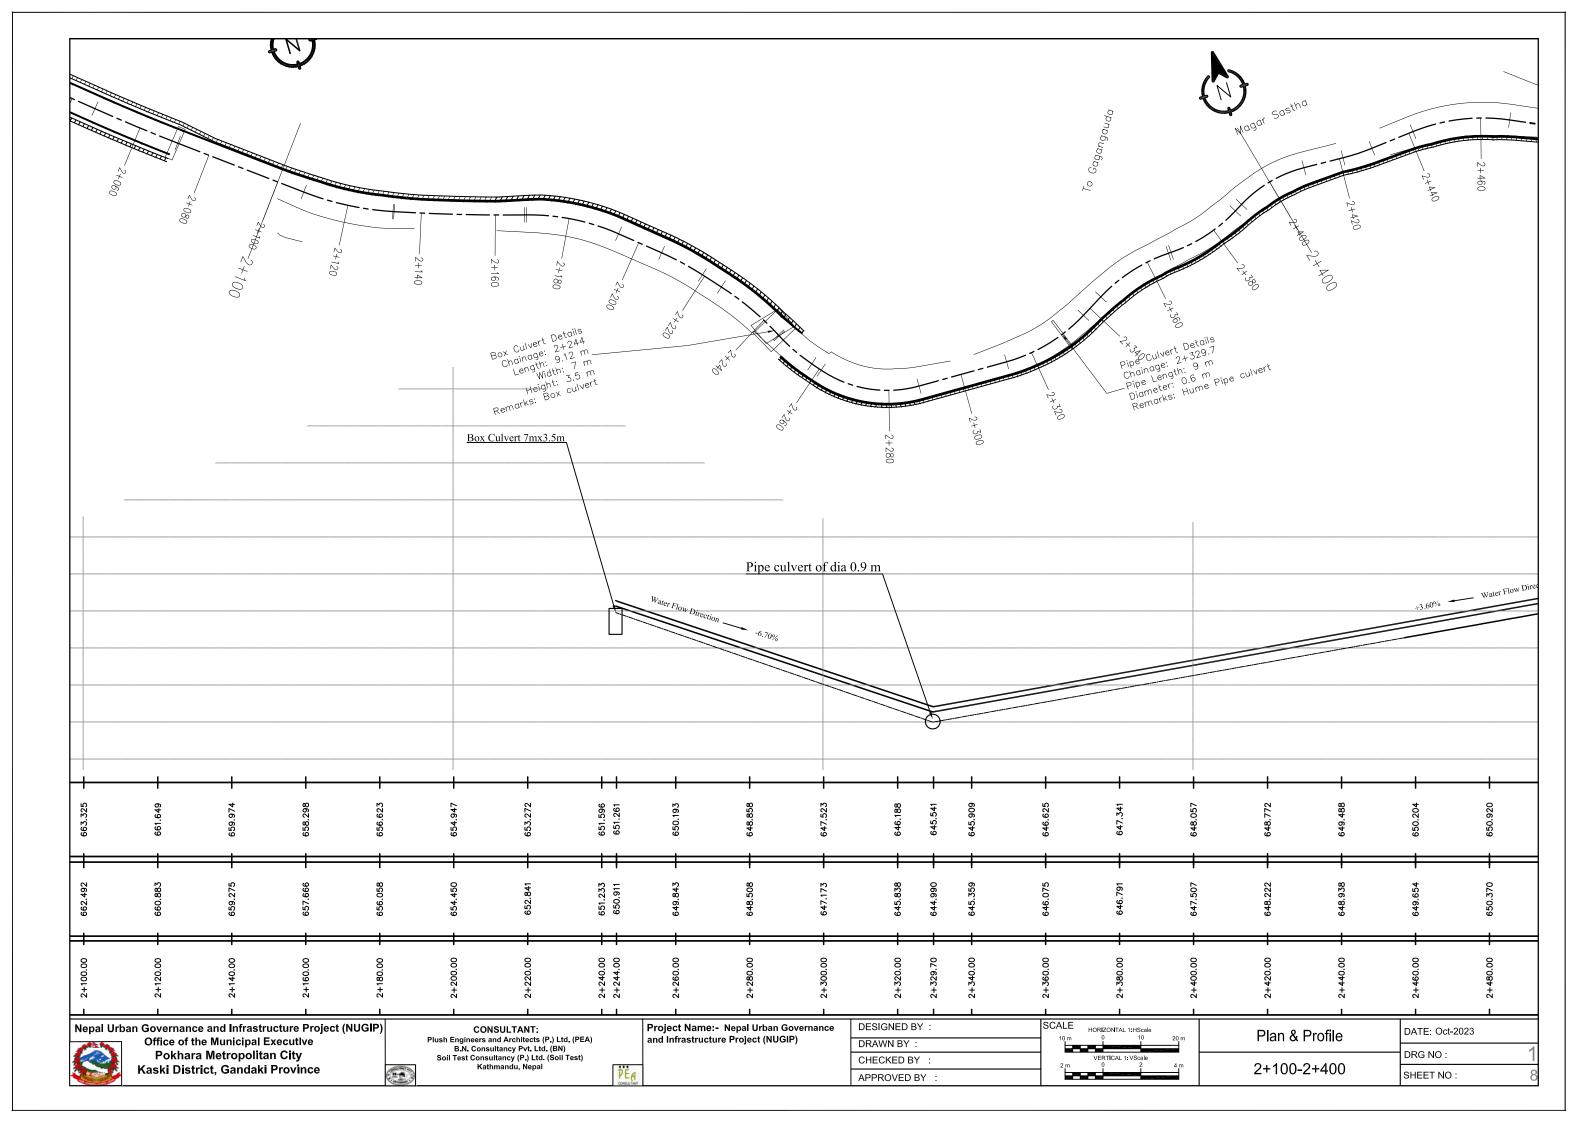


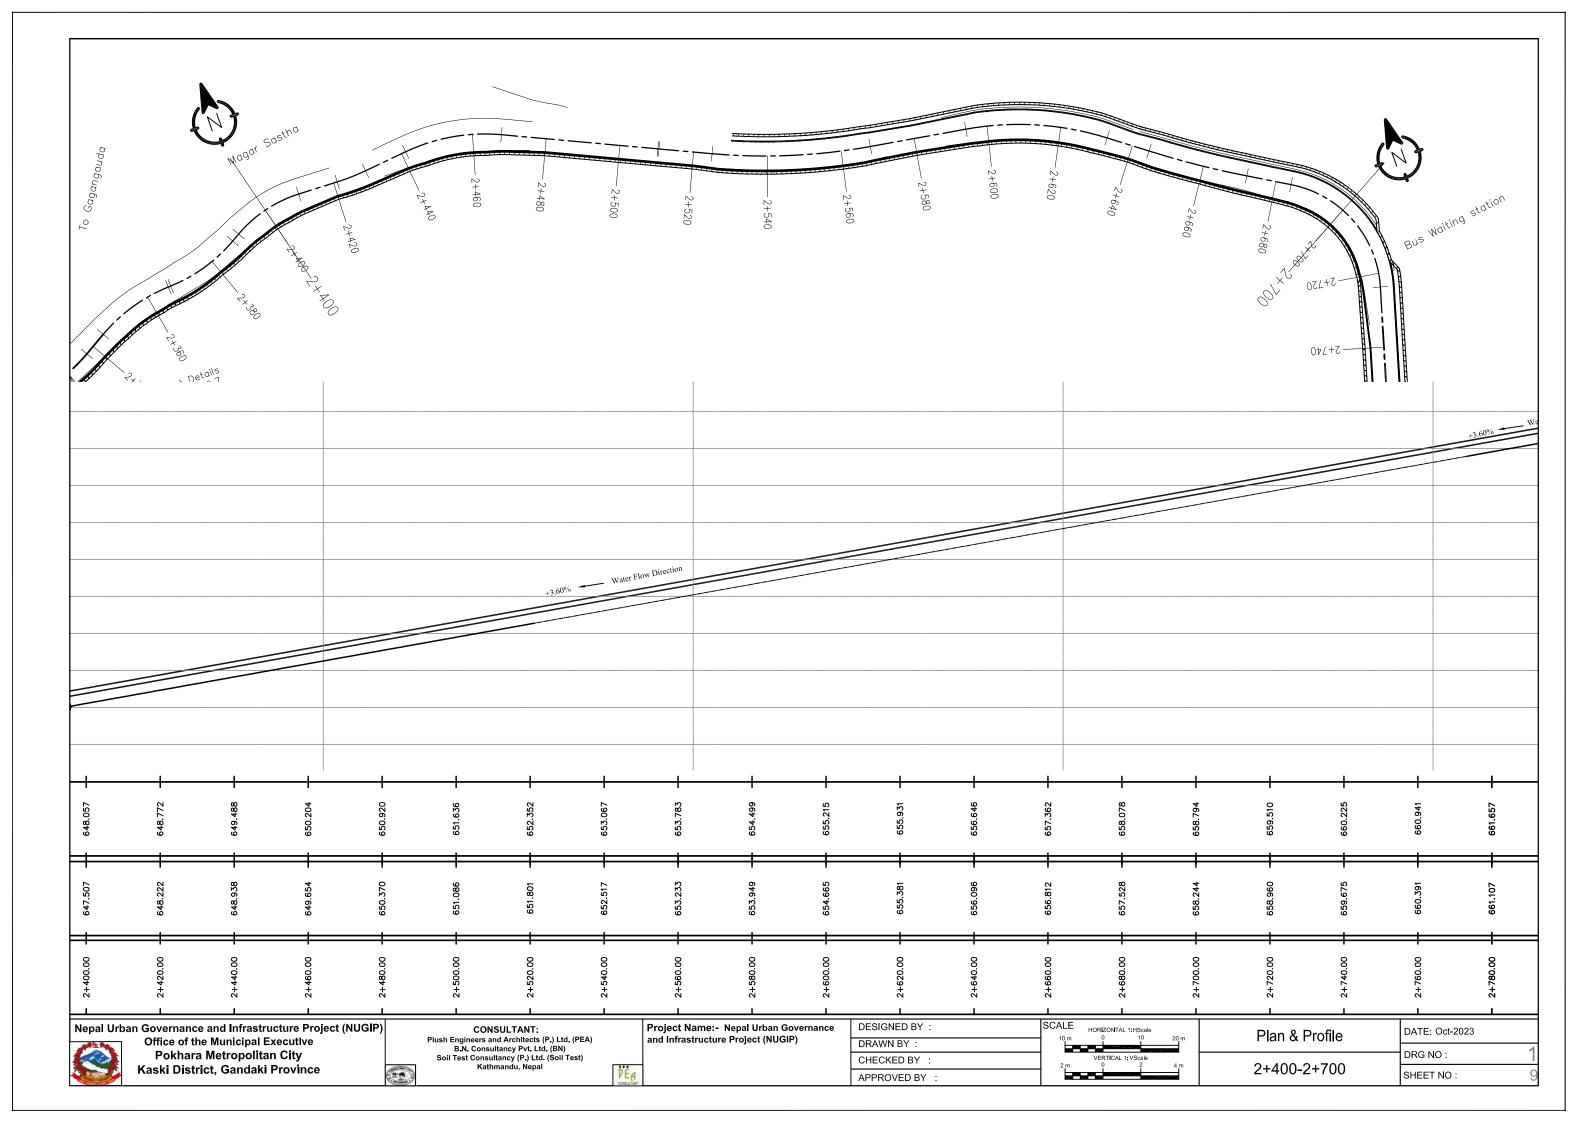


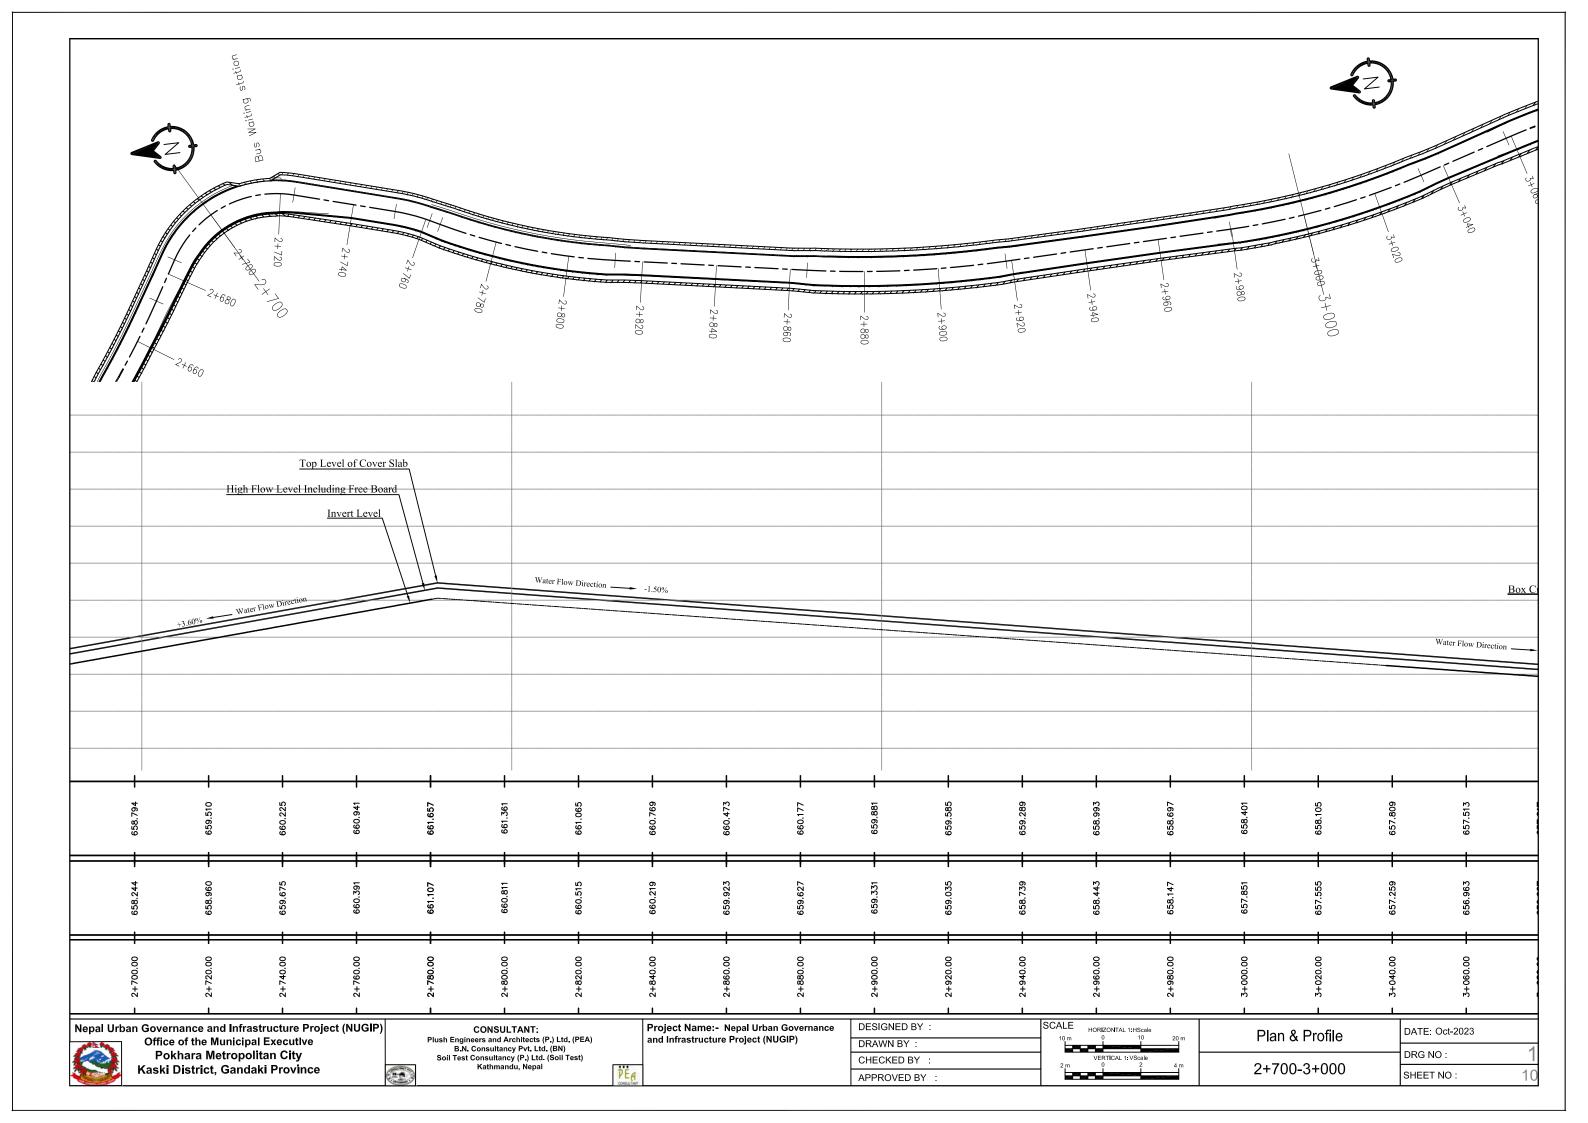


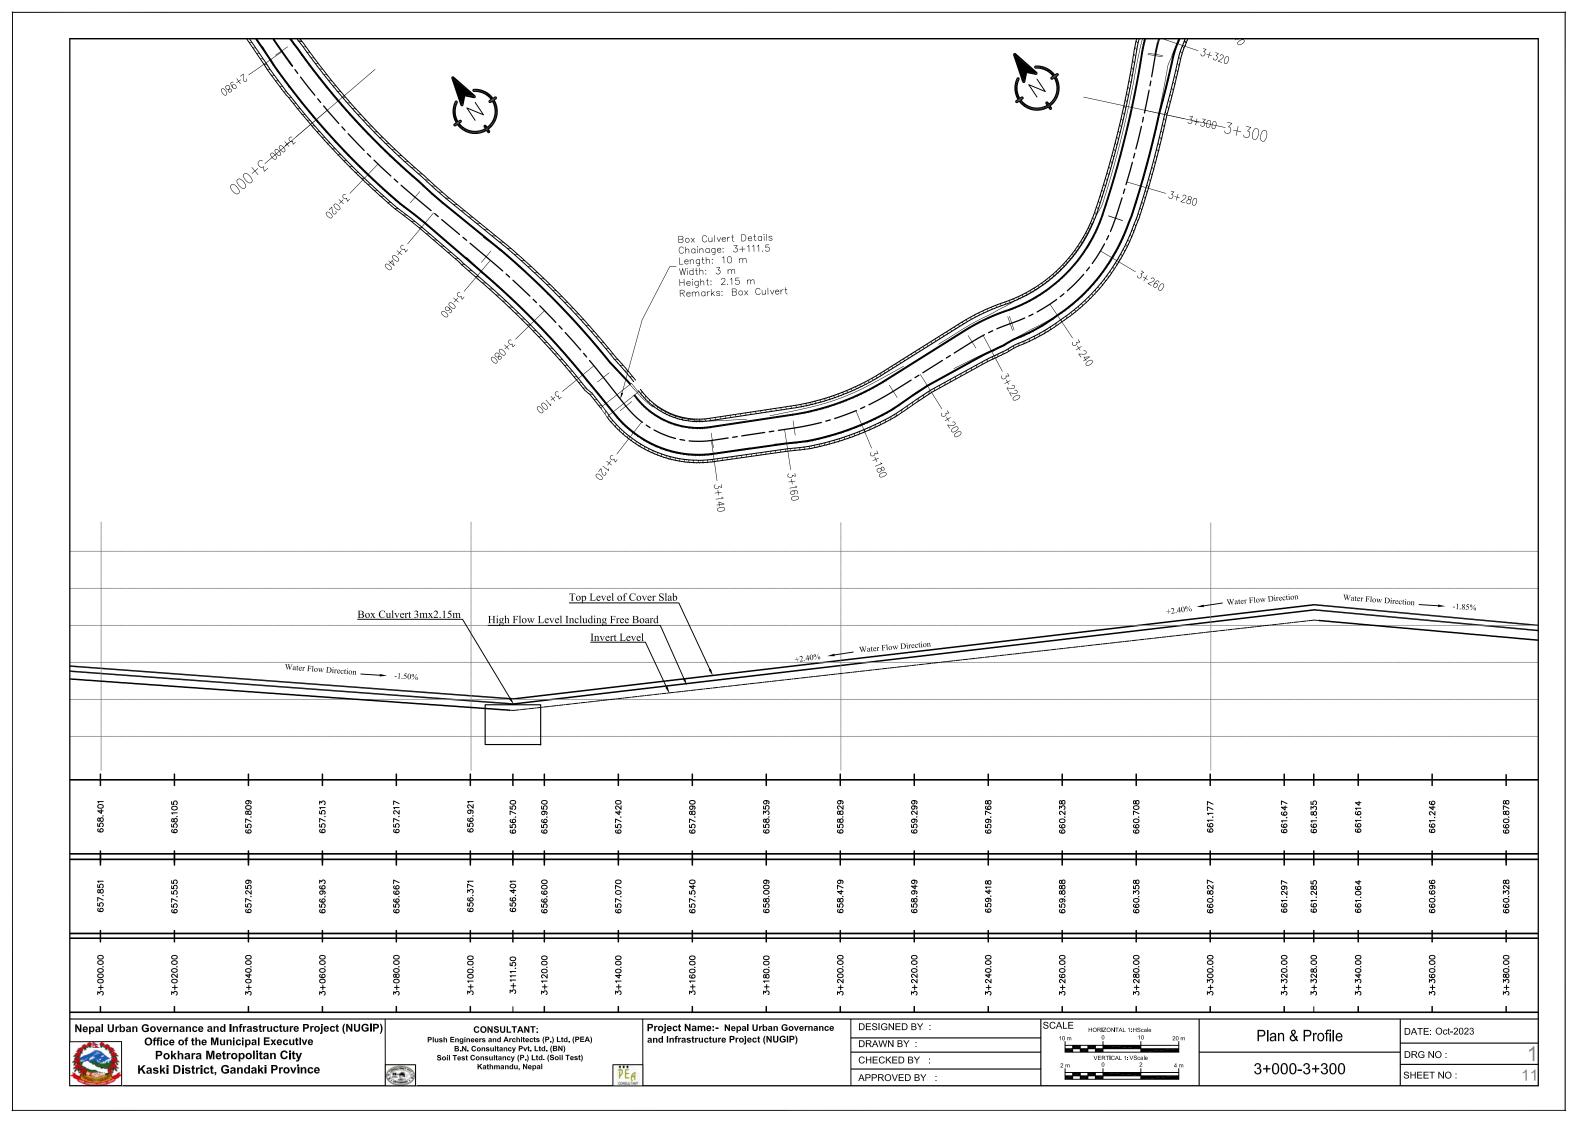


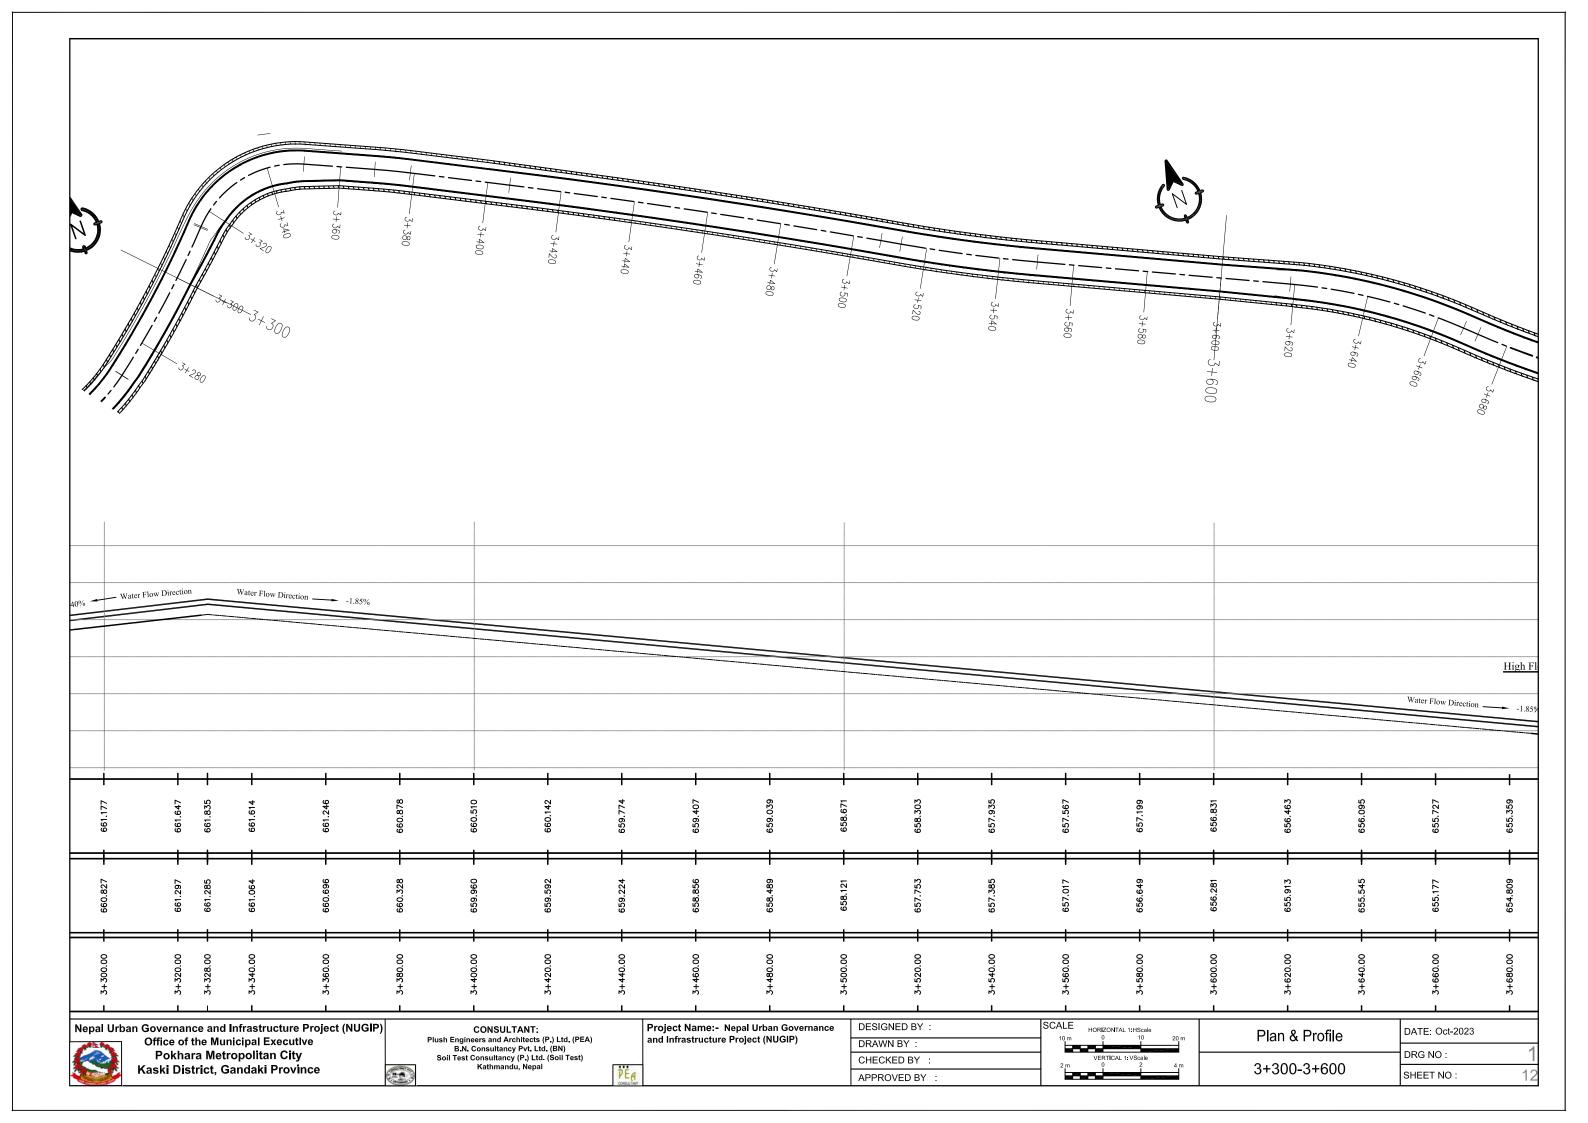


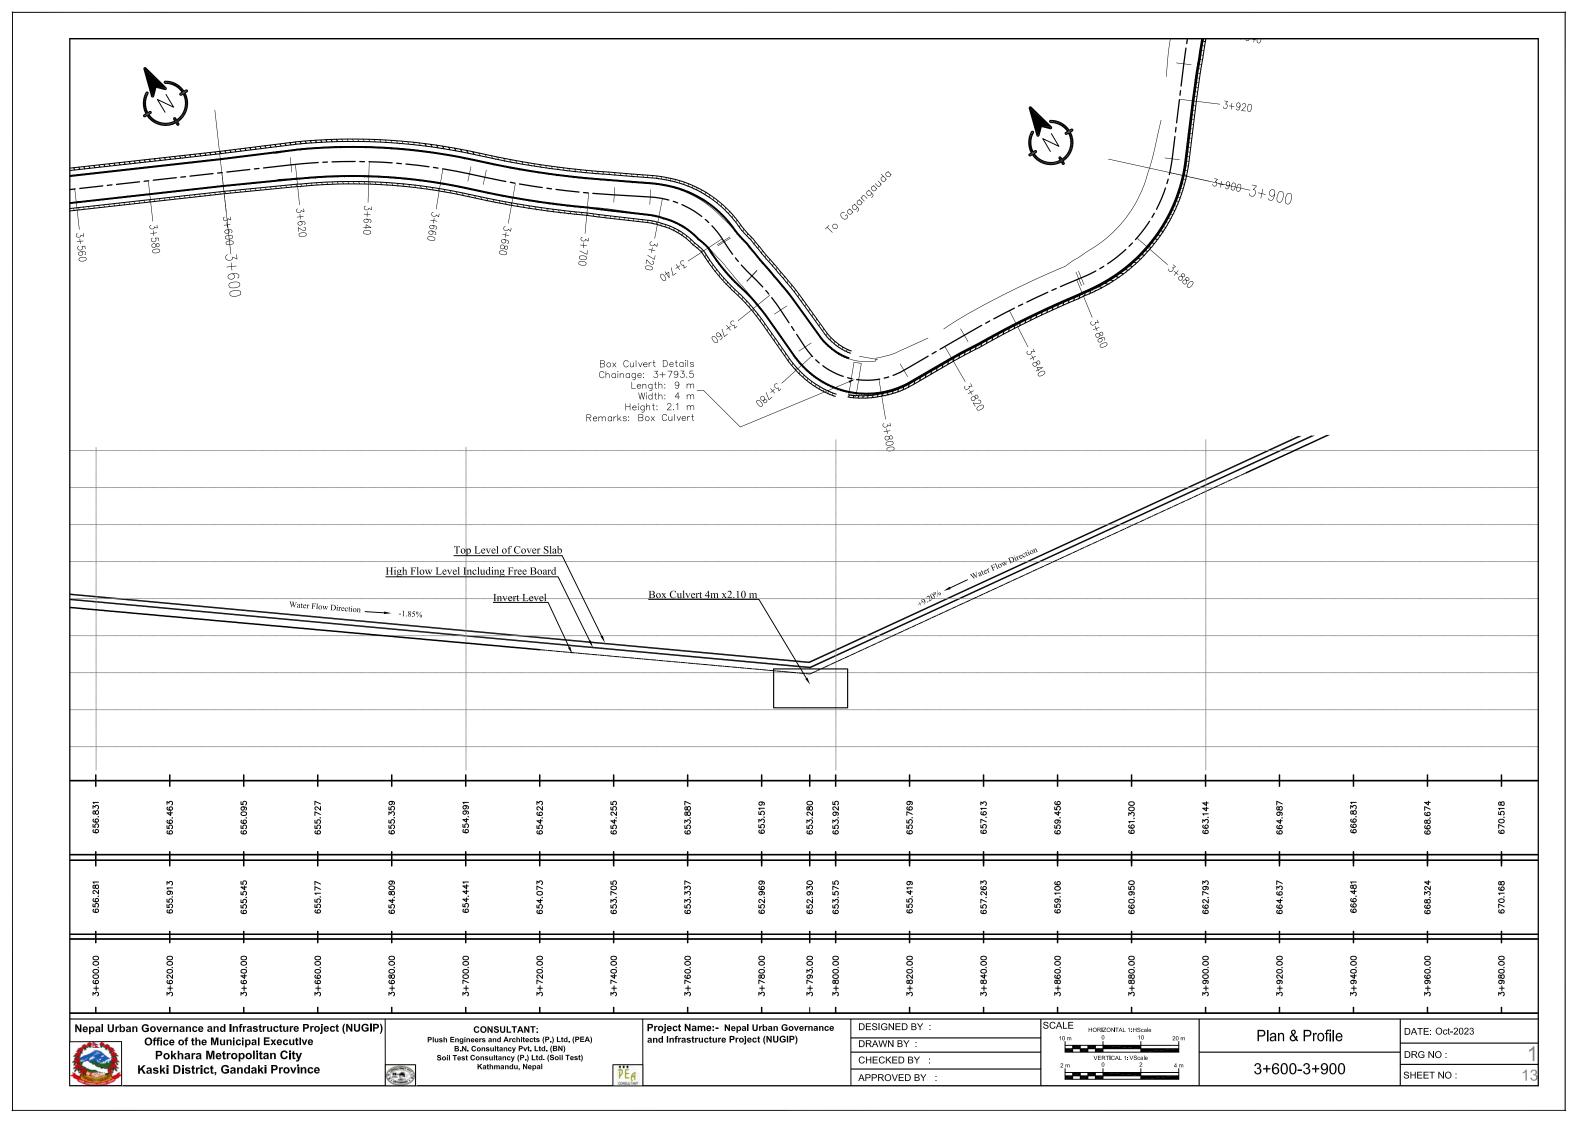


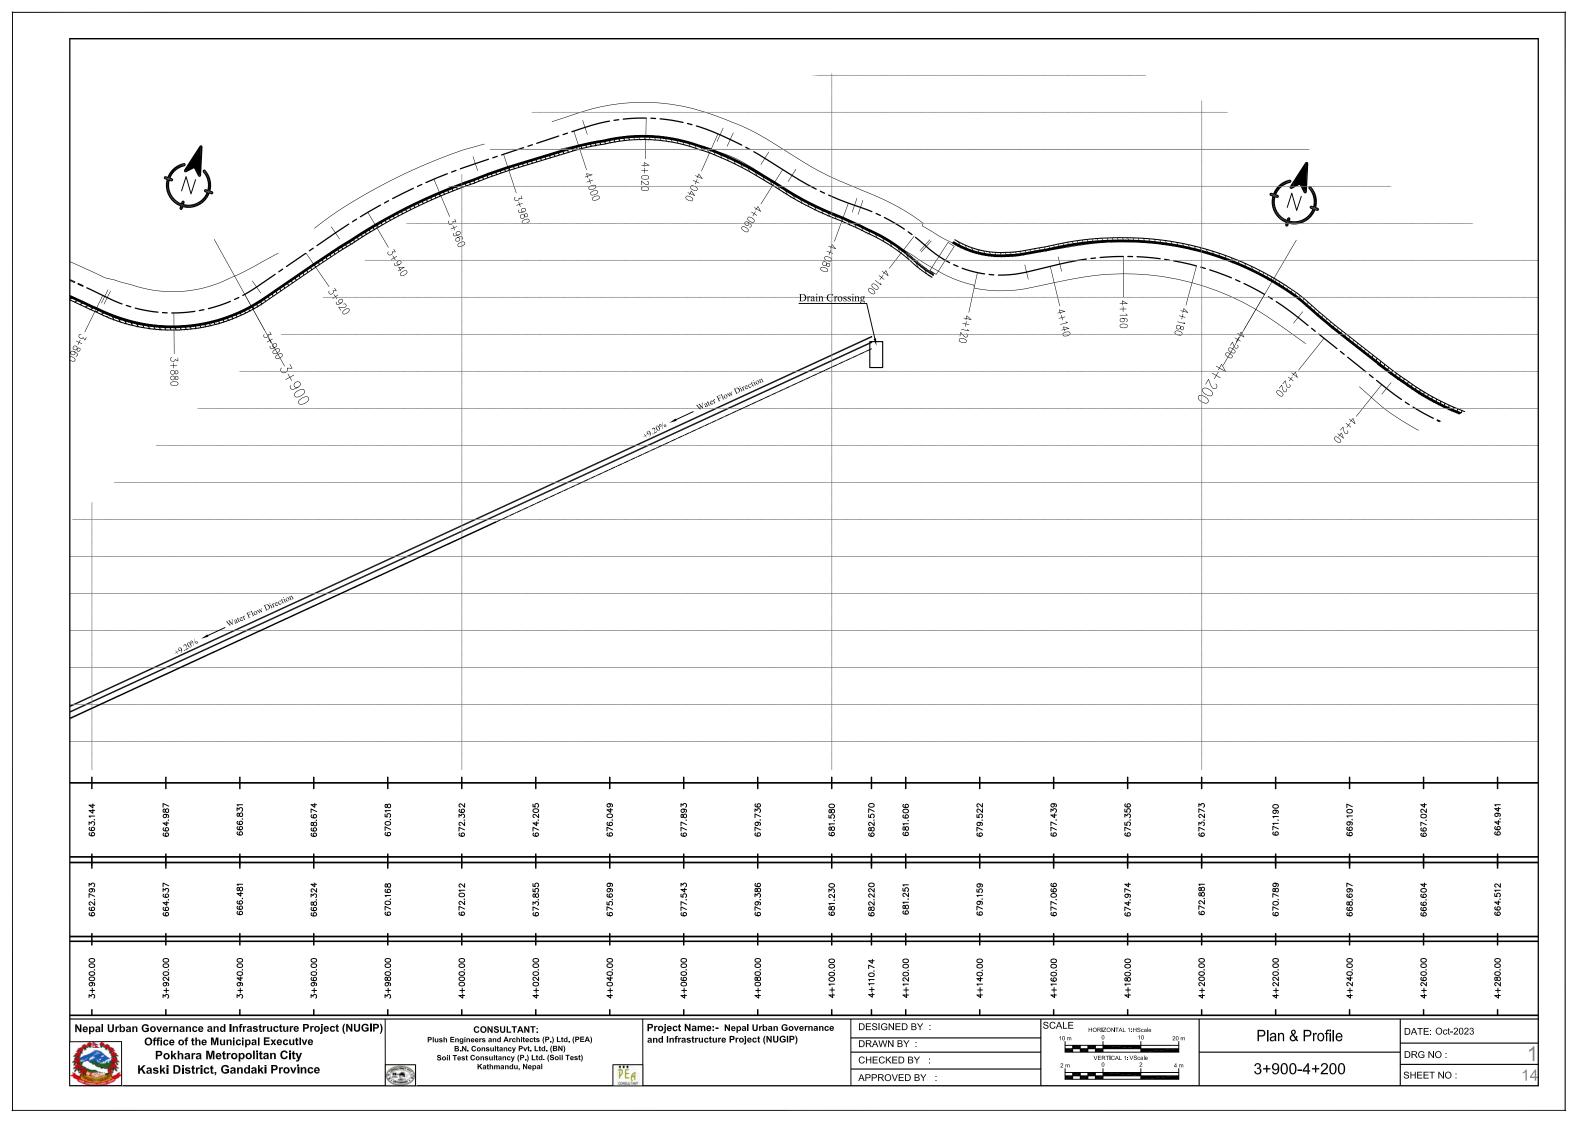


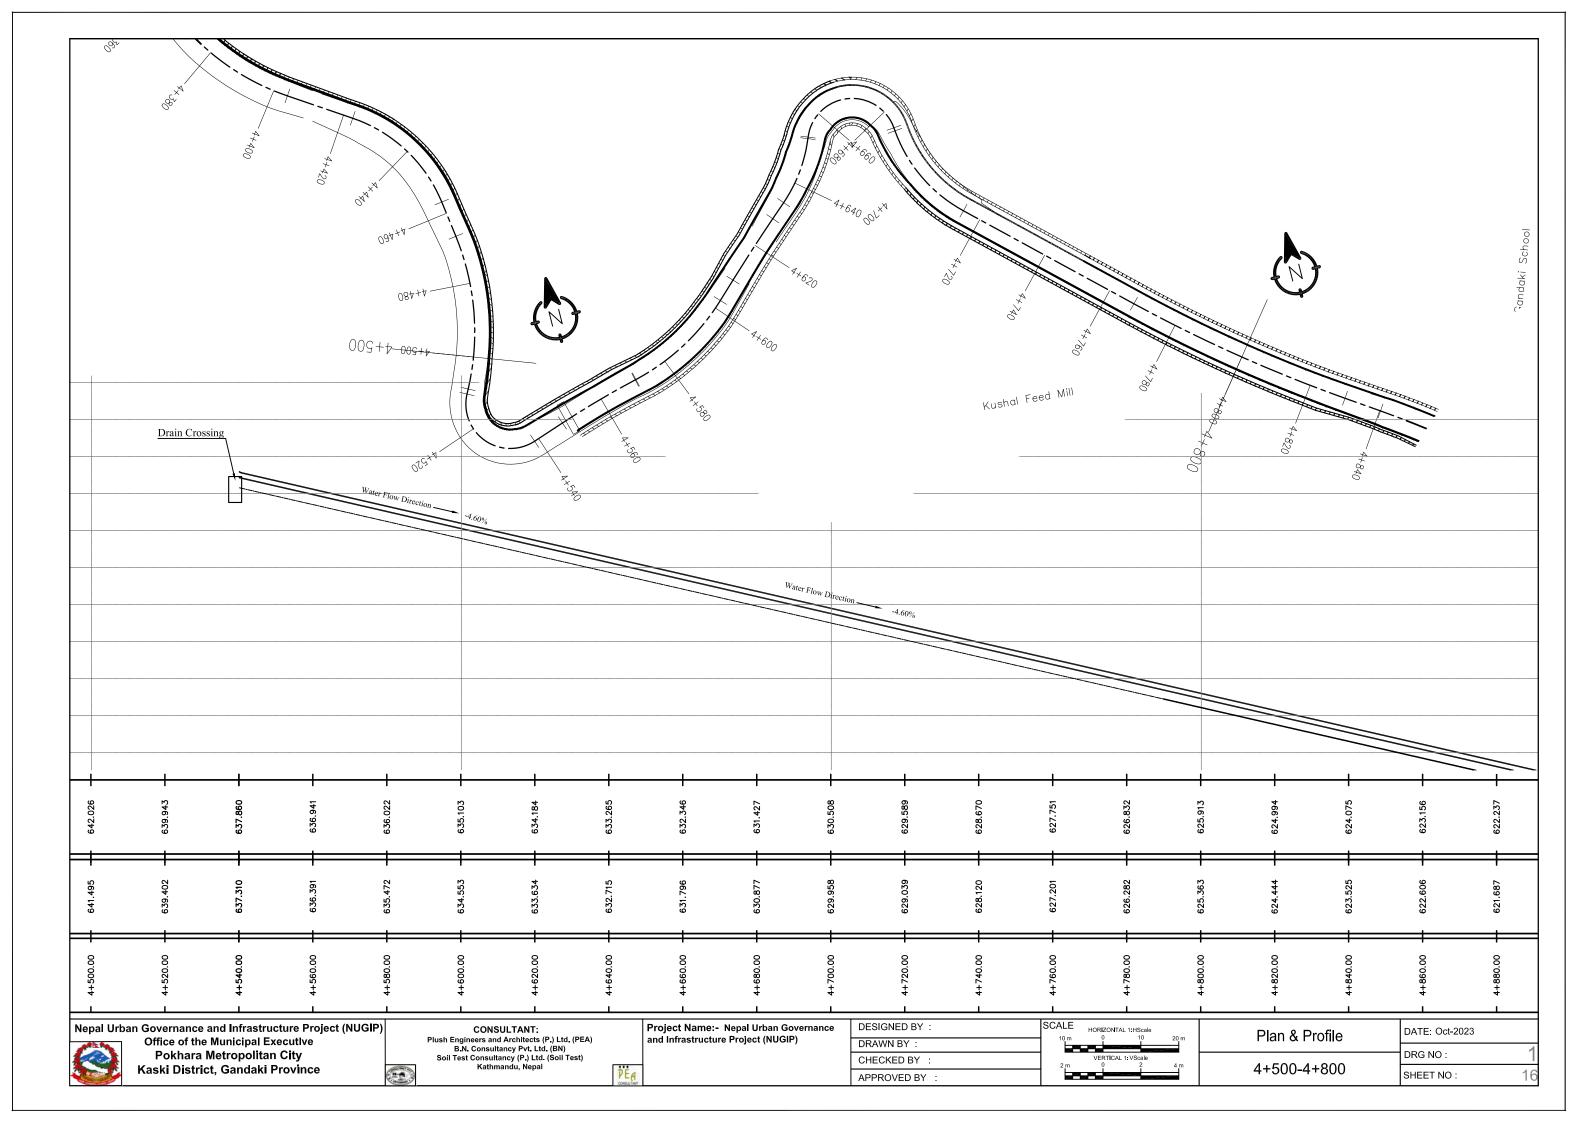


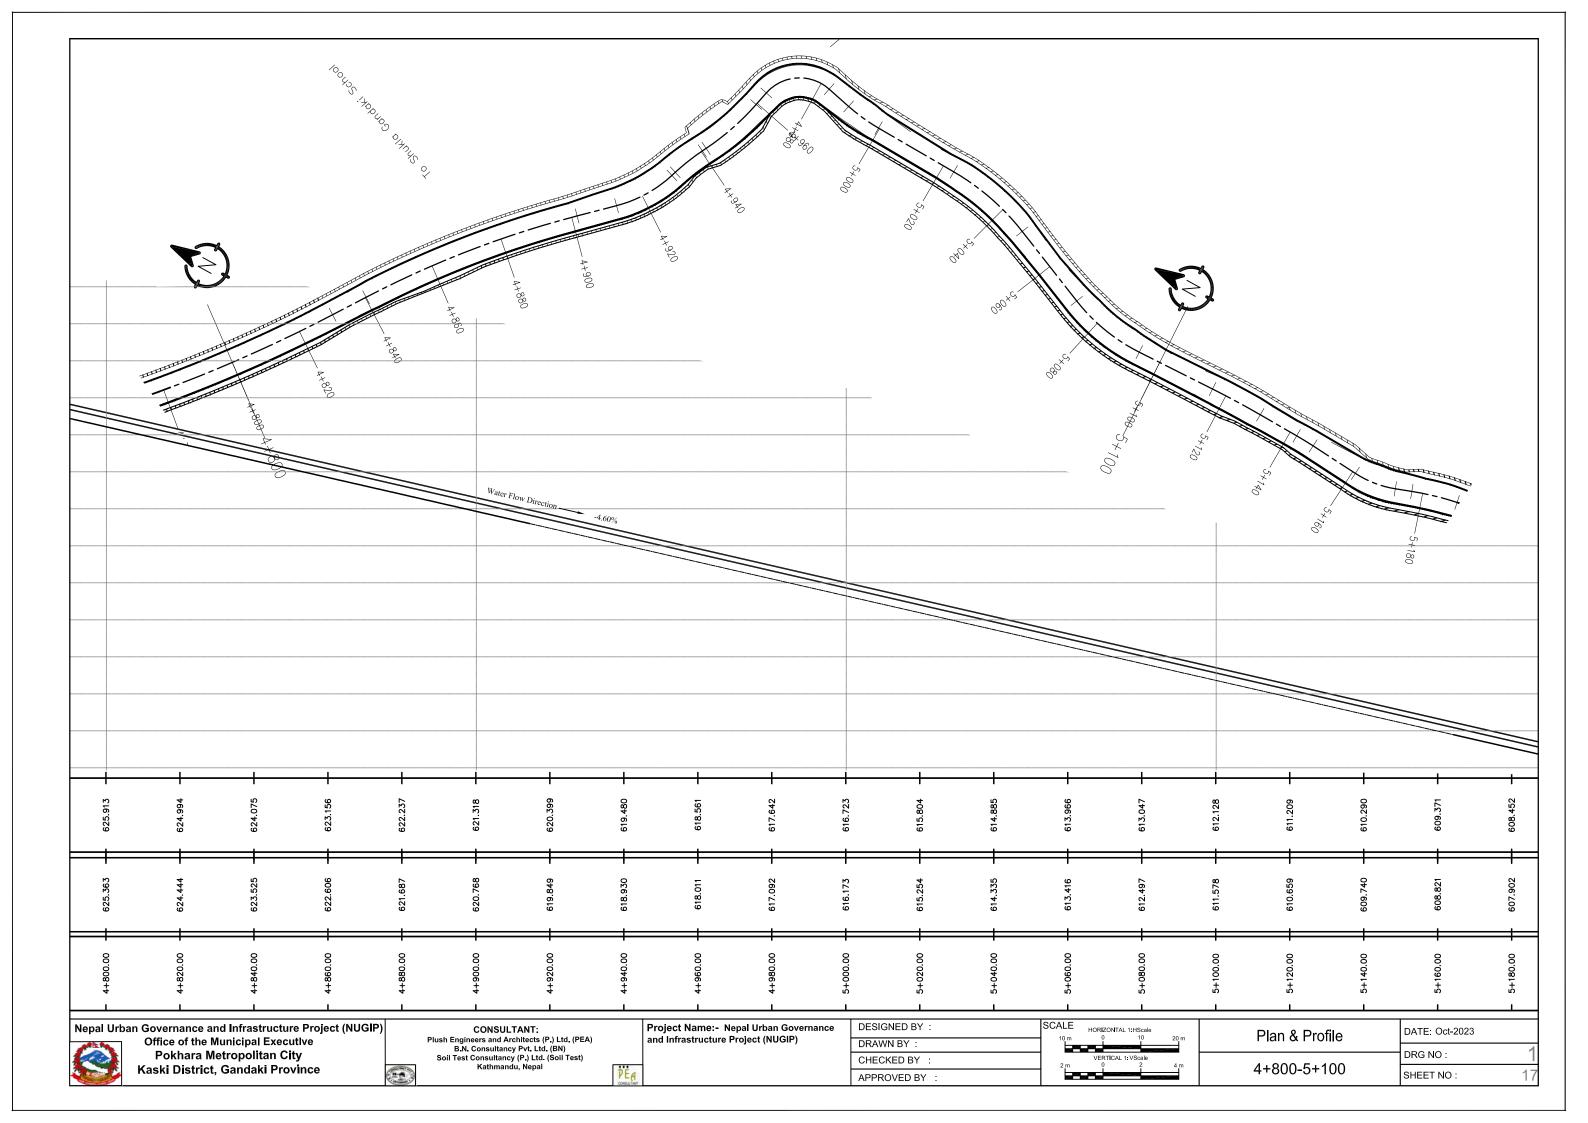


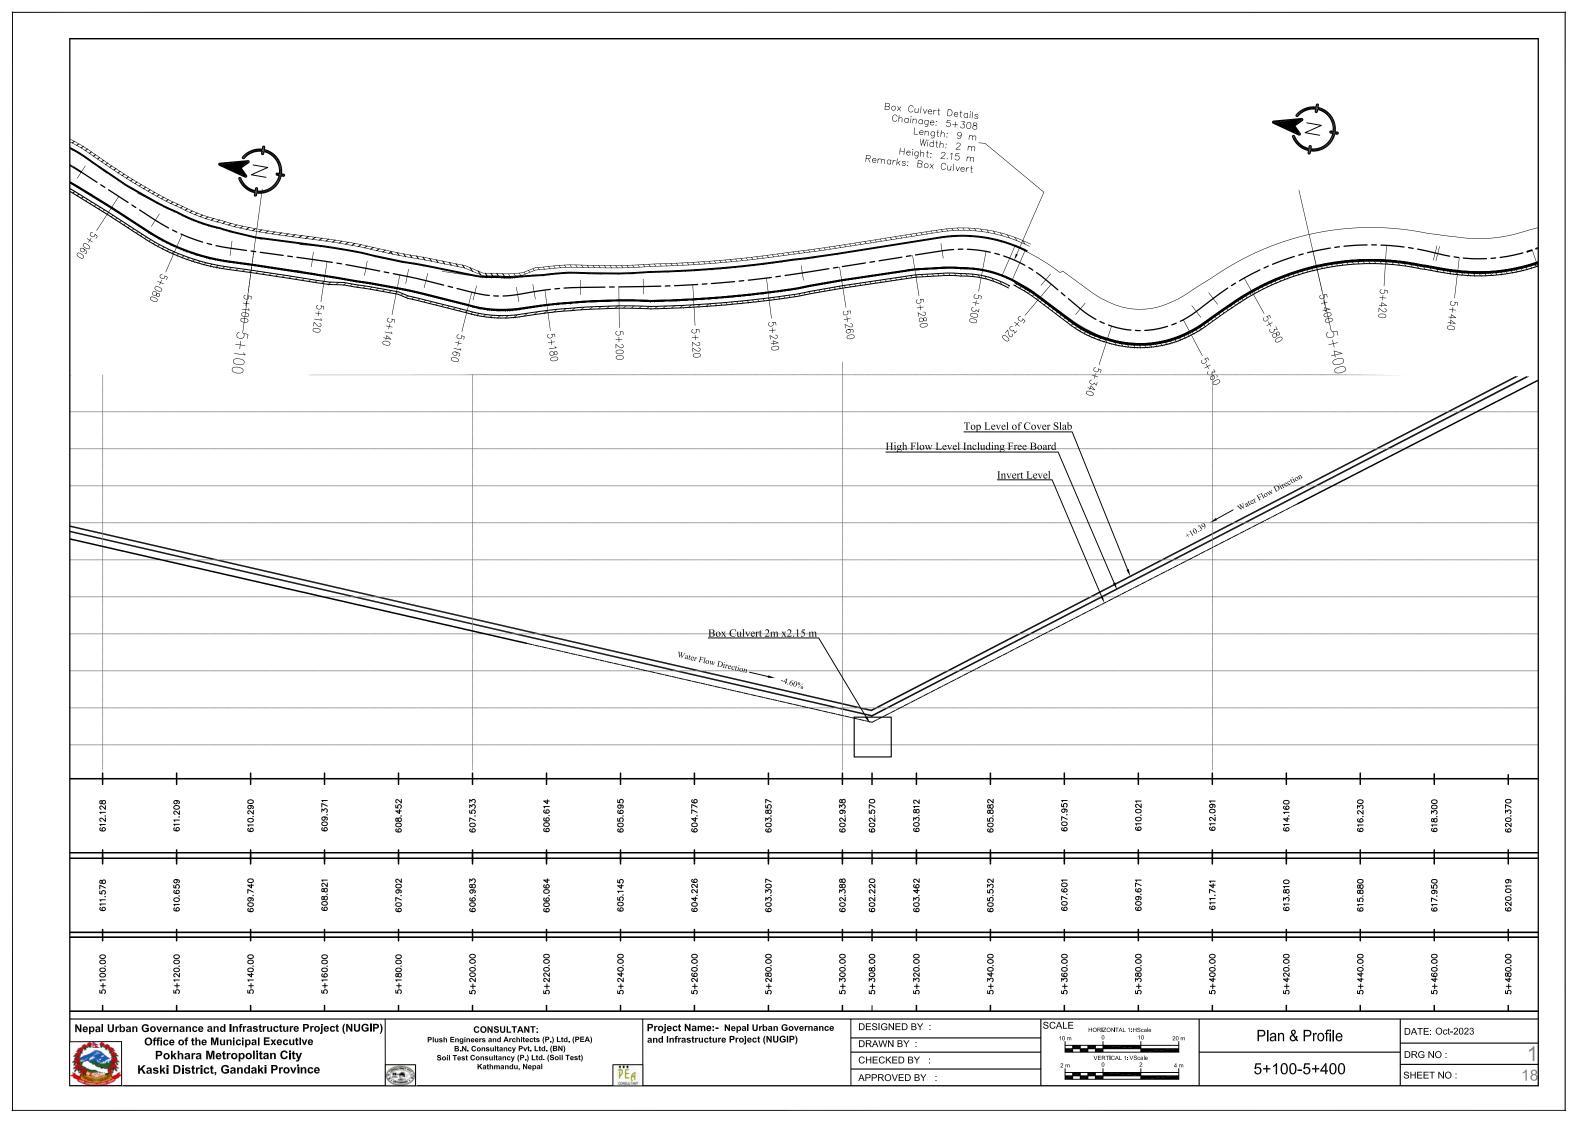


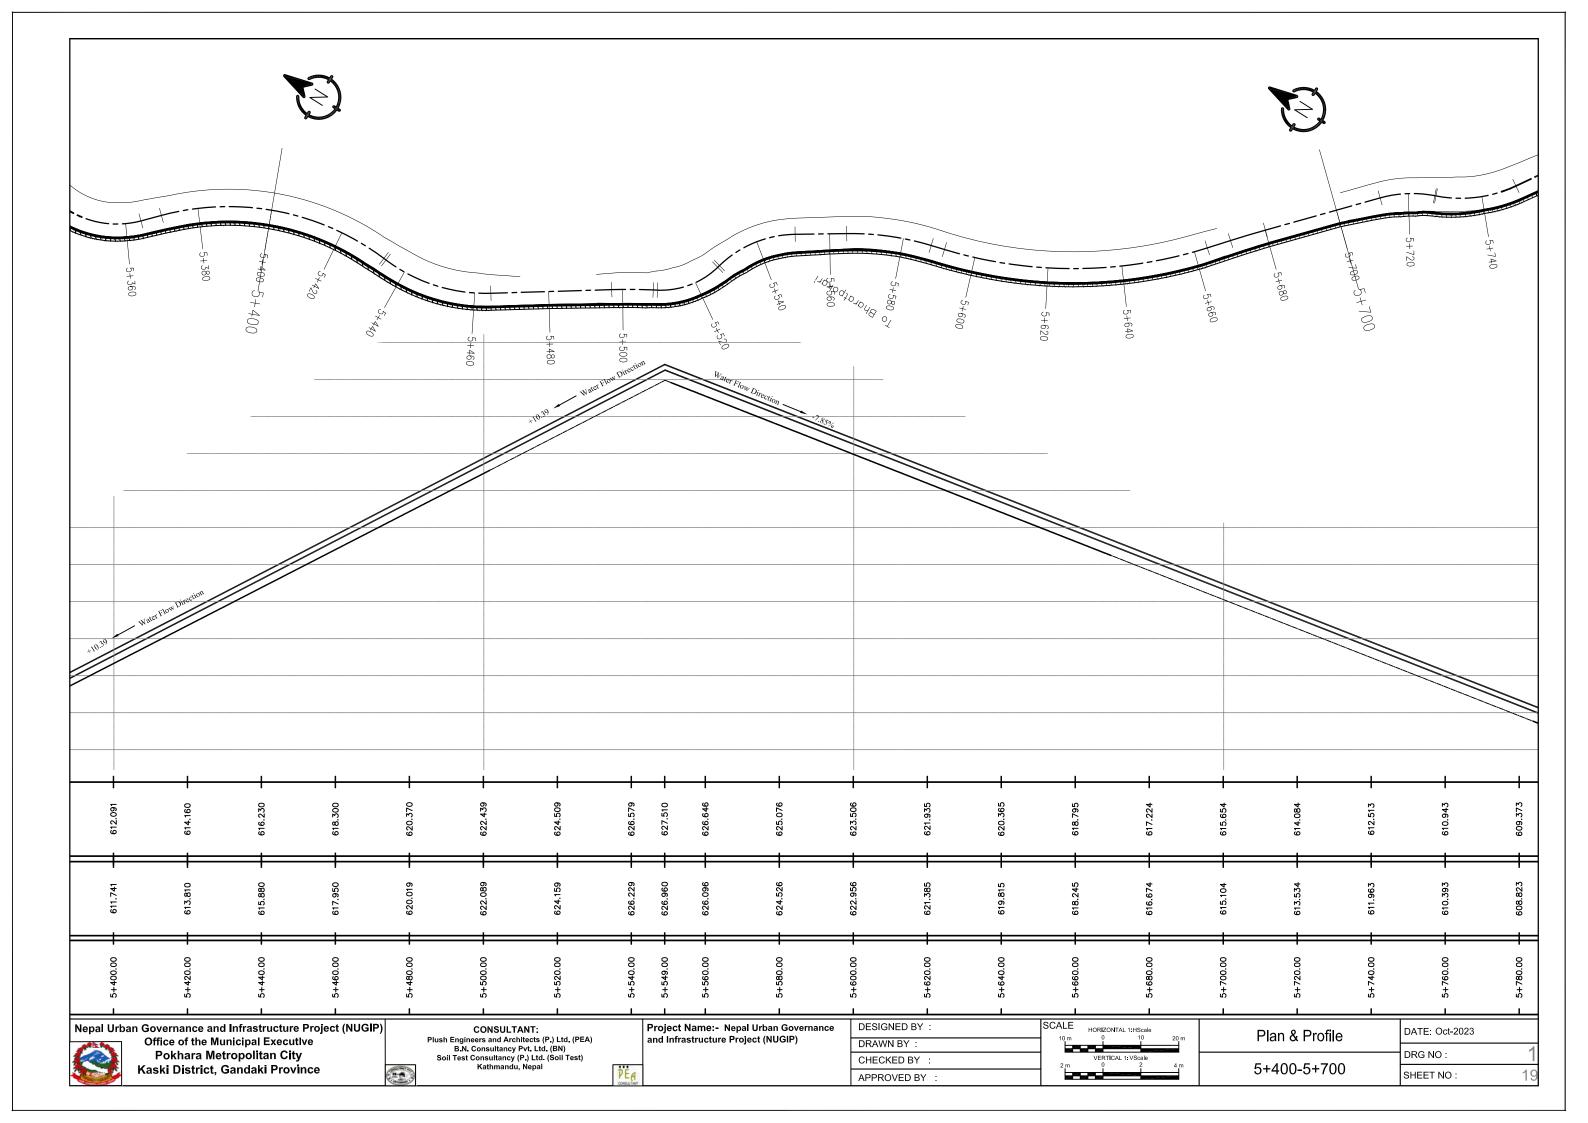


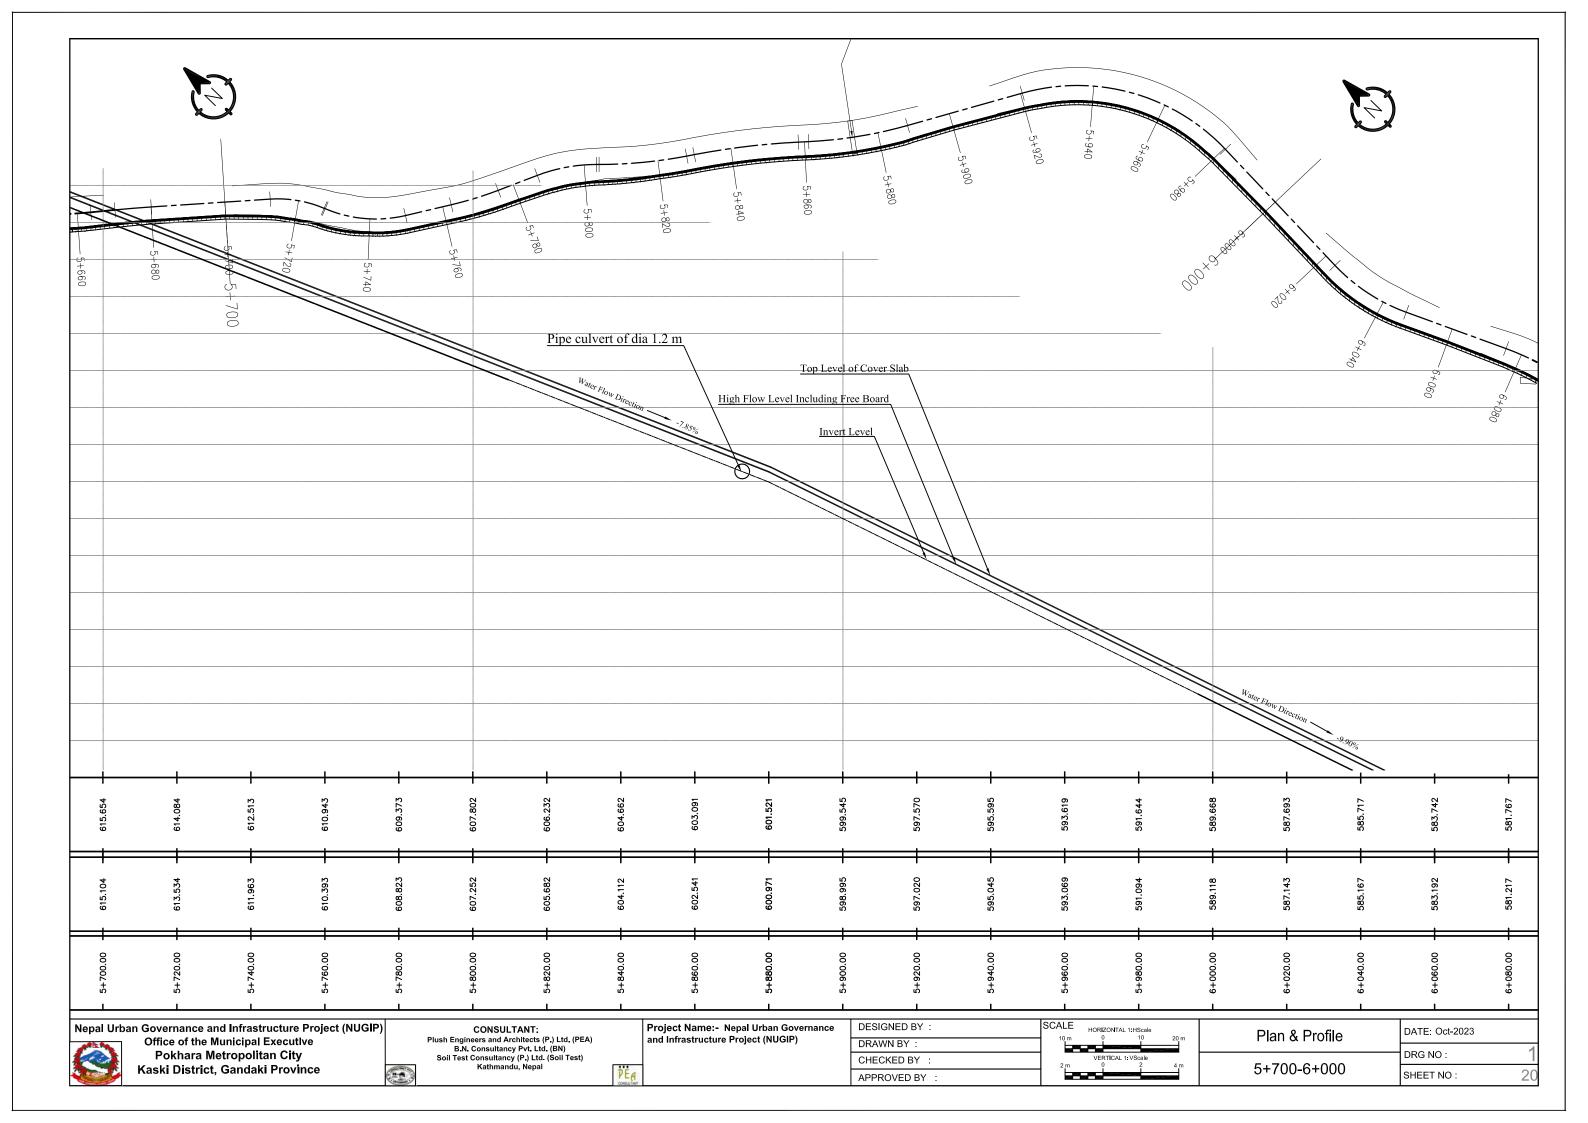


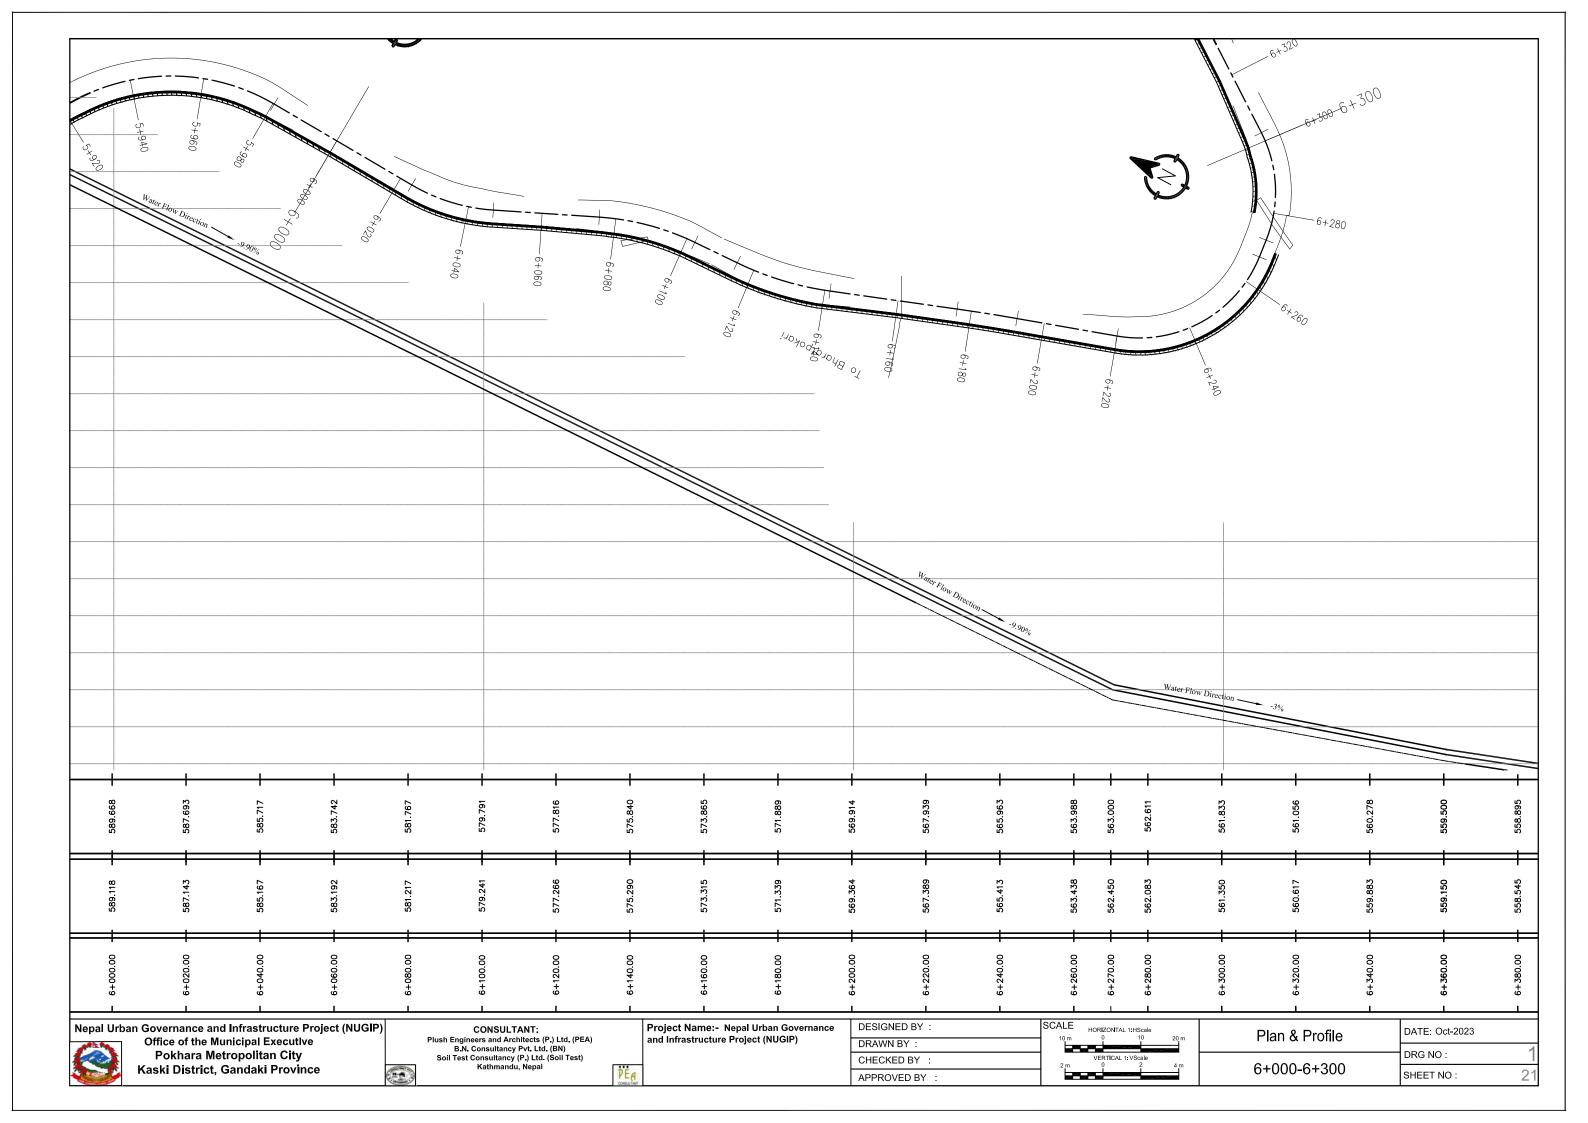


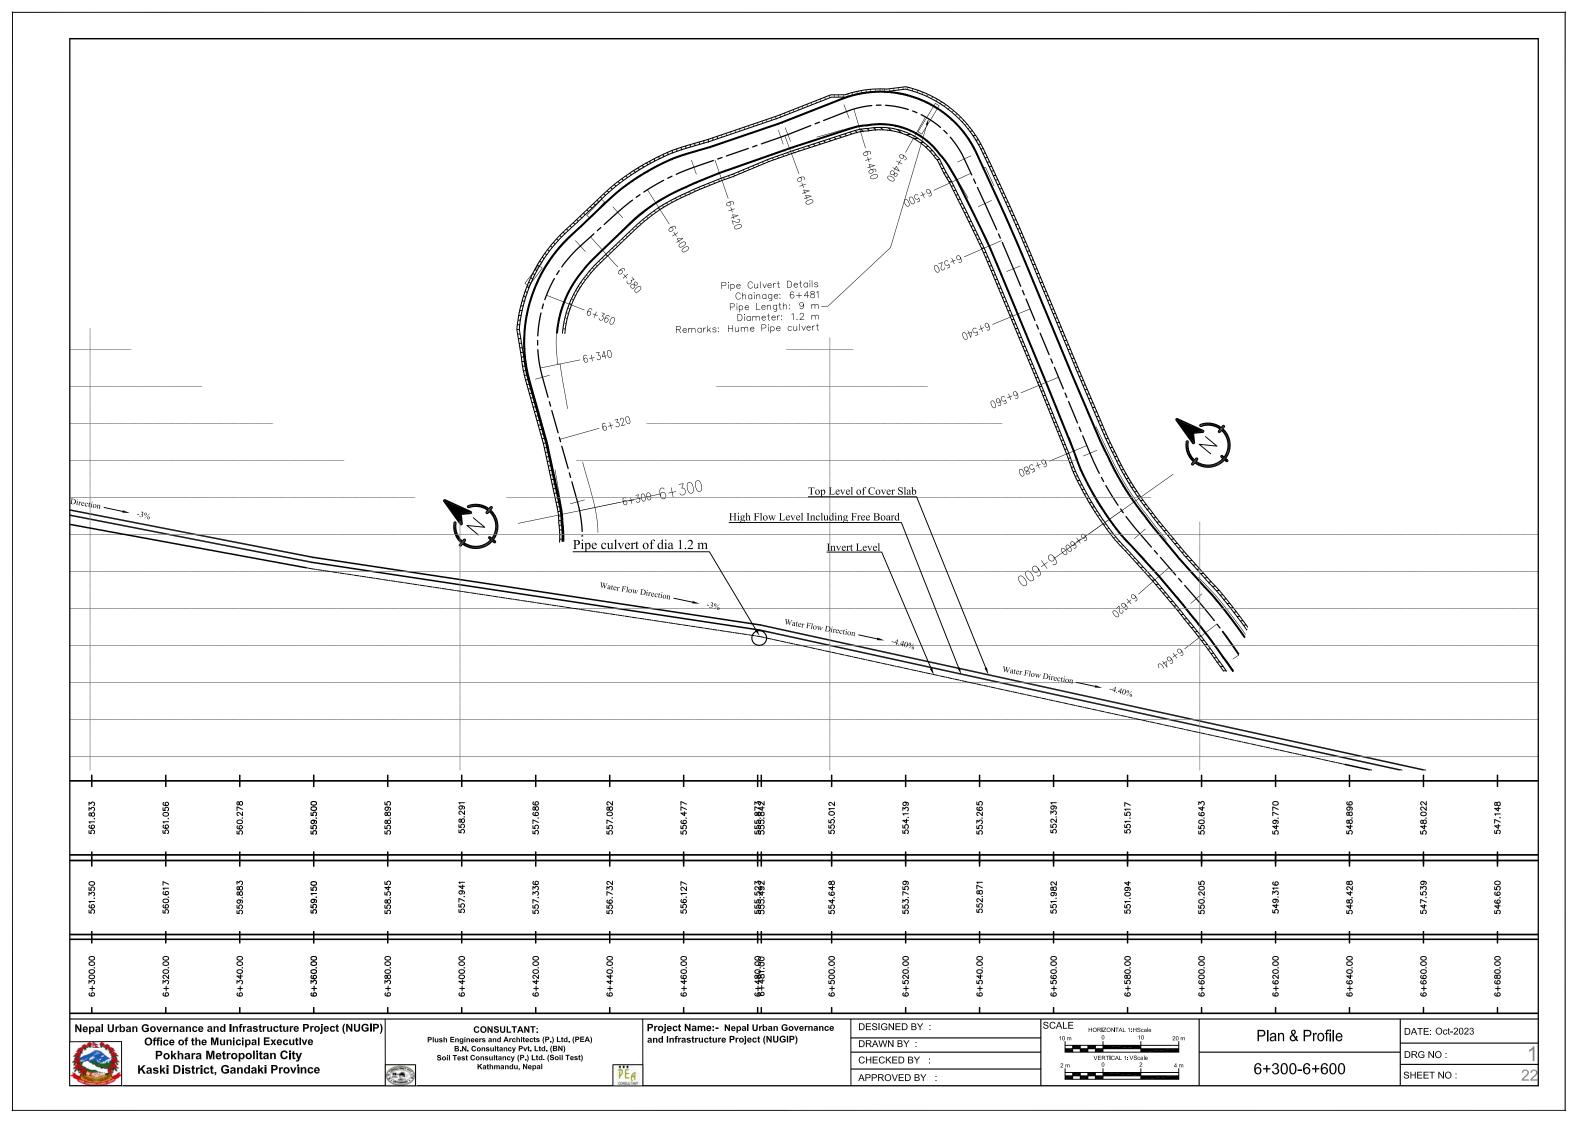


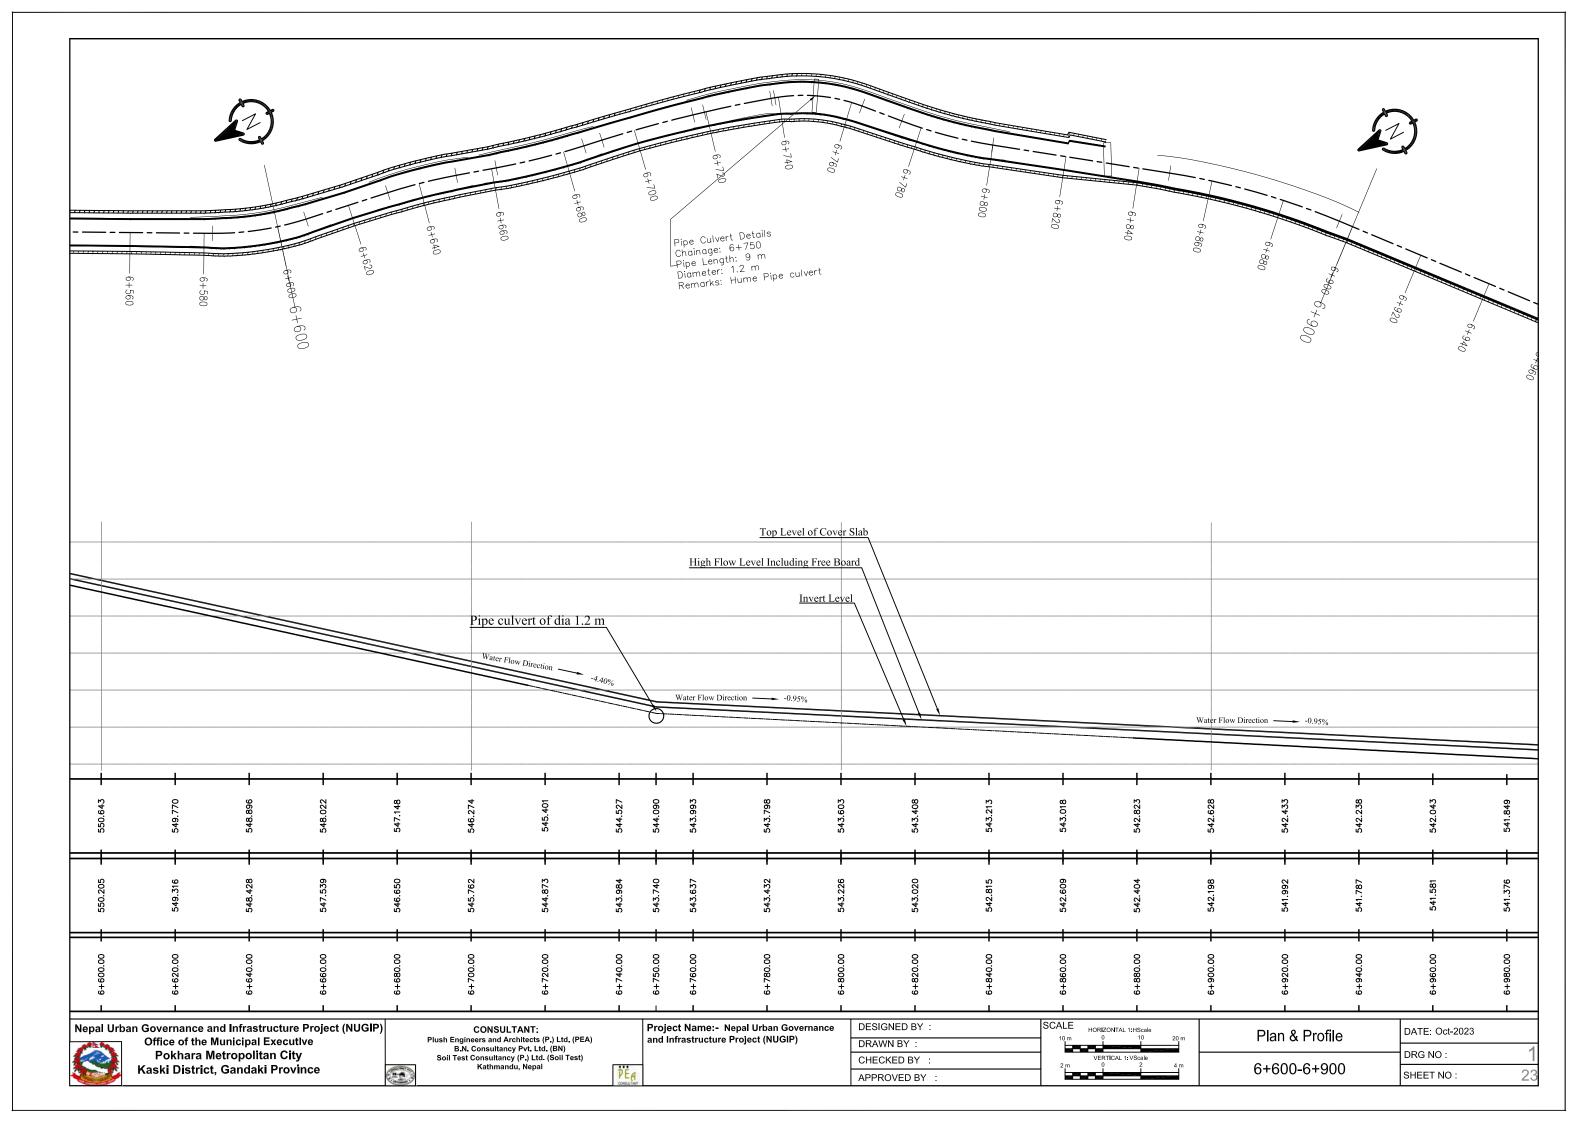


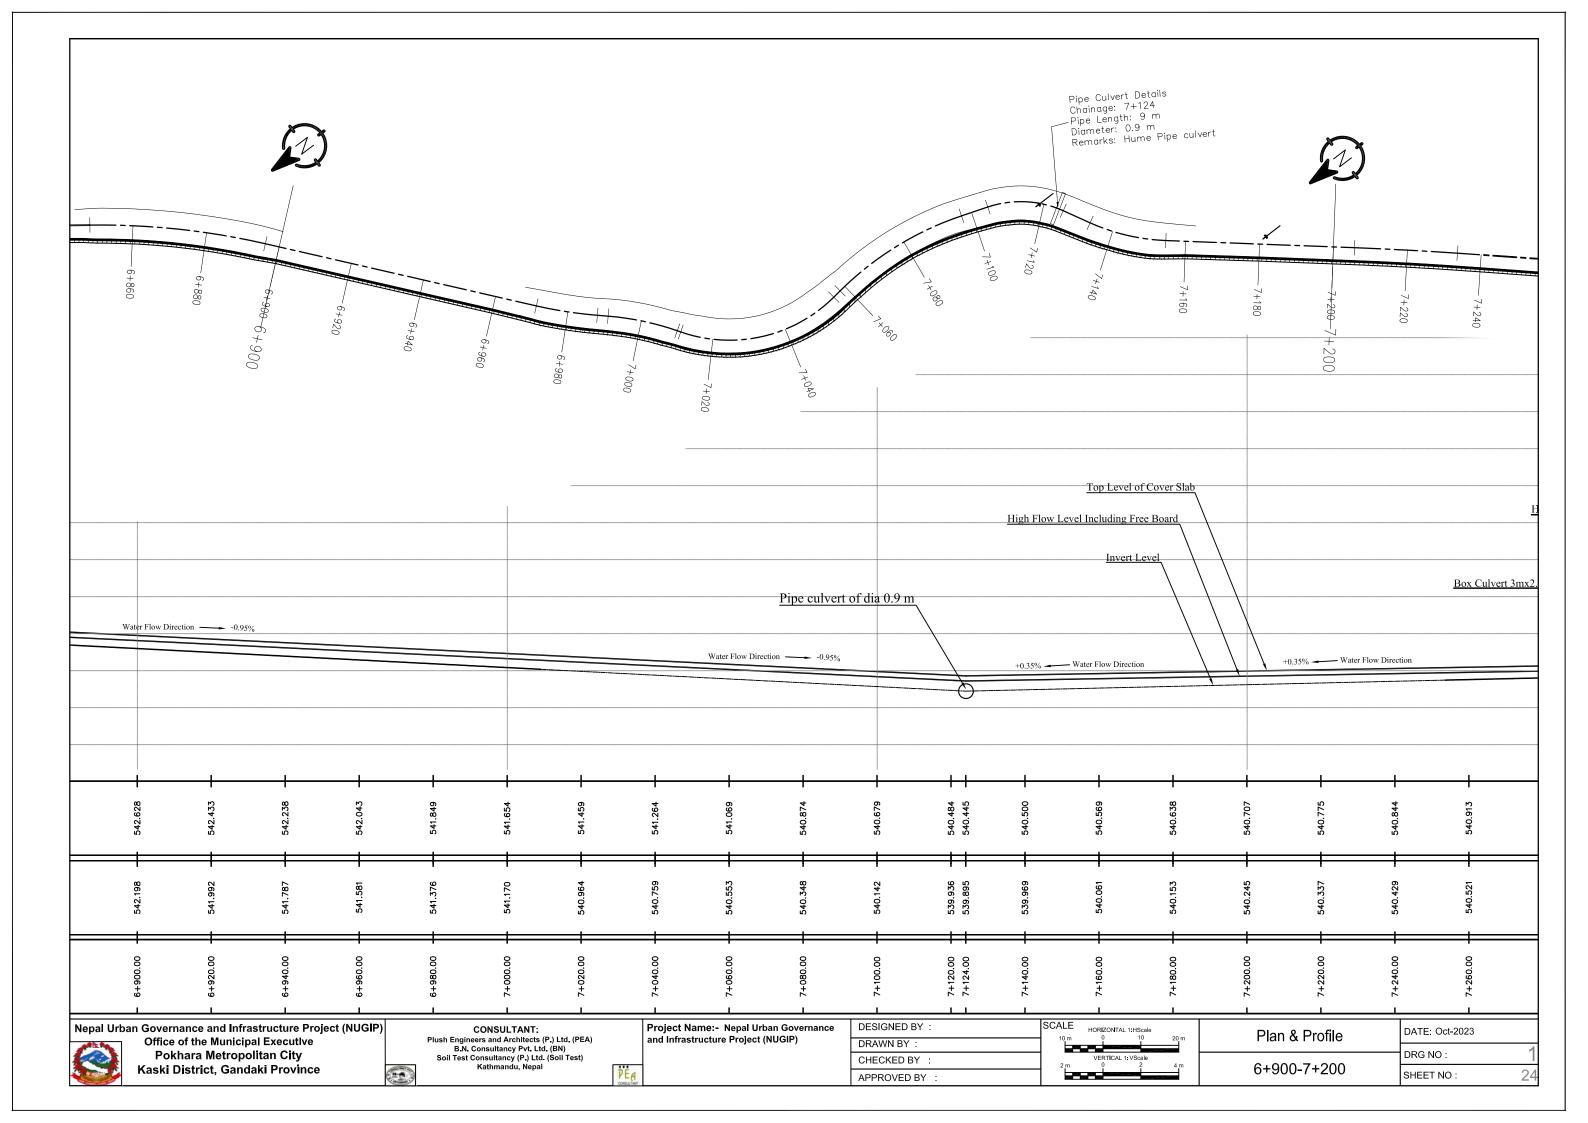


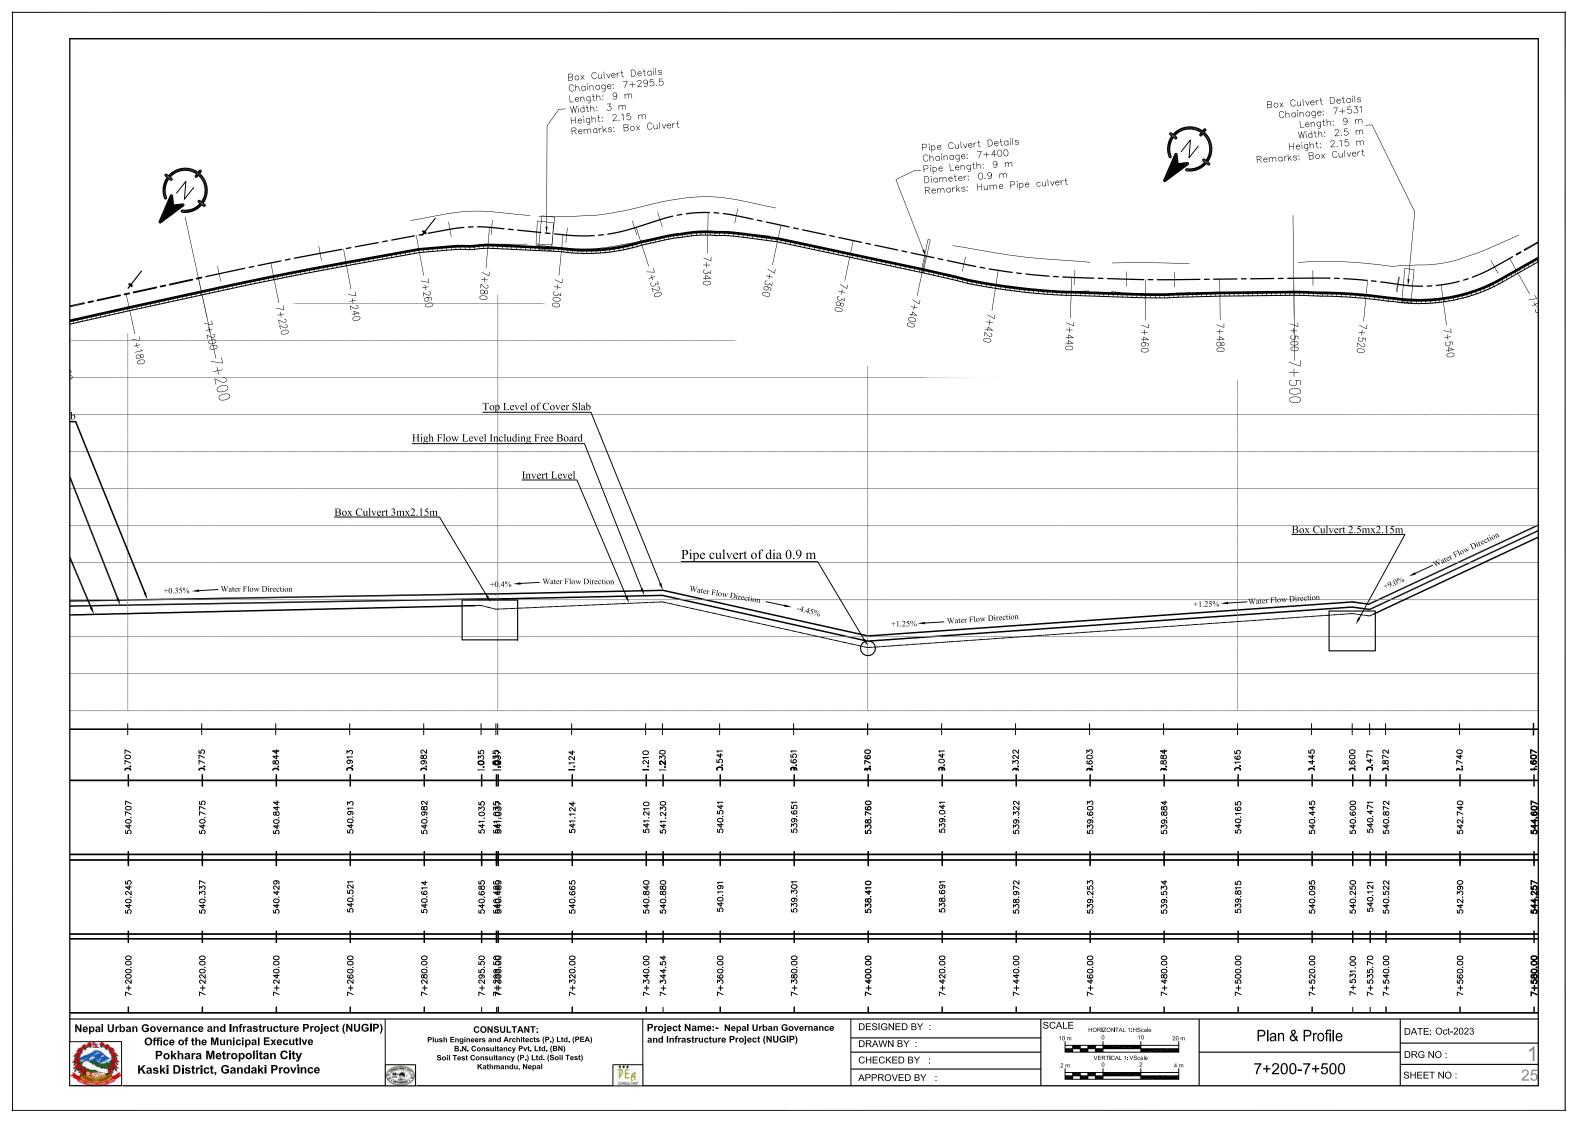


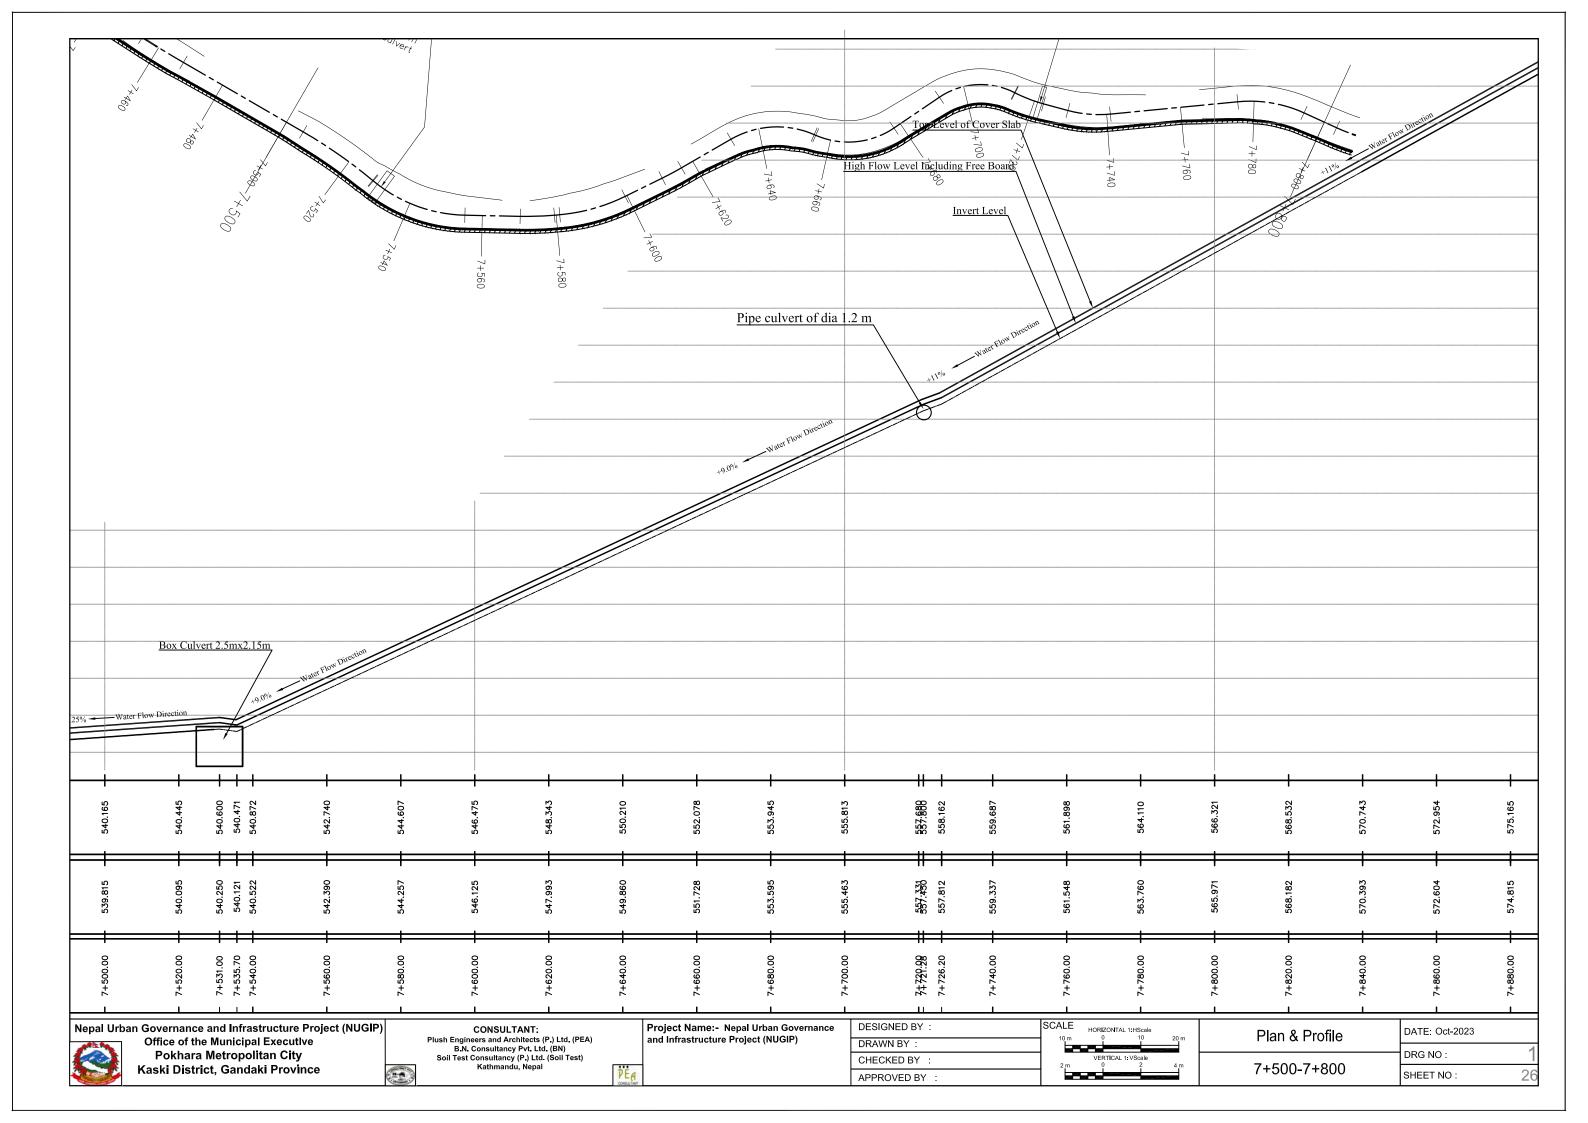


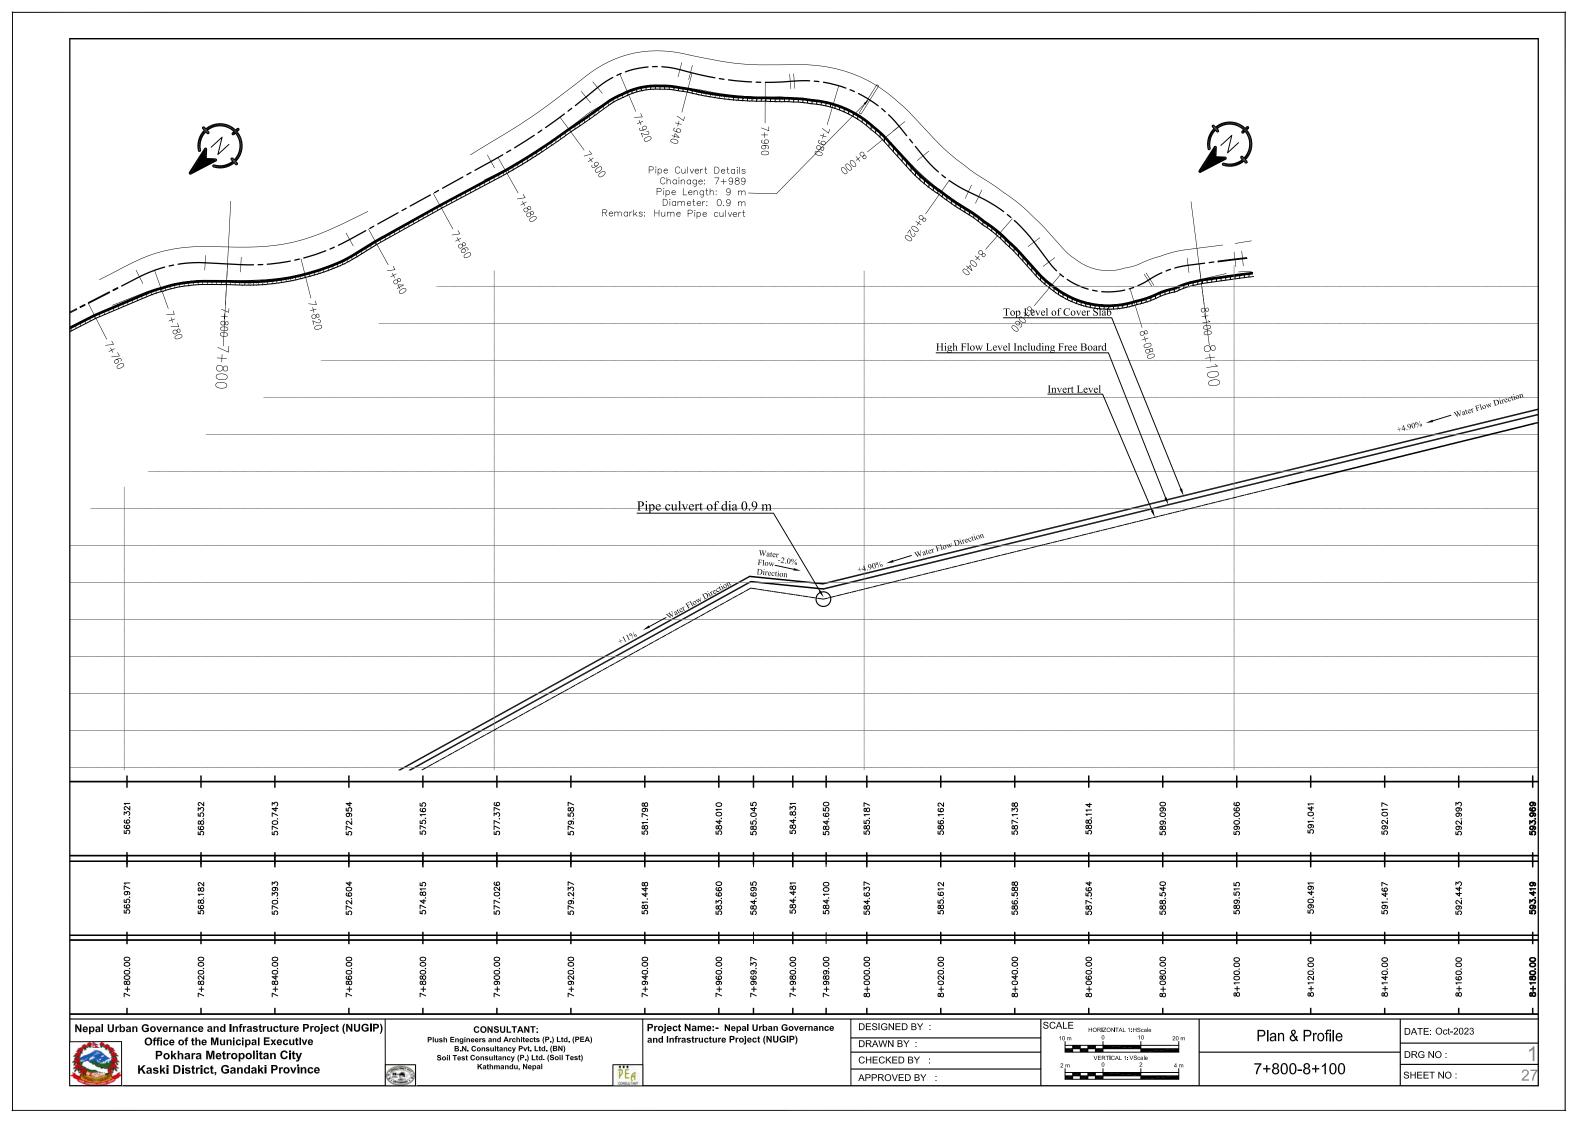


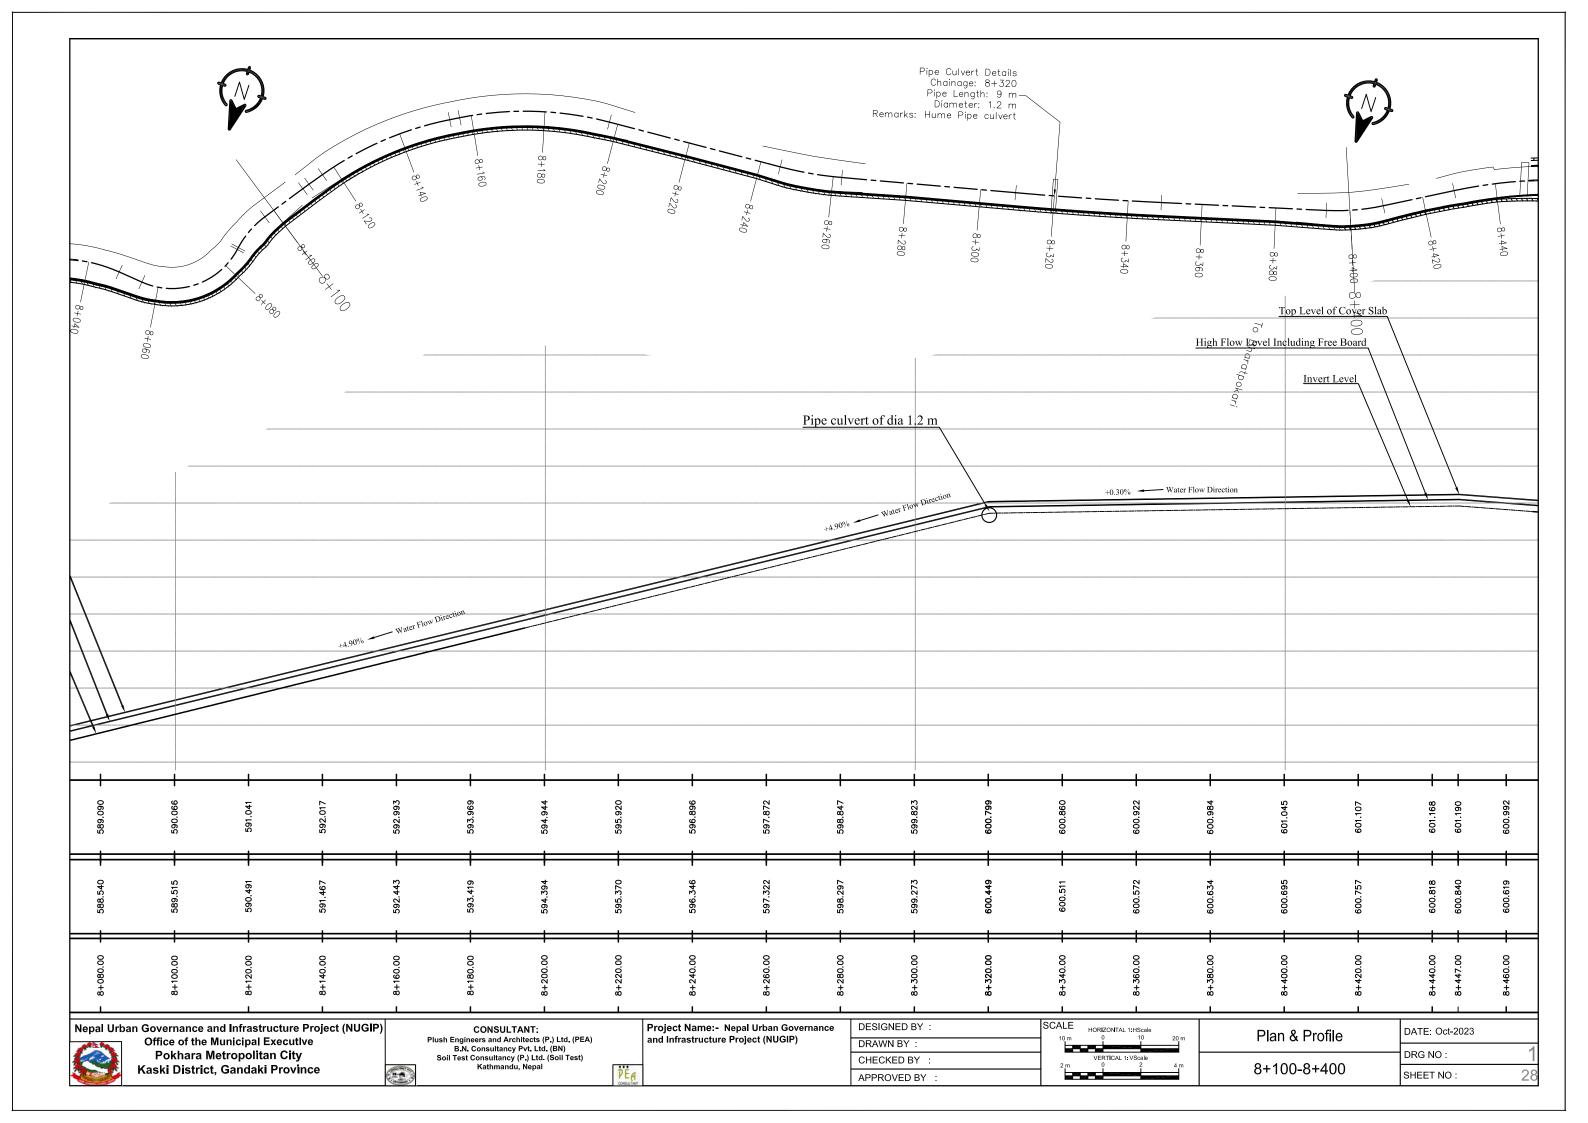


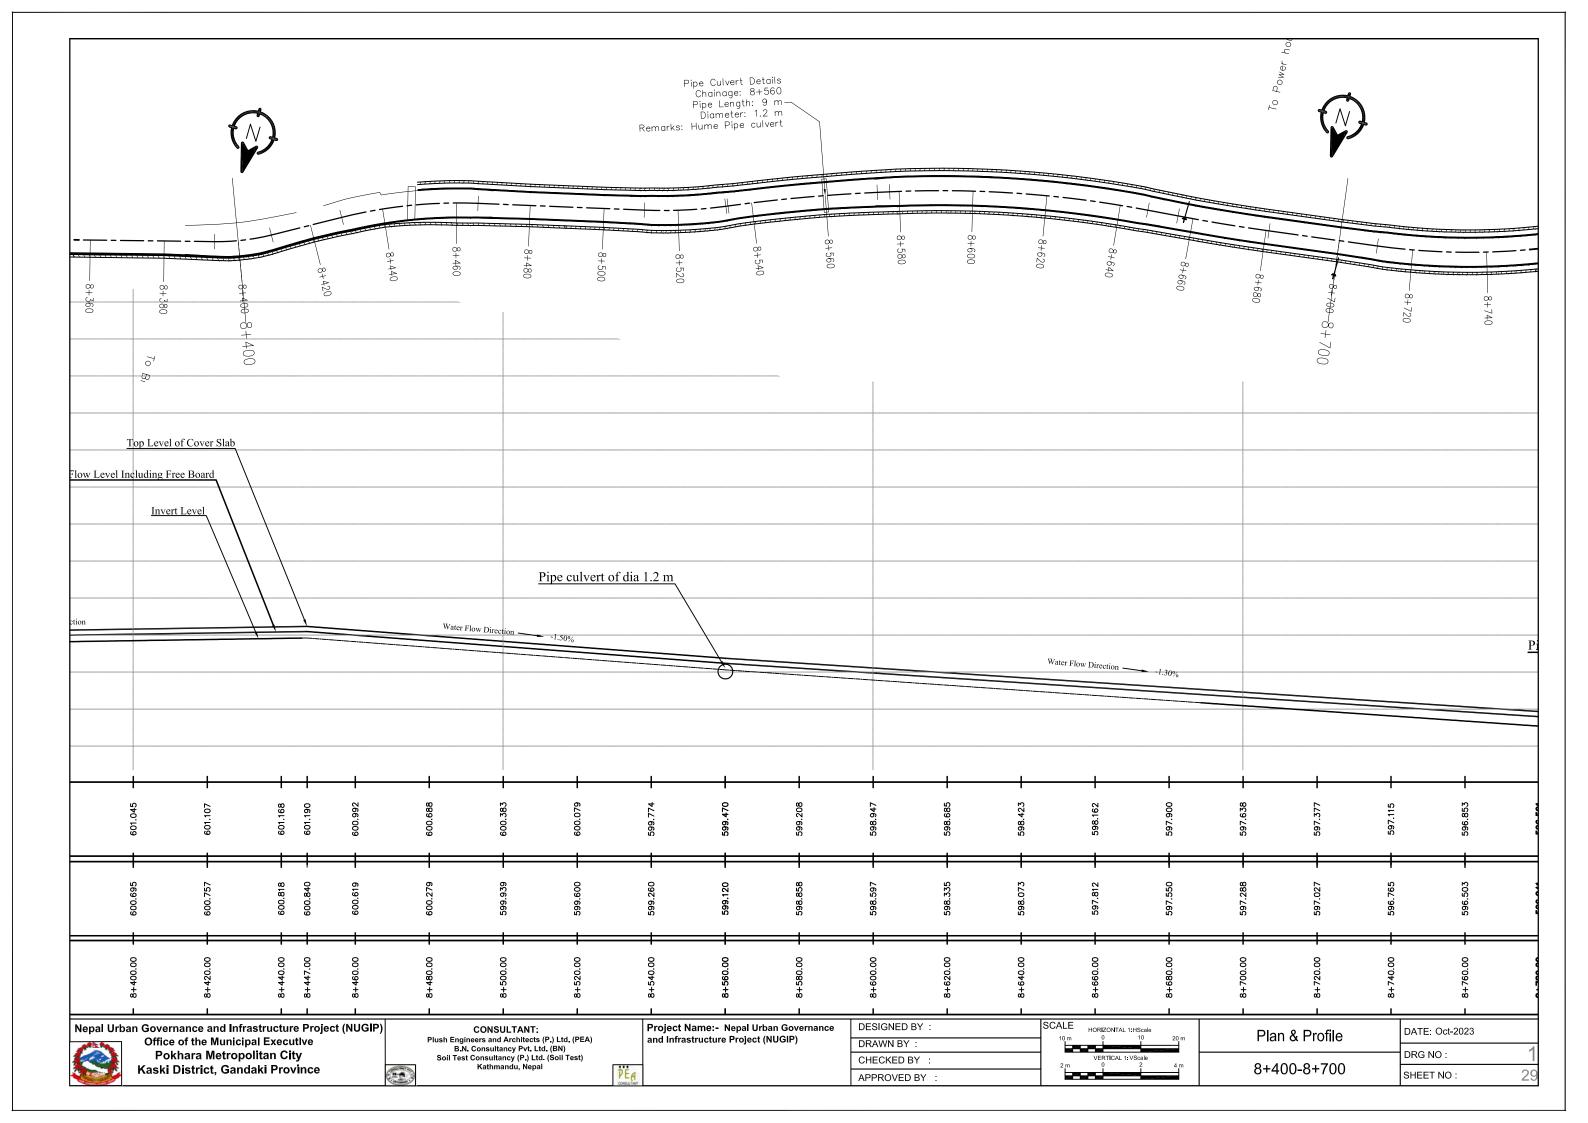

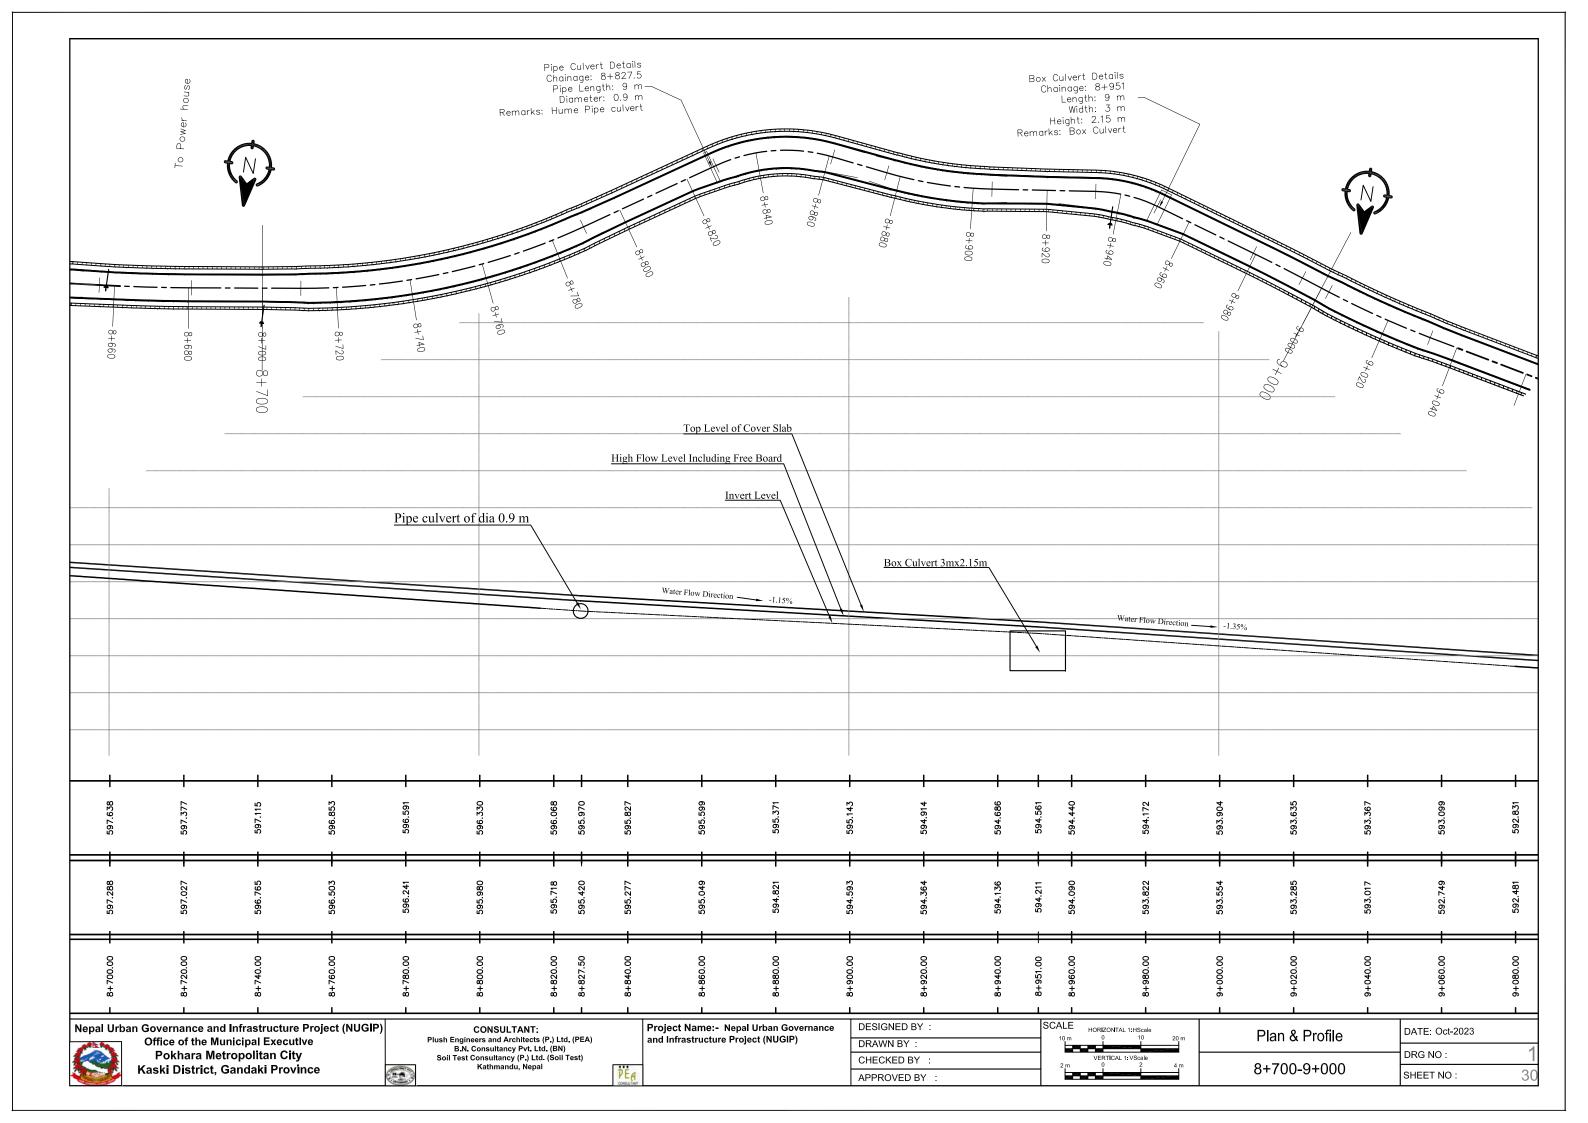

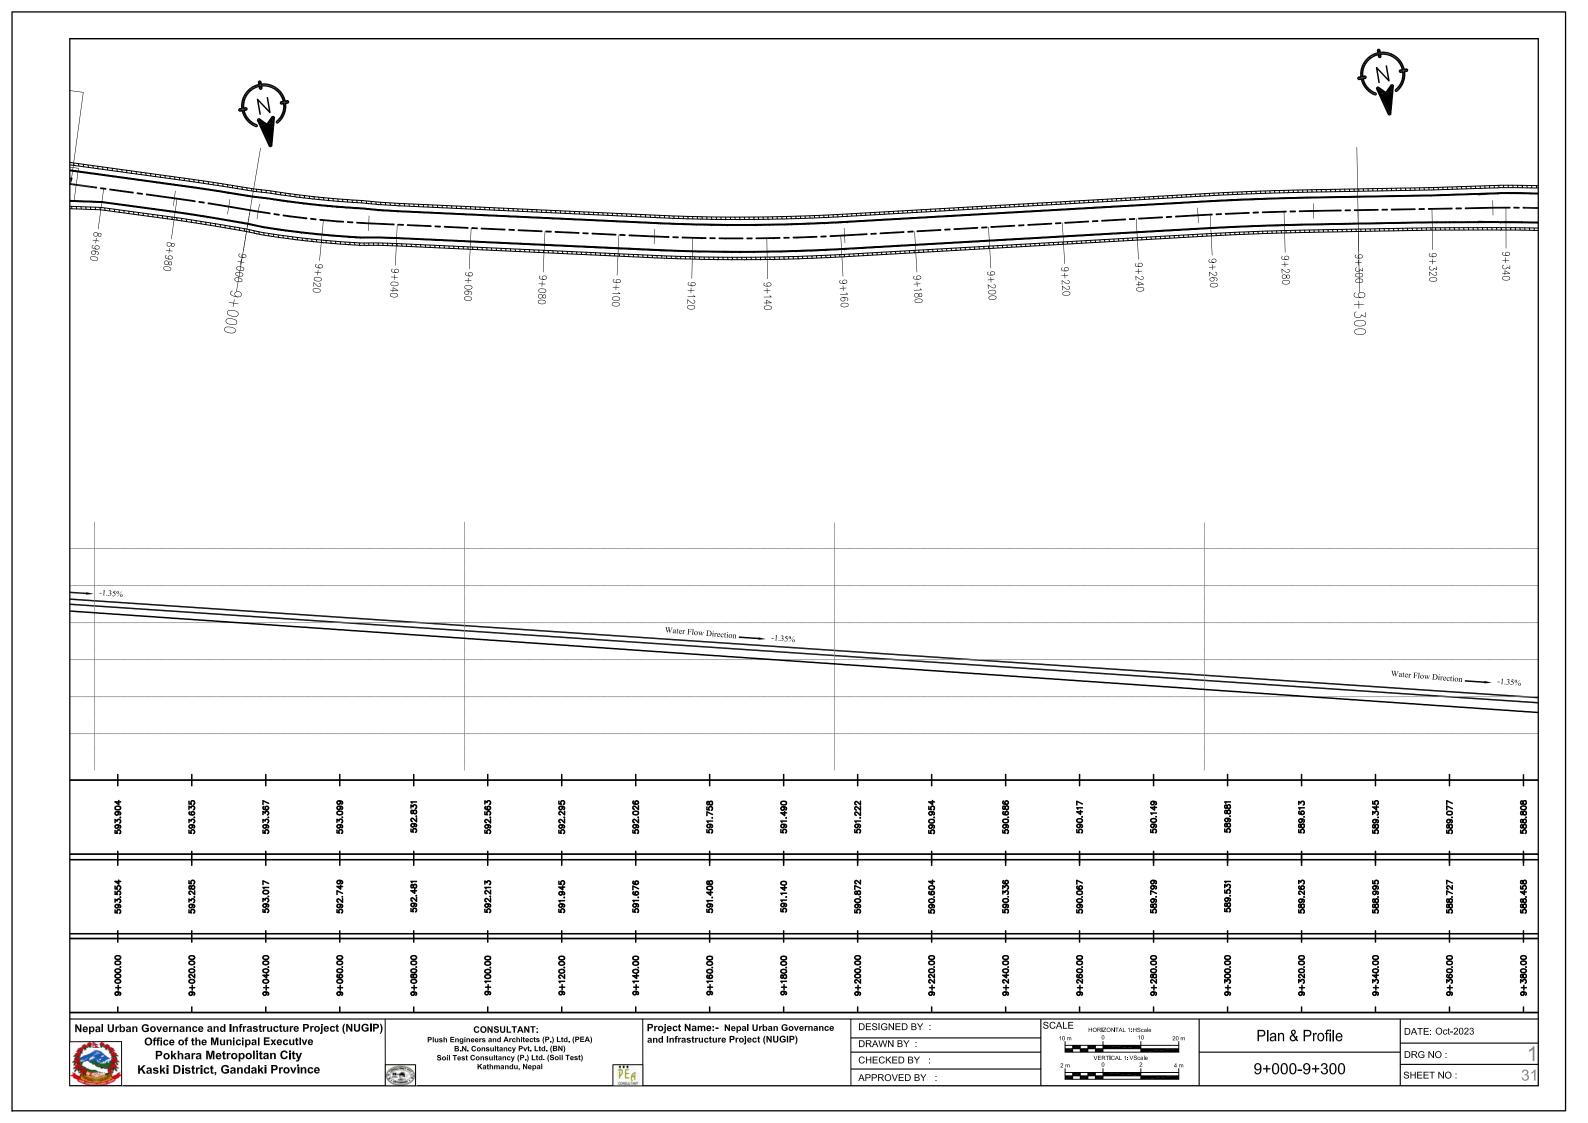

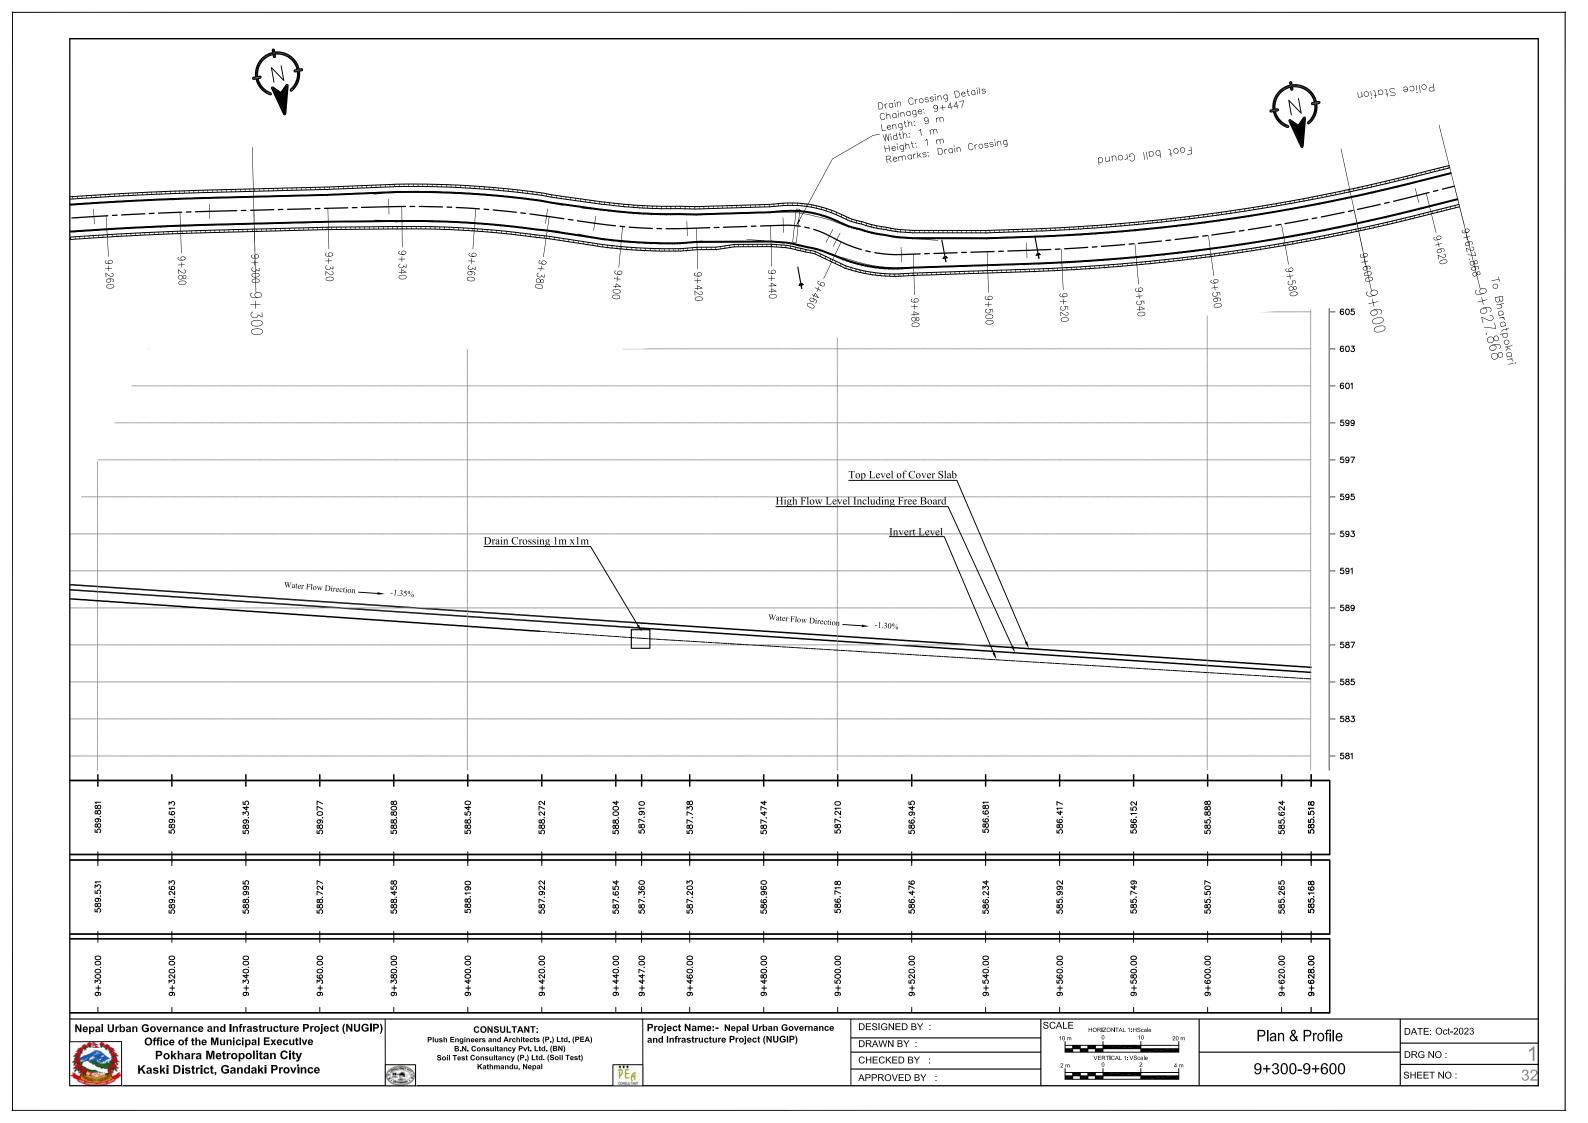

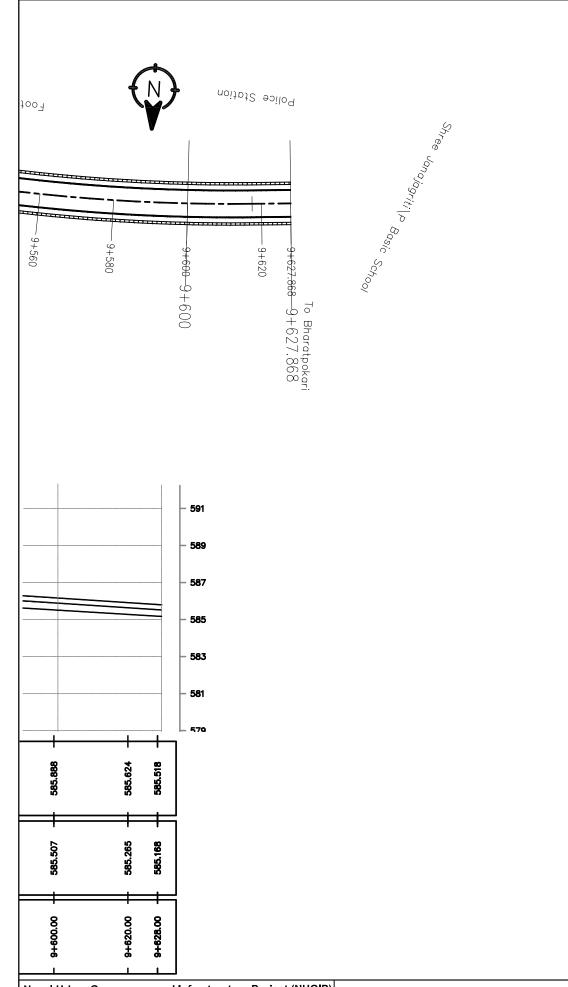

Nepal Urban Governance and Infrastructure Project (NUGIP)


Office of the Municipal Executive
Pokhara Metropolitan City
Kaski District, Gandaki Province


CONSULTANT:
Plush Engineers and Architects (P.) Ltd. (PEA)
B.N. Consultancy Pvt. Ltd. (BN)
Soil Test Consultancy (P.) Ltd. (Soil Test)
Kathmandu, Nepal


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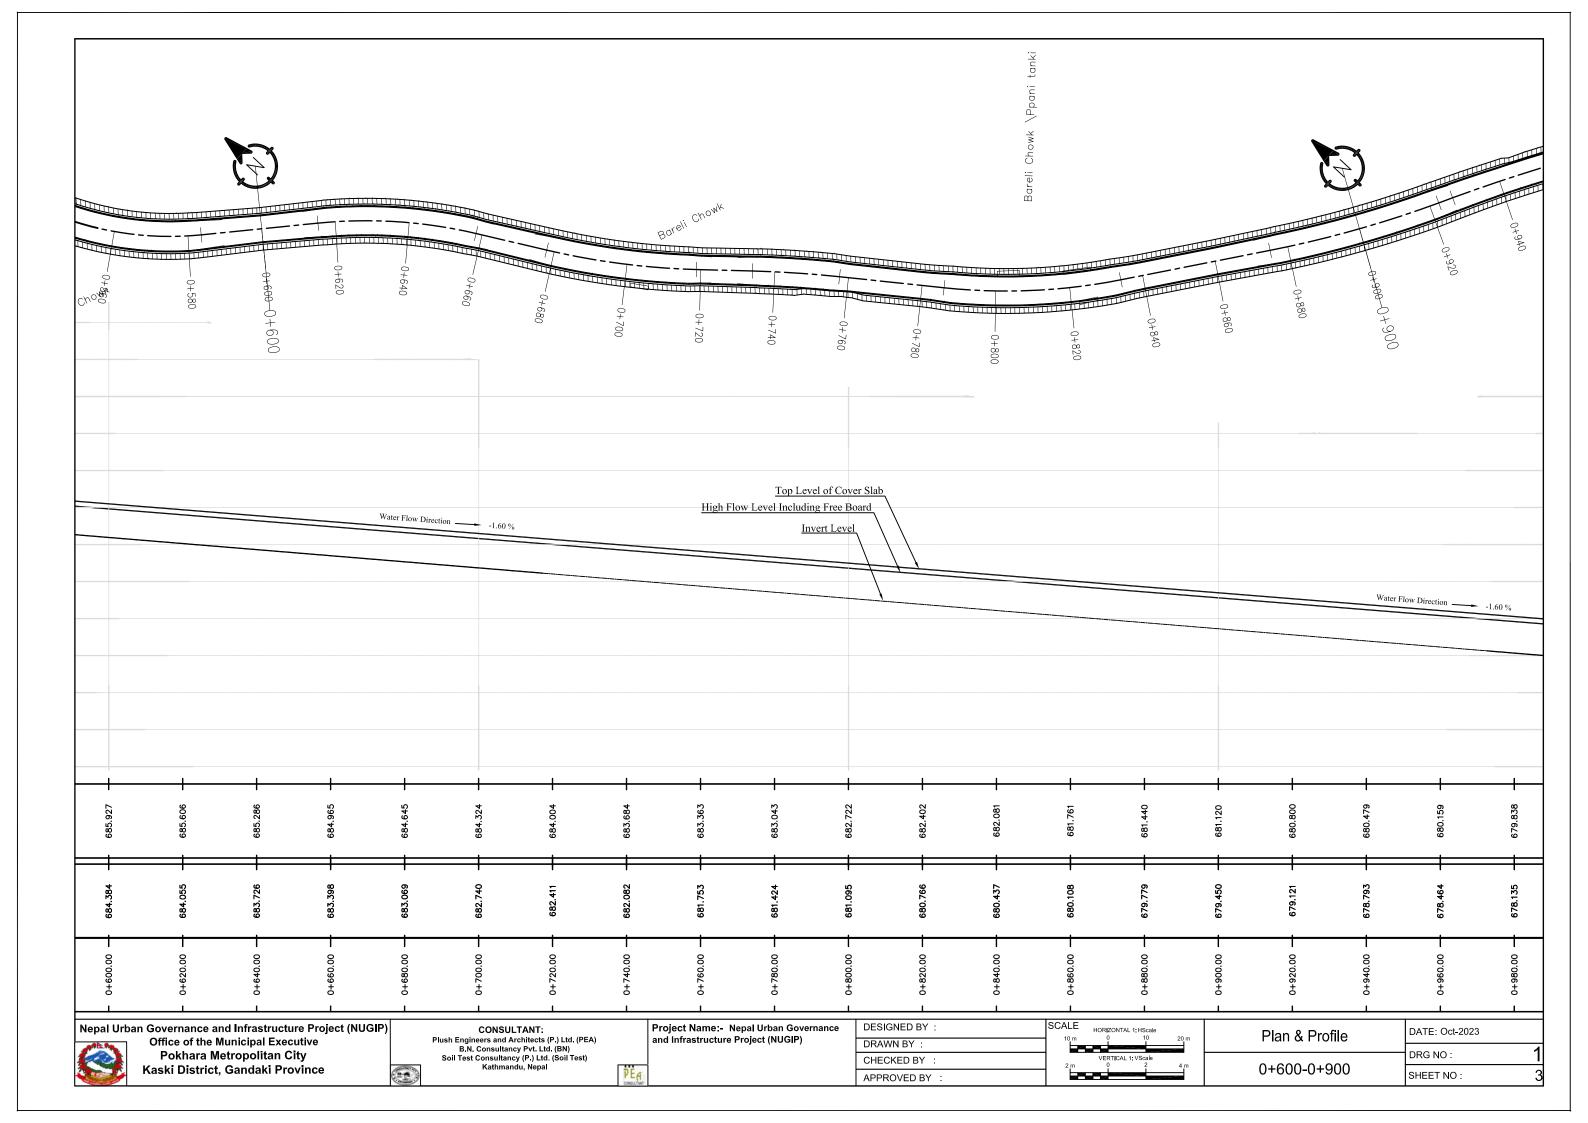
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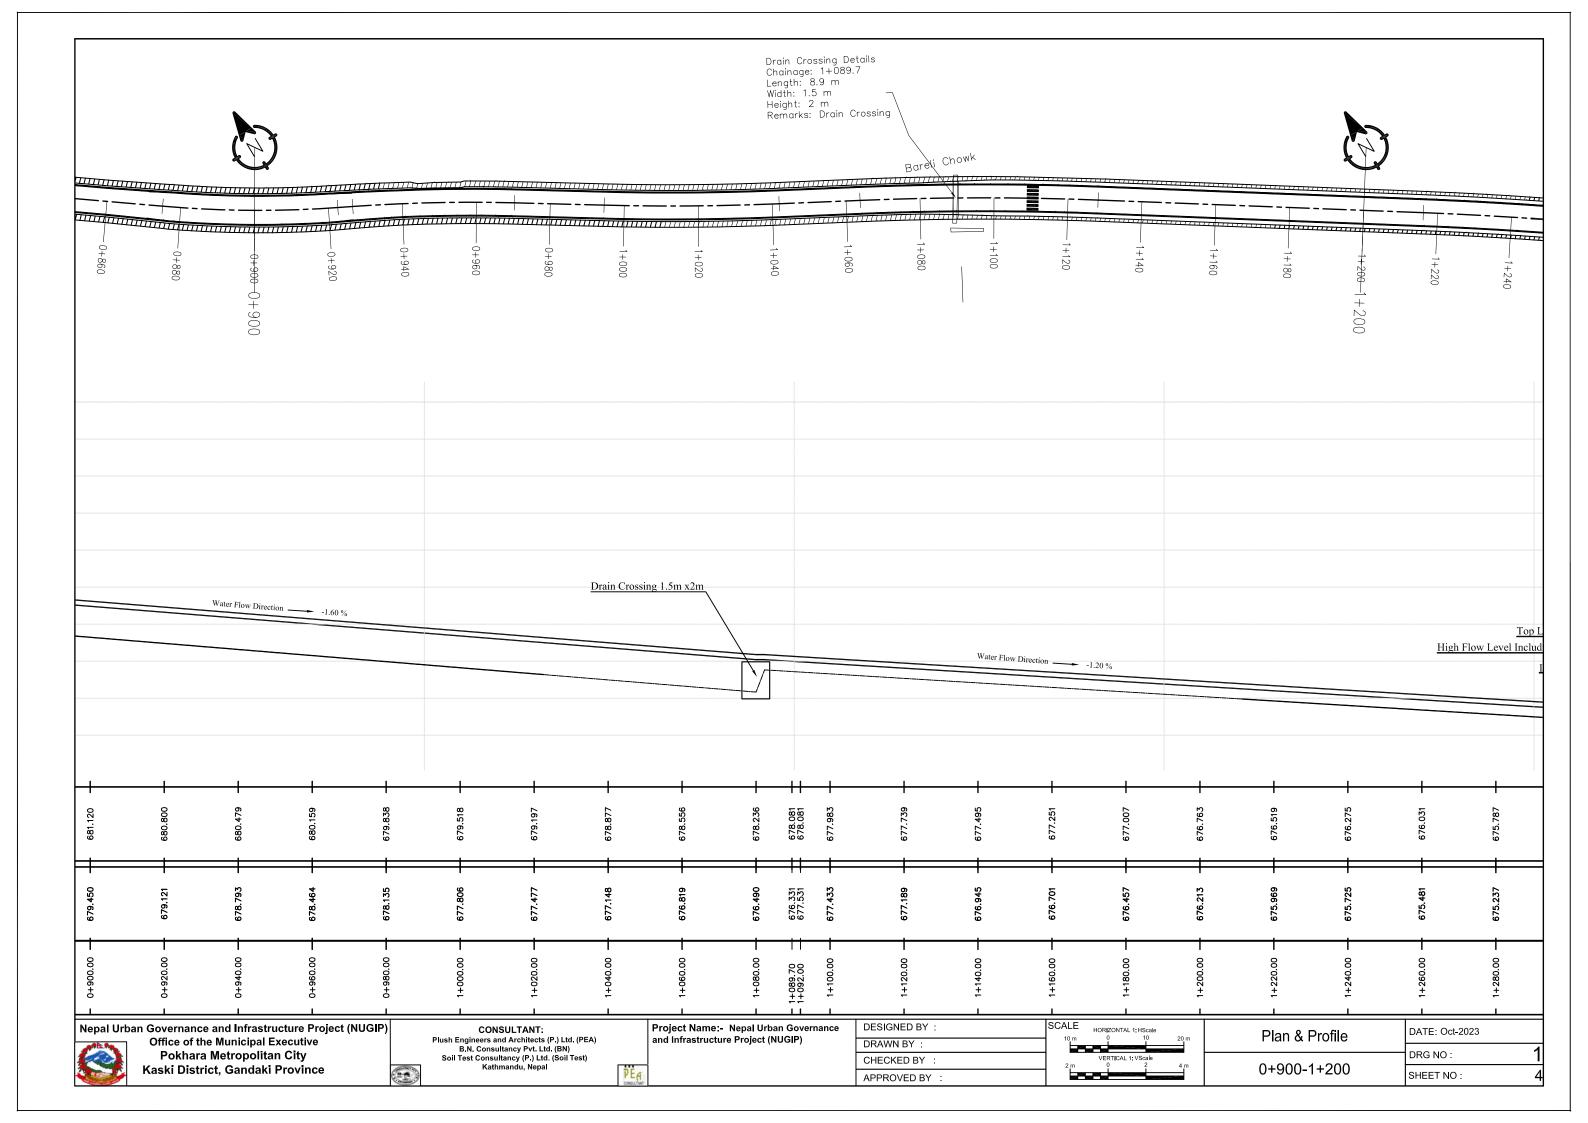
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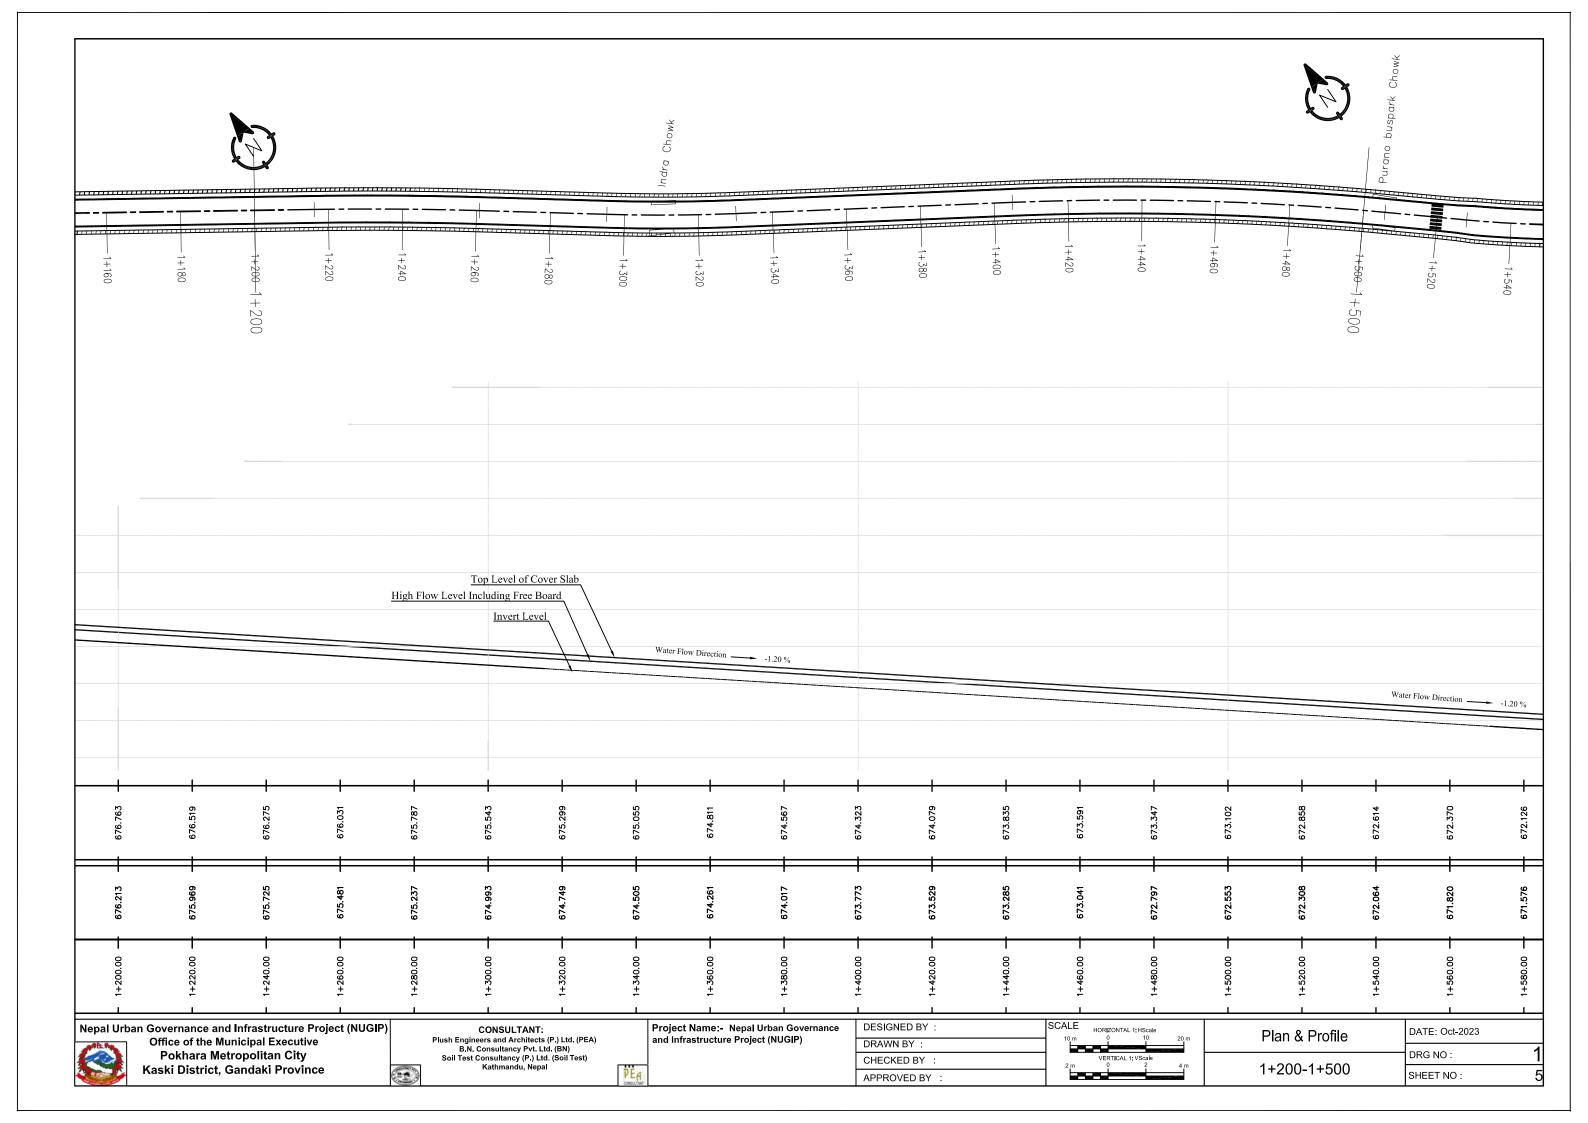








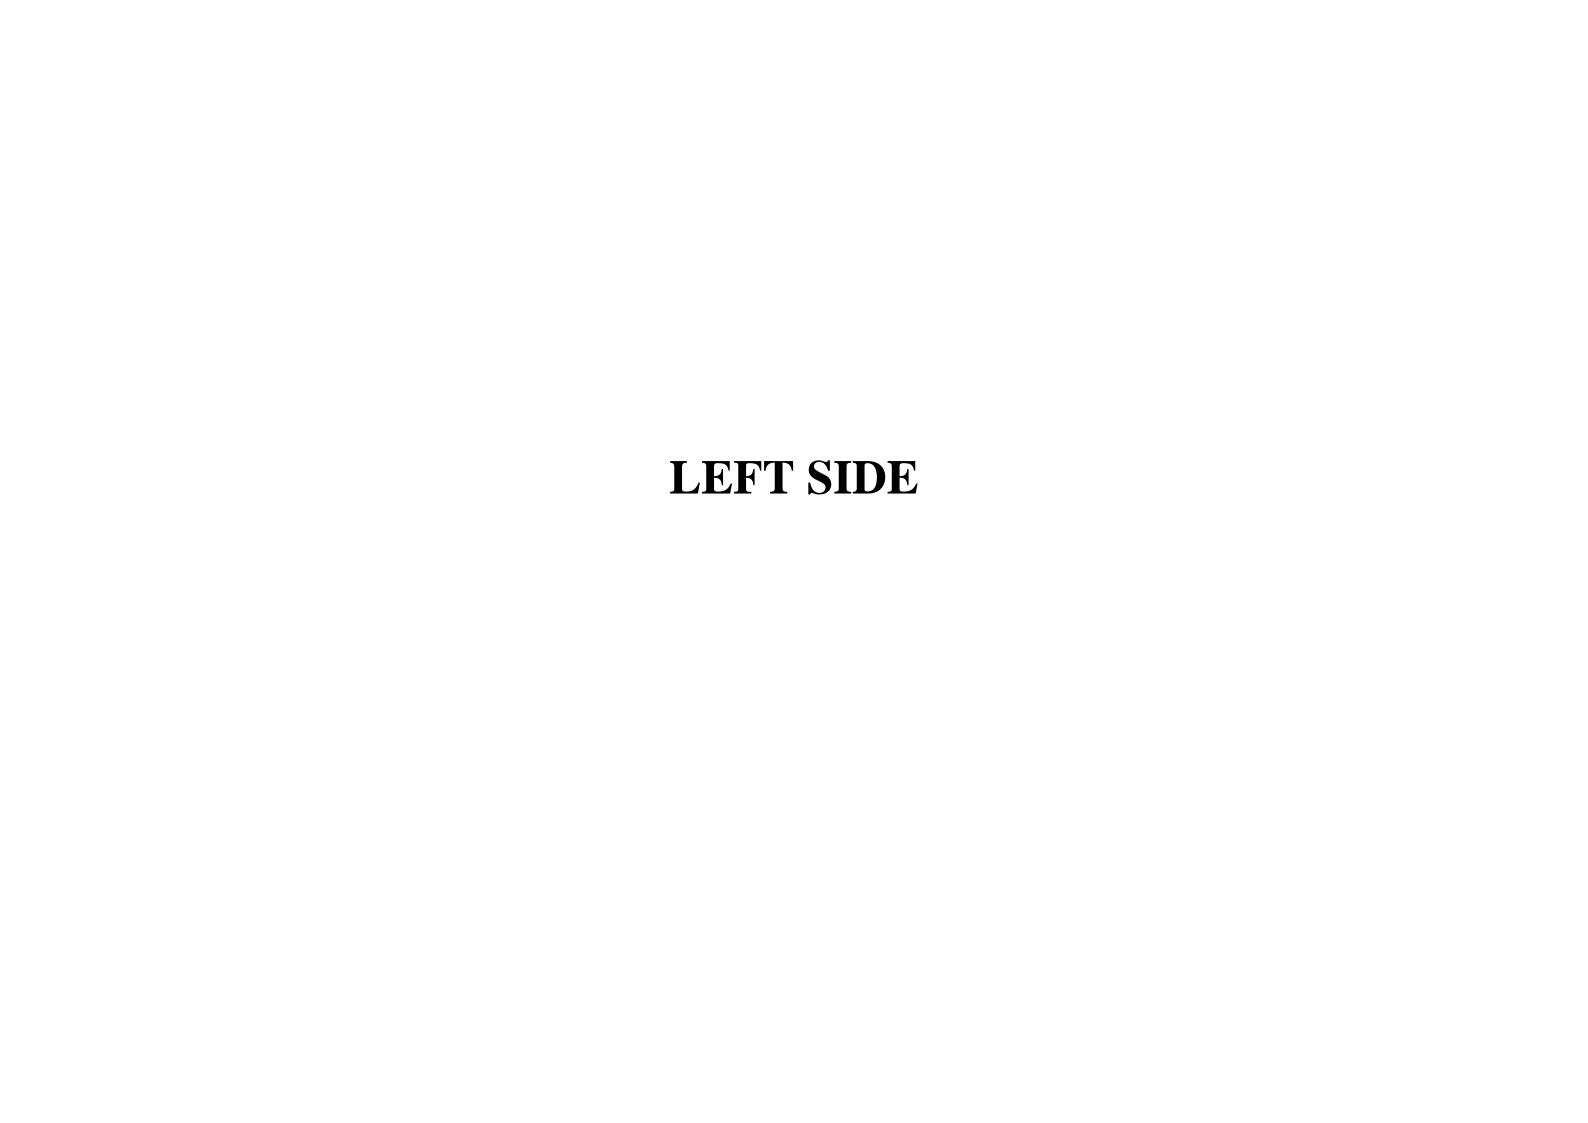


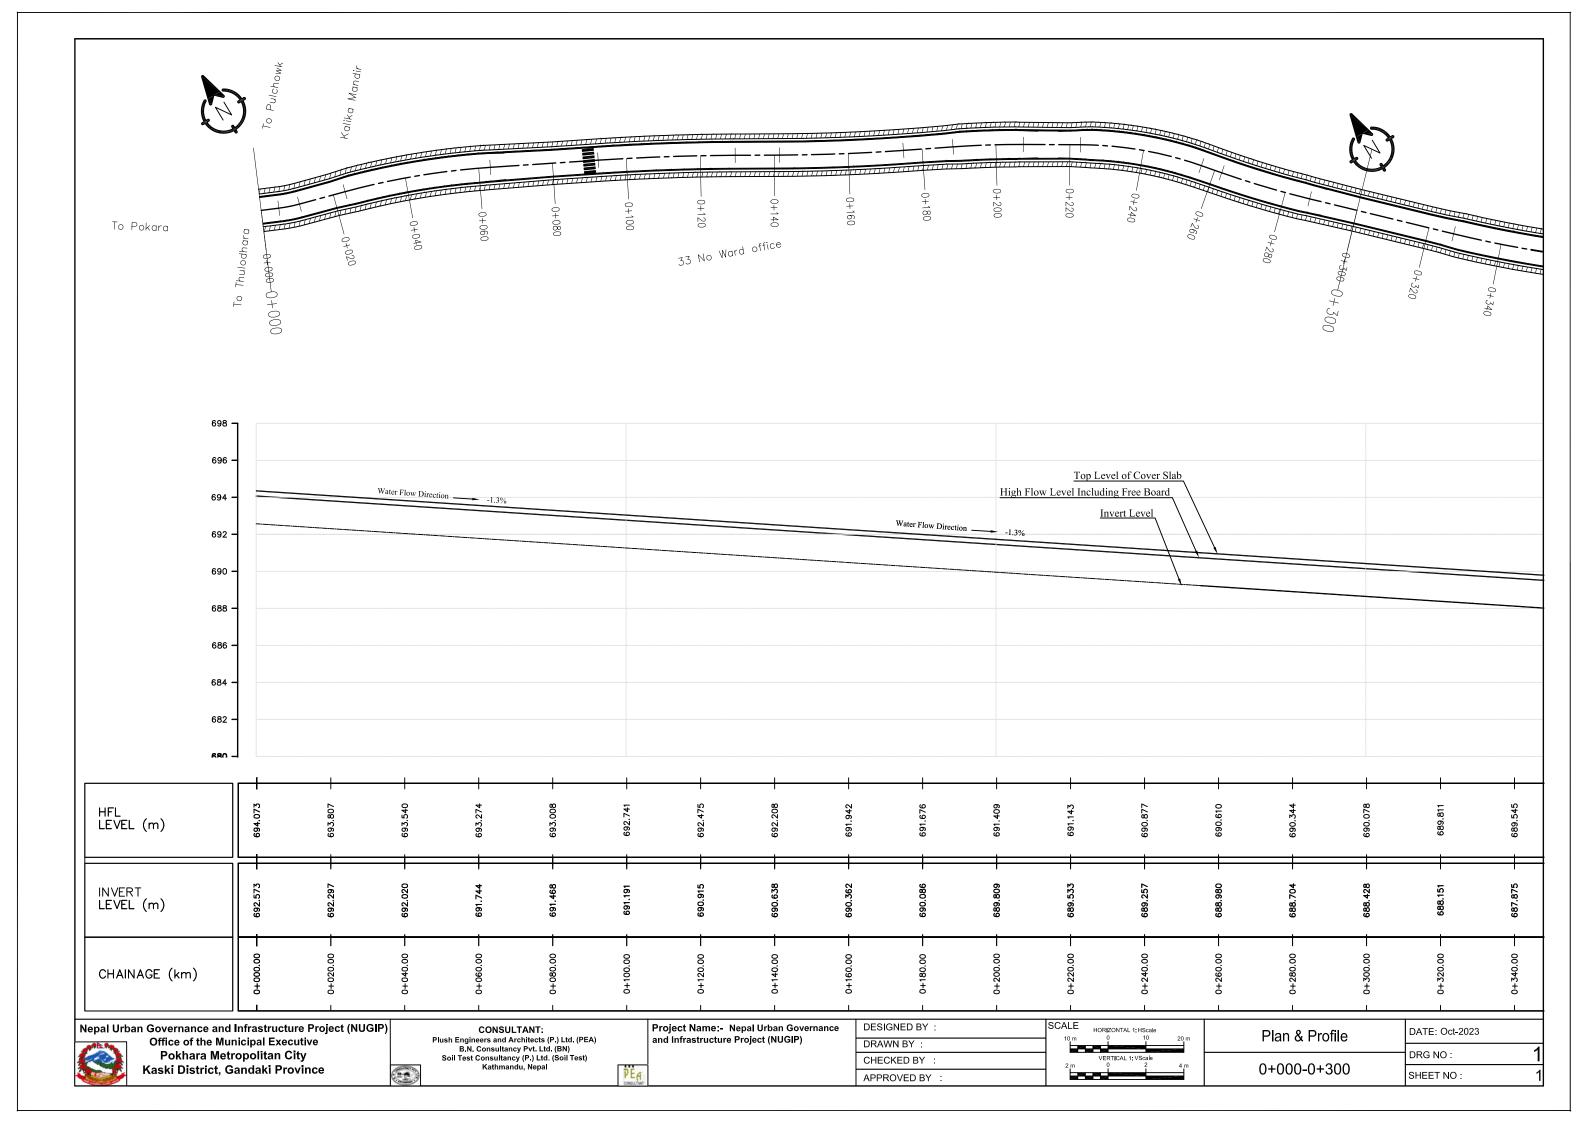


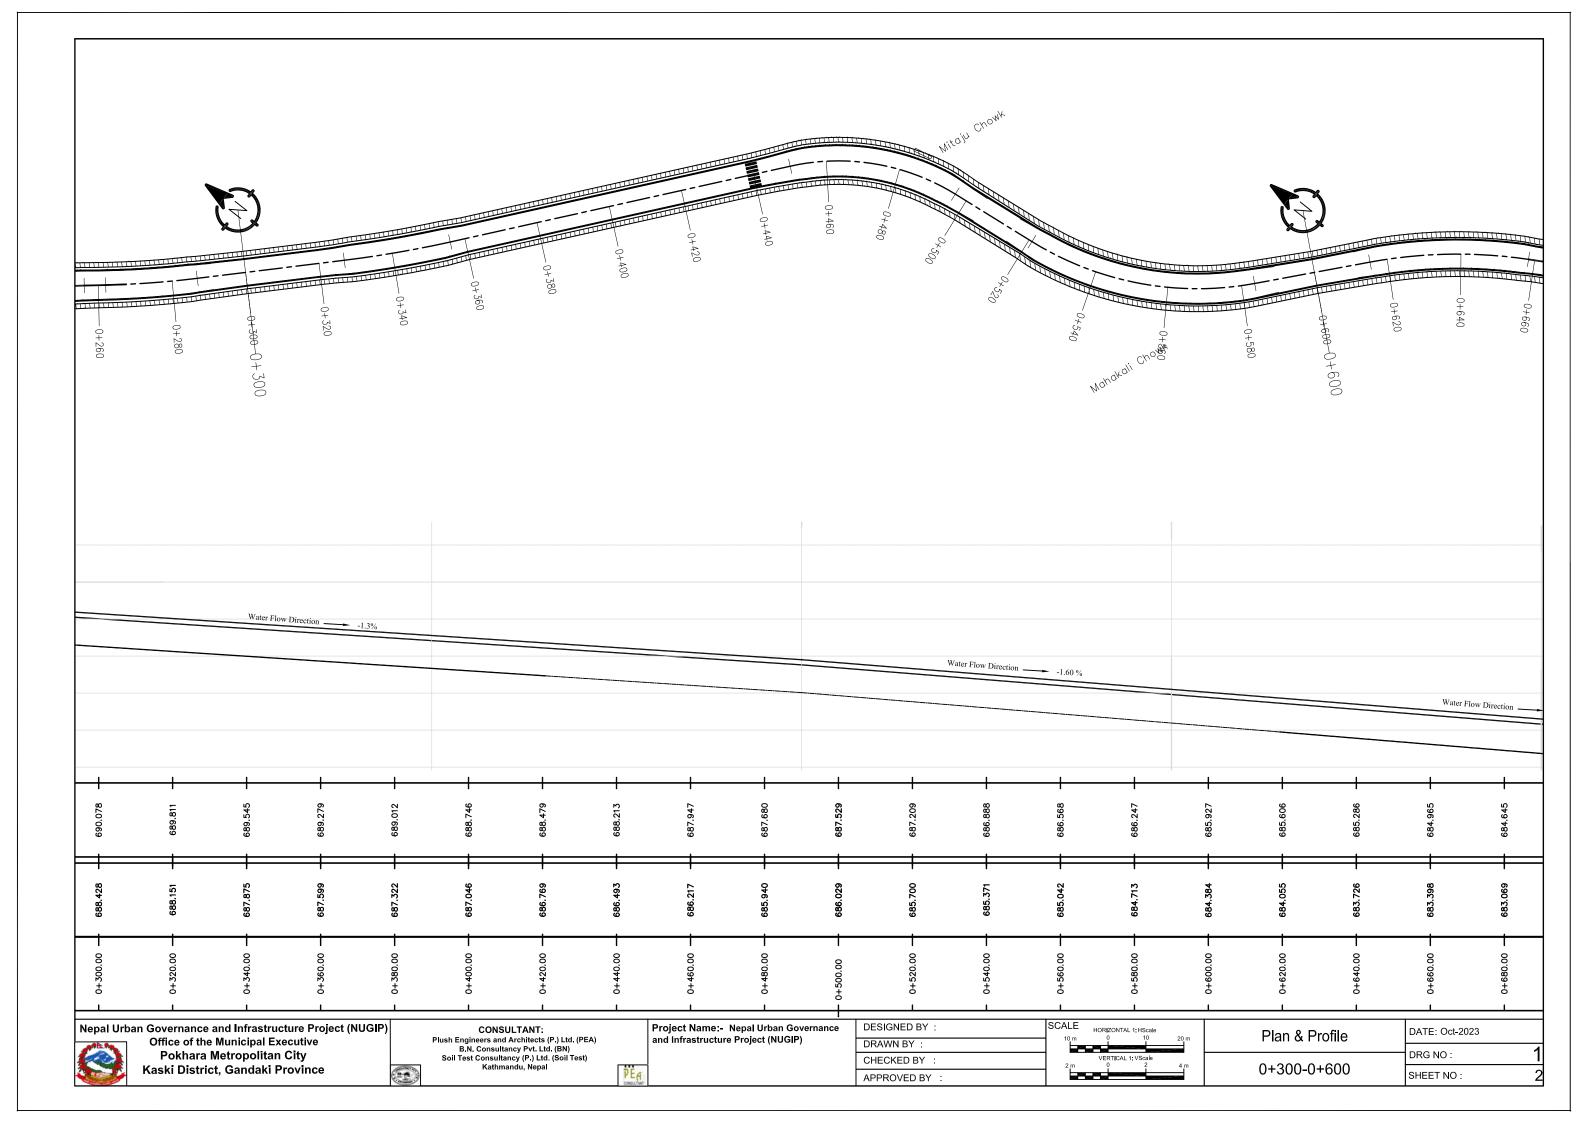


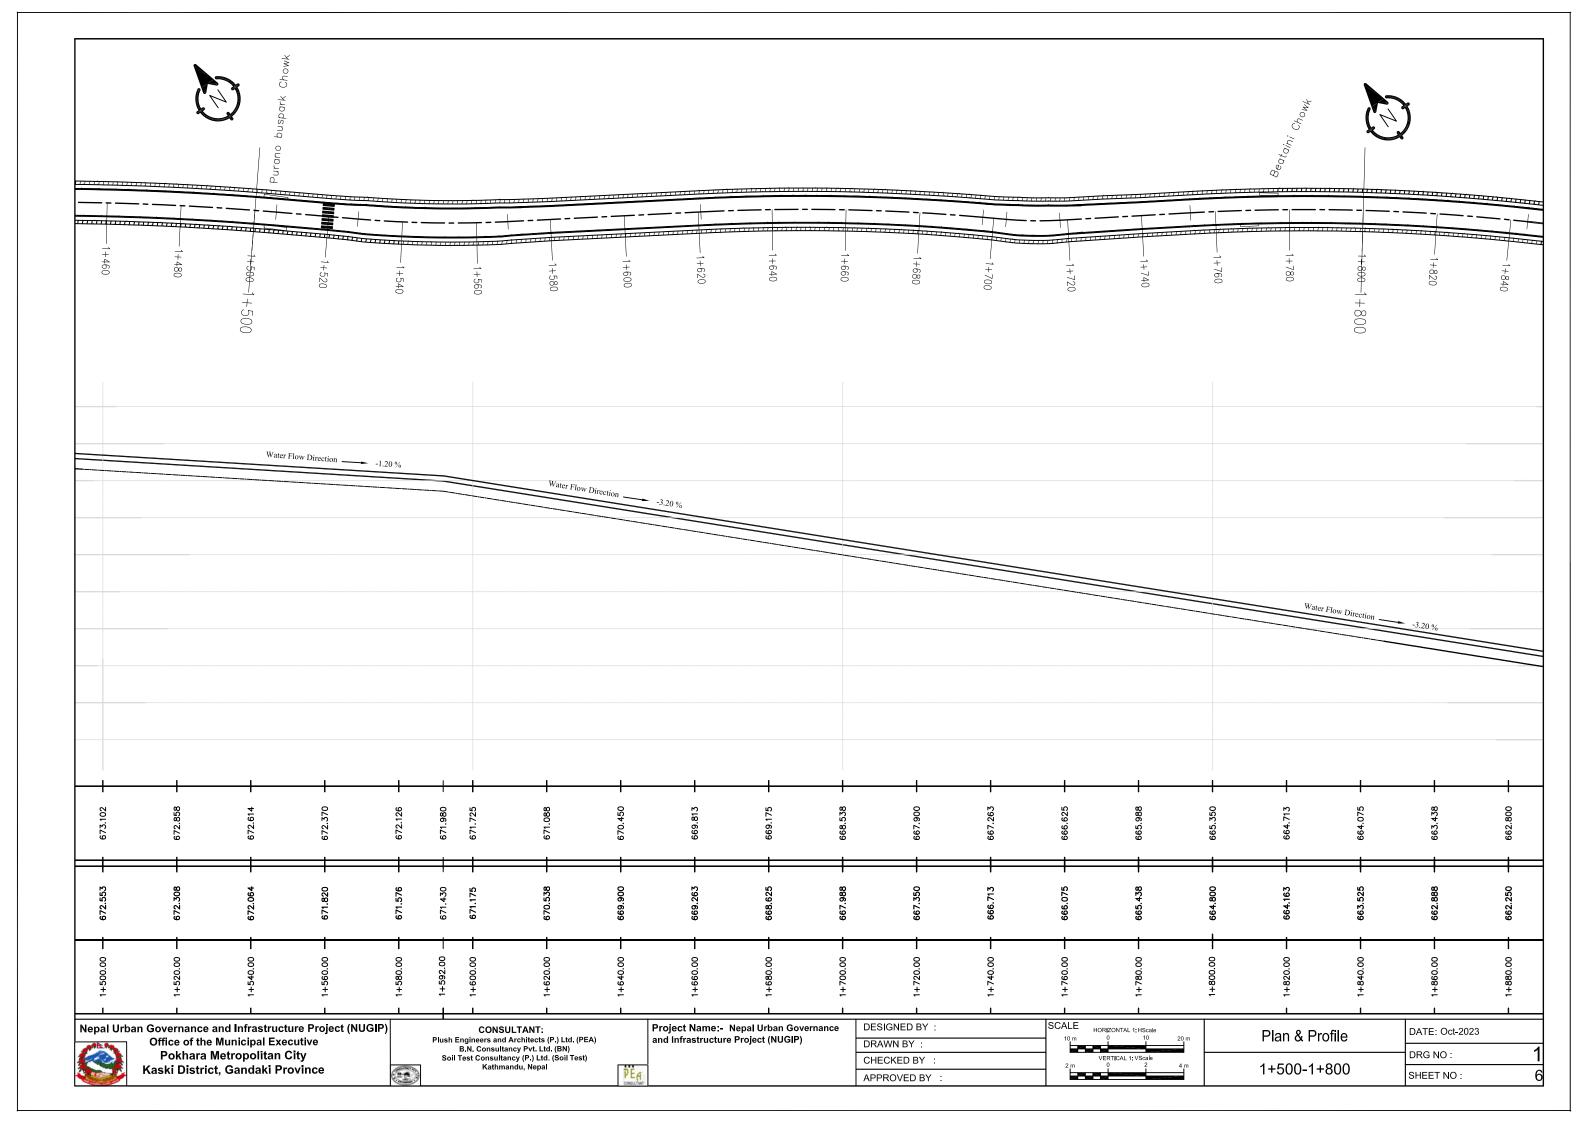


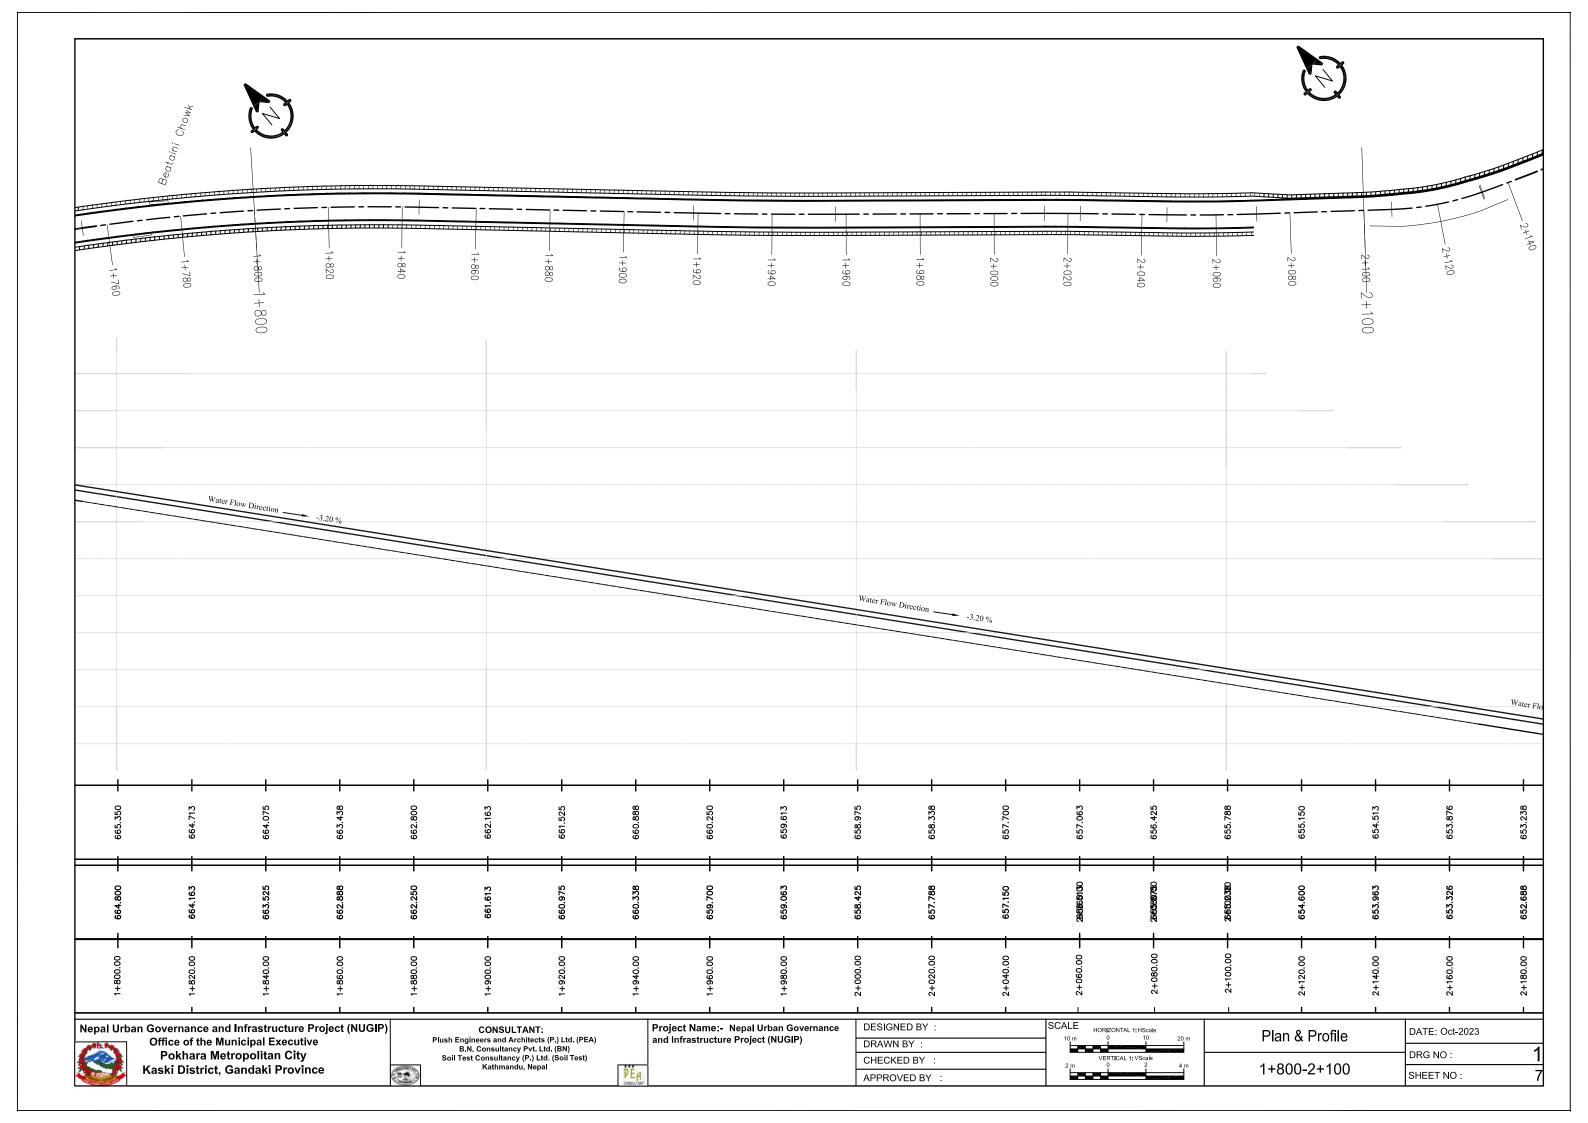


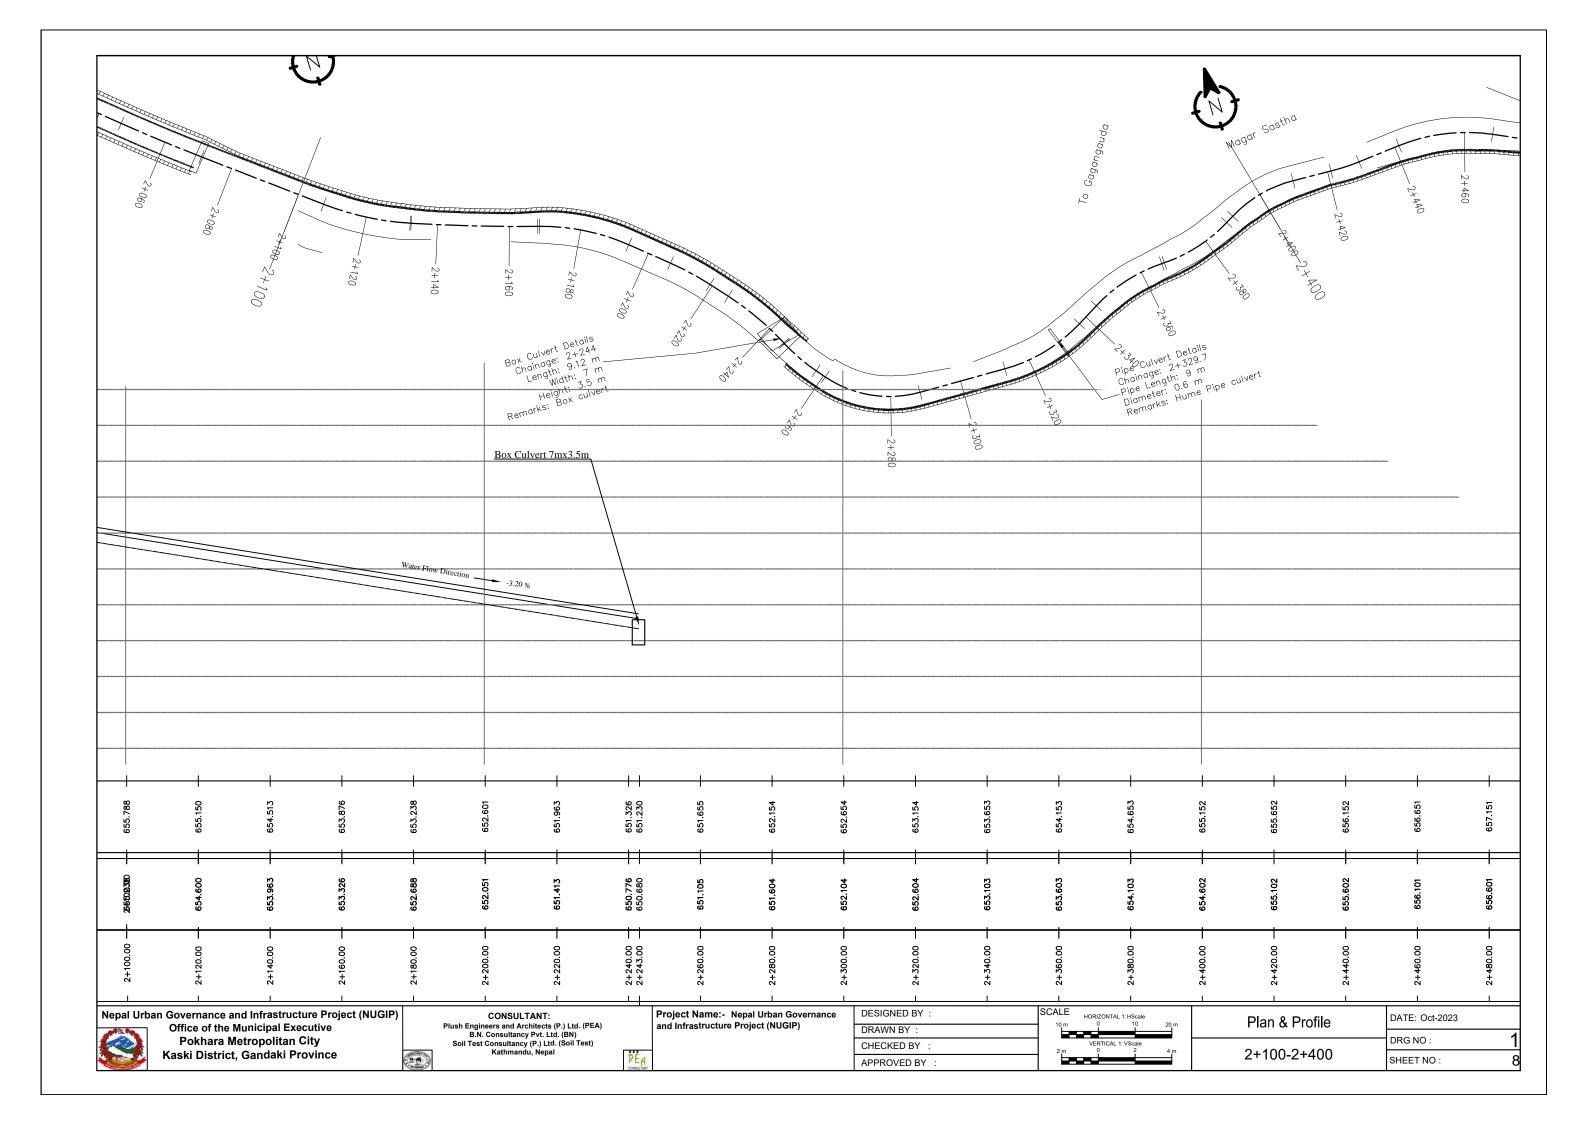


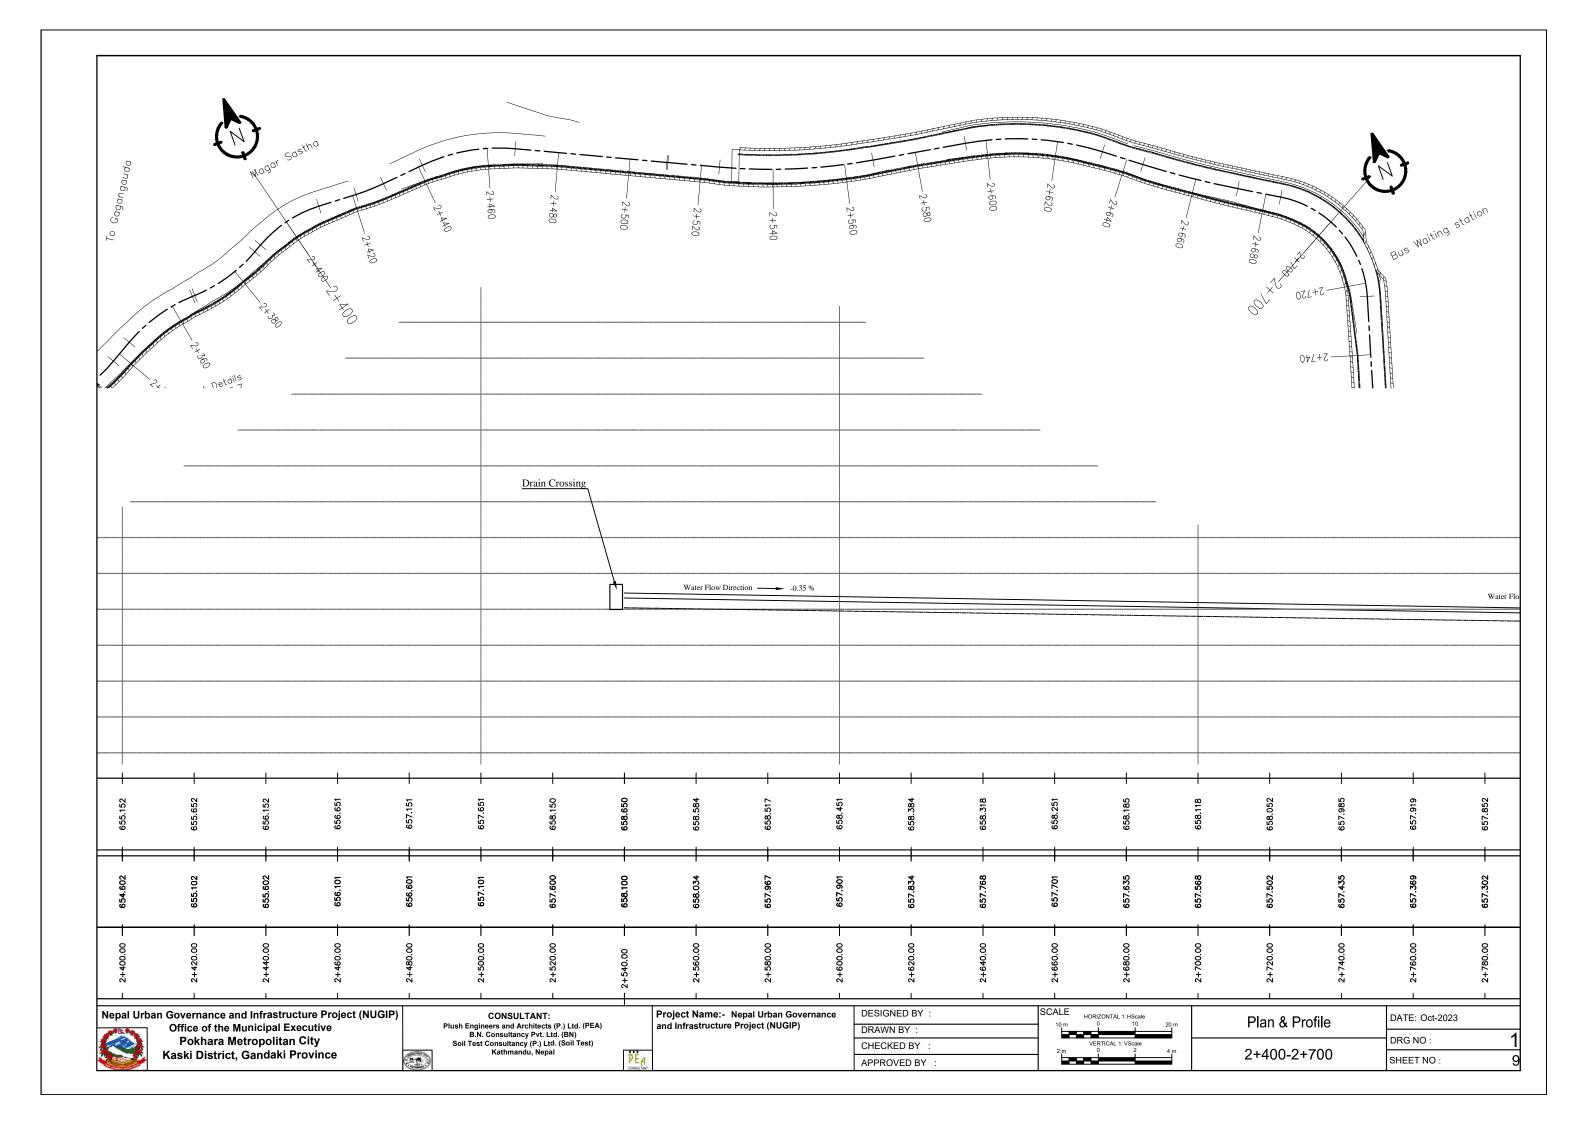


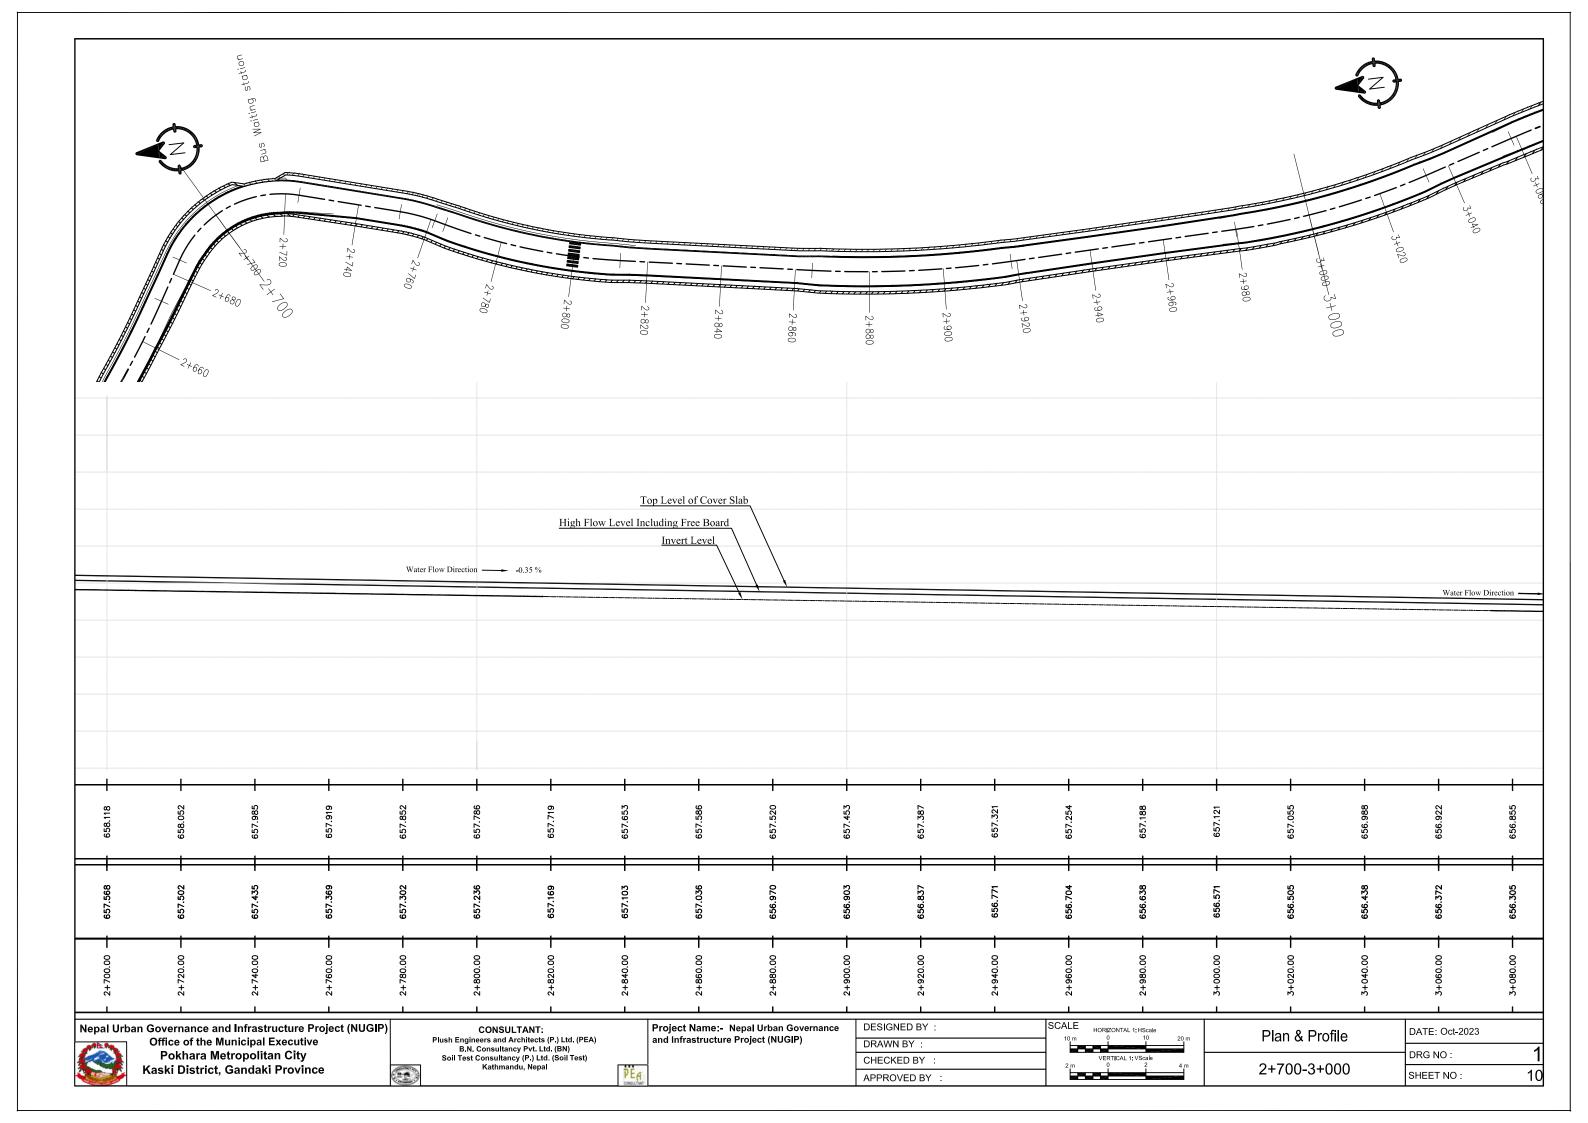


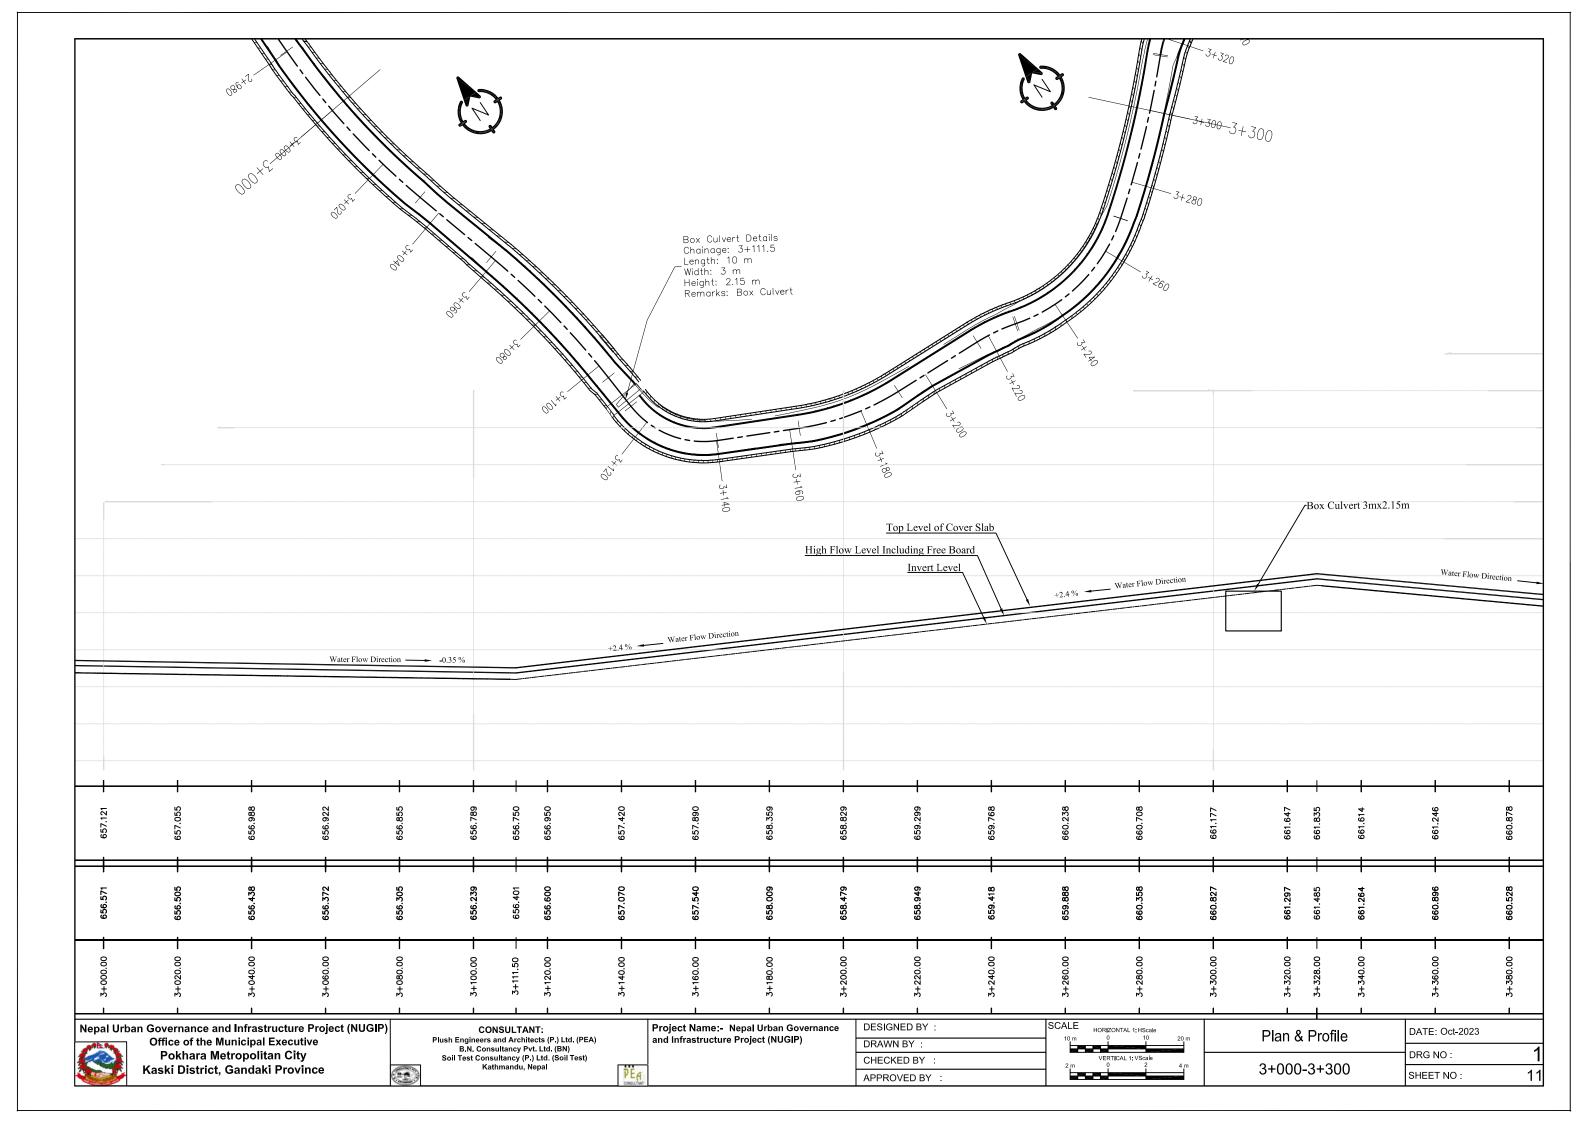


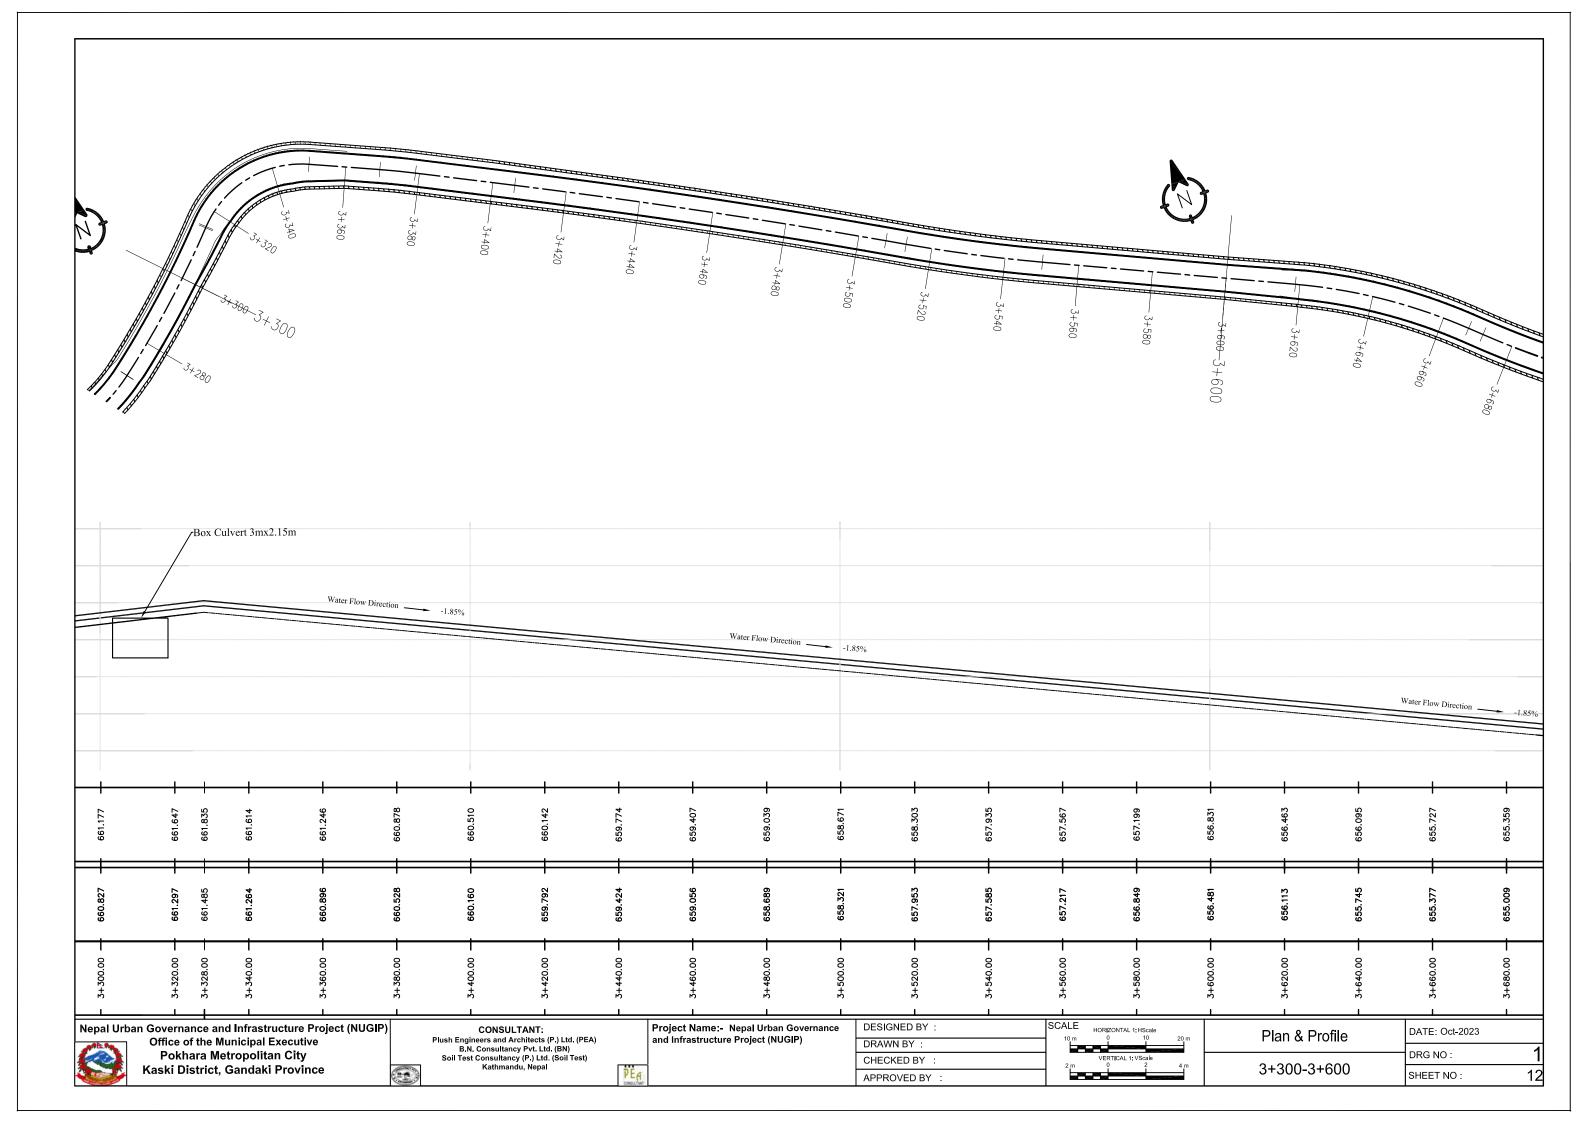


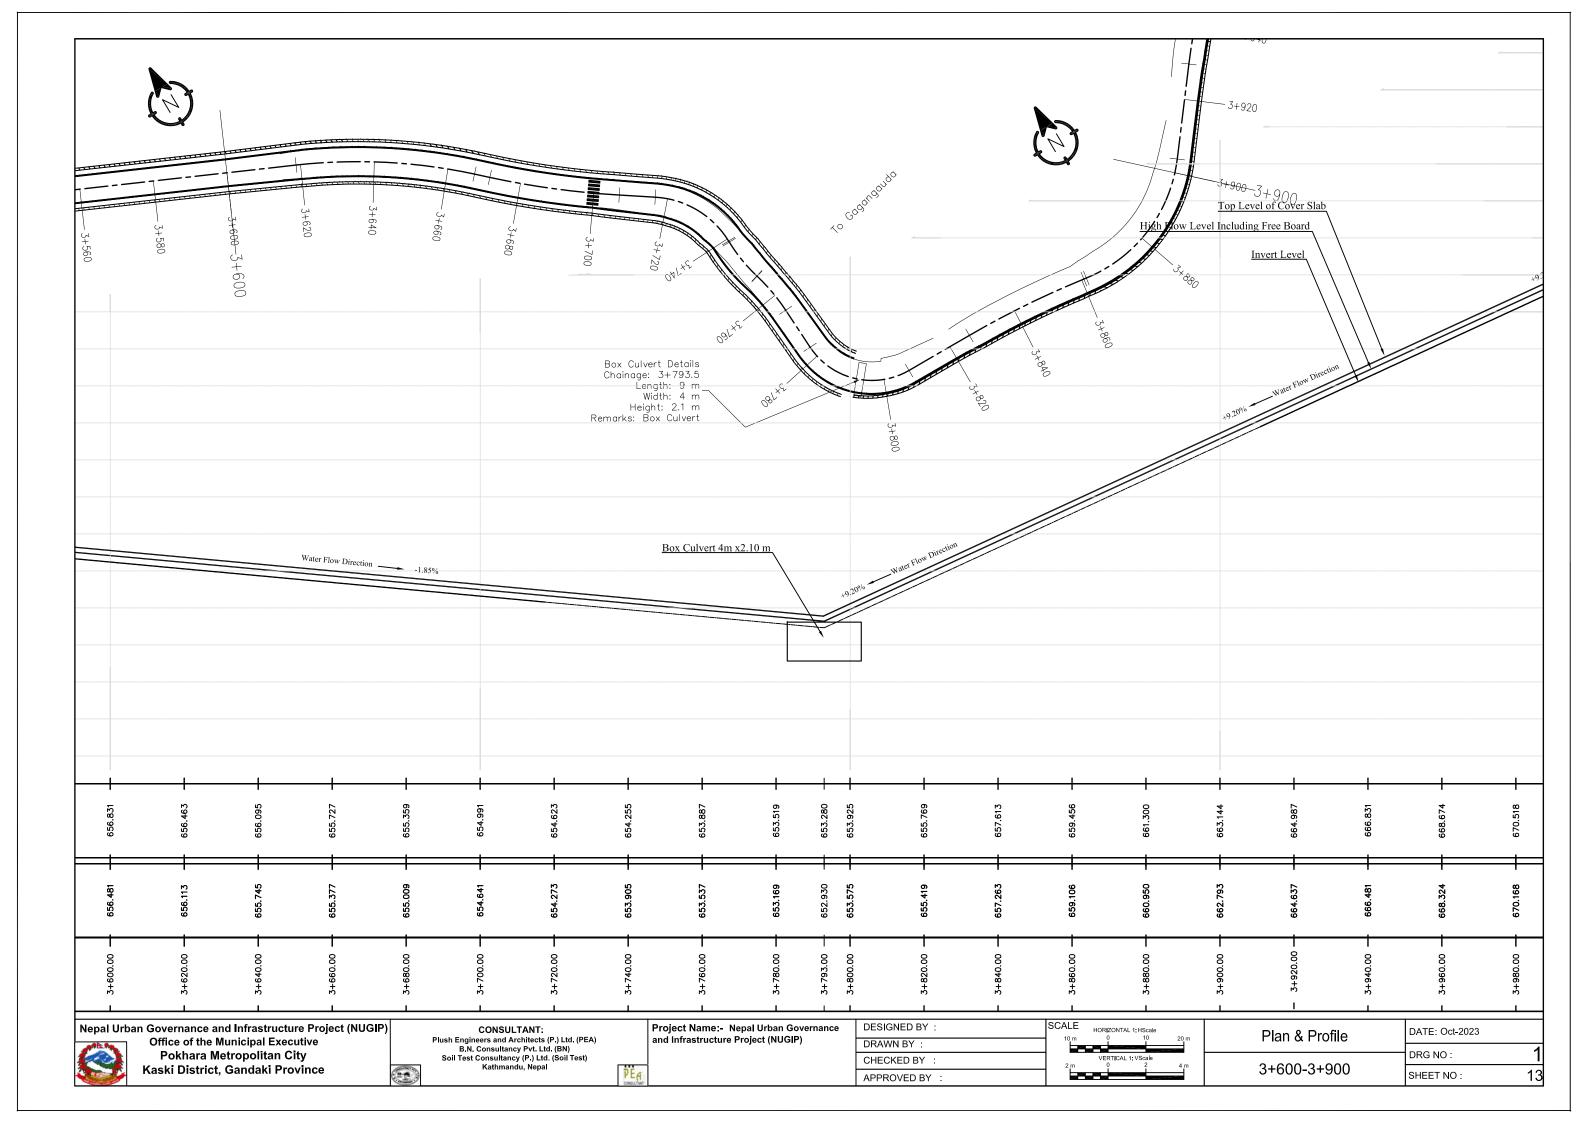


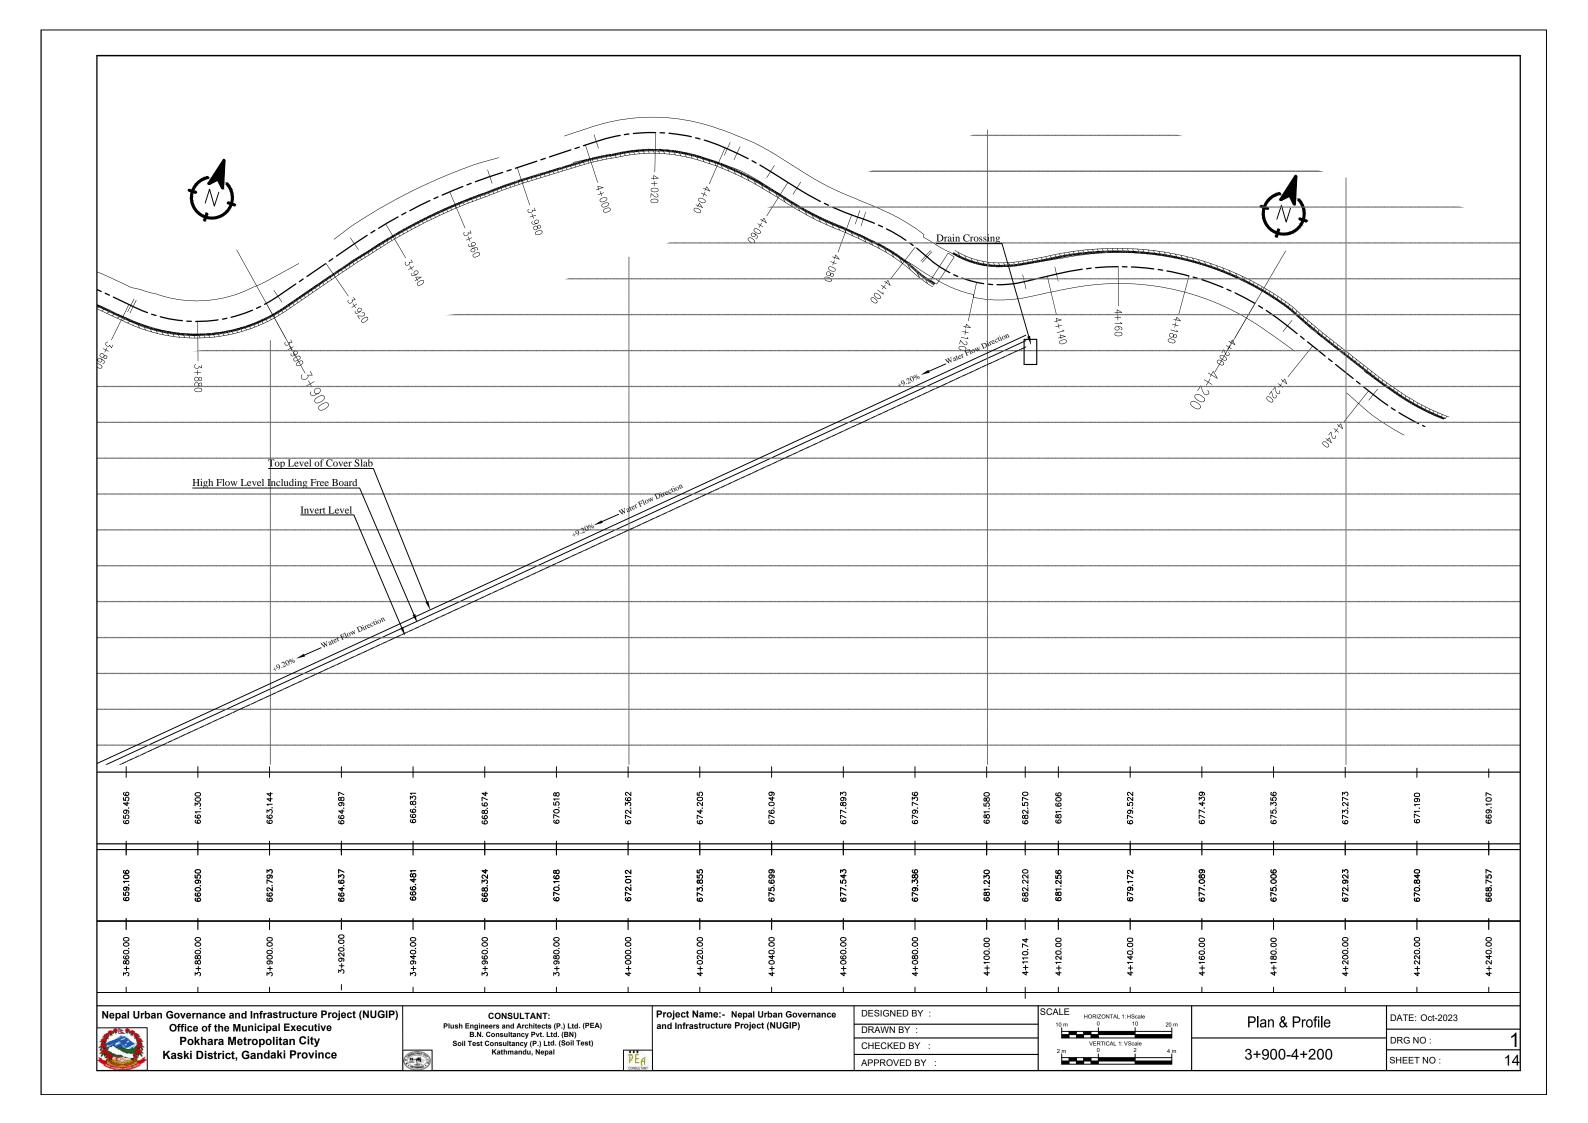


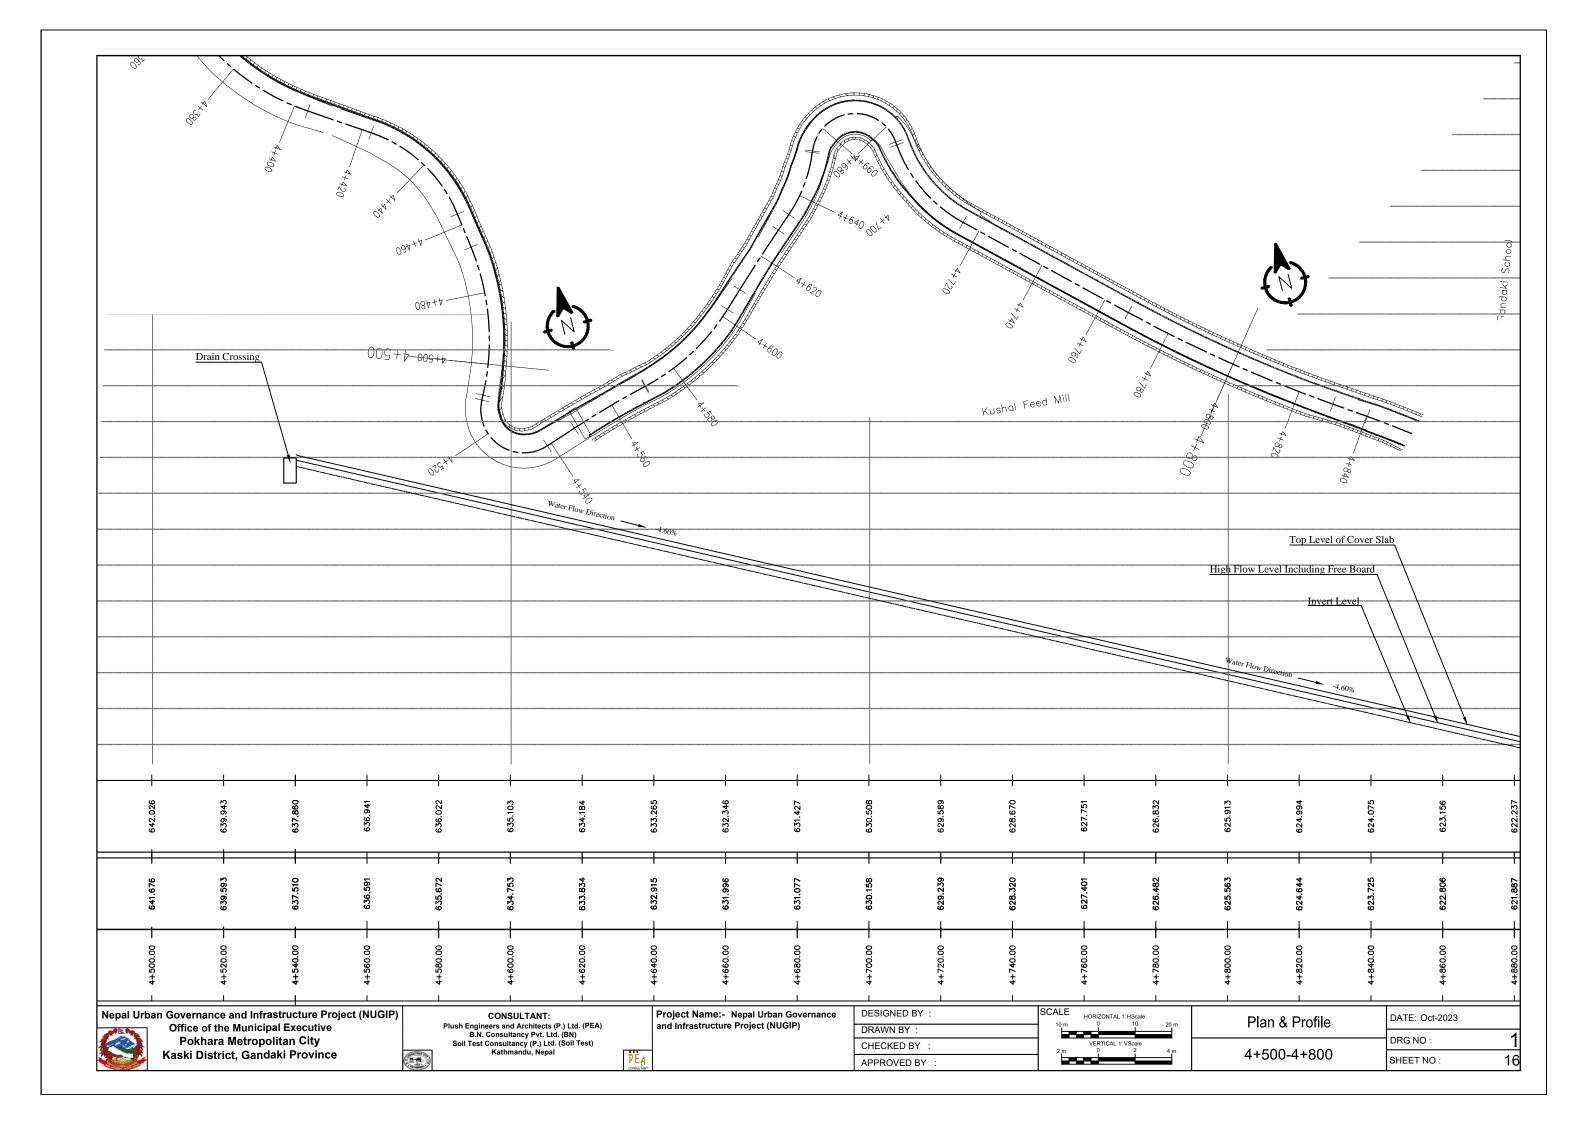


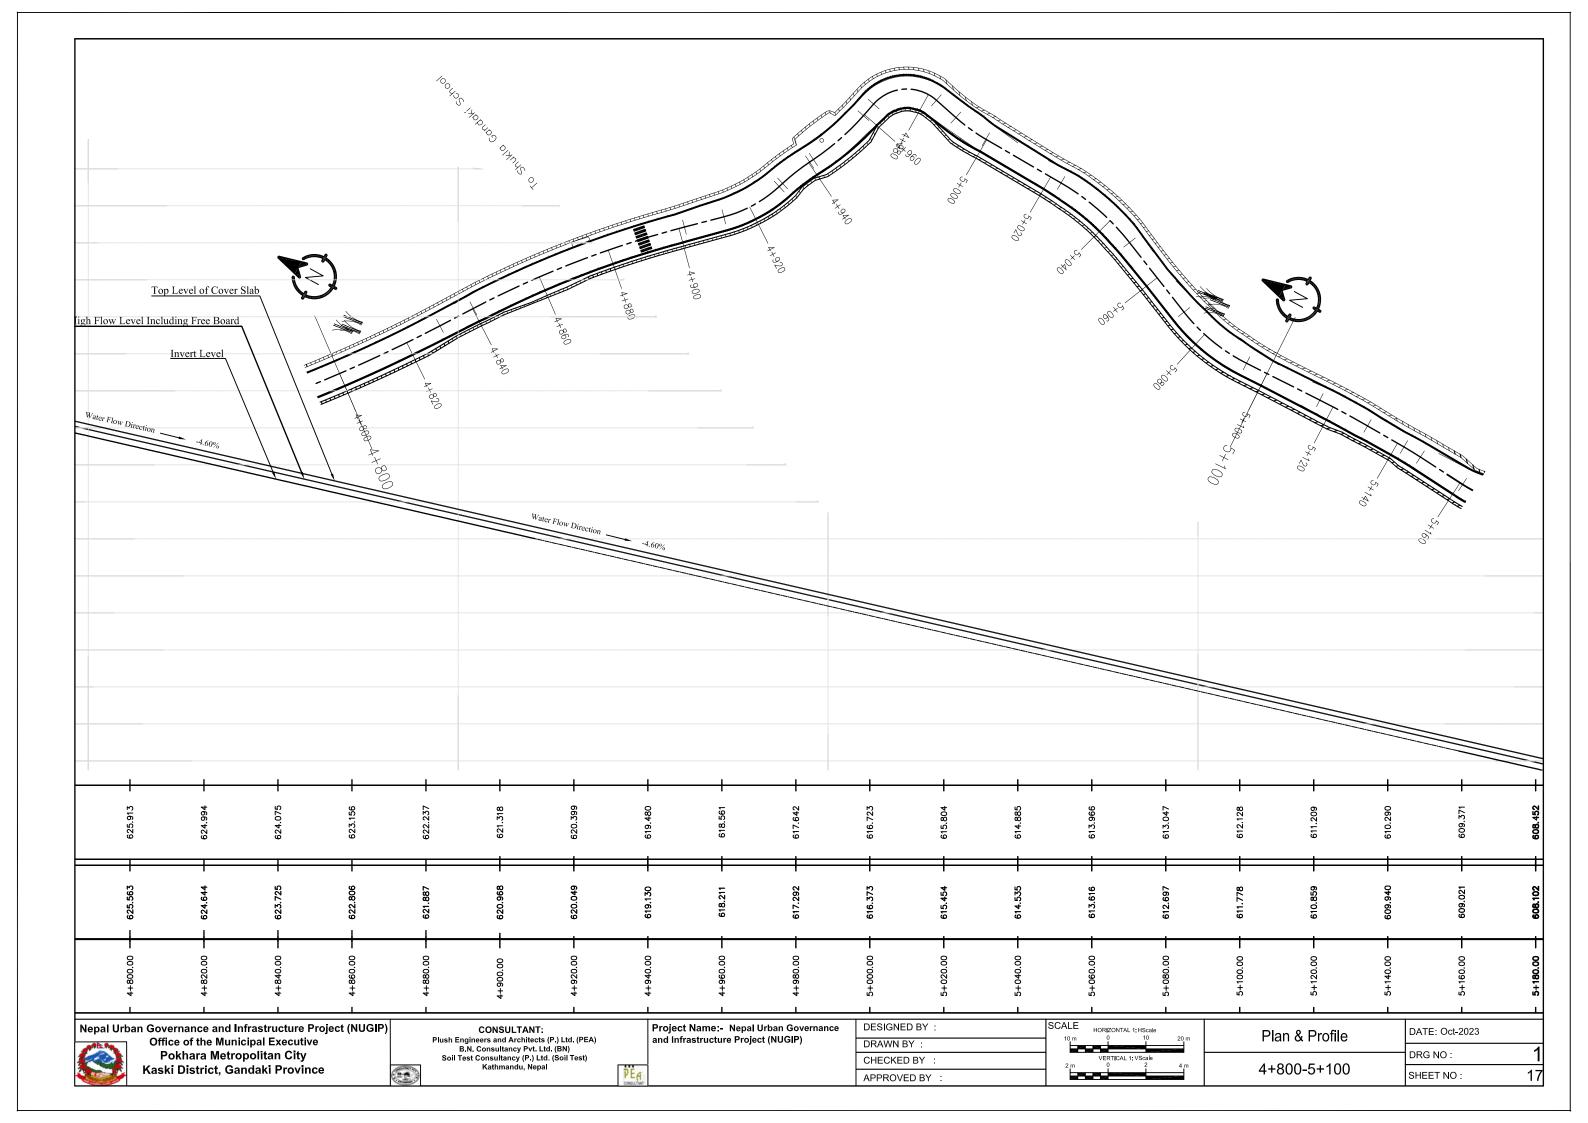


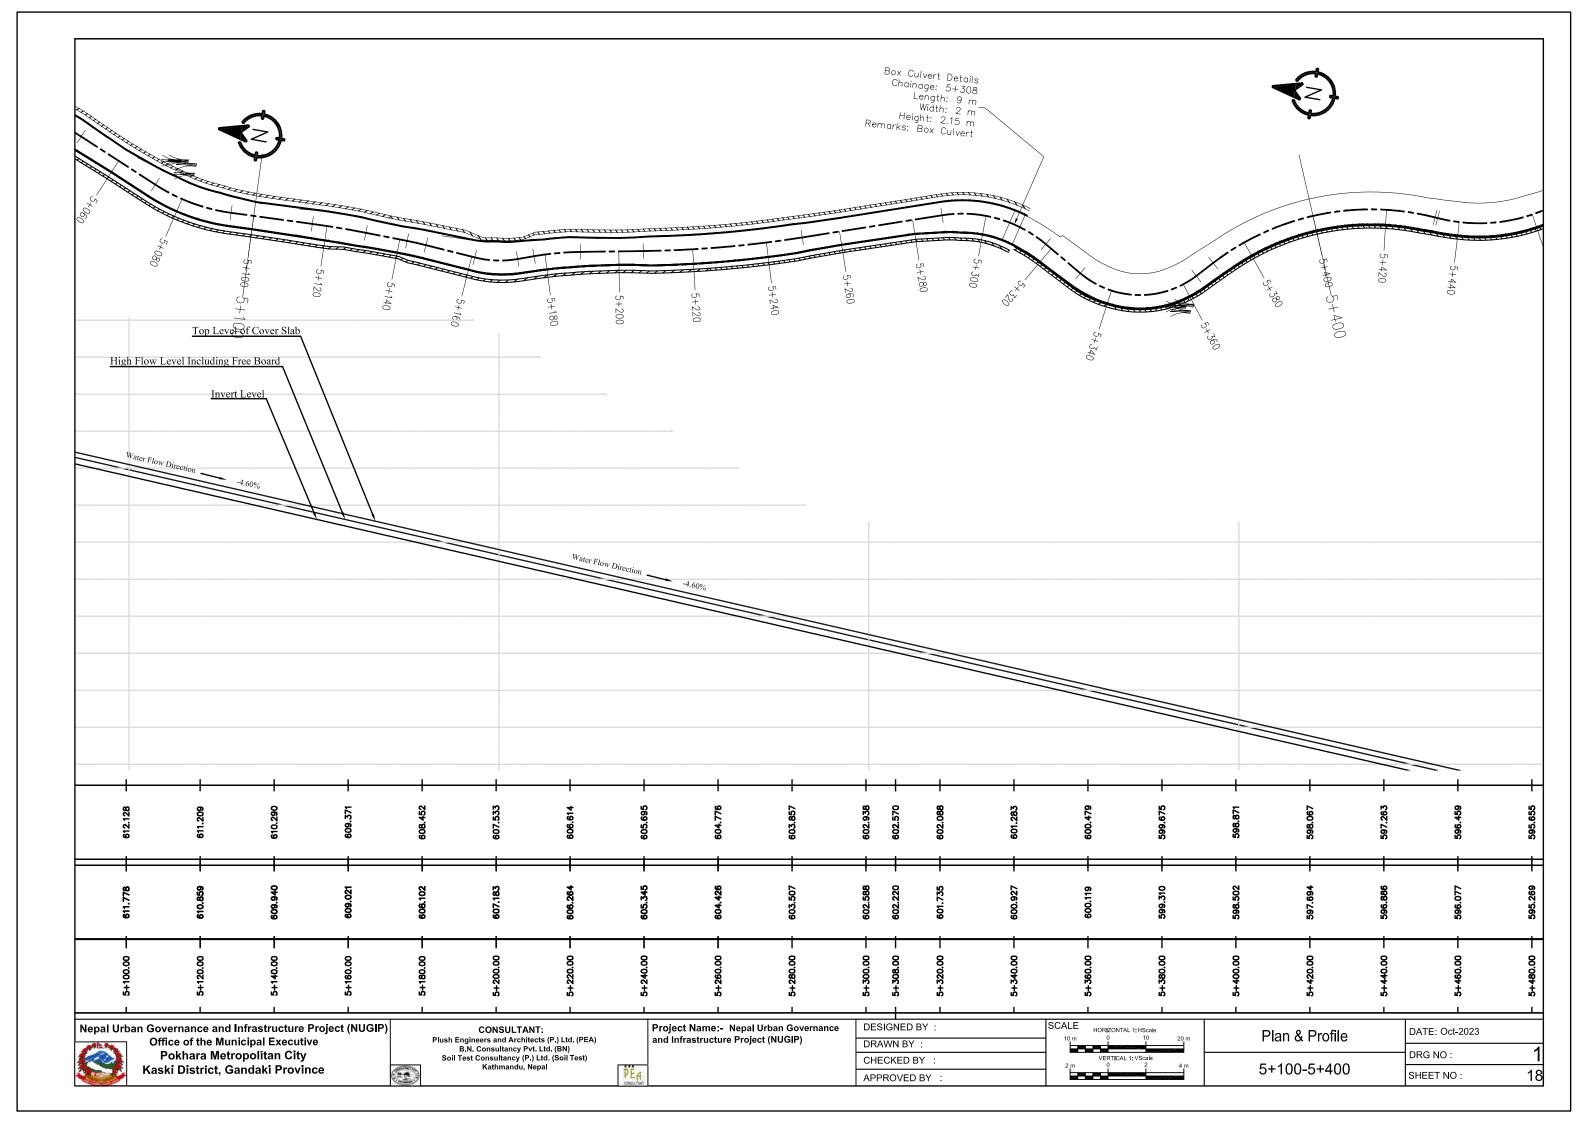


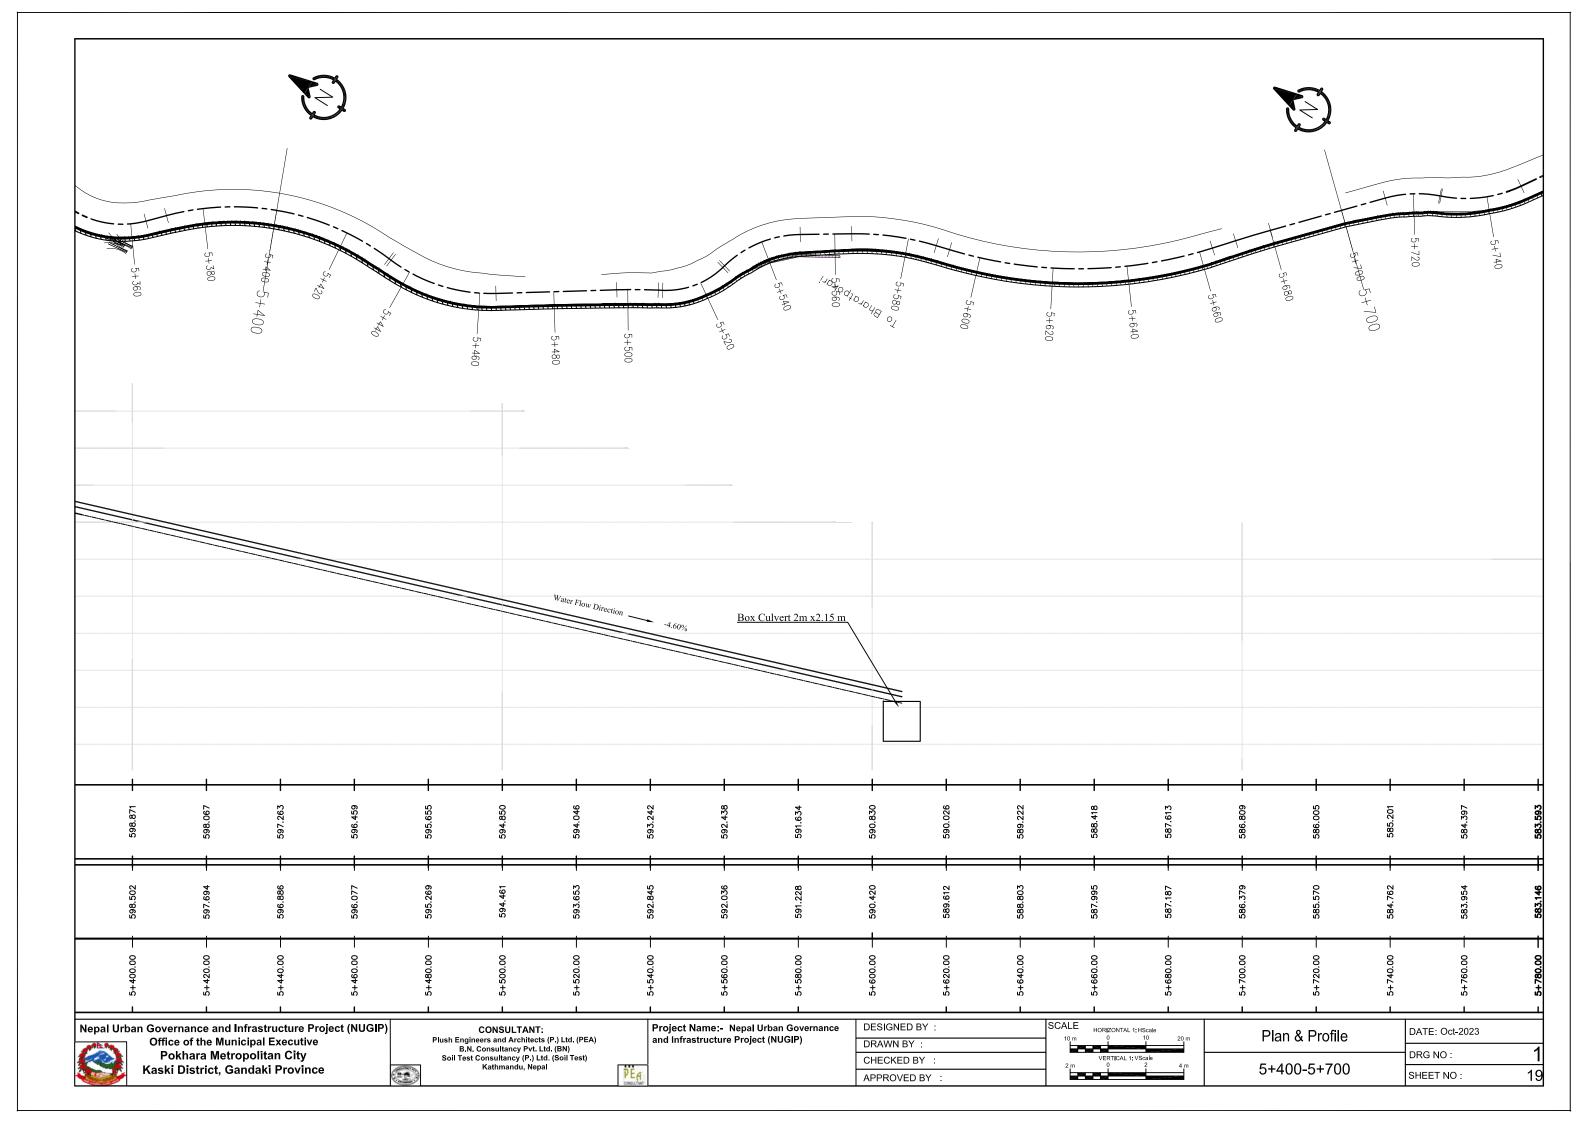


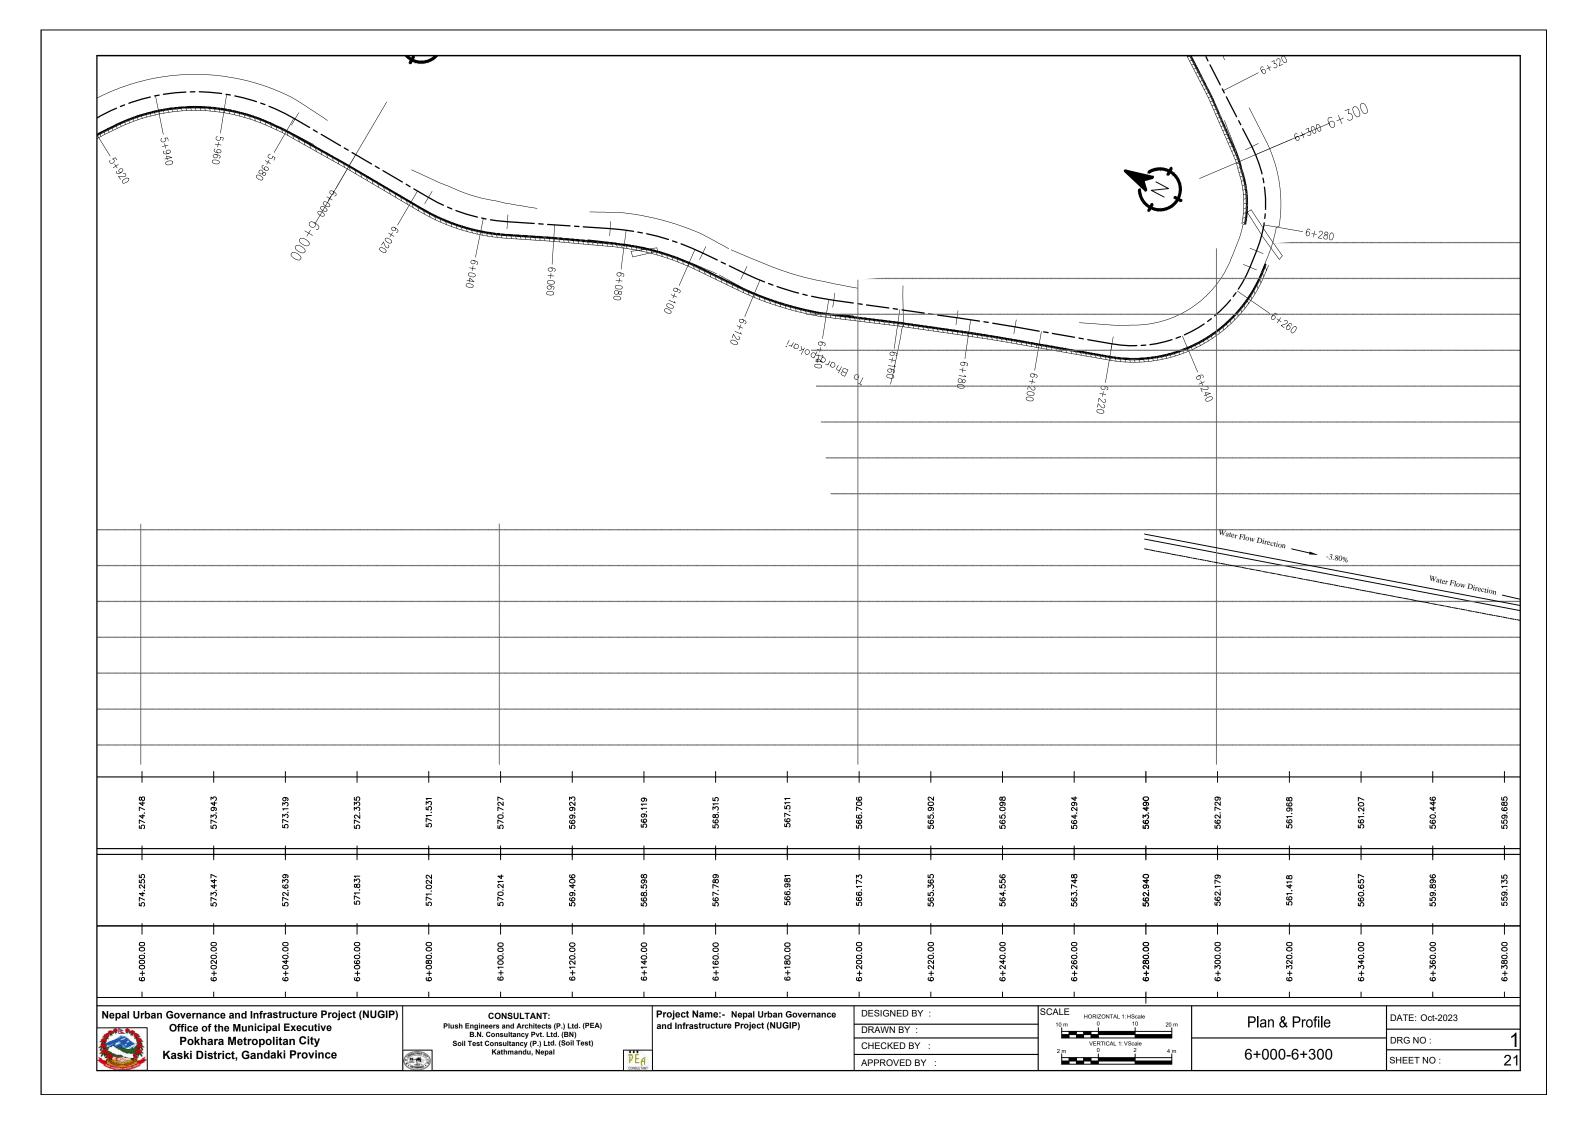


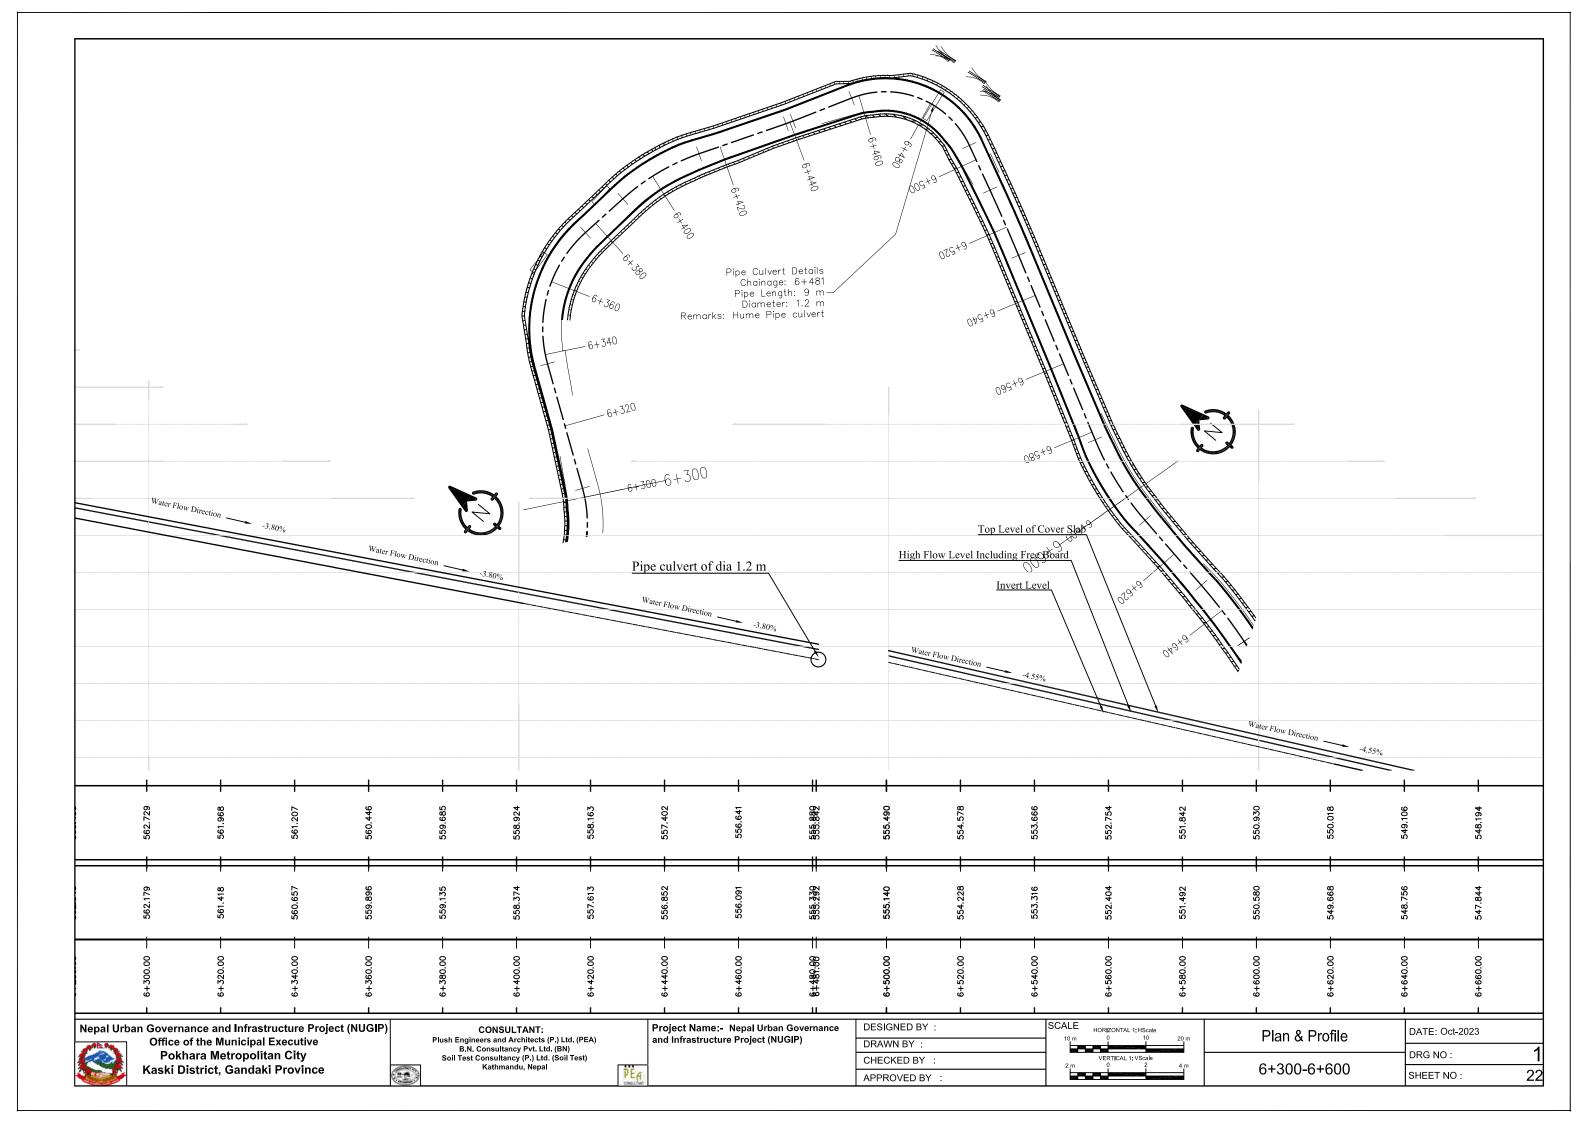


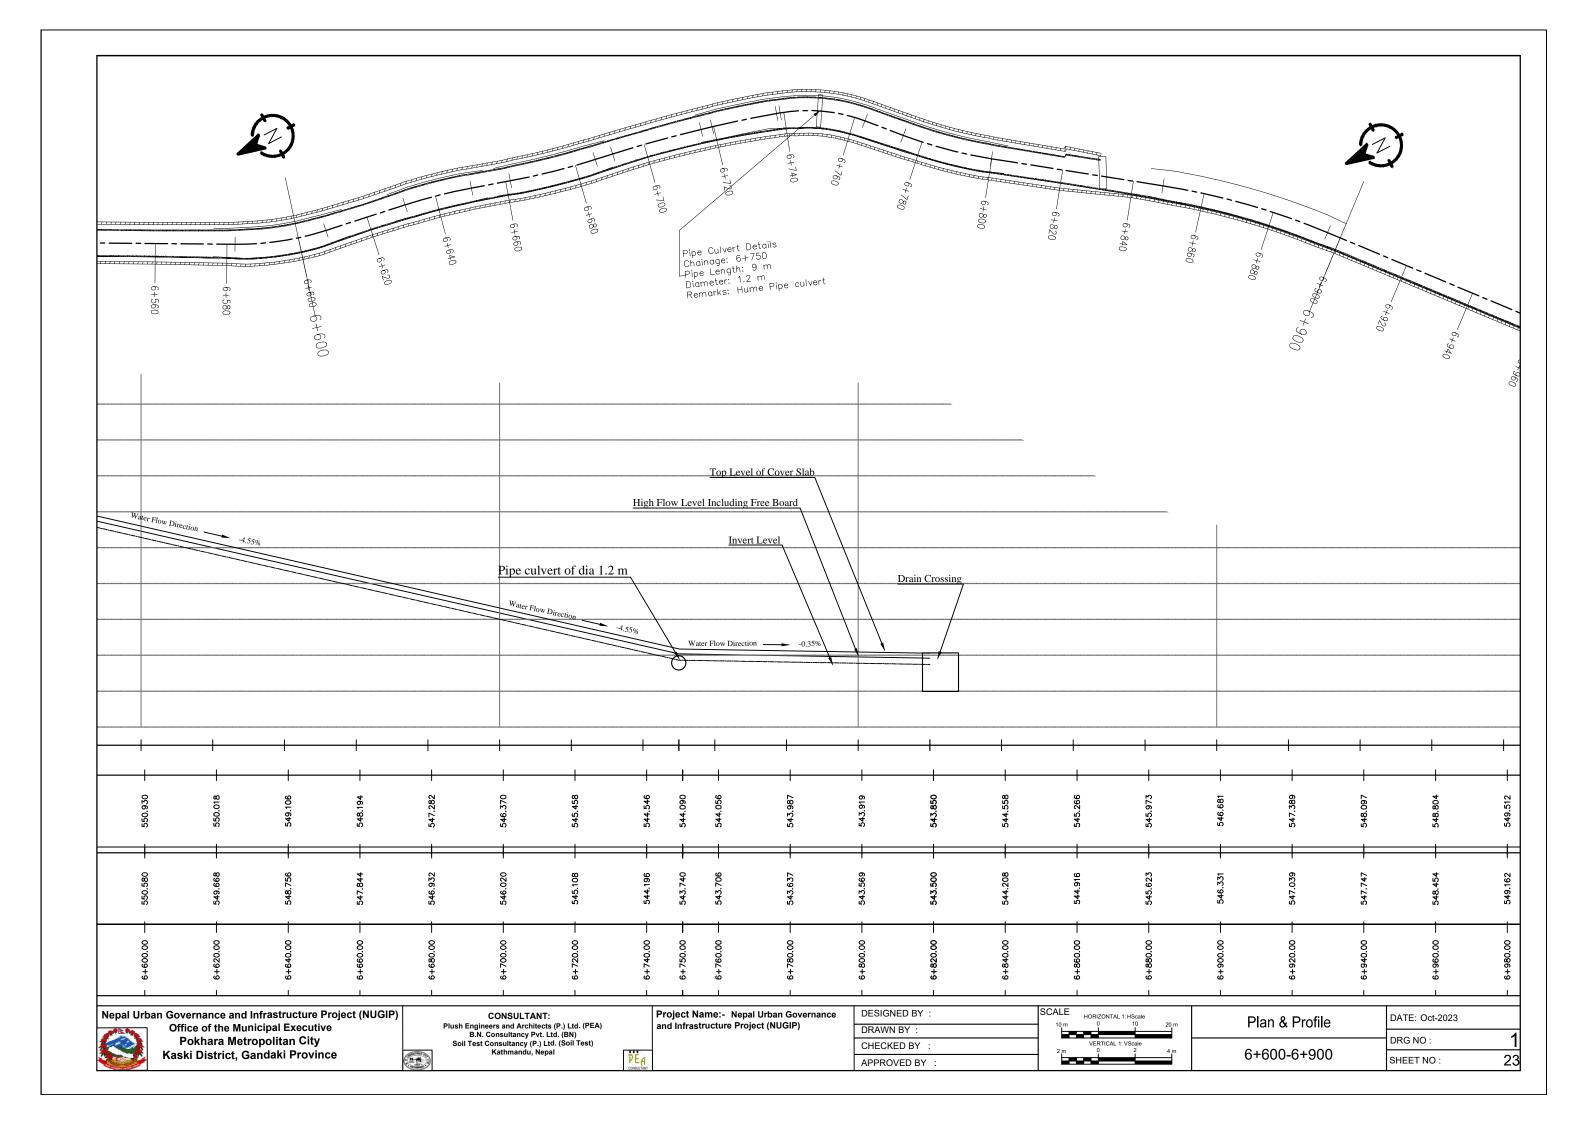


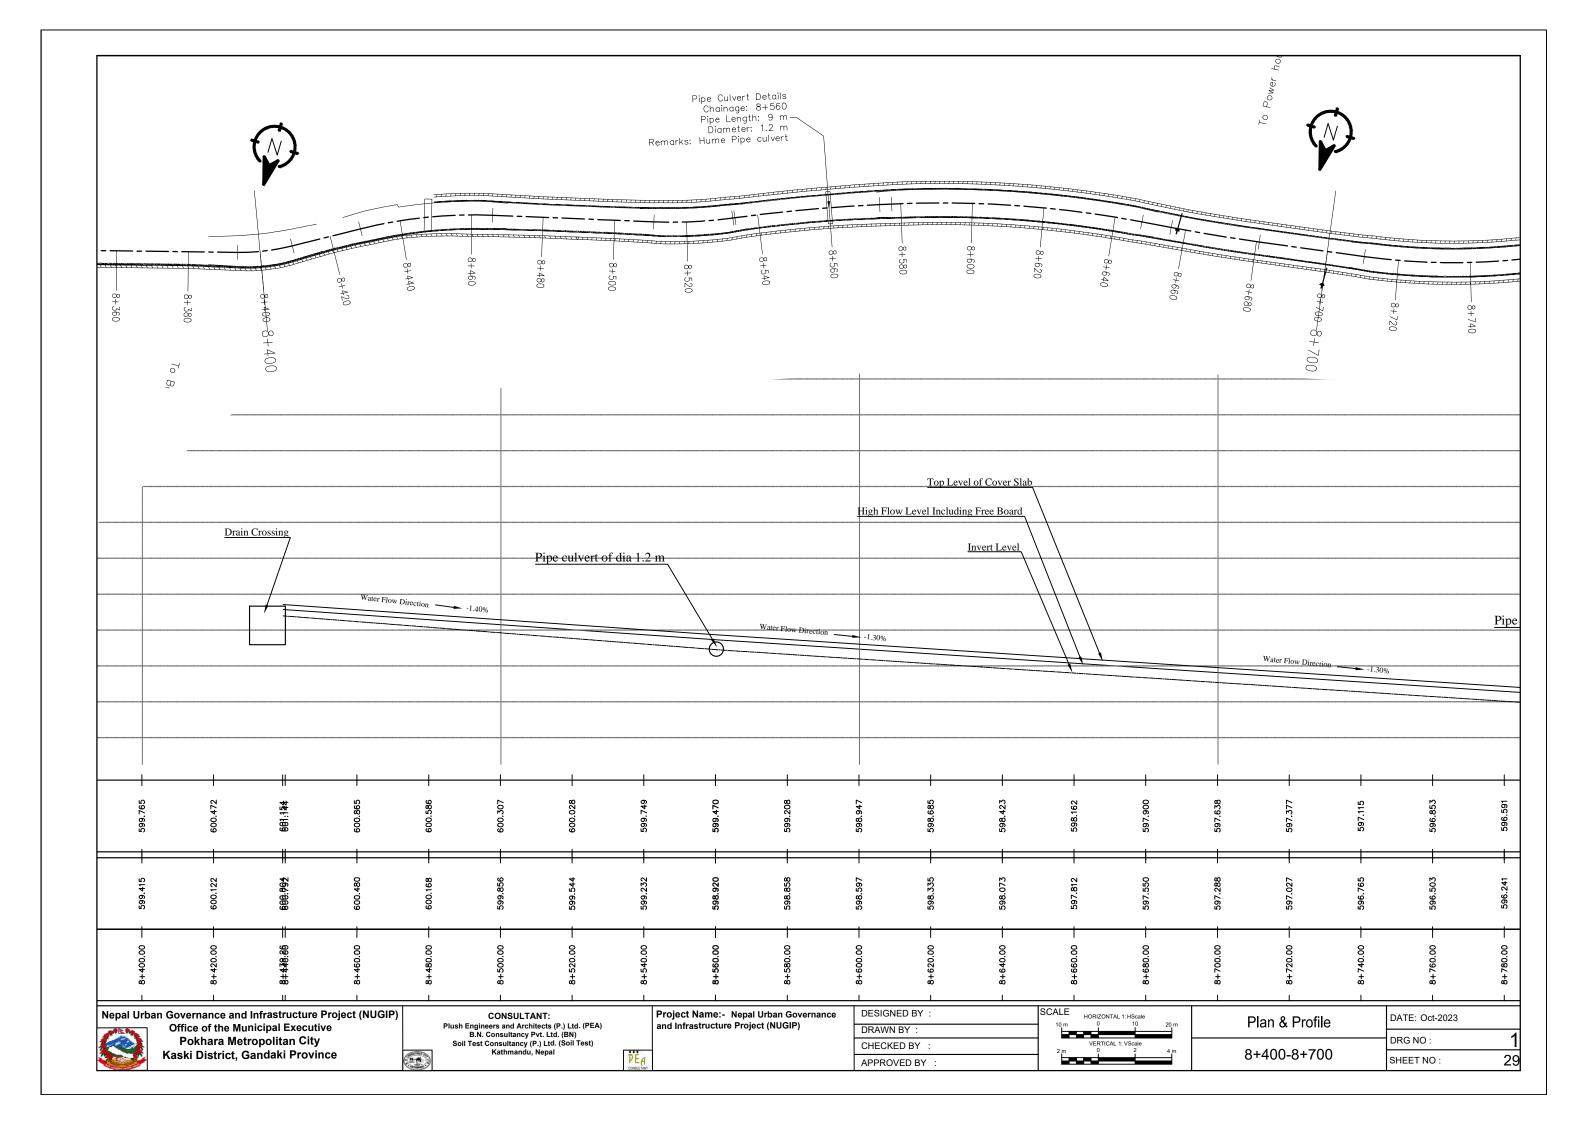

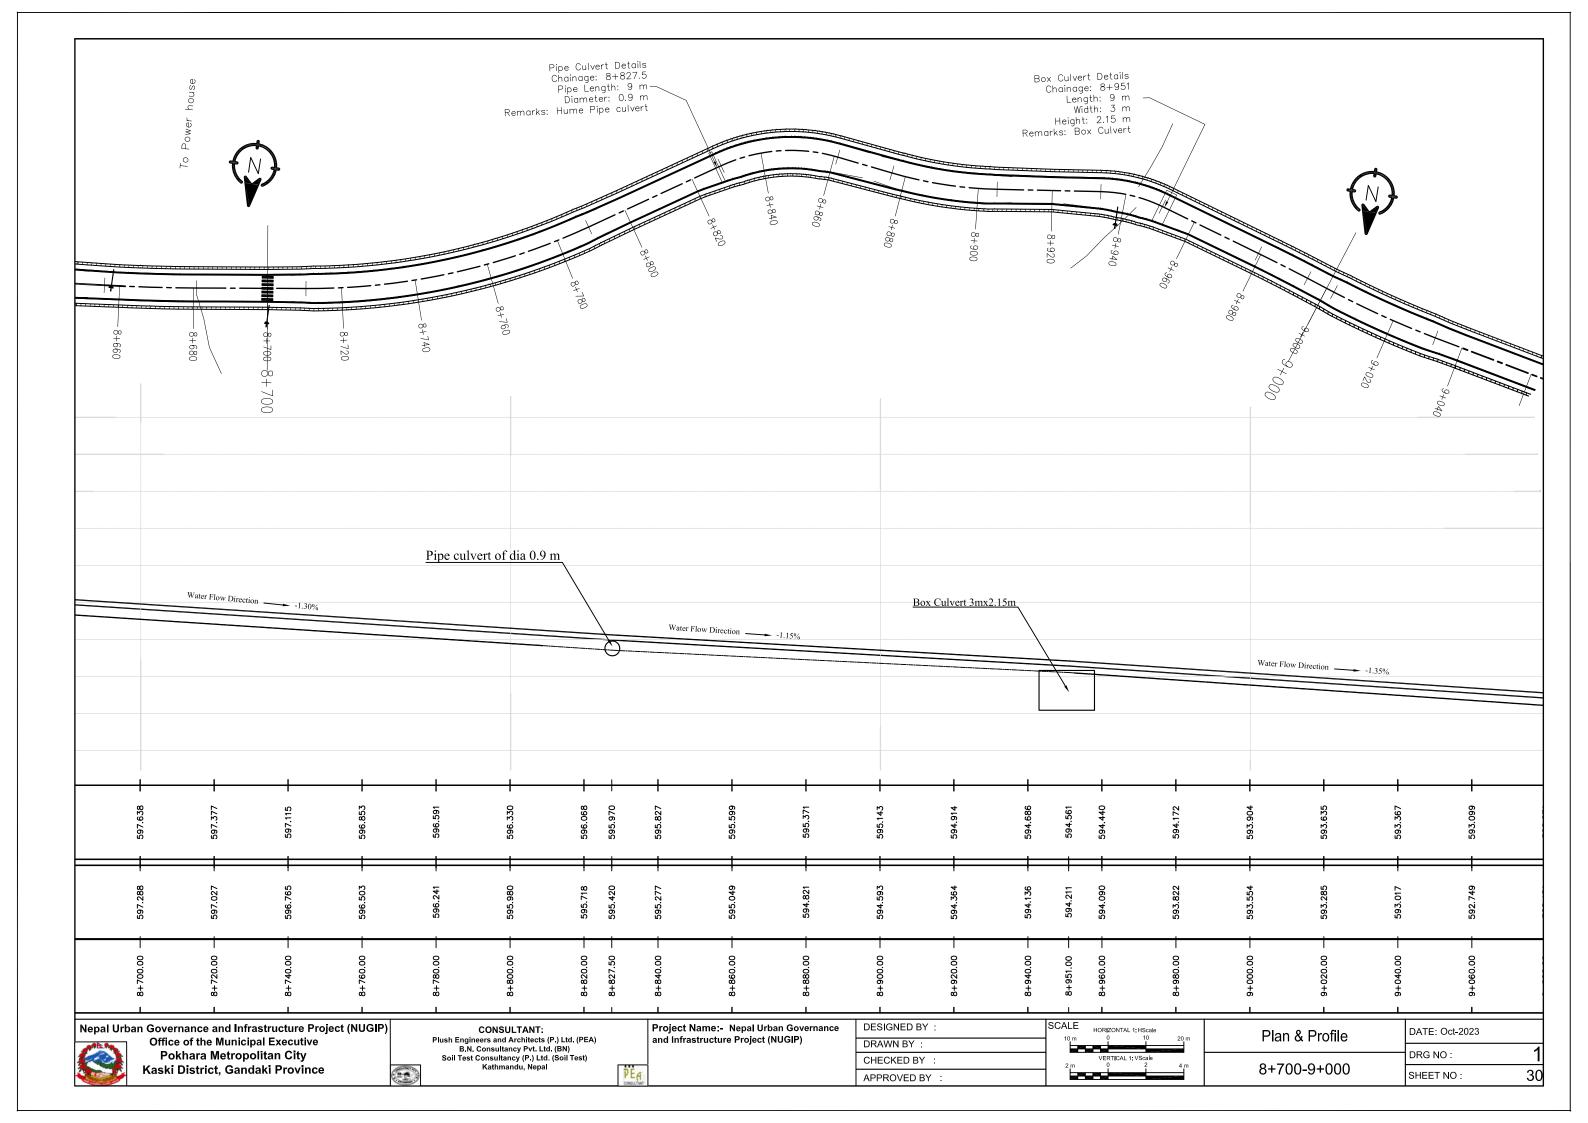


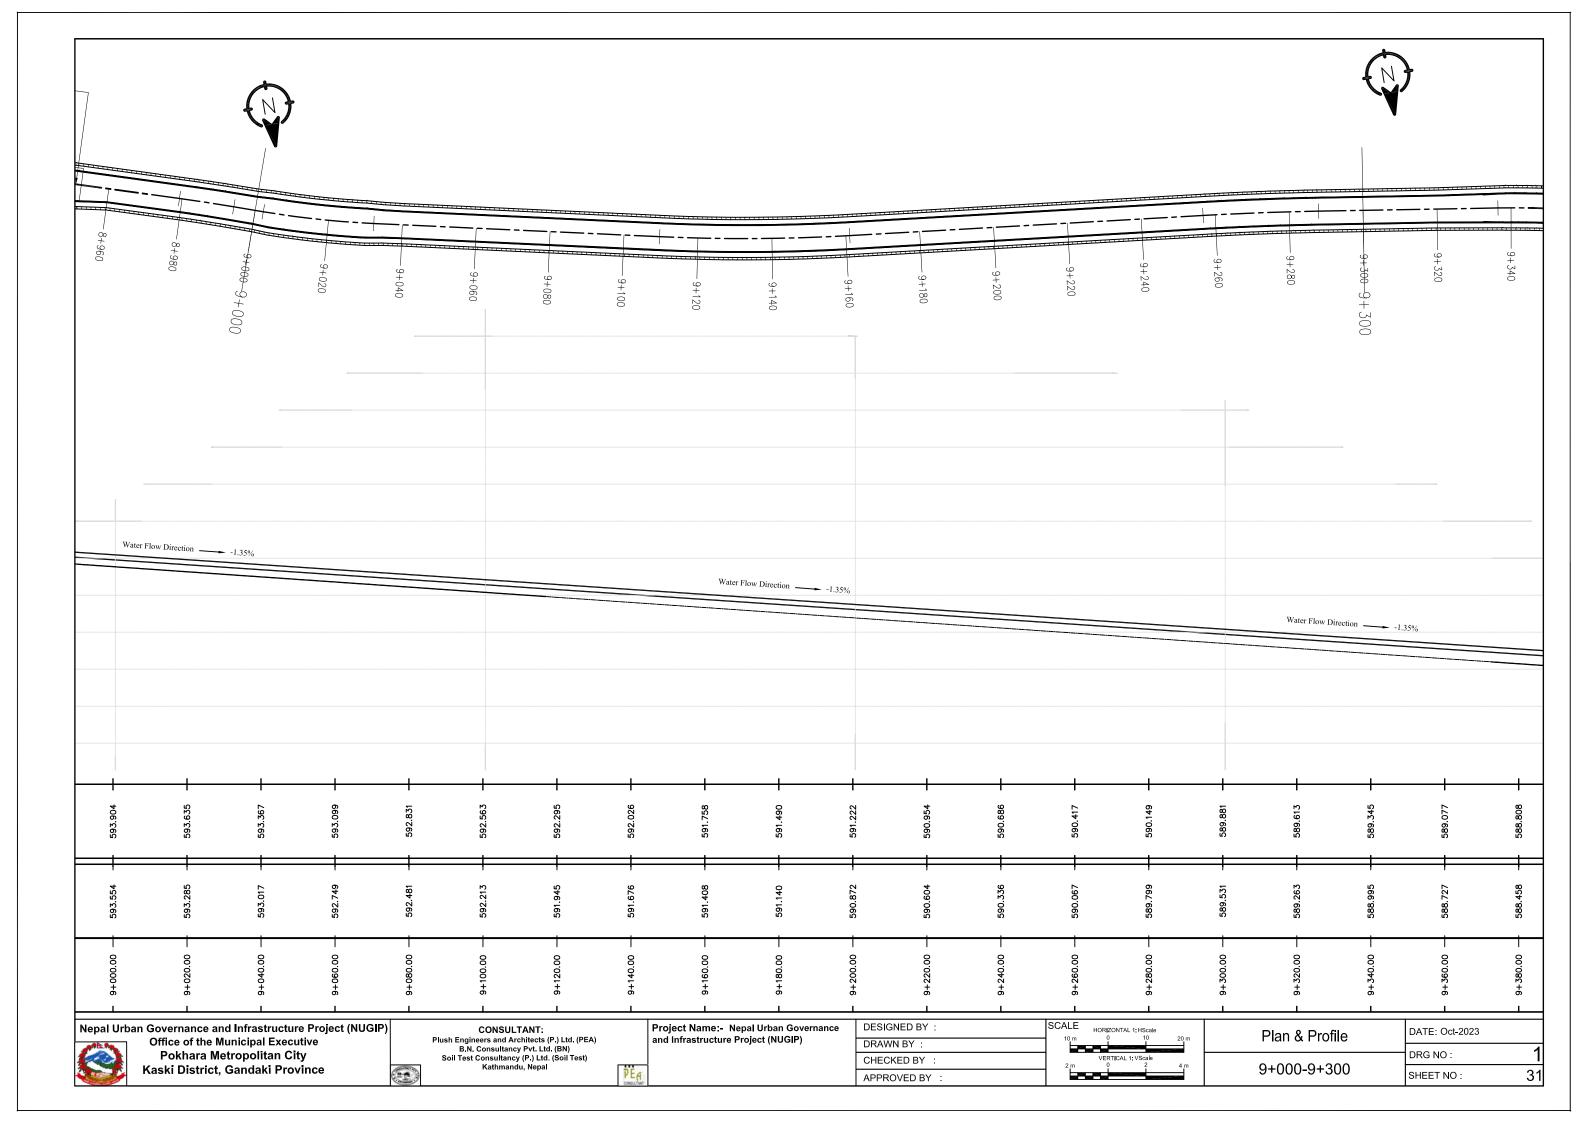


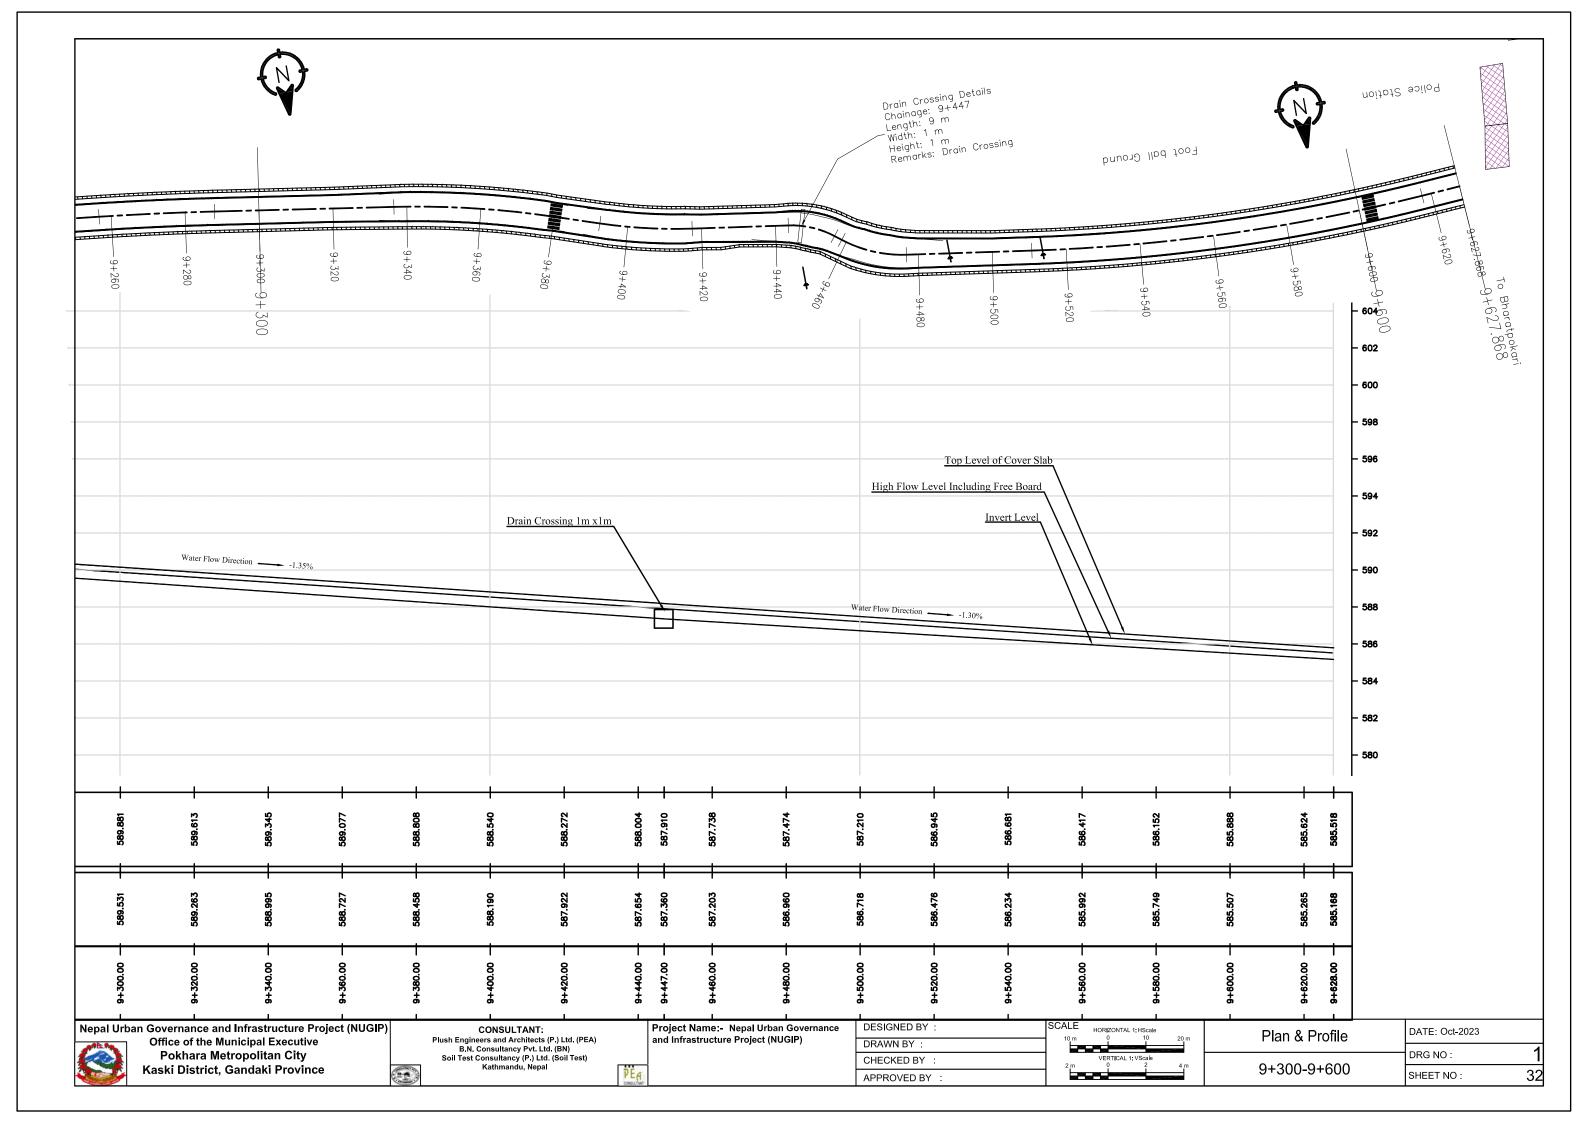


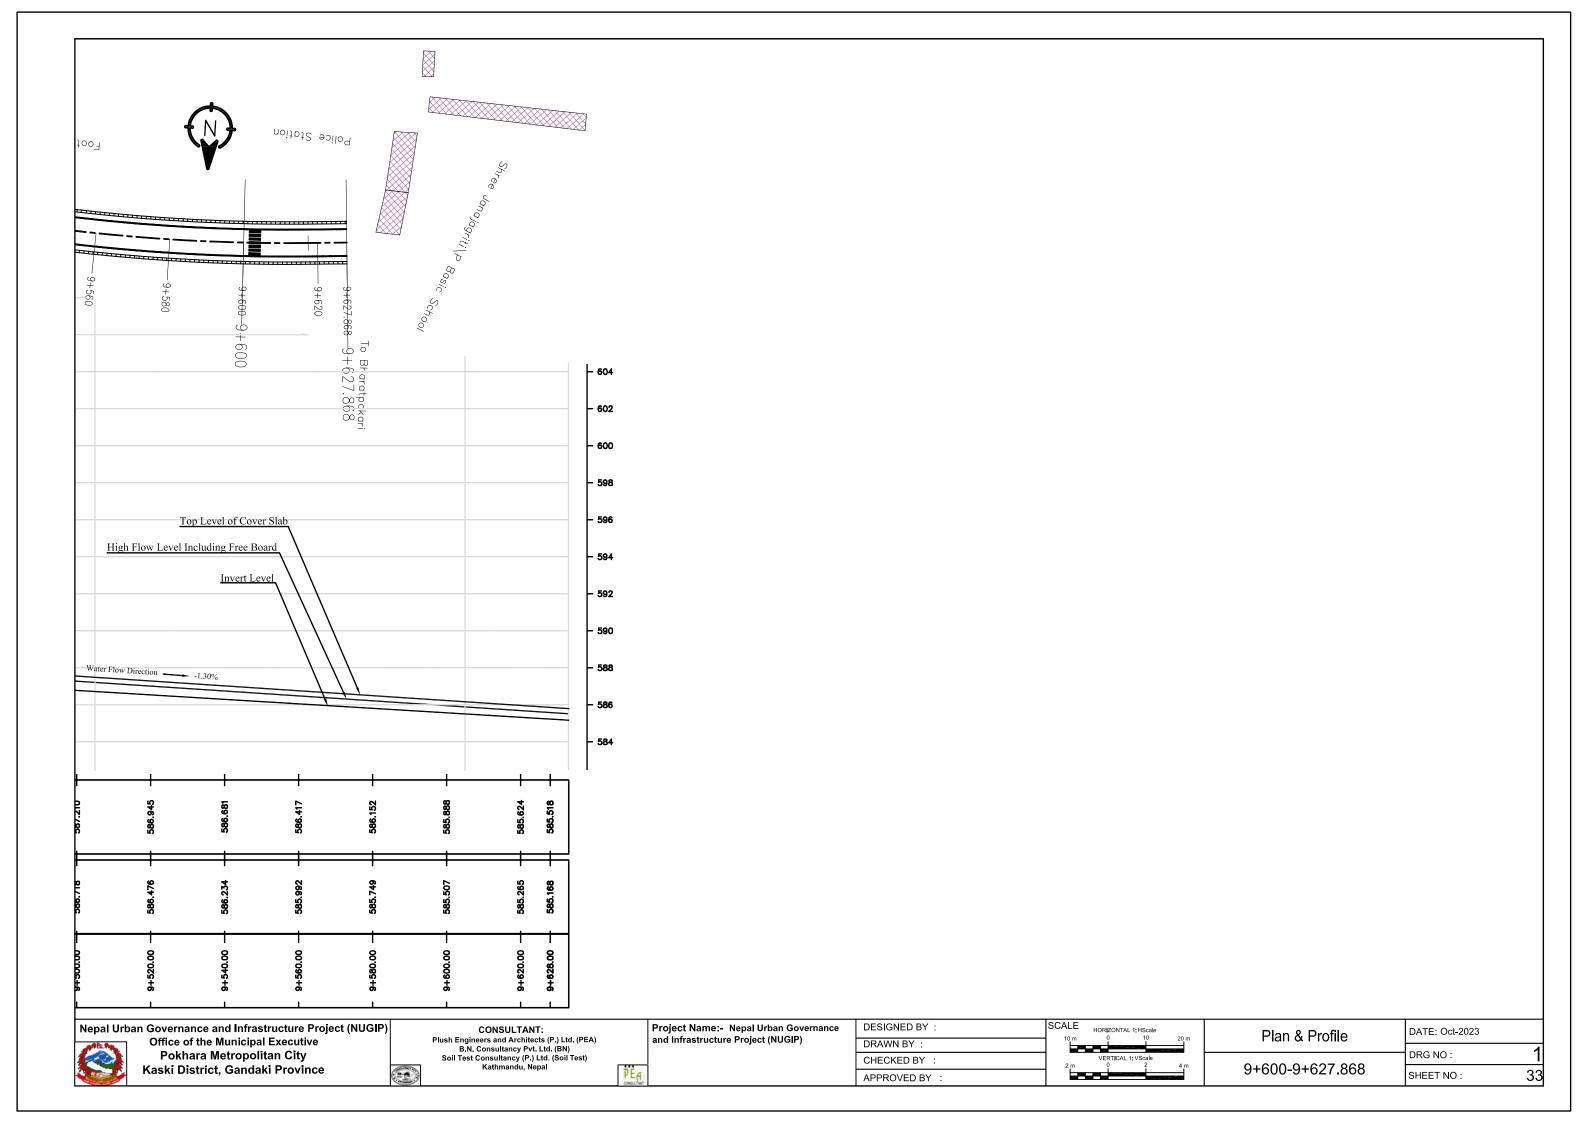



## SIDE DRAIN PLAN AND PROFILE SECTION - II

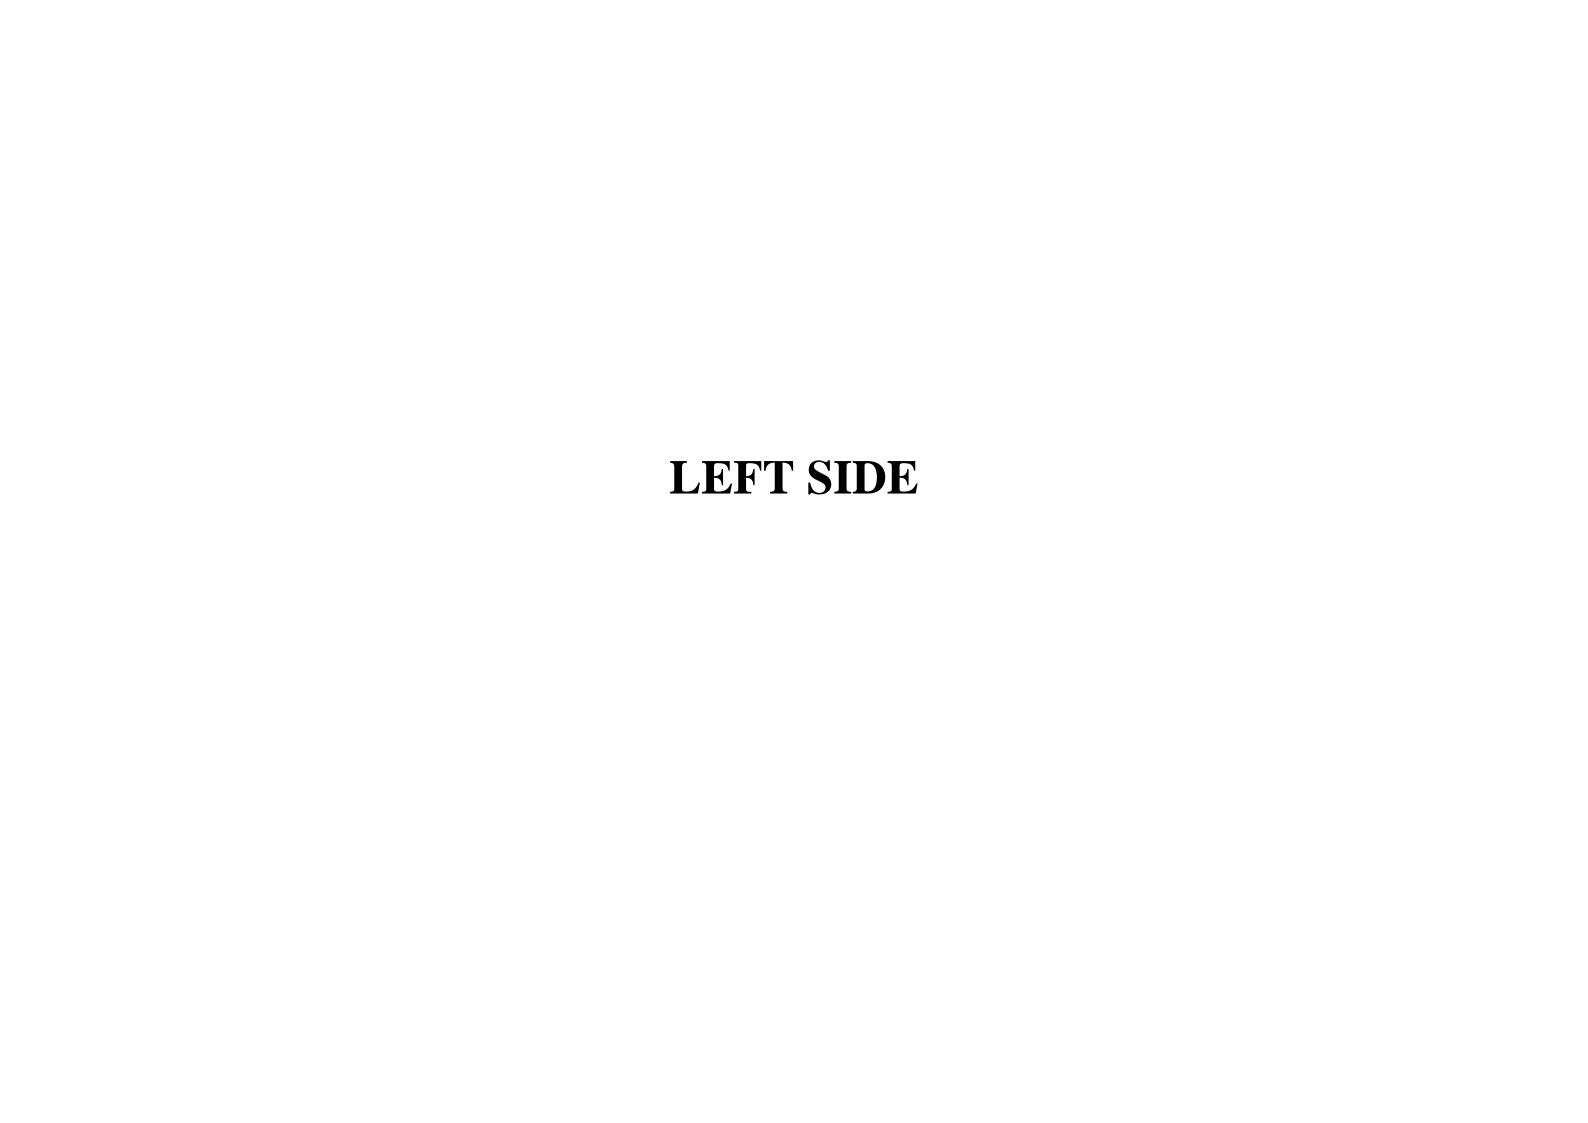


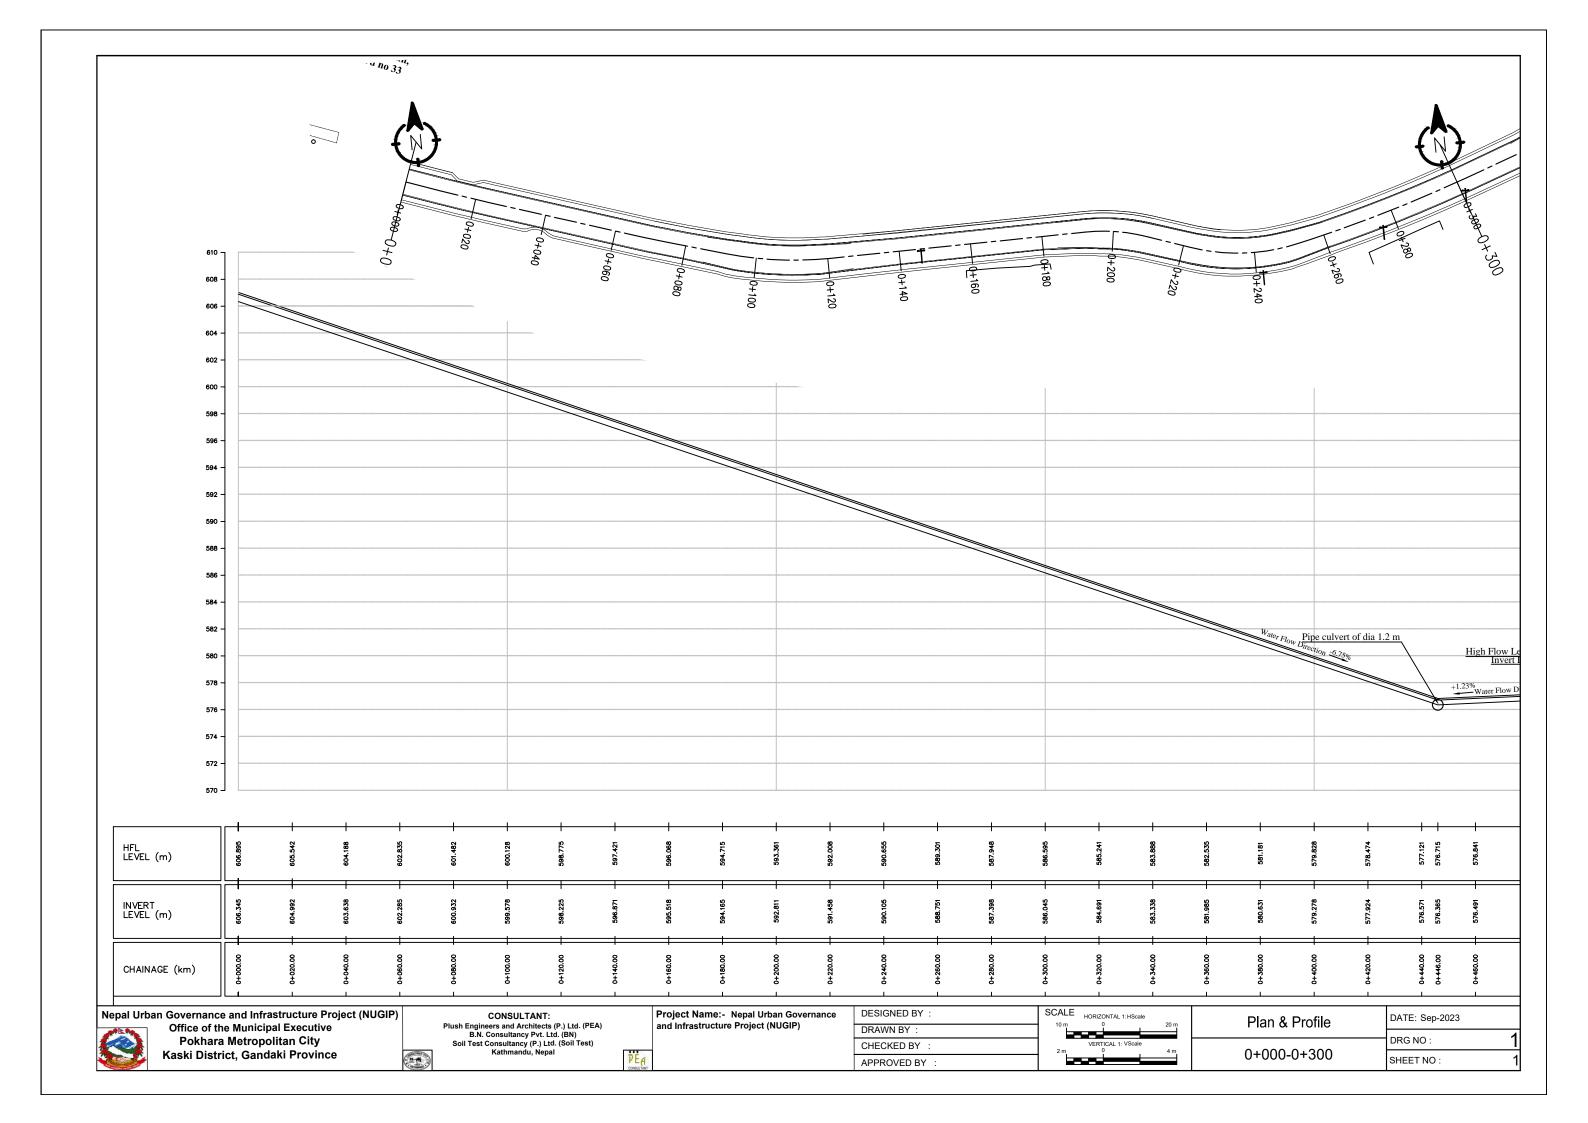


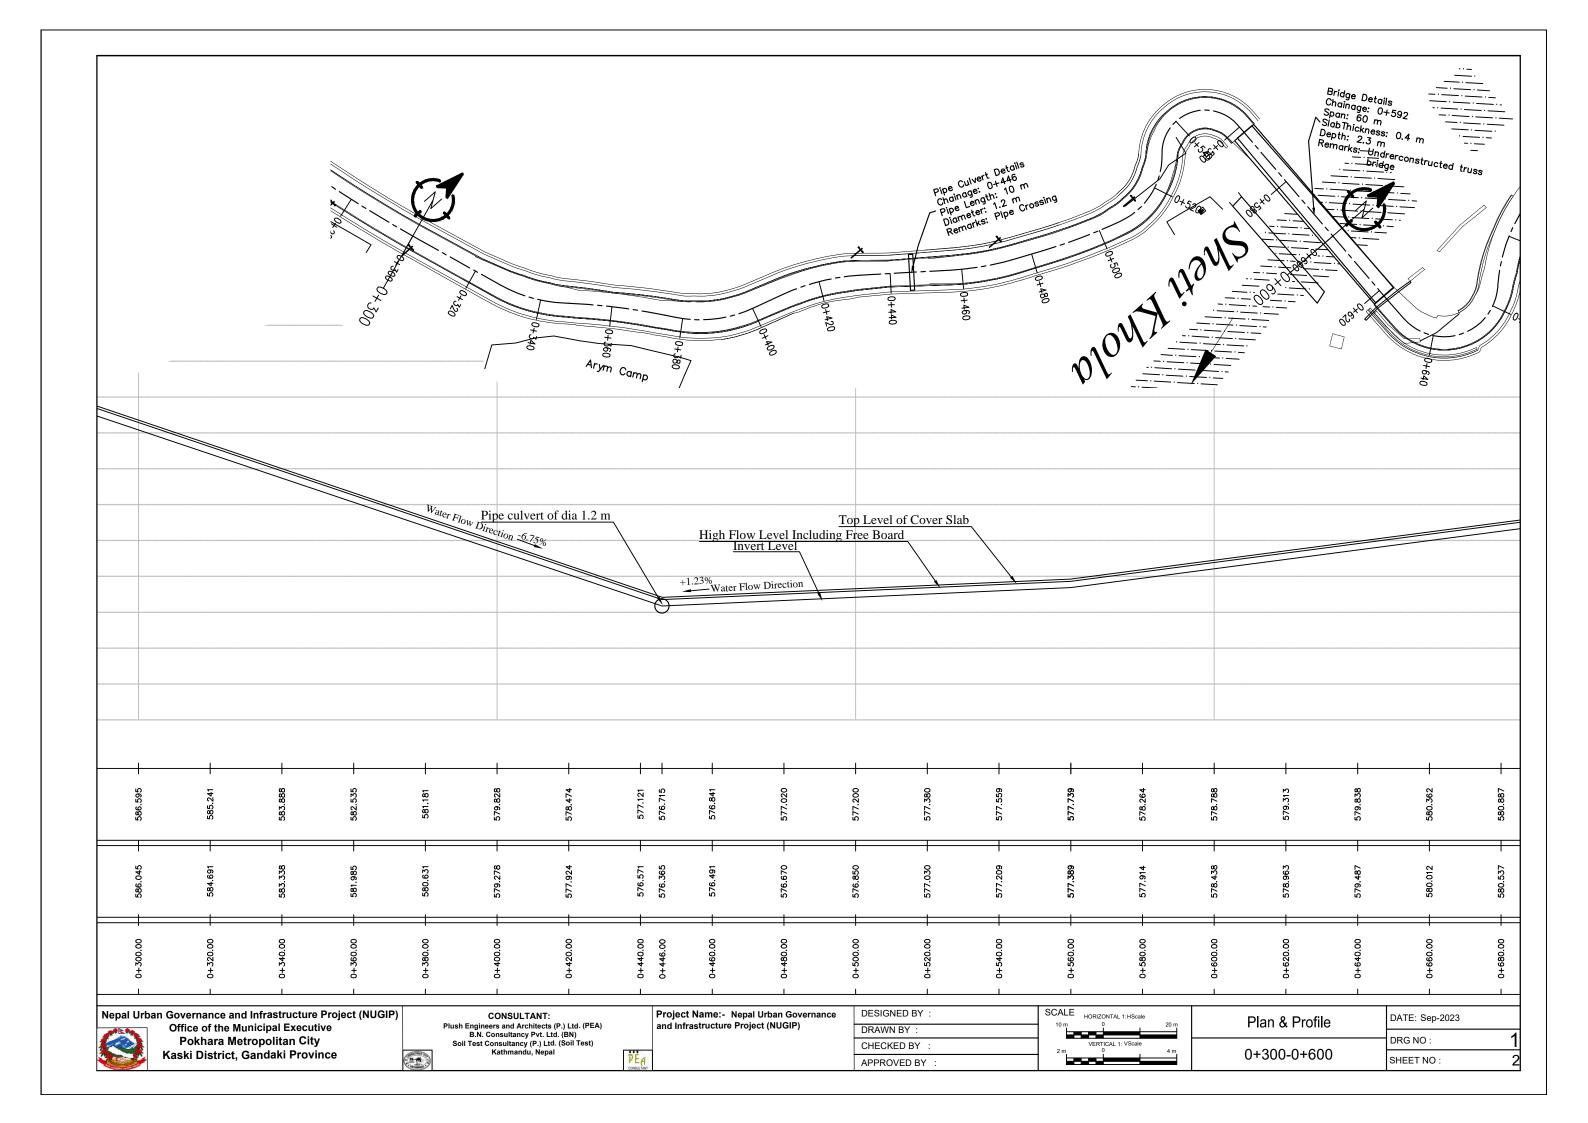


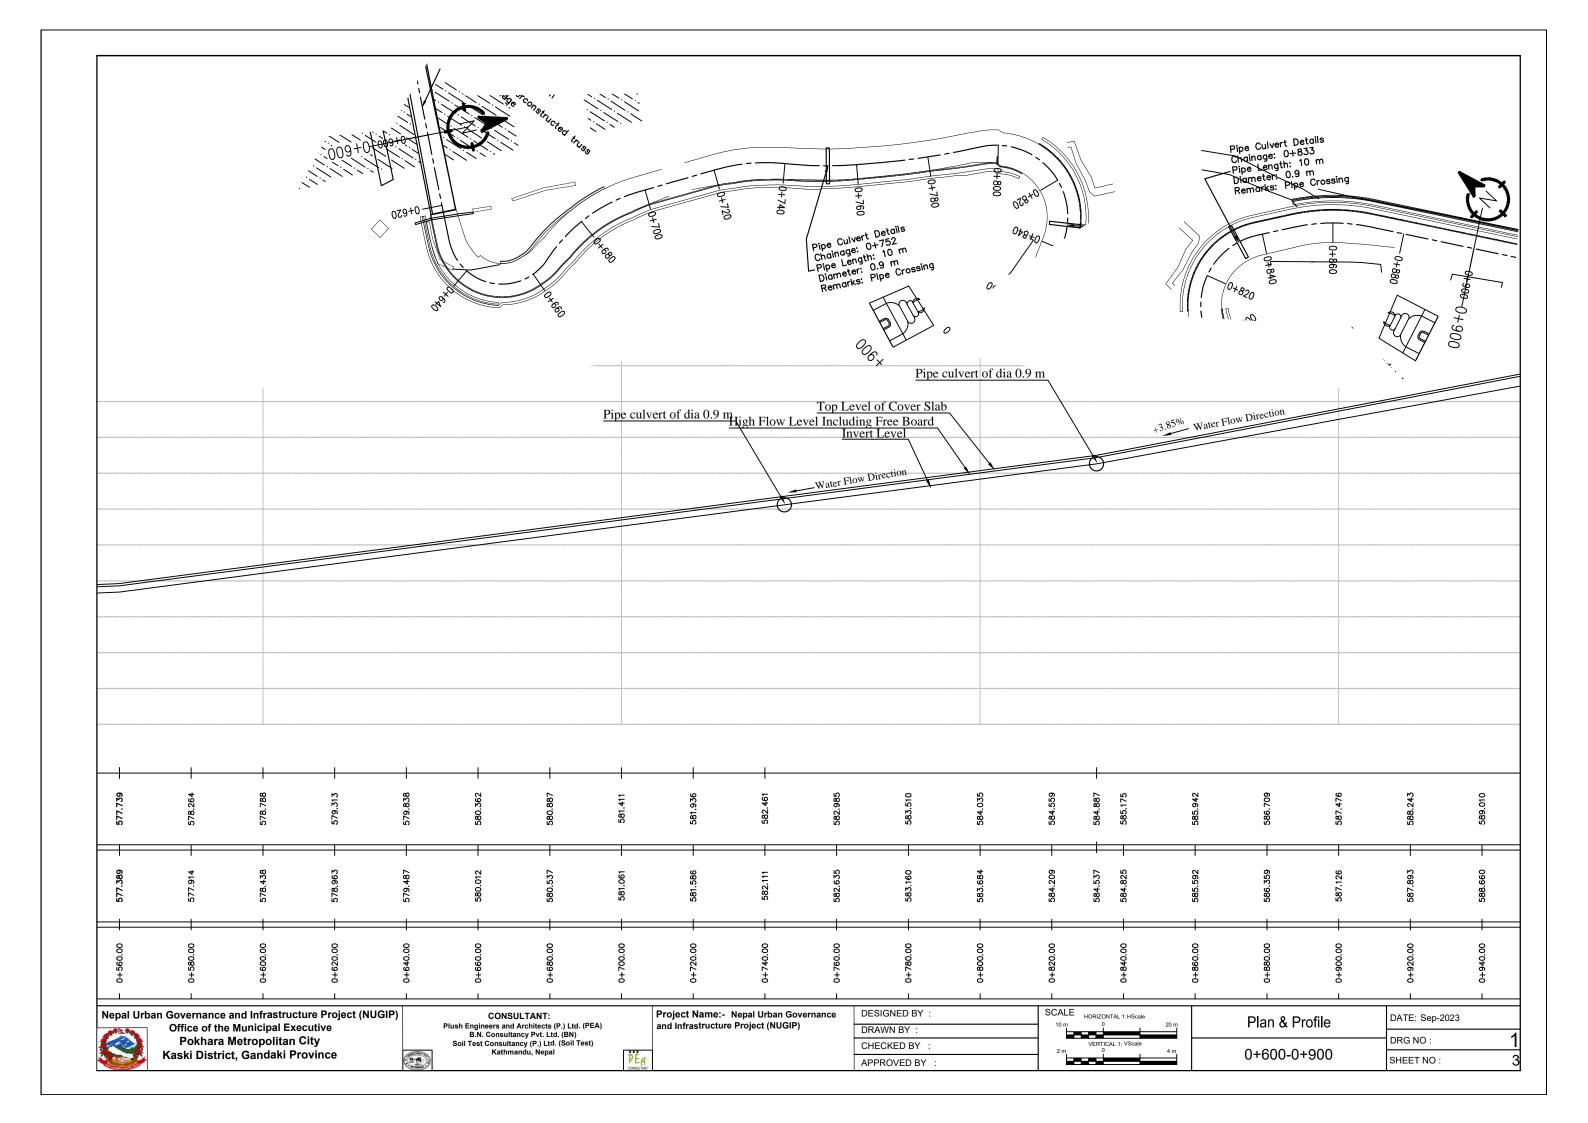


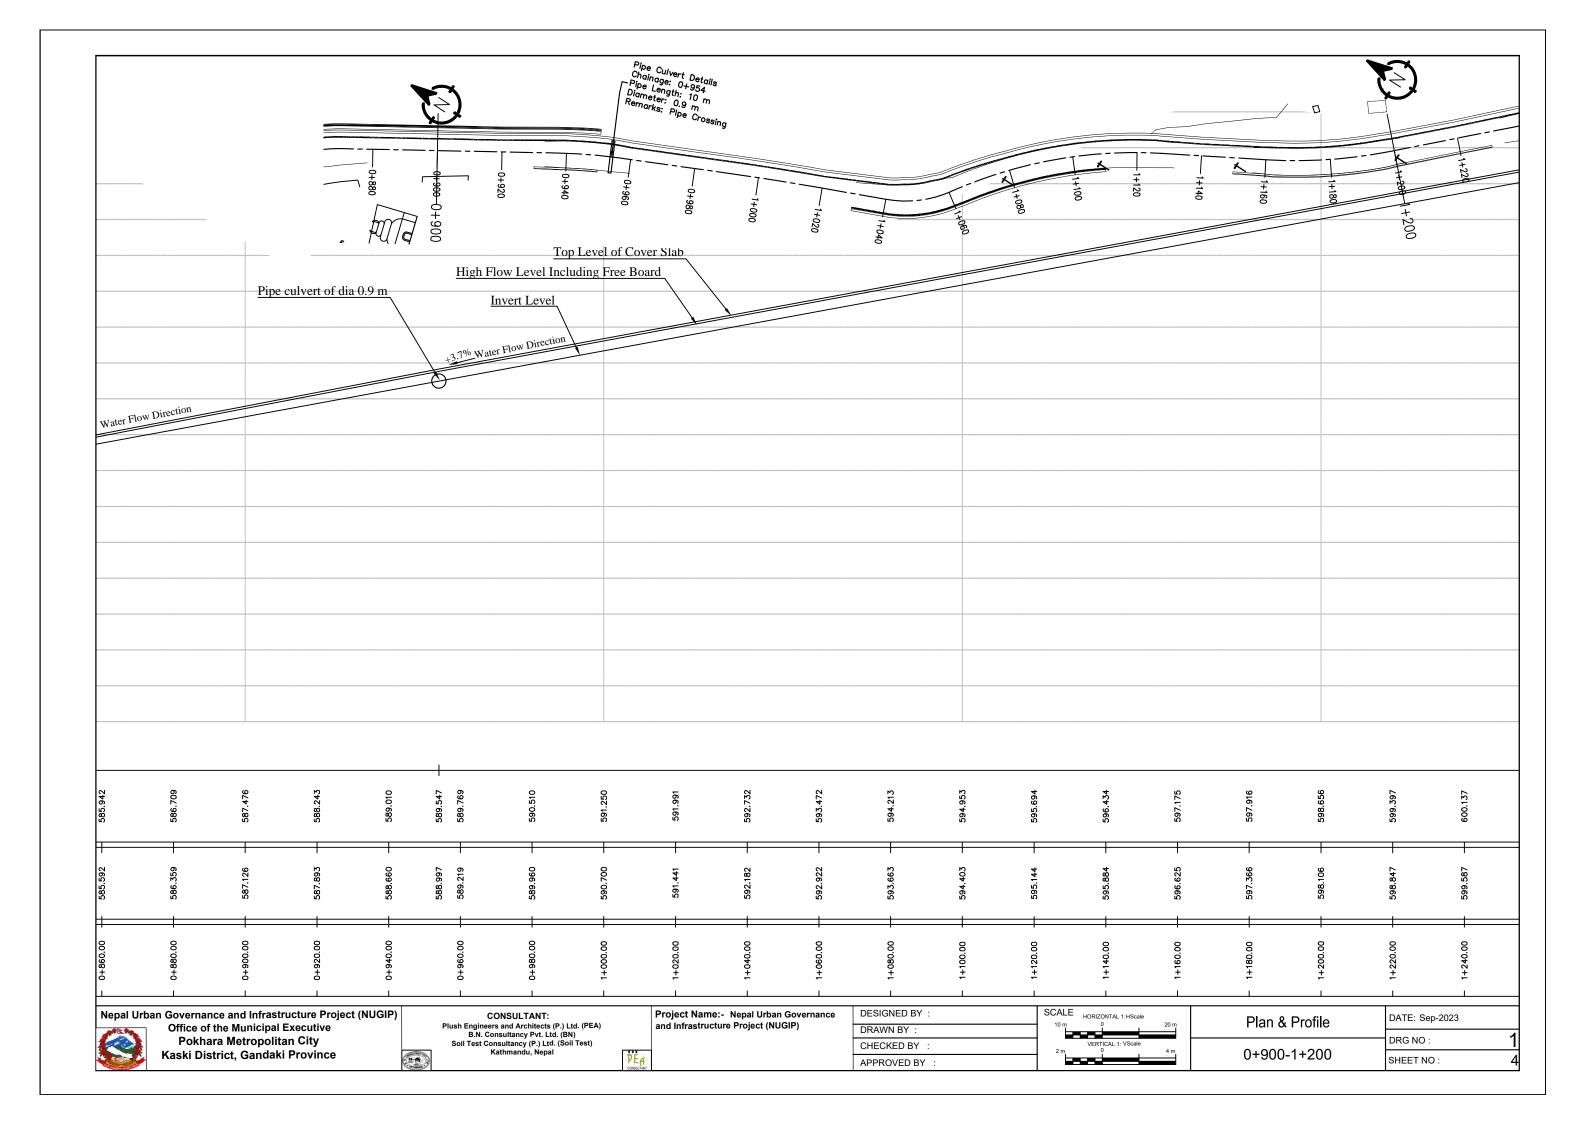


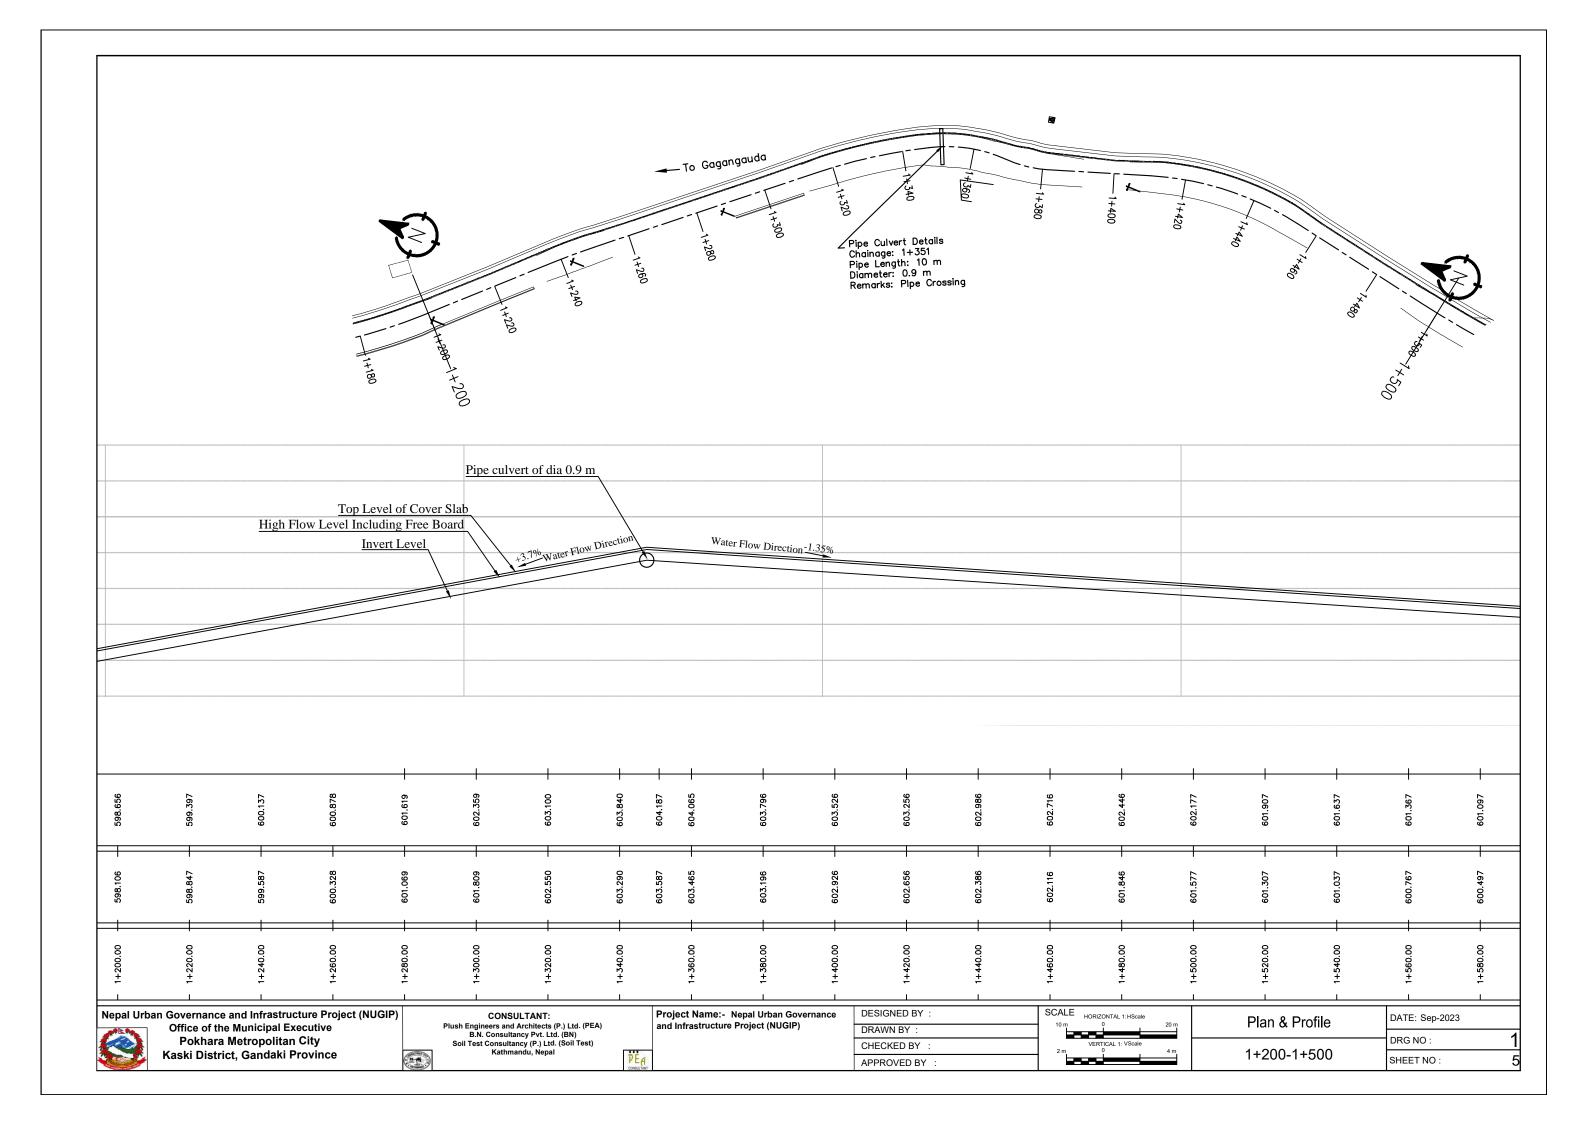


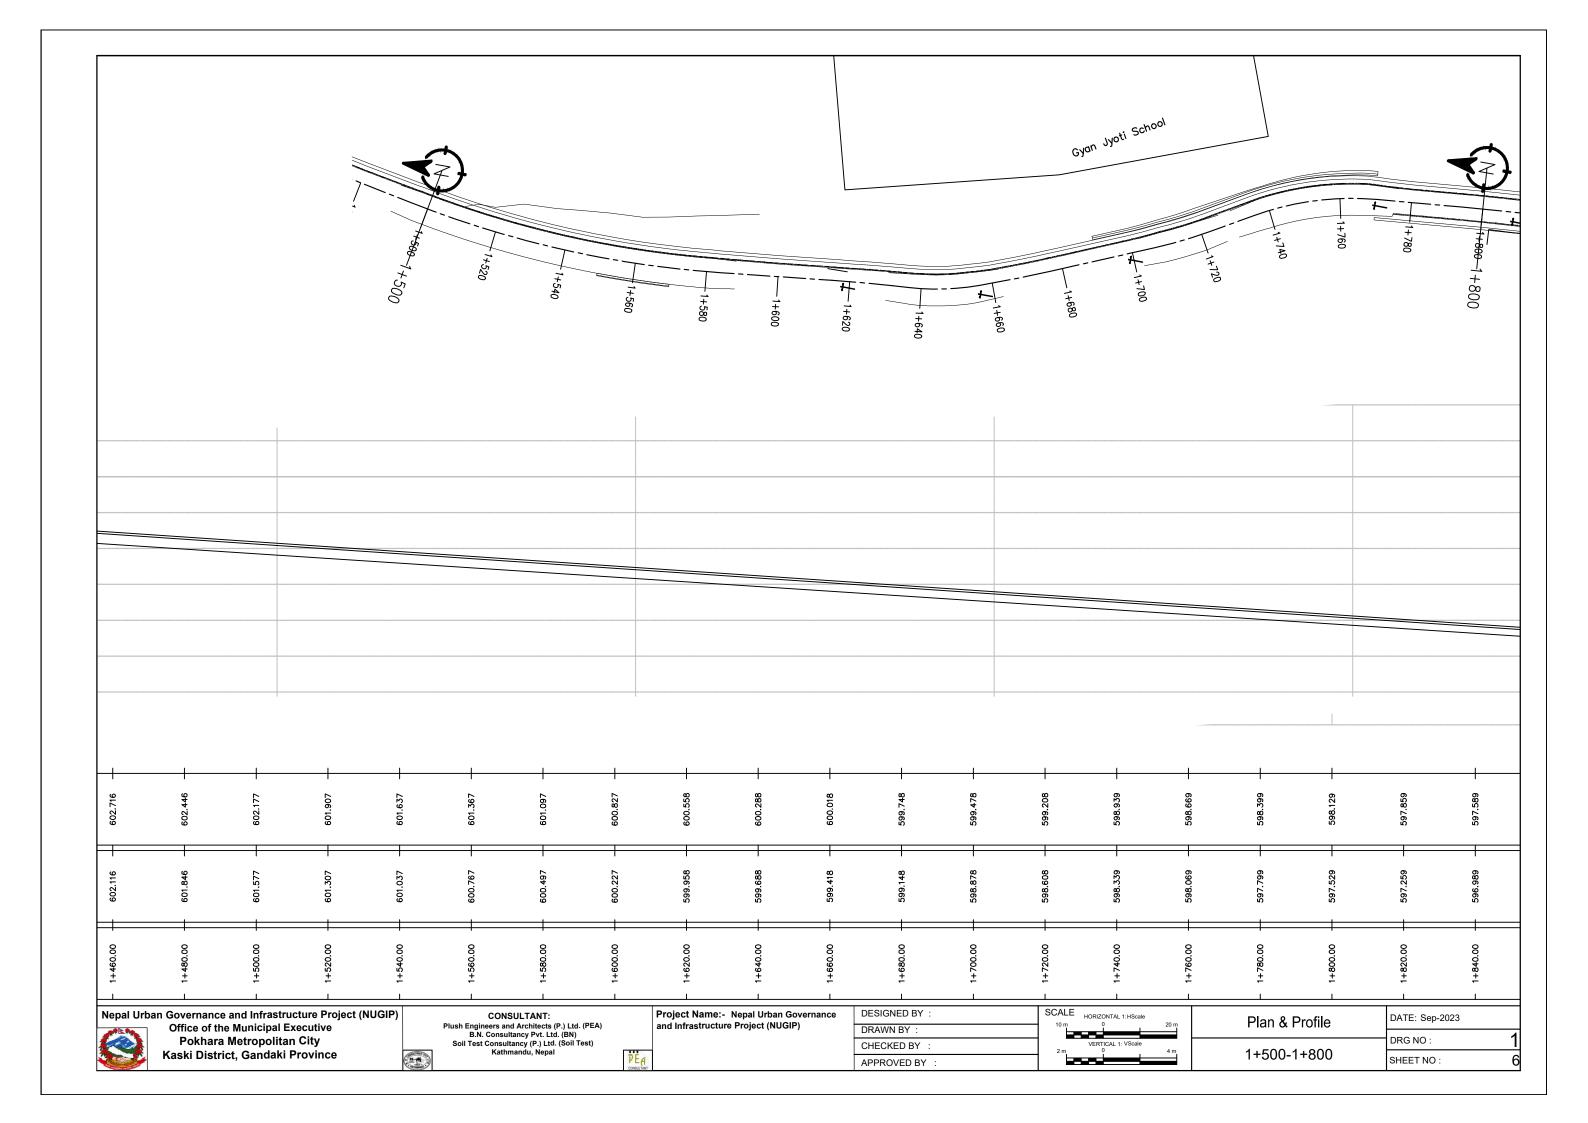


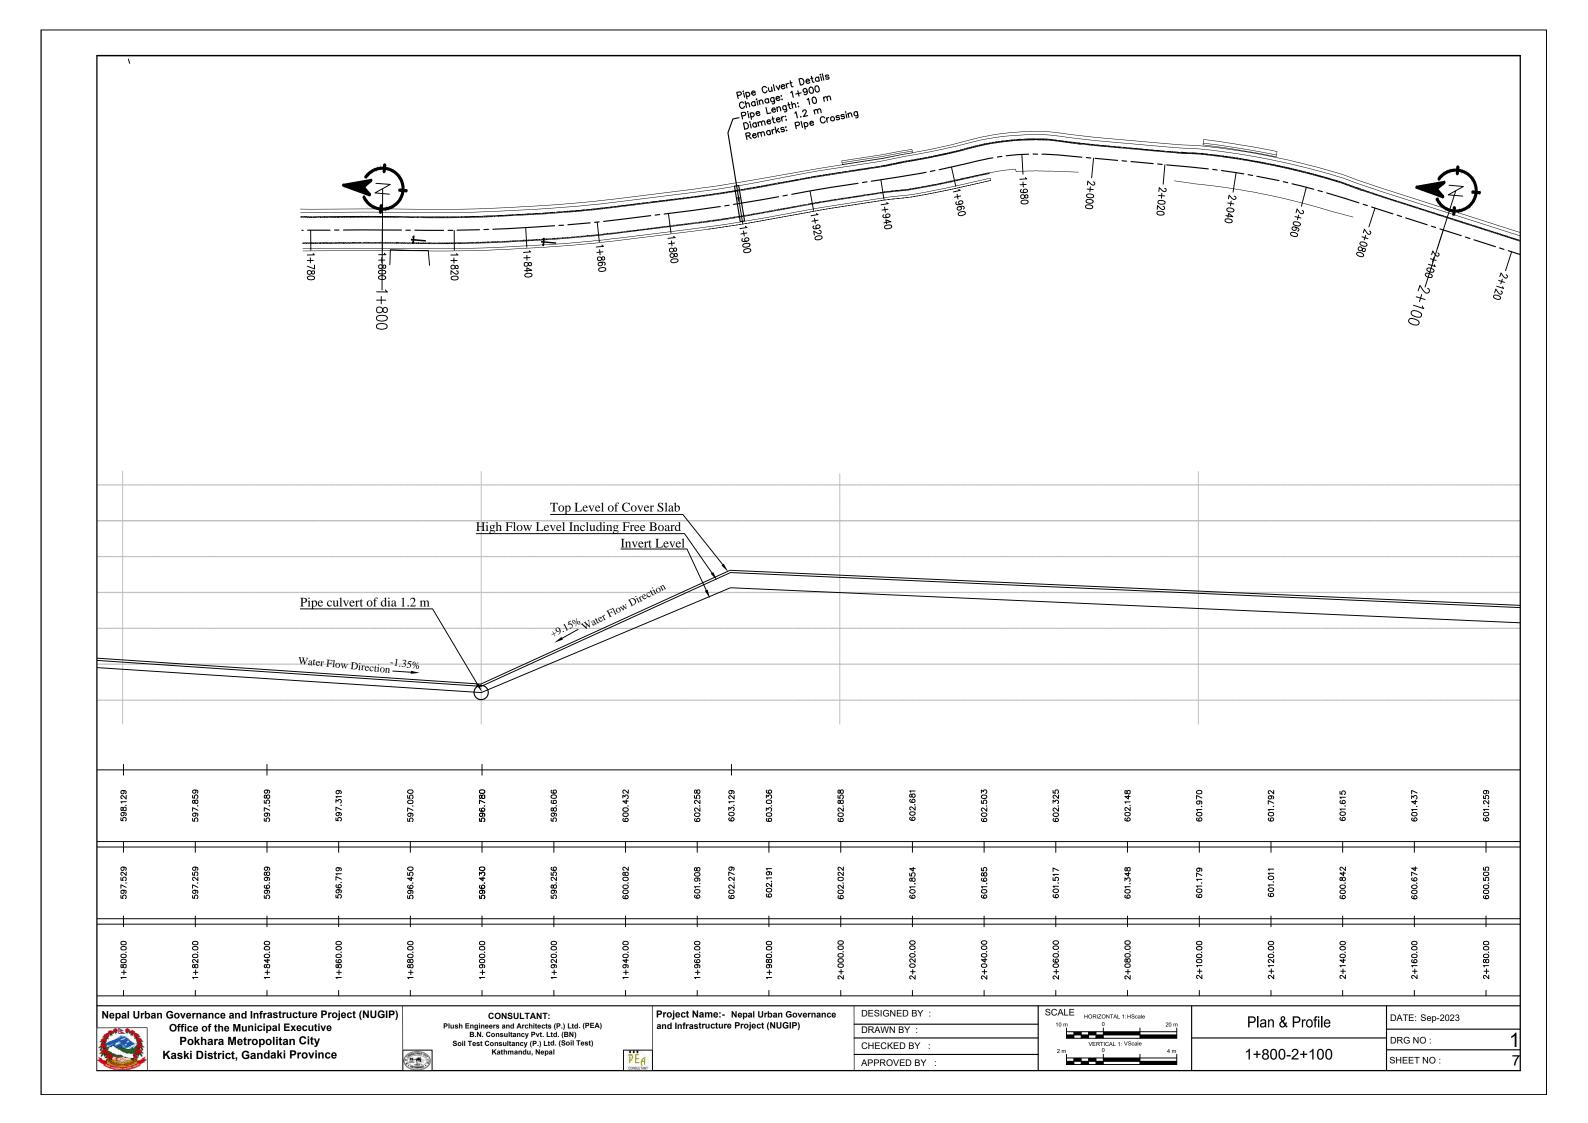


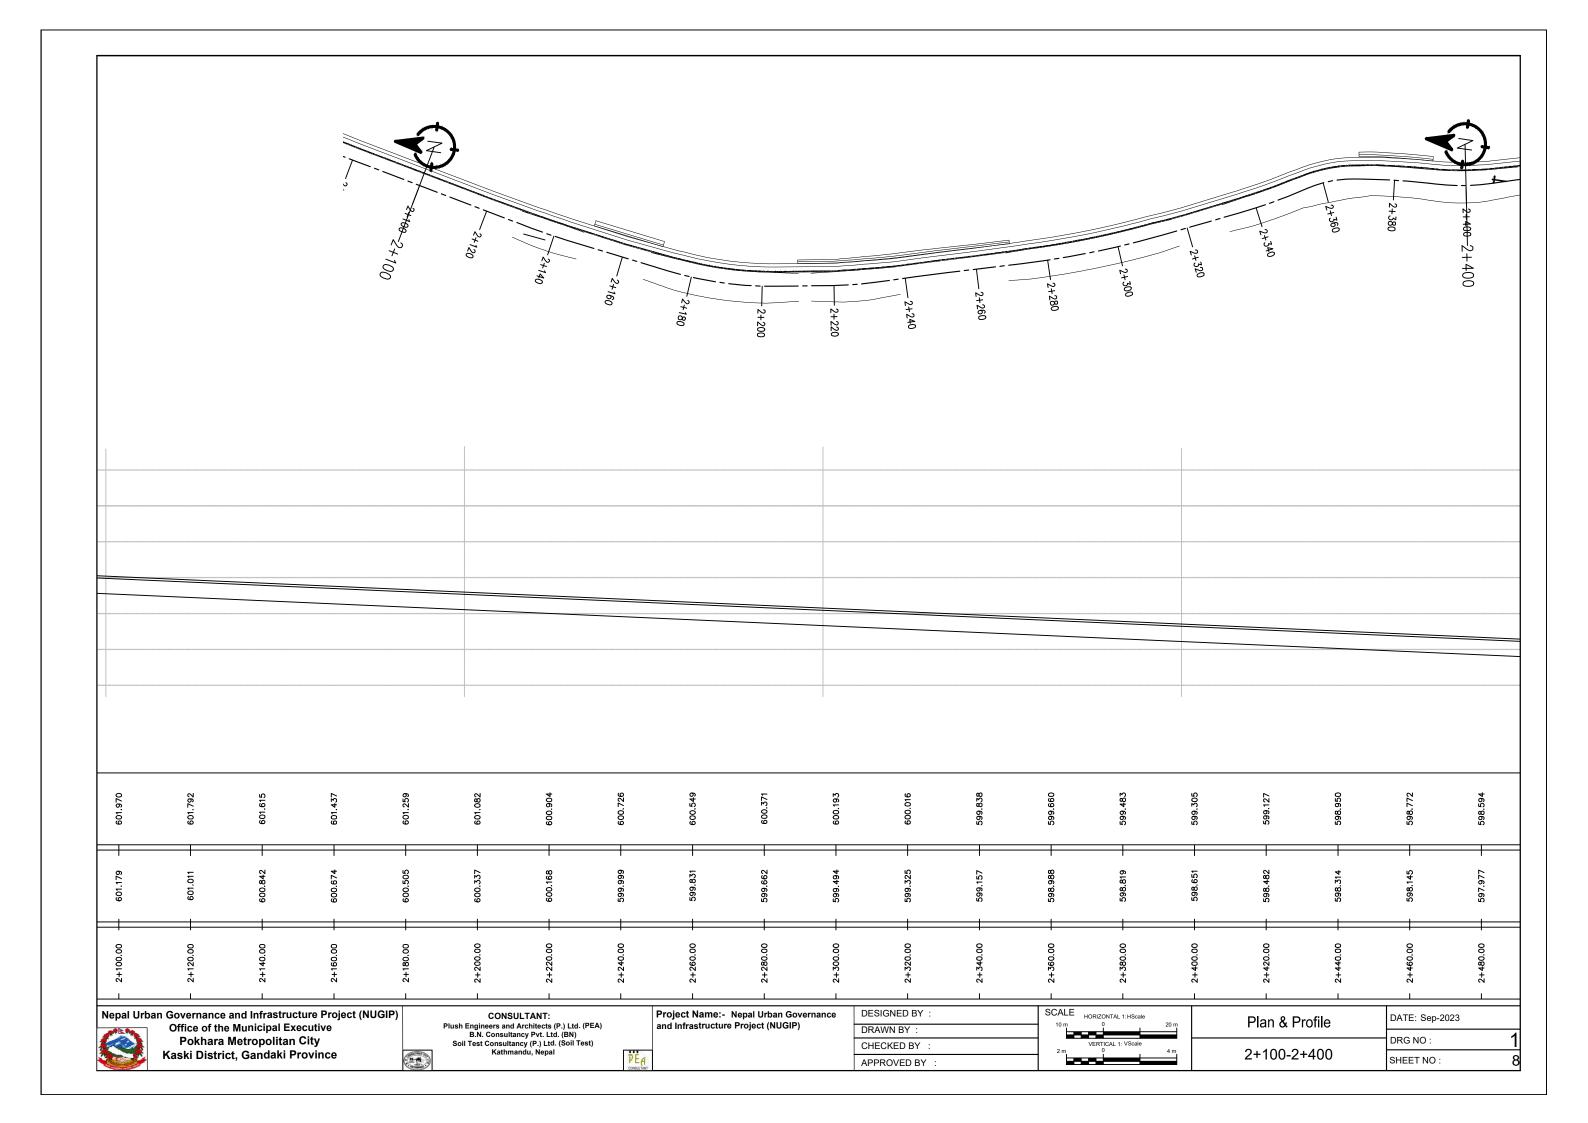


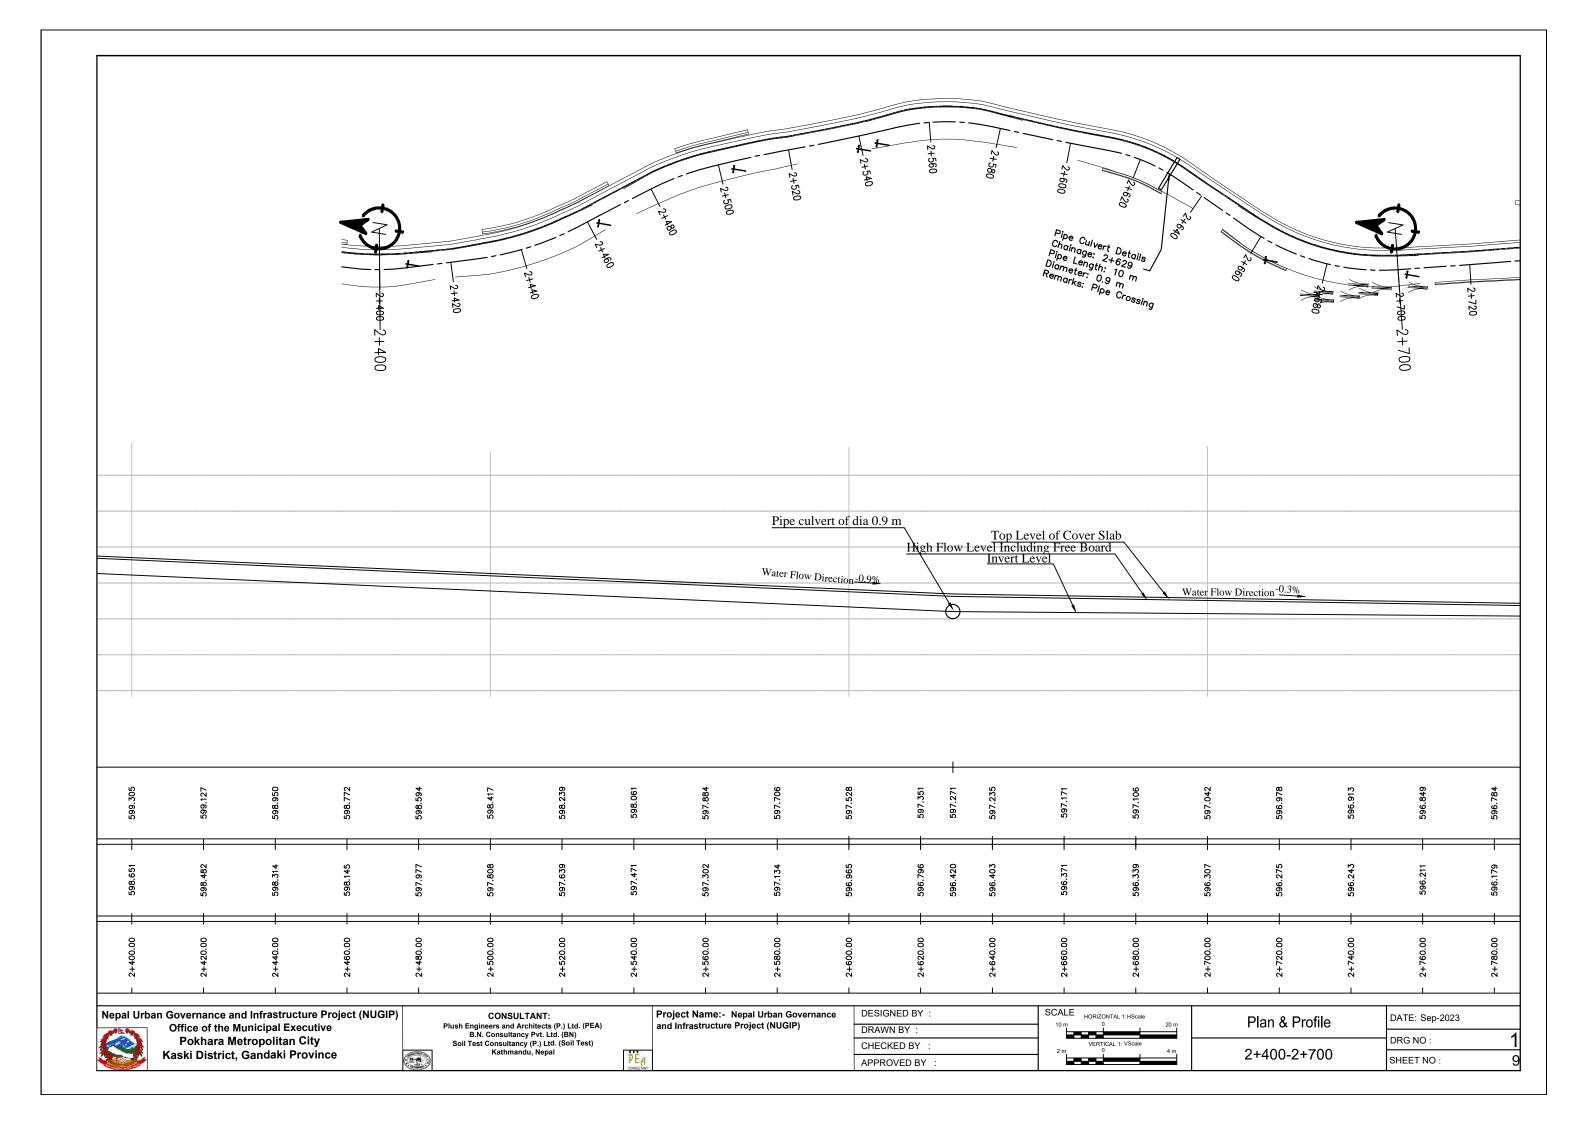


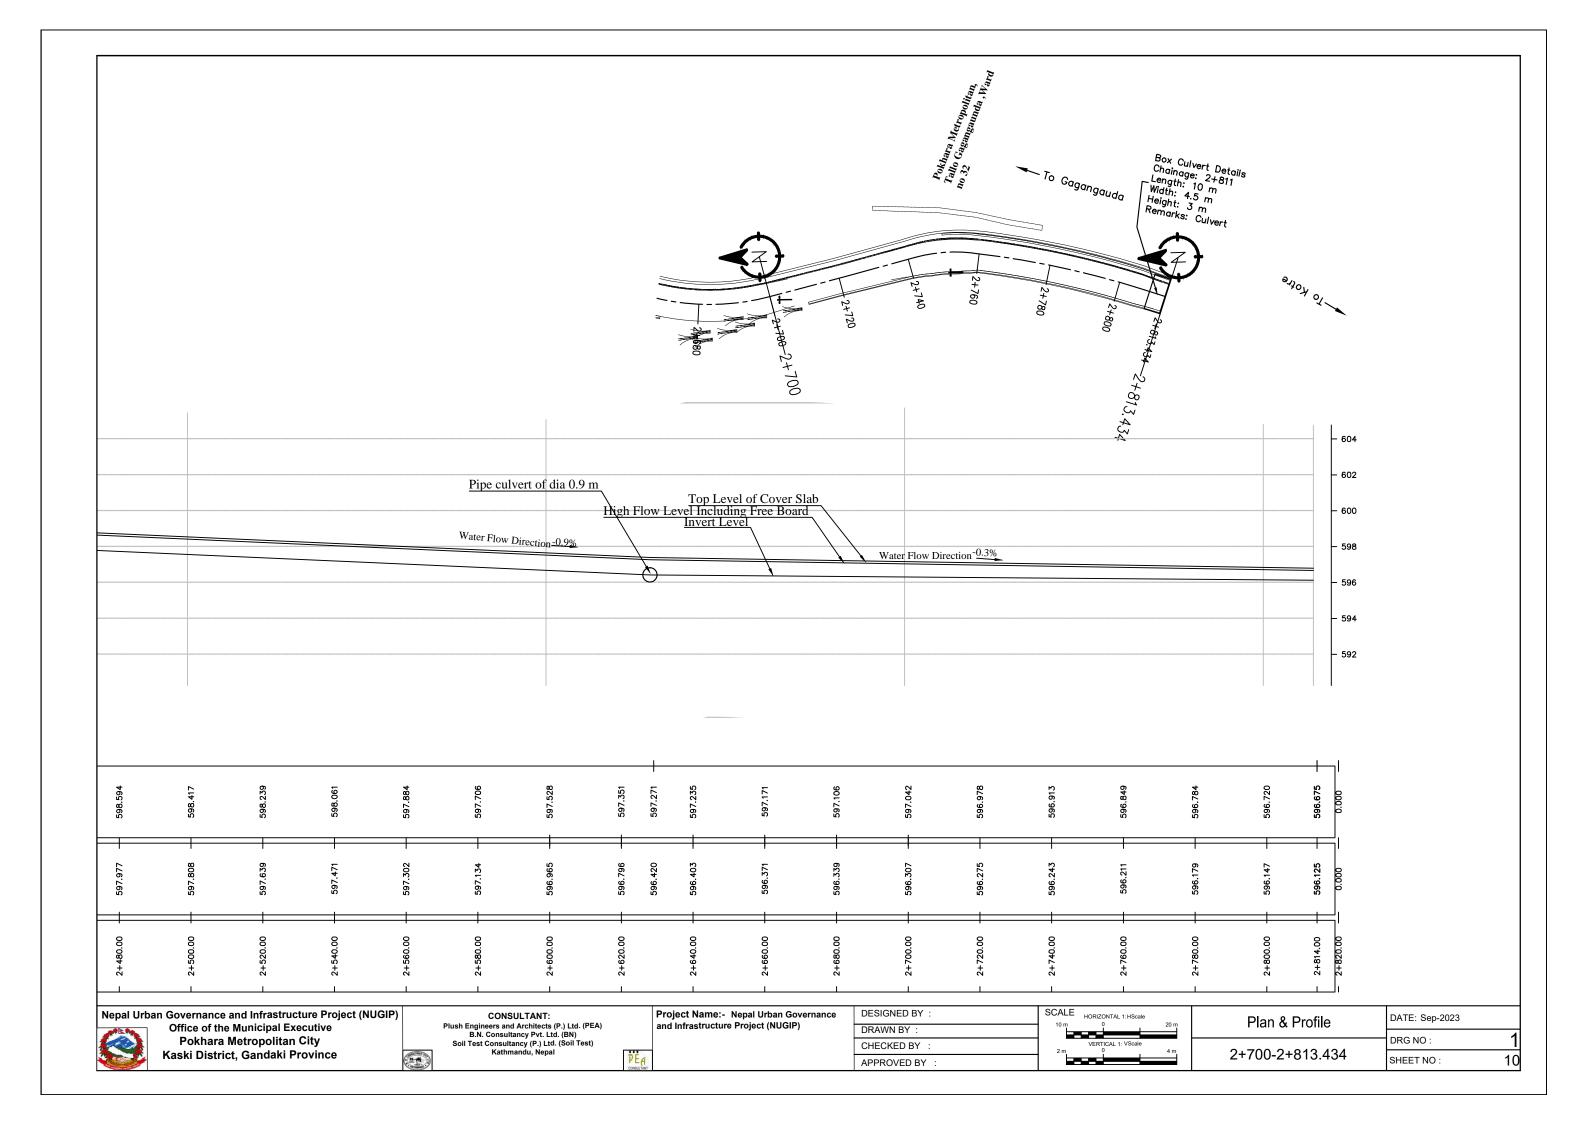


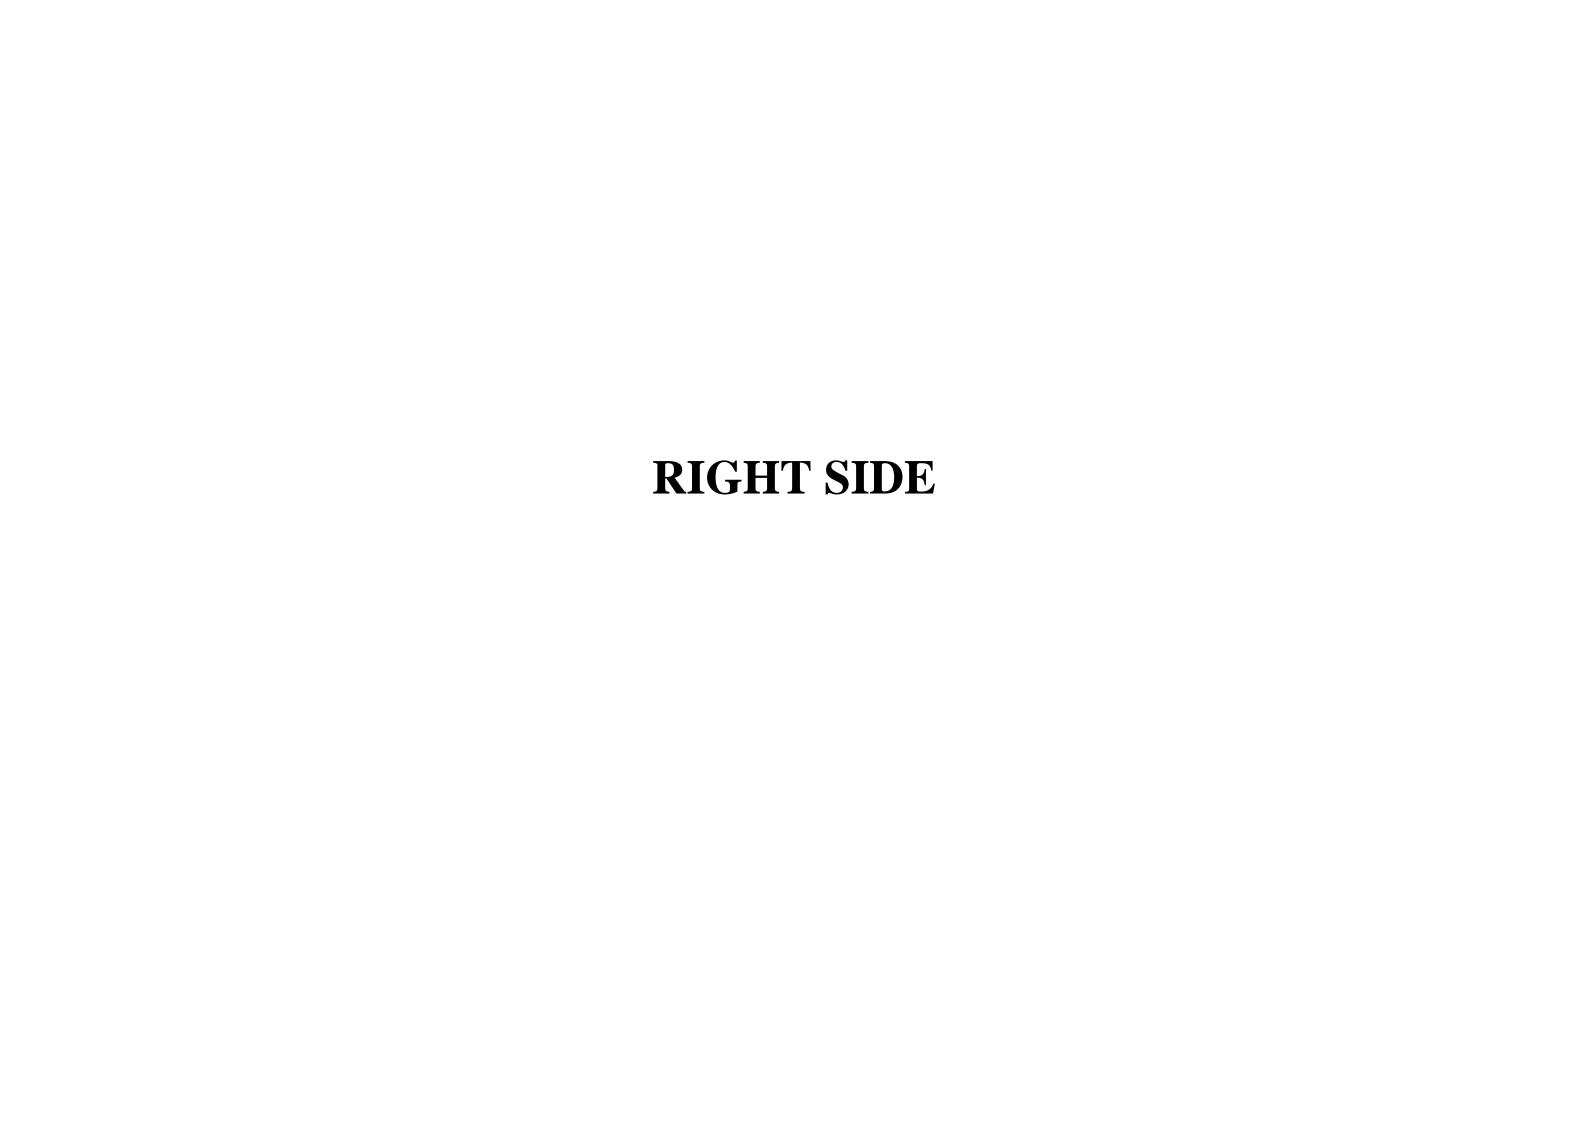


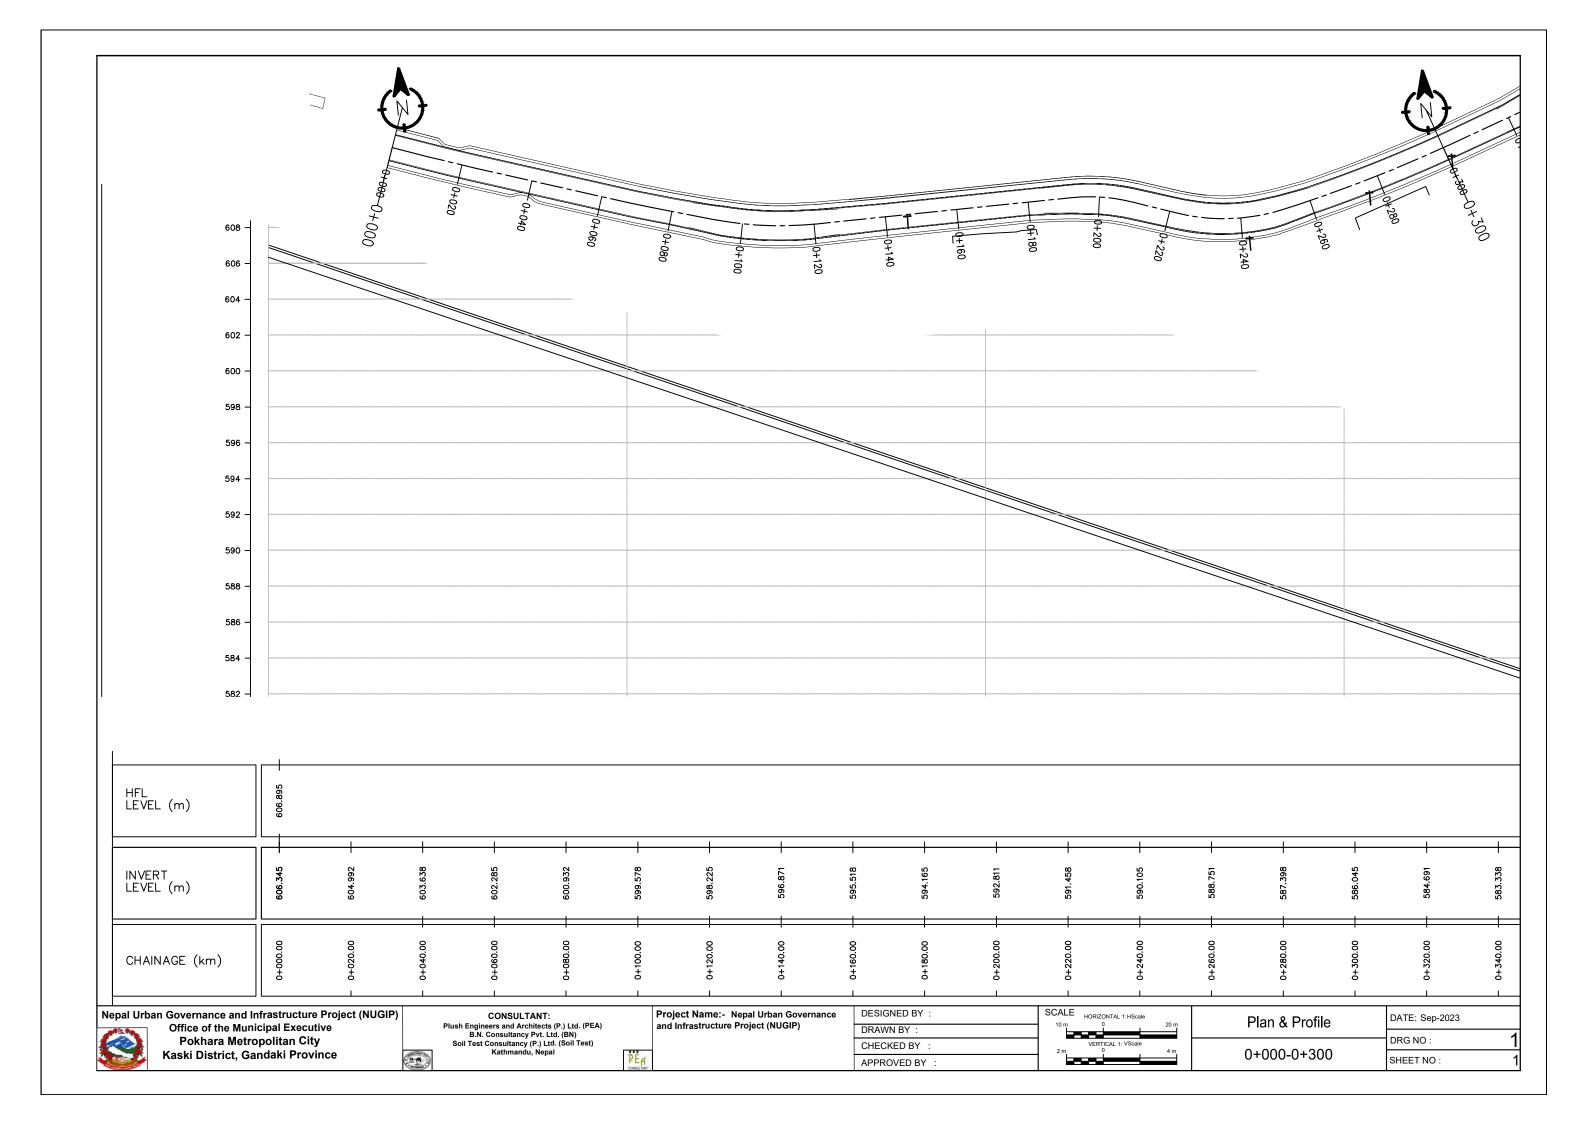


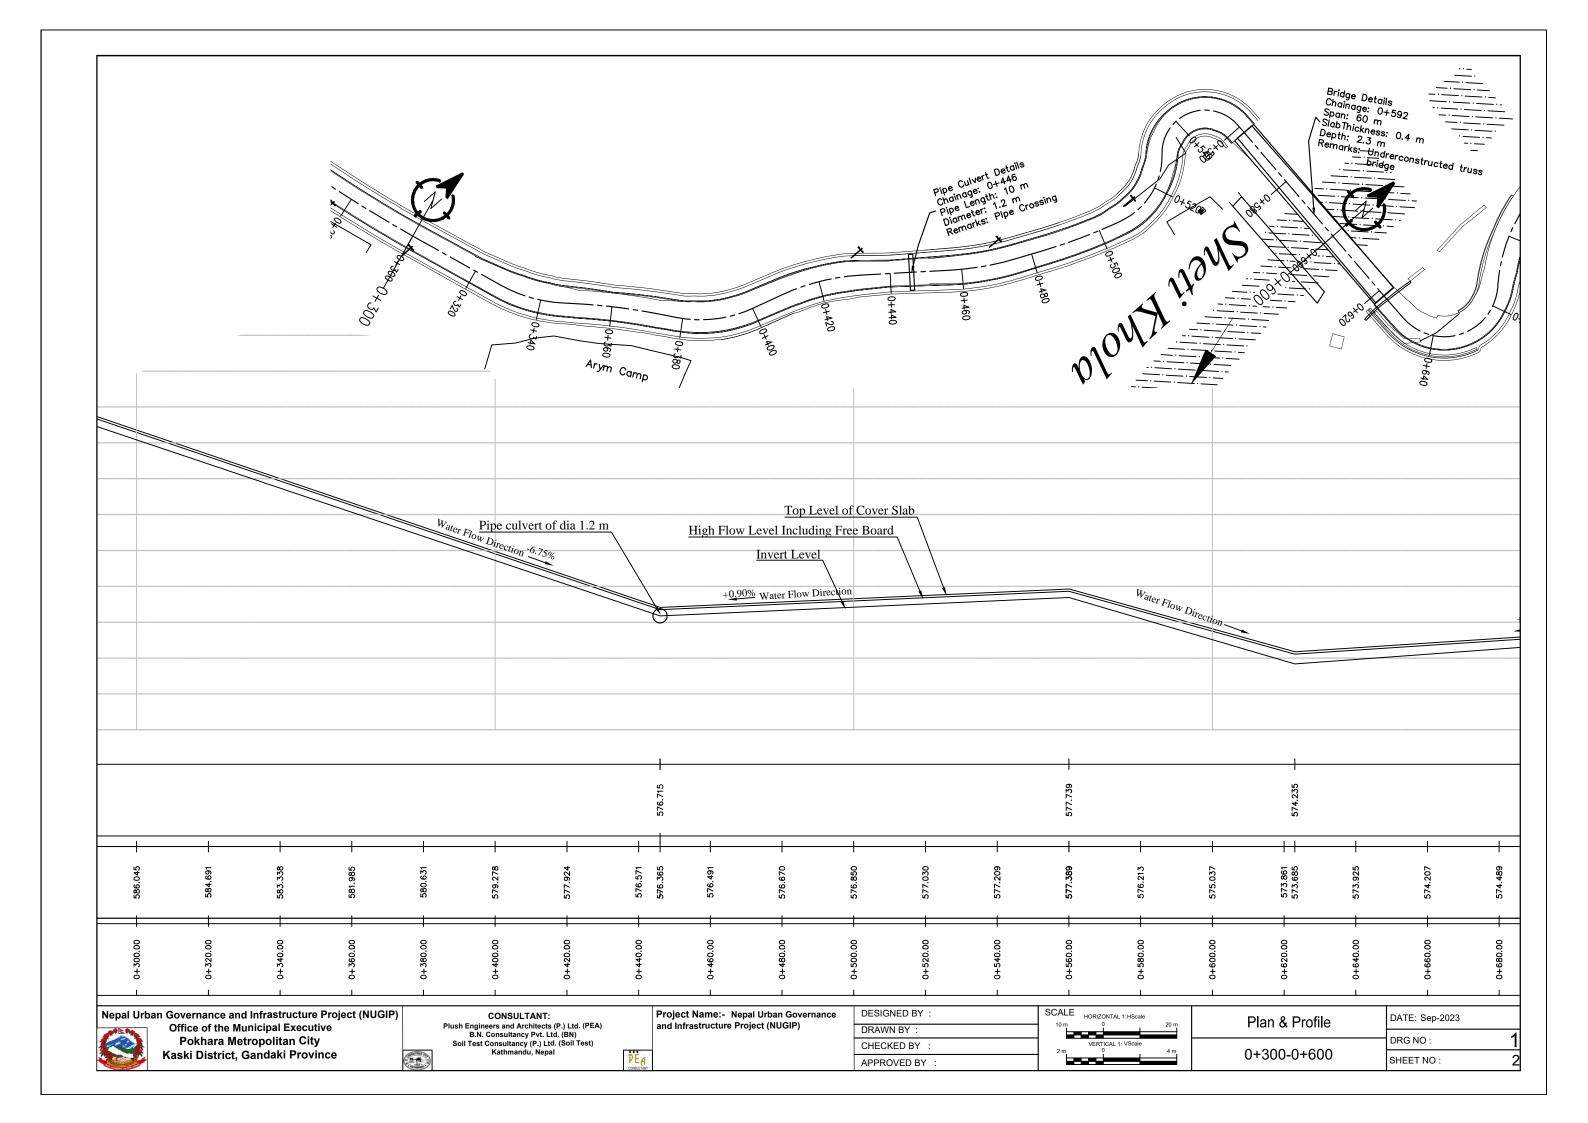


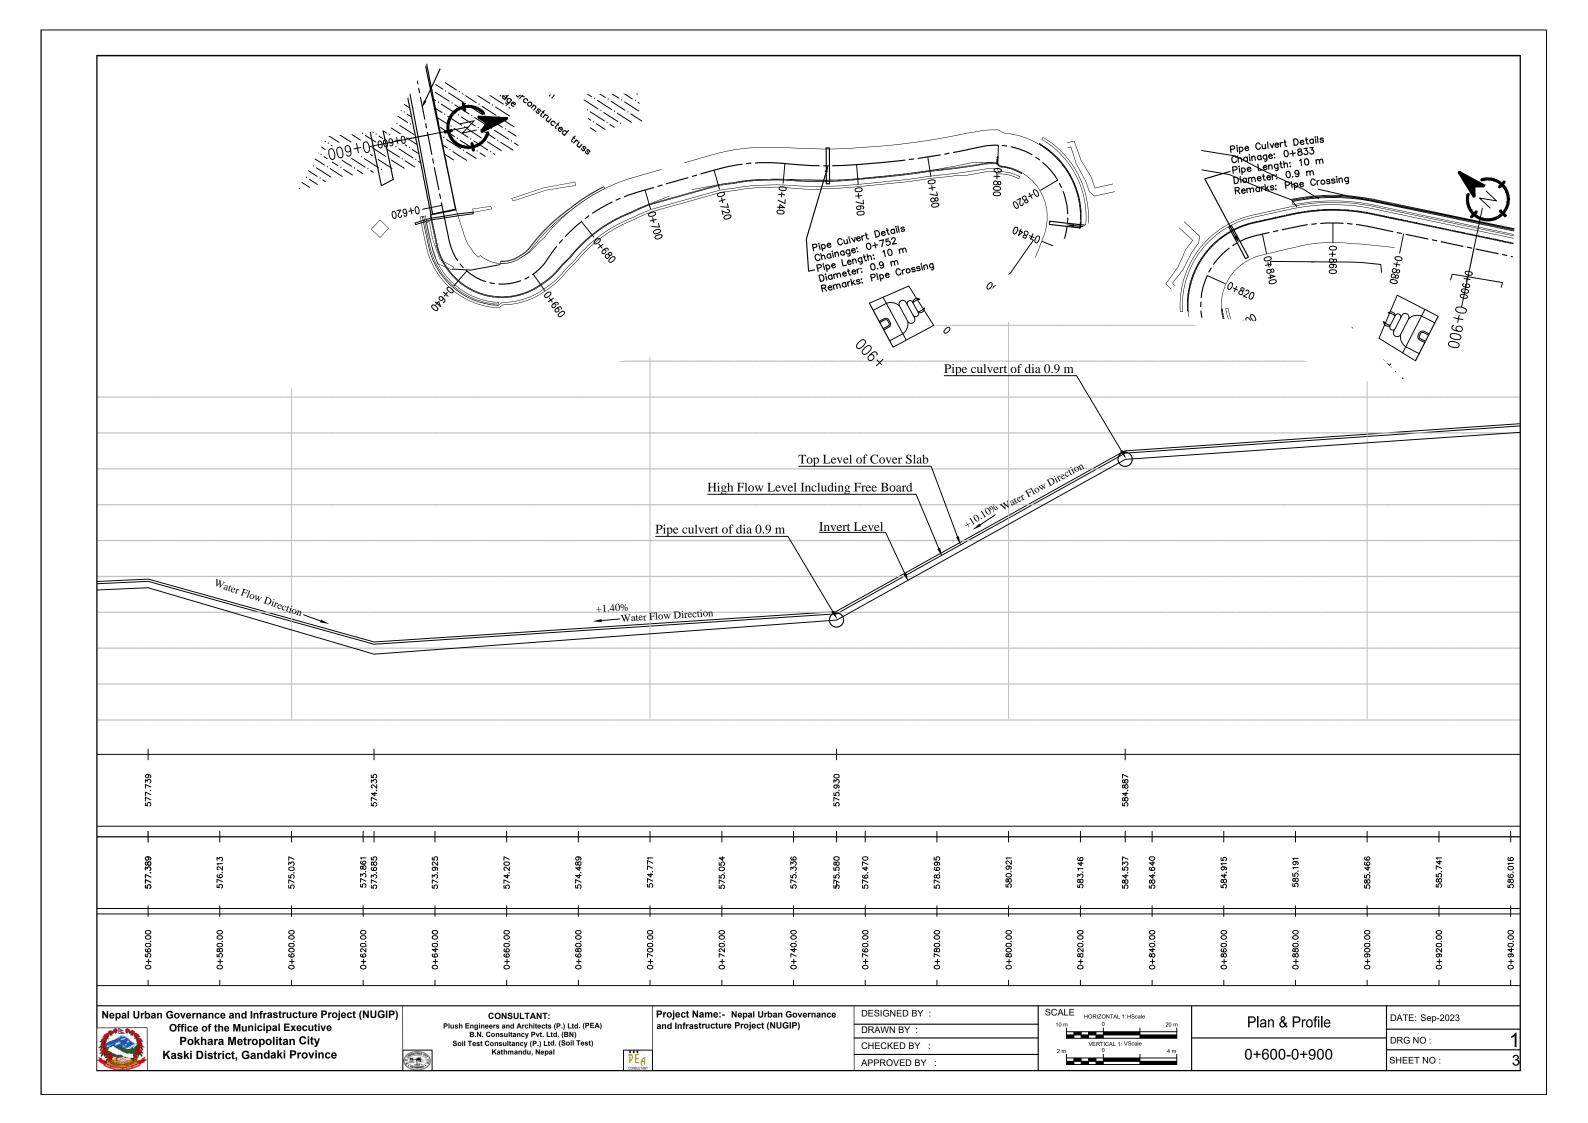


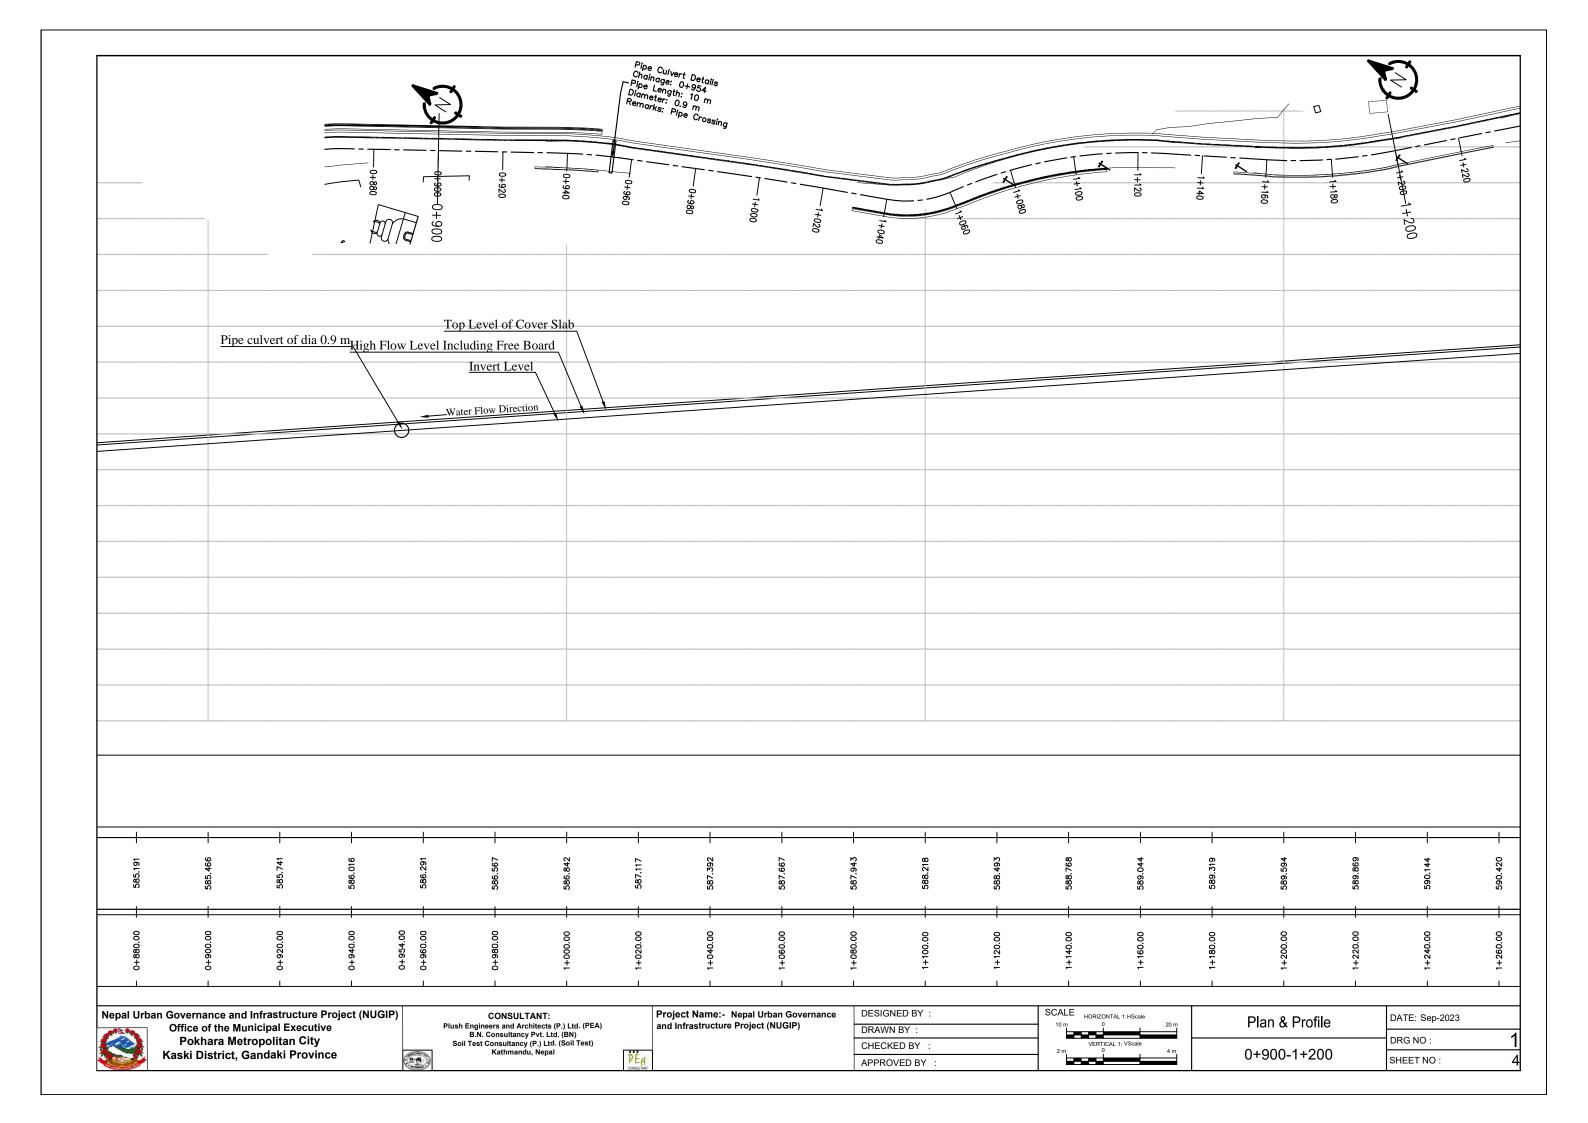

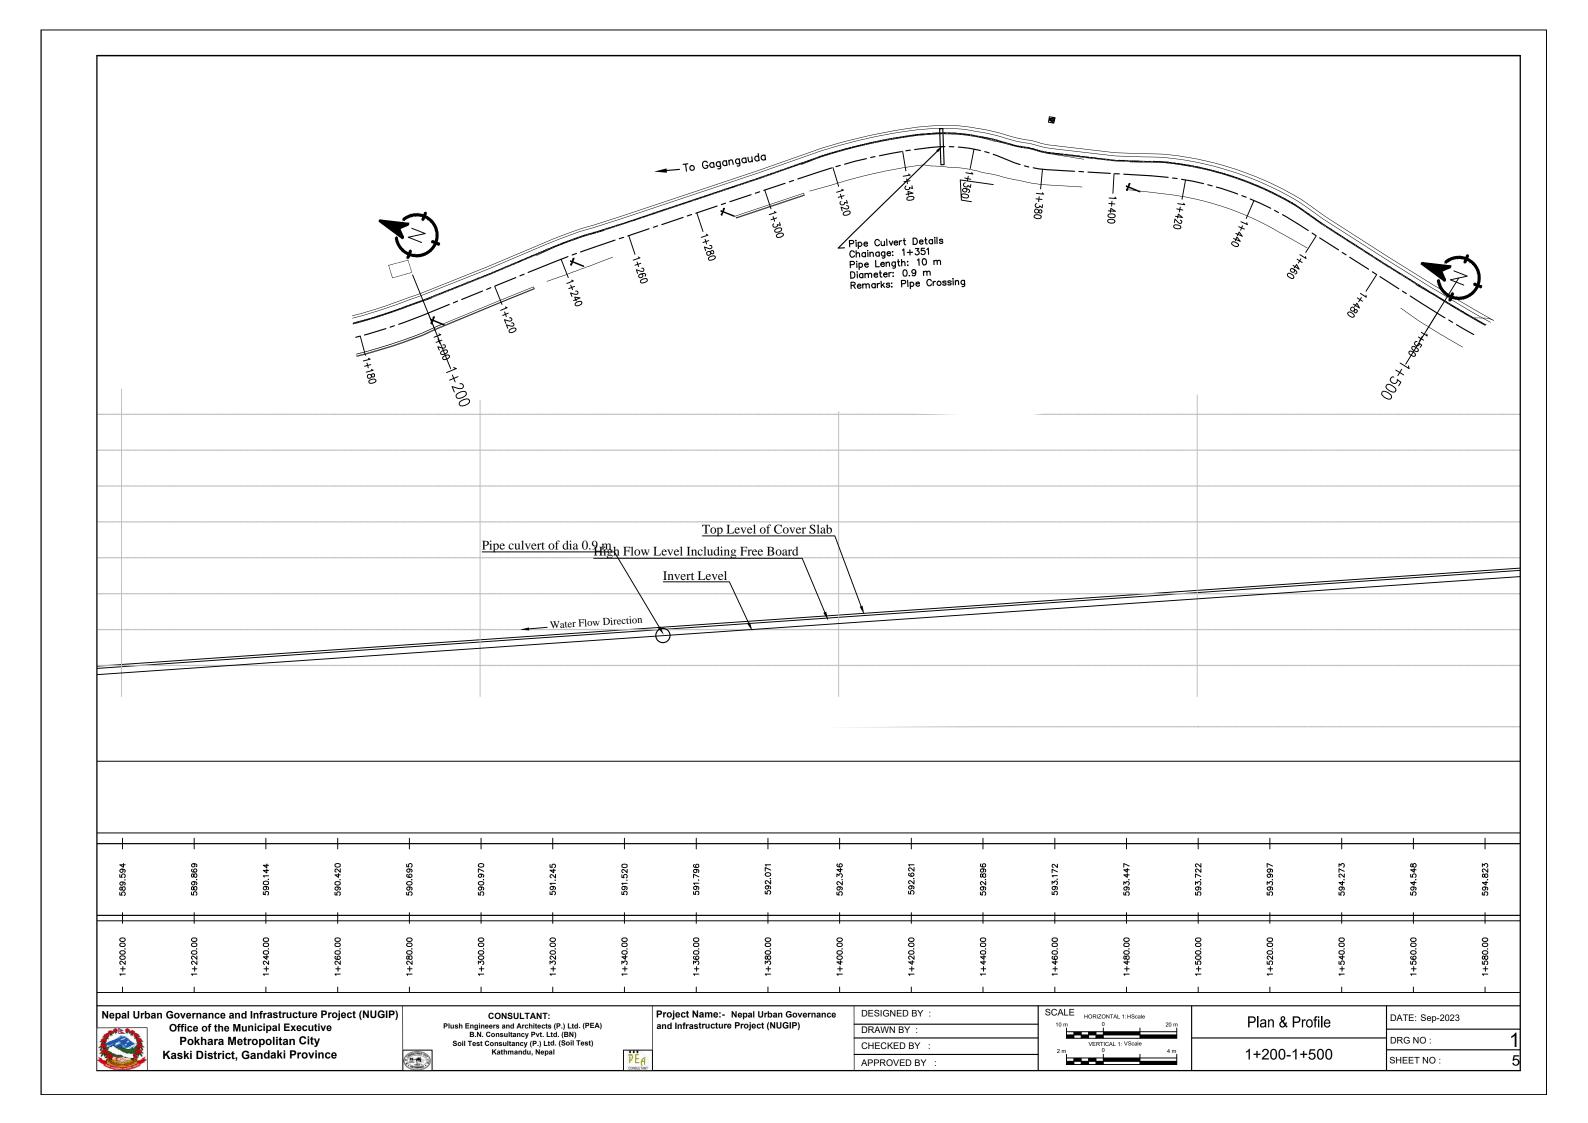

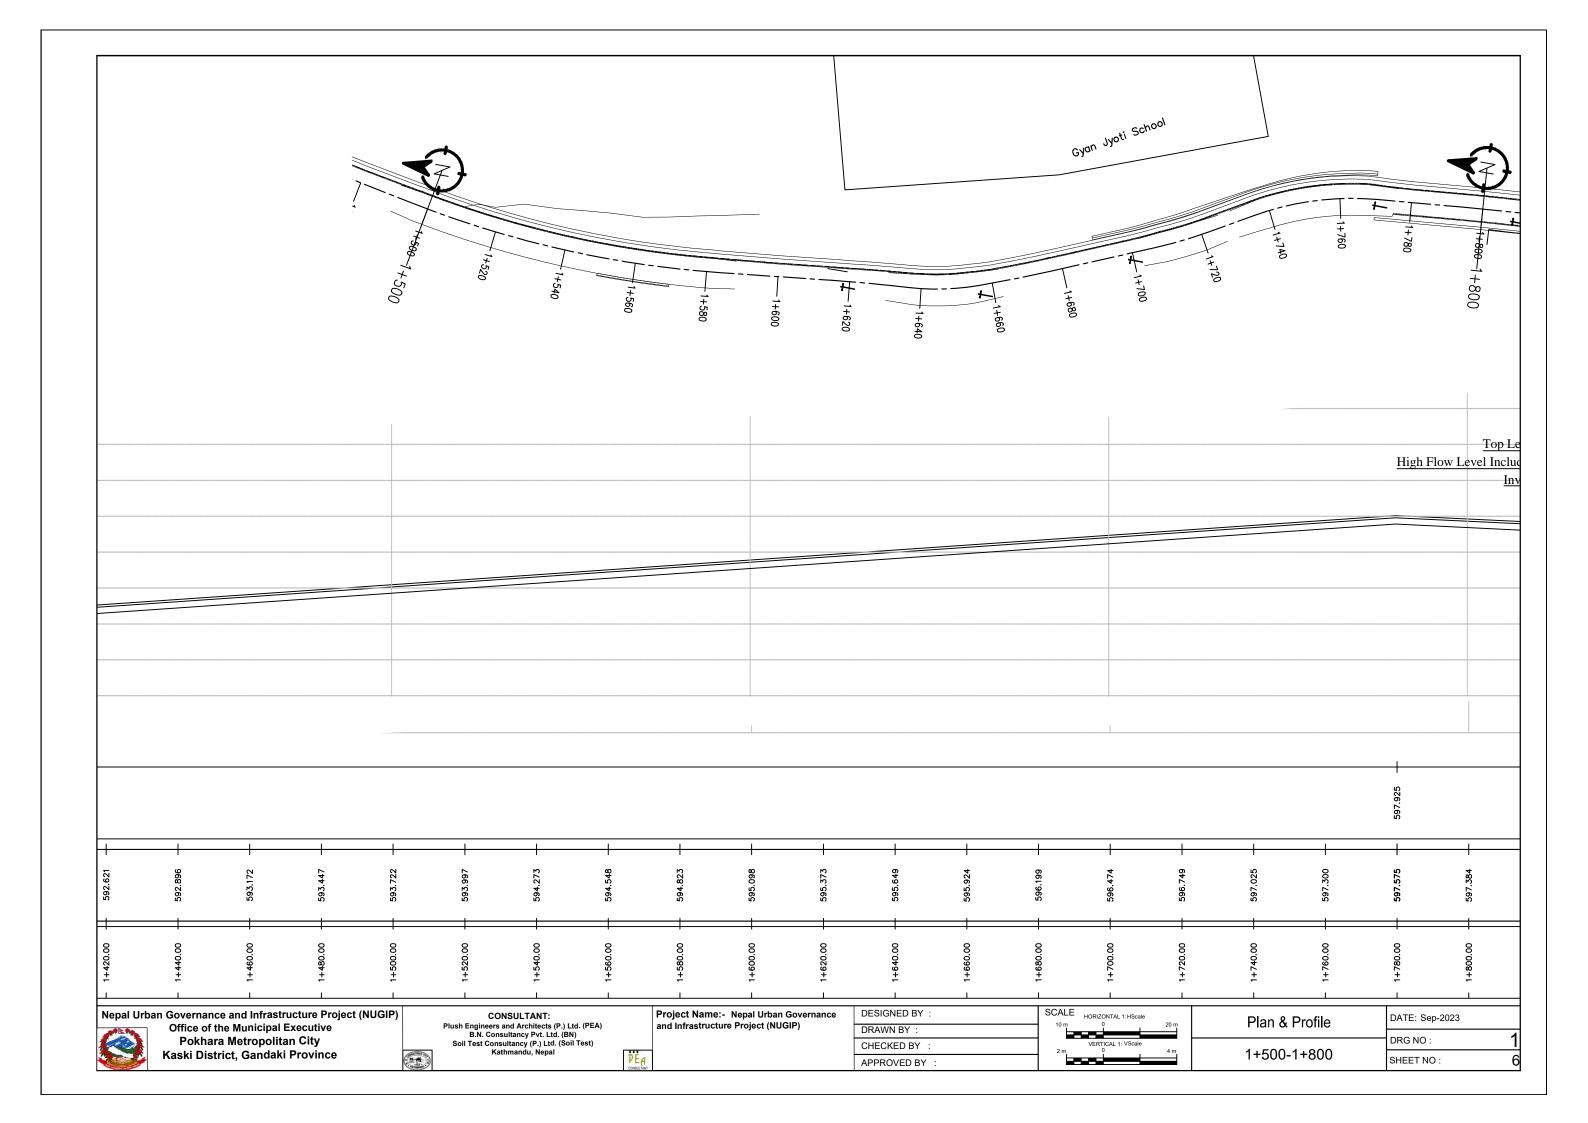

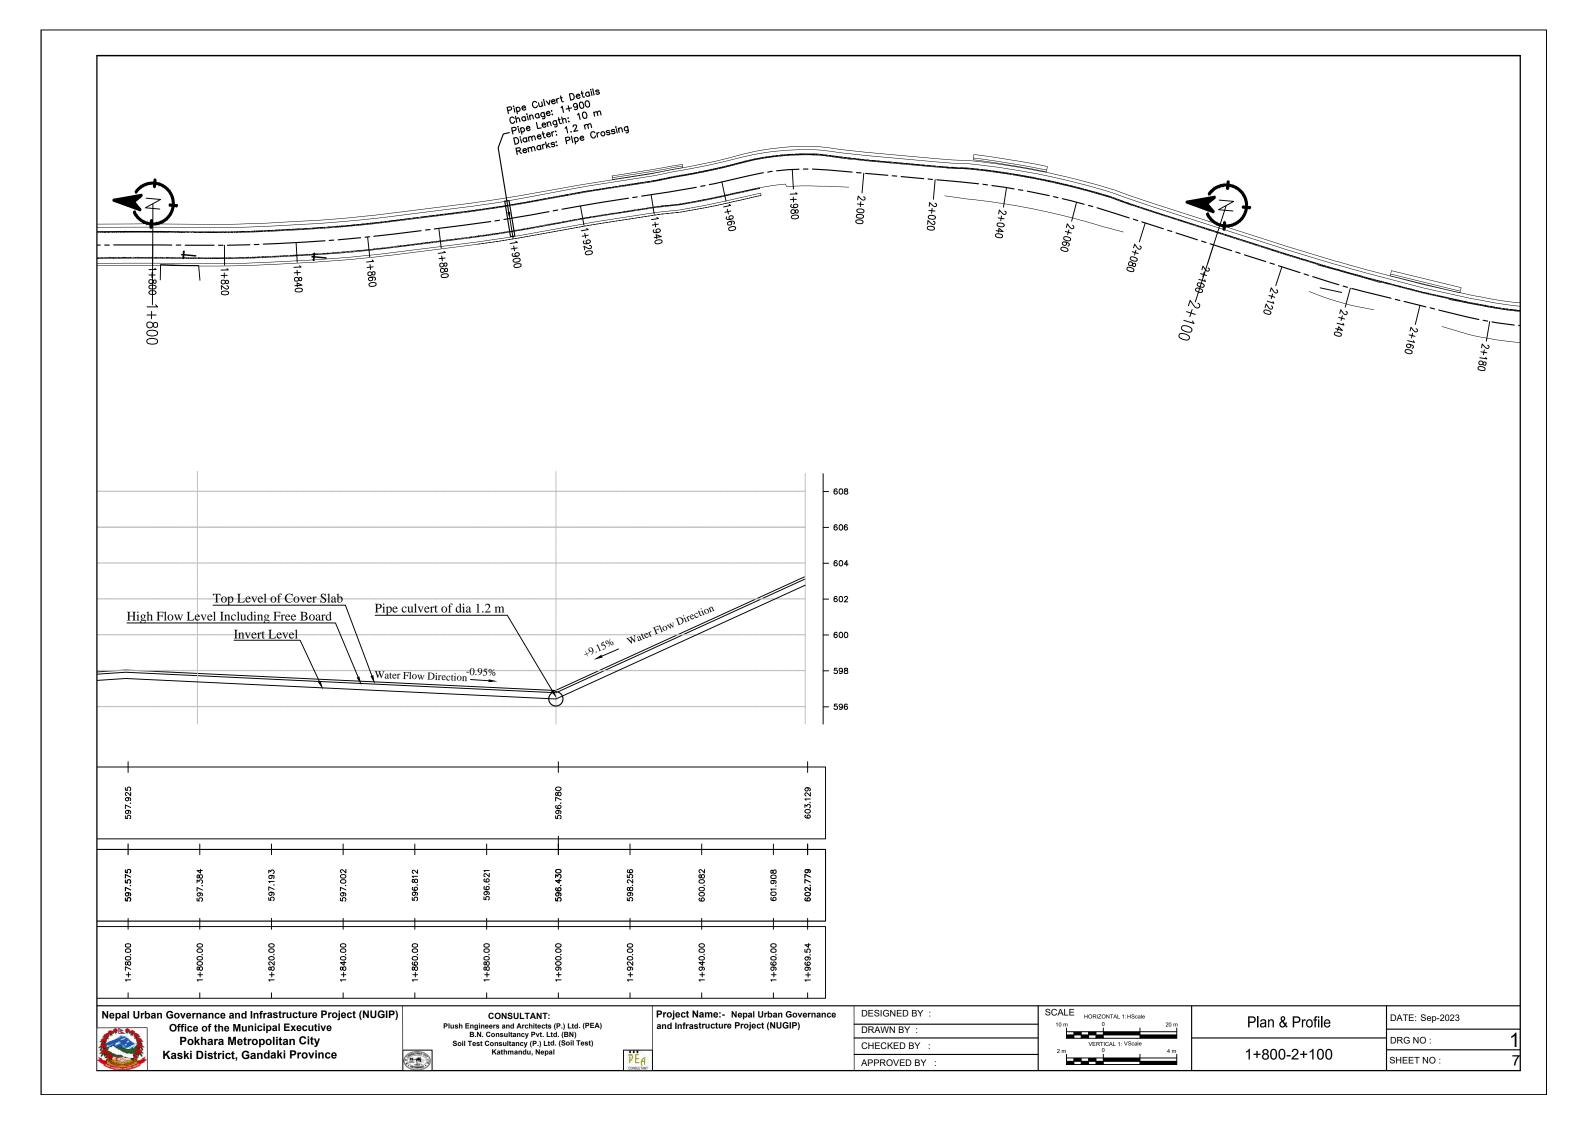


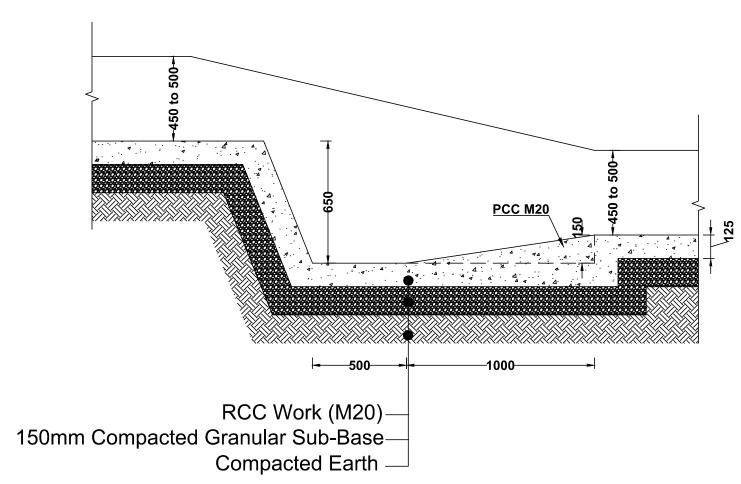



<b>Vertical</b>	Drop	For	Drain


			Vertical Drop Details							
S.N.	Cha	inage	Proposed Length	Proposed Height	Remarks					
S.IN.	From	То	Between each Drop (DL)	of Drop (DL)	Remarks					
	Section-I Right side drain									
1	0+000	0+500	83.33	0.50						
2	0+500	1+090	58.97	0.53						
3	4+111	3+793	17.65	0.53						
4	4+540	5+308	42.67	0.51						
5	5+549	5+308	15.06	0.58						
6	5+549	5+880	17.42	0.58						
7	5+880	6+270	11.47	0.60						
8	7+726	7+531	21.69	0.52						
9	7+969	7+721	20.67	0.52						
			Section-I Left side drain							
1	0+000	0+500	83.33	0.50						
2	0+500	1+090	58.97	0.53						
3	4+111	3+793	24.44	0.53						
4	6+280	6+481	28.71	0.51						
		Secti	on-II Left side drain							
1	0+000	0+446	34.30	0.60						
			Section-II Right side drain							
1	0+000	0+446	49.56	0.52						
2	1+970	1+900	23.18	0.49						


**Vertical Drop For Drain** 

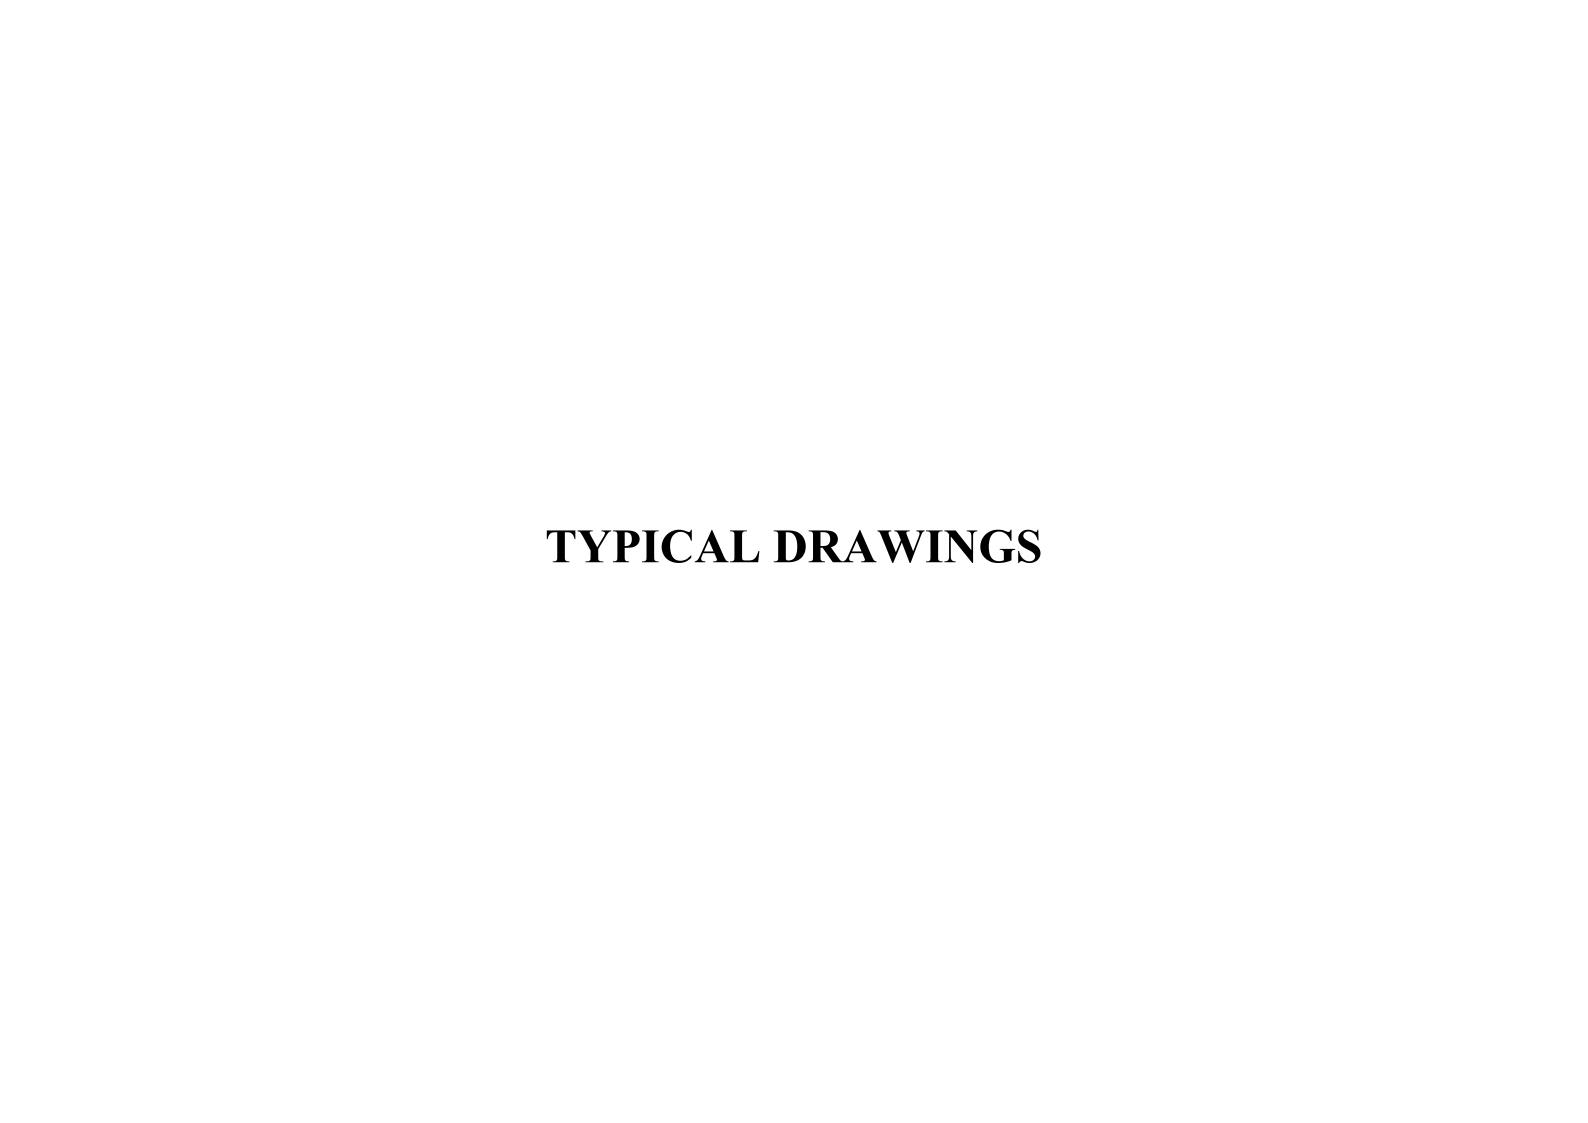


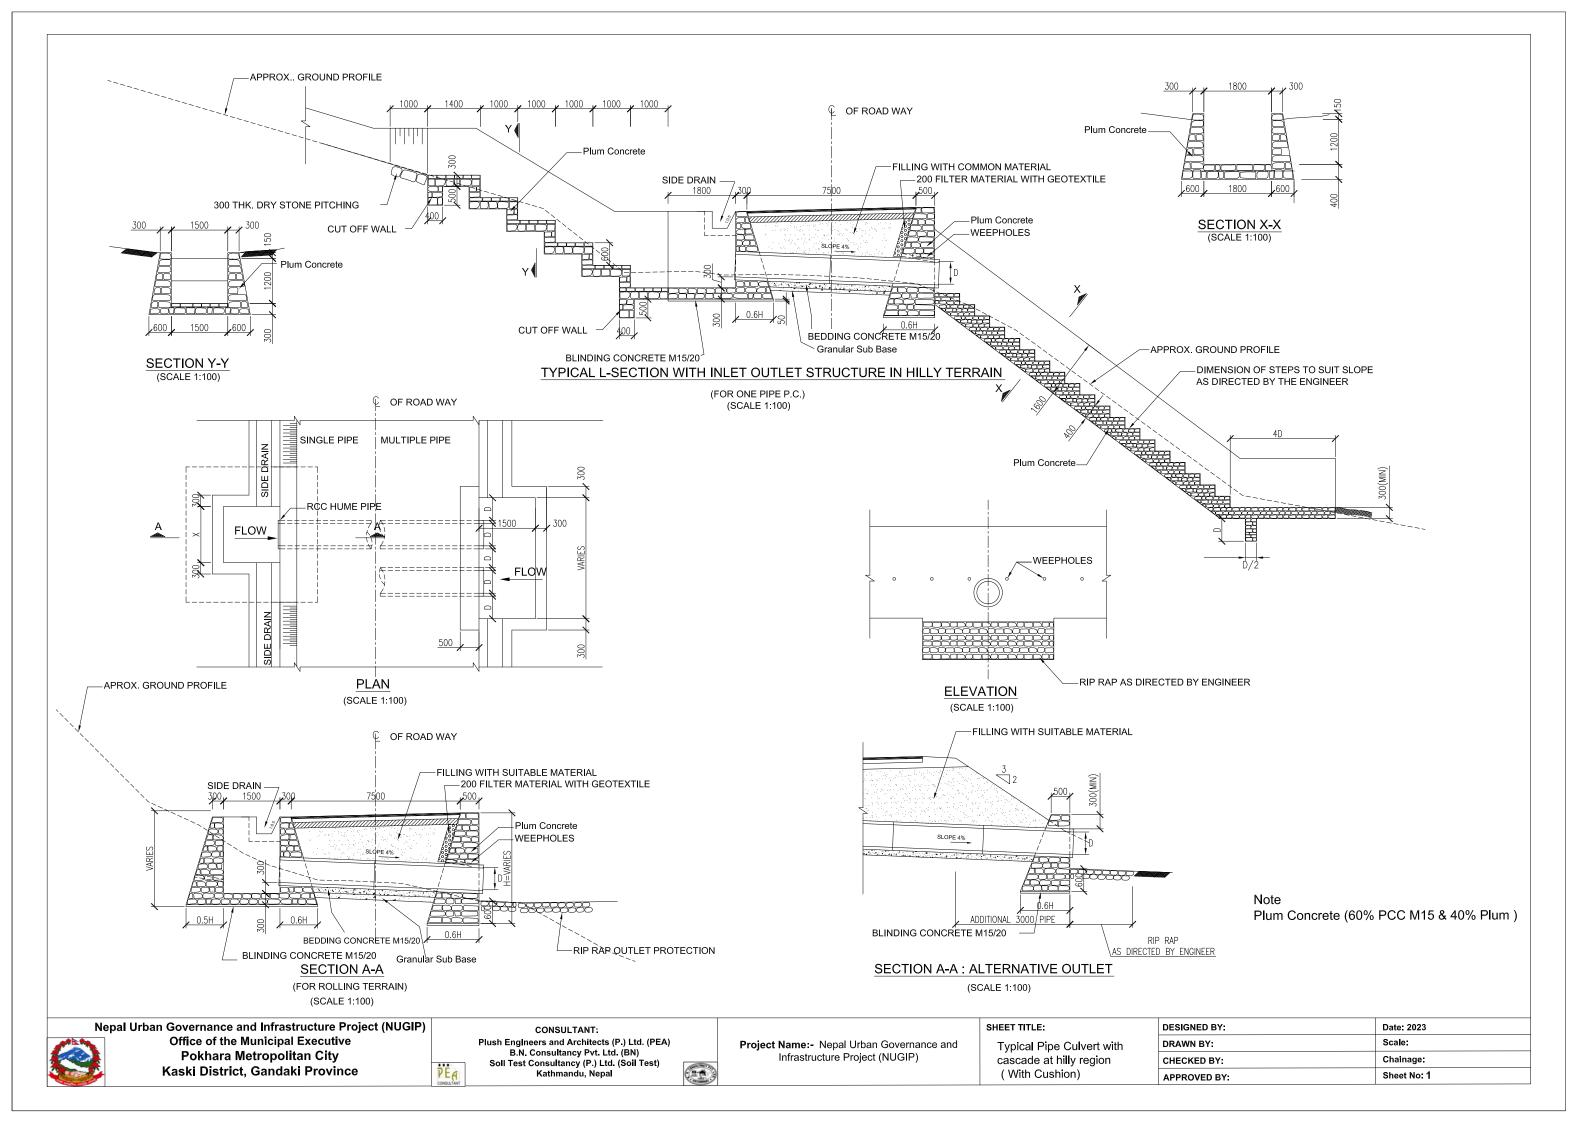

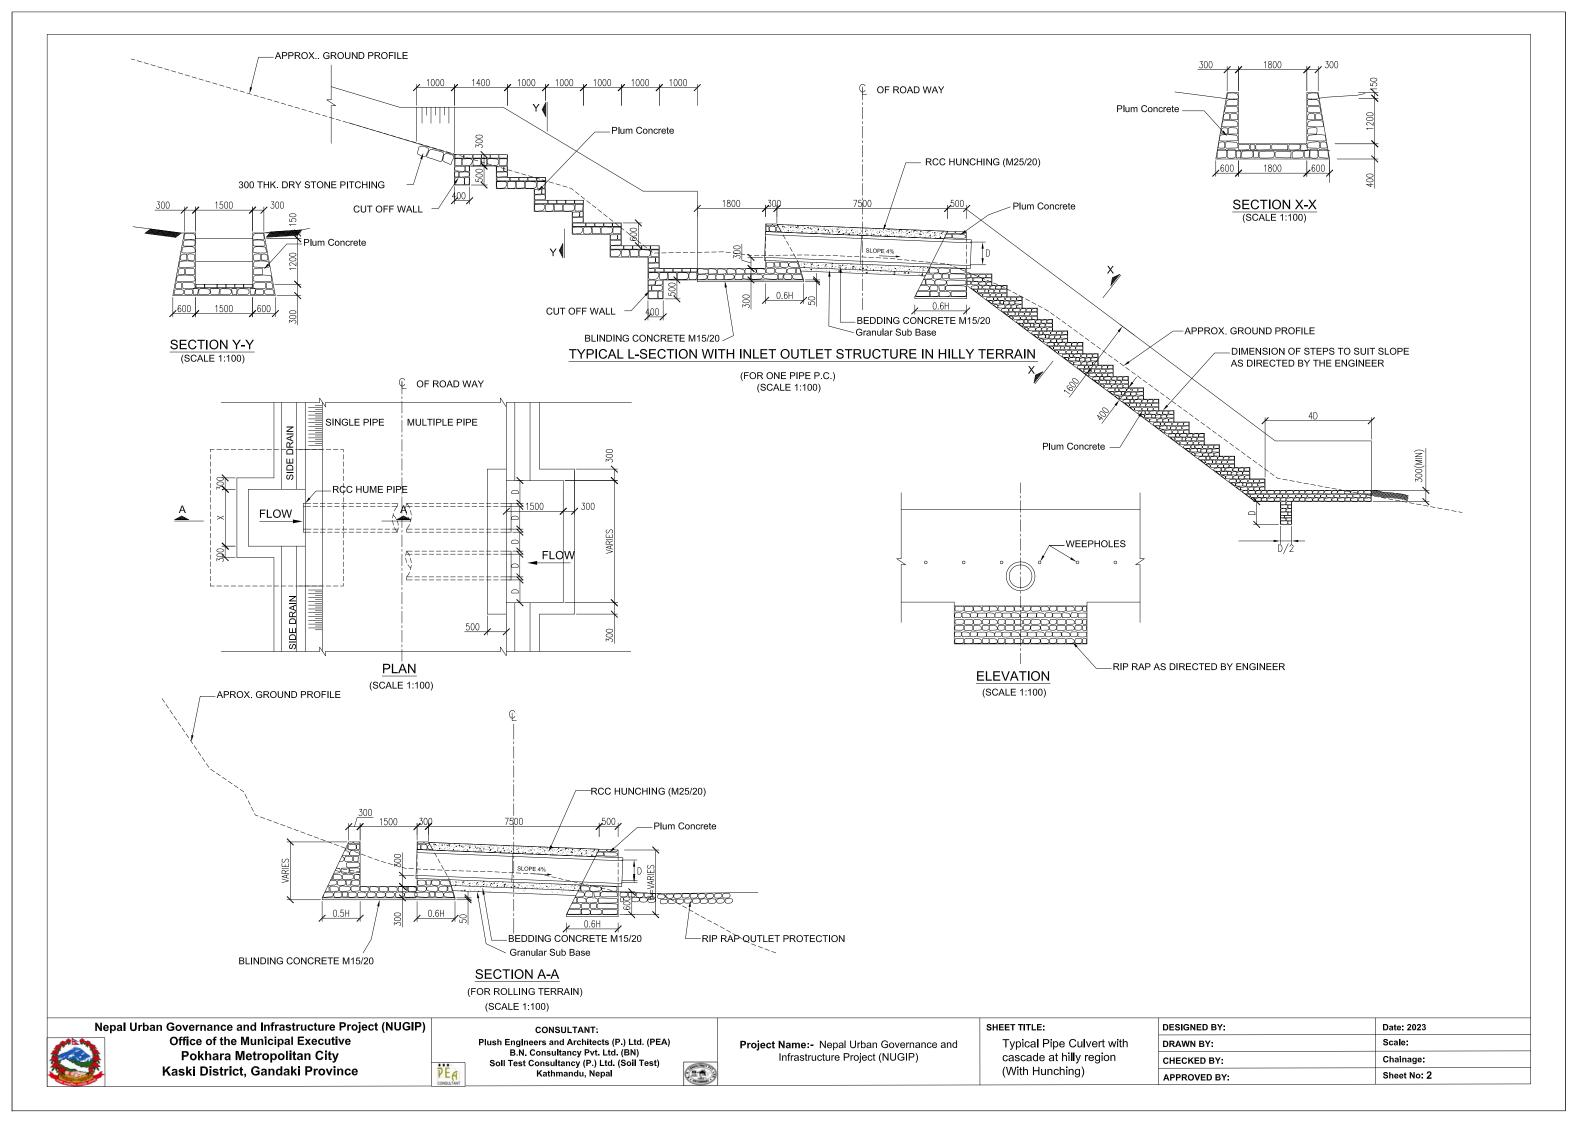

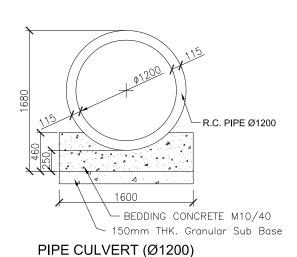

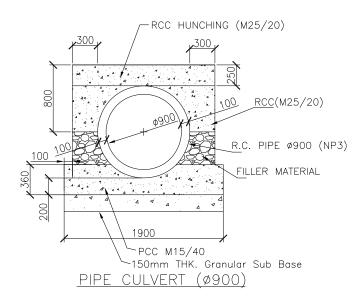

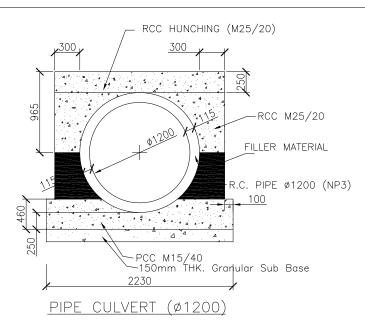

### For Section - I

Summary of Cross Drainage Structures (Hume Pipe Types)

	Sum	mary of	Cross Drain	age Structu	res (Hume	Pipe Typ	es)				
		pa	, 2	42	n g si	7		Head	l Wall	_ =	_ <del>_</del>
S.N.	Chainage	Propsed Bed level (m)	Proposed structure (Pipe Culvert) @	Structure Type	Cushion(60mm) /Hunching (20mm thick M25)/Cushio	Adopted FRL	Remark	Length (m)	Height (m)	Width of Foundation	Height of Cutoff Wall from Bed Level (m)
1	2+330	644.52	0.90	Hume Pipe Culvert	0.25	645.67	Single cell	3.30	1.85	1.11	1
2	5+873	599.08	1.20	Hume Pije Culver	1	601.28	Single cell/Cushion- 0.75m	4.20	3.1	1.86	0.99
3	6+481	554.53	1.20	Hume Hume Pipe Pipe Culvert Culvert	0.25	555.98	Single cell	4.20	2.25	1.35	1.04
4	6+750	542.64	1.20	Hume Pipe Culvert	0.25	544.09	Single cell	4.20	2.25	1.35	1.07
5	7+124	539.34	0.90	Hume Pipe Hume Pipe Culvert Culvert	0.25	540.49	Single cell	3.30	1.85	1.11	1
6	7+400	537.51	0.90	Hume Pipe Culvert	0.25	538.66	Single cell	3.30	1.85	1.11	1
7	7+722	557.04	1.20	Hume Pipe Culvert	0.25	558.49	Single cell	4.20	2.25	1.35	1.5
8	7+989	583.59	0.90	Hume Pipe Culvert	0.25	584.74	Single cell	3.30	1.85	1.11	1
9	8+320	599.36	1.20	Hume Pipe Culvert	0.25	600.81	Single cell	4.20	2.25	1.35	1.1
10	8+560	598	1.20	Hume Pipe Culvert	0.25	599.45	Single cell	4.20	2.25	1.35	1.37
11	8+828	594.73	0.90	Hume Pipe Culvert	0.25	595.88	Single cell	3.30	1.85	1.11	1

For Section - II

**Summary of Cross Drainage Structures (Pipe Culverts)** 

	9.	<b>5</b> 5	(a)	<u>~</u>	ıg ick ish	<b>T</b>	<u></u>	Head	Wall	on on	of /all od 1)
S.N.	Chainage	Propsed Bed level (m)	Proposed structure (Pipe Culvert) @	Remark	Hunching (20mm thick M25)+Cush ion	Adopted FRL	Remark	Length (m)	Height (m)	Width of Foundation	Height of Cutoff Wall from Bed Level (m)
1	0+446	575.33	1.20	Hume Pipe Culvert	0.25	576.78	Single cell	4.20	2.25	1.35	1.39
2	0+752	575.04	0.90	Hume Pipe Culvert	0.25	576.19	Single cell	3.30	1.85	1.11	1
3	0+832.5	583.93	0.90	Hume Pipe Culvert	0.25	585.08	Single cell	3.30	1.85	1.11	1
4	0+954	588.32	0.90	Hume Pipe Culvert	0.25	589.47	Single cell	3.30	1.85	1.11	1
5	1+351	603.14	0.90	Hume Pipe Culvert	0.25	604.29	Single cell	3.30	1.85	1.11	1
6	1+900	595.52	1.20	Hume Pipe Culvert	0.25	596.97	Single cell	4.20	2.25	1.35	1
7	2+629	596.06	0.90	Hume Pipe Culvert	0.25	597.21	Single cell	3.30	1.85	1.11	1

Nepal Urban Governance and Infrastructure Project (NUGIP) Office of the Municipal Executive Pokhara Metropolitan City


CONSULTANT: Plush Englneers and Architects (P.) Ltd. (PEA) B.N. Consultancy Pvt. Ltd. (BN)
Soll Test Consultancy (P.) Ltd. (Soil Test)
Kathmandu, Nepal PEA




Project Name: - Nepal Urban Governance and Infrastructure Project (NUGIP)

SHEET TITLE: Typical Pipe Culvert

DESIGNED BY:	Date: 2023
DRAWN BY:	Scale:
CHECKED BY:	Chainage:
APPROVED BY:	Sheet No: 3

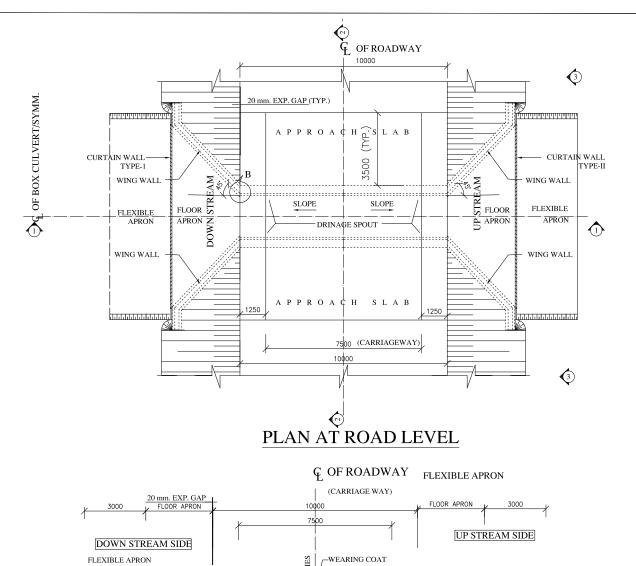

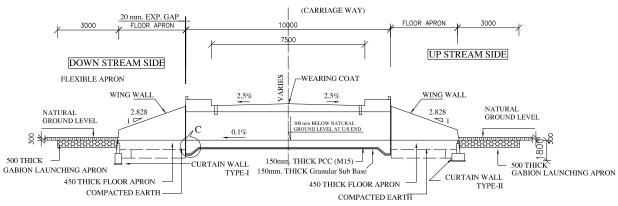


SECTION 1-1

TABLE SHOWING	CALIENT	DIMENSIONS	OF CINICIE	CELL DOV	CIH VEDT
TABLE SHOWING	SALIENT	DIMENSIONS	OF SINGLE	CELL DUA	CULVERI

Box Cell Designation	a (mm)	b (mm)	c (mm)	d (mm)	e (mm)	f (mm)	g (mm)
3 m x 2.15 m	3000	2150	900	430	420	420	NA
2 m x 2.15 m	2000	2150	500	350	380	300	NA
2.5 m x 2.15 m	2500	2150	900	430	420	420	NA

		Sum	mary of C	ross Drai	nage Stru	ctures (Be	ox Culvert)		
S.N.	Chainage	Propsed Bed level (m)  Propsed Bed level (m)  Proposed Structure (Box Structure (Box Calvert) (m)		Cover Slab (mm)	Adopted FRL	Remarks	Adopted Scour Level (m)	Height of Curtain Wall from Bed Level (m) HS	
		Pro	Height(m	Width				PΑ	Heigh From
1	3+111.5	654.50	2.15	3	350	657	SingleCell(1x3)	654.00	1
2	3+793.5	650.81	2.15	2	350	653.31	Single Cell(1x2)	650.31	1
3	5+308	600.79	2.15	3	350	603.29	Single Cell(1x3)	600.30	1
4	7+531	537.80	2.15	2.5	350	540.3	Single Cell(1x2.5)	537.28	1.02
5	8+951	592.26	2.15	3	350	594.76	Single Cell(1x3)	590.76	2

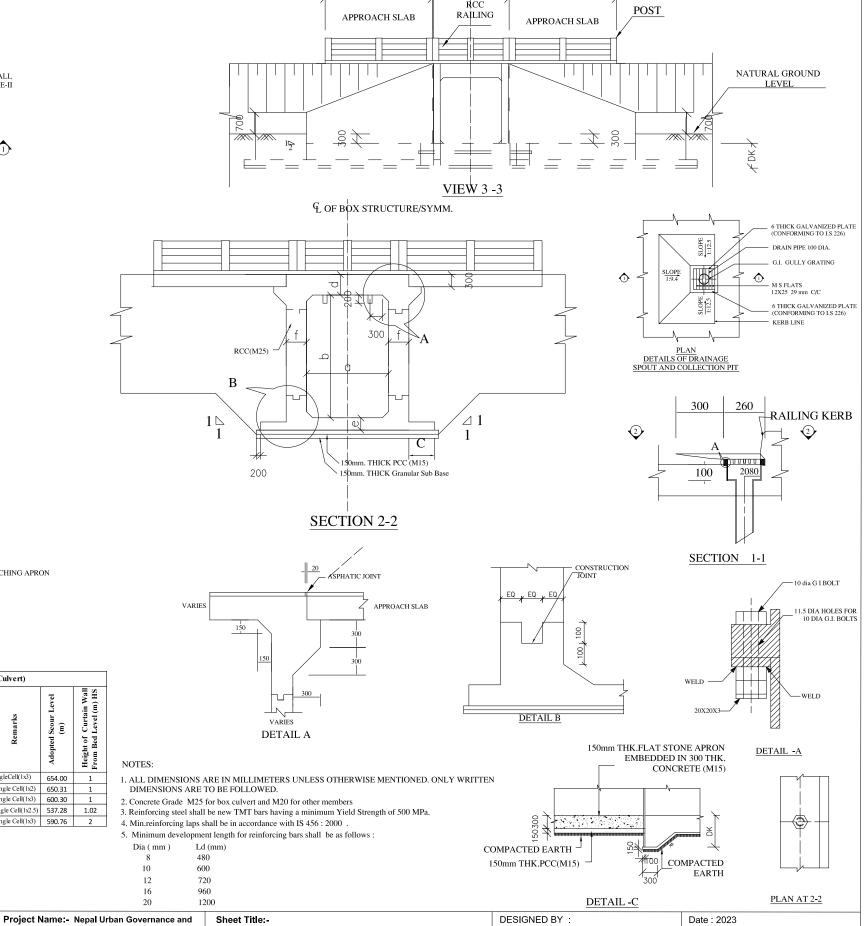

G. OF BOX STRUCTURE/SYMM

20mm EXPANSION JOINT



CONSULTANT:
Plush Engineers and Architects (P.) Ltd. (PEA)
B.N. Consultancy Pvt. Ltd. (BN)
Soil Test Consultancy (P.) Ltd. (Soil Test)
Kathmandu, Nepal

Infrastructure Project (NUGIP)

Box Culvert Single Cell


 DESIGNED BY :
 Date : 2023


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 CHECKED BY :
 Chainage :


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 Sheet No. :1







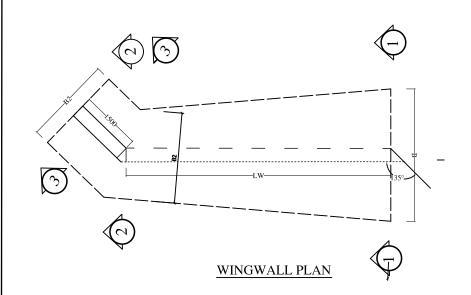

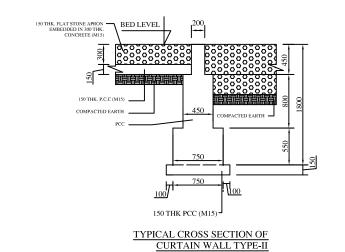(UP STREAM SIDE)

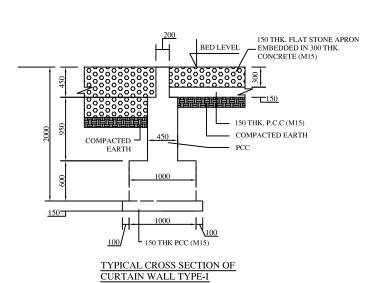

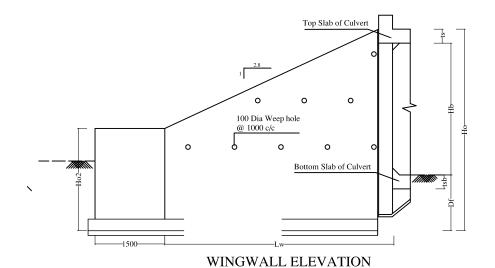

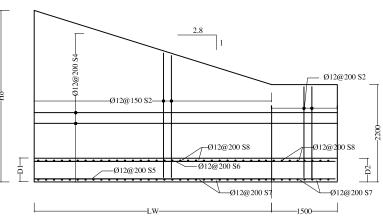



REINFORCEMENT DETAILS OF WINGWALL (BACK FACE)

(FRONT FACE)

S3

<u>/ s7</u>

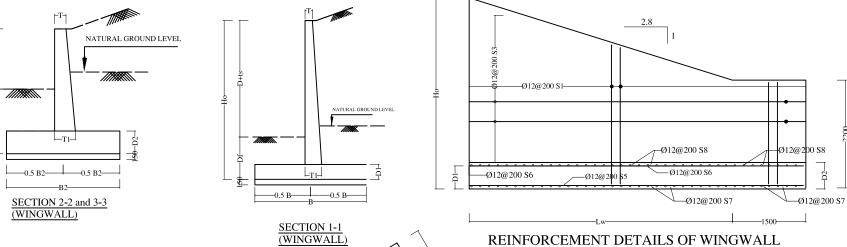

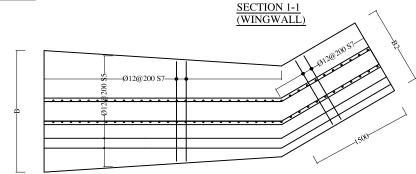

REINFORCEMENT DETAILS OF WINGWALL PlAN (BOTTOM)

G 11	Height of		Max. ht.	Length of		Section 1 -1 Section 2 -2 and 3							
S.No.		Foundation,		wing wall,	T	T1	В	D1	T	T1	B2	D2	
	Hb (mm)	Df (mm)	(mm)	Lw (mm)	(mm)	(mm)	(mm)	(mm)	(mm)	(mm)	(mm)	(mm)	
1	2150	1500	4080	1880	200	420	1000	400	200	400	1000	400	

ARRANGEMENT OF REINFORCEMENTS ( WING WALL)

1. ALL DIMENSIONS ARE IN MILLIMETERS UNLESS OTHERWISE MENTIONED. NOTES: ONLY WRITTEN DIMENSIONS ARE TO BE FOLLOWED.

2. FOR GENERAL NOTES AND REFERENCE DRAWINGS REFER DRG NO.

3. FOR REINFORCEMENT DETAIL REFER DRG. NO.

4. FOR DETAILS OF WING WALL REFER \DRG. NO.



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(DOWN STREAM SIDE)




Project Name: - Nepal Urban Governance and Infrastructure Project (NUGIP)


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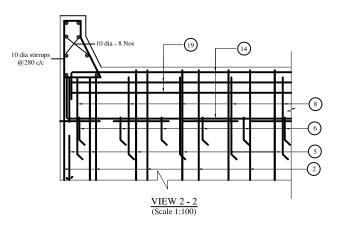
**Box Culvert Single Cell** Section - I


DESIGNED BY:	Date : 2023
DRAWN BY:	Scale : Not in Scale
CHECKED BY :	Chainage :
APPROVED BY :	Sheet No. : 2





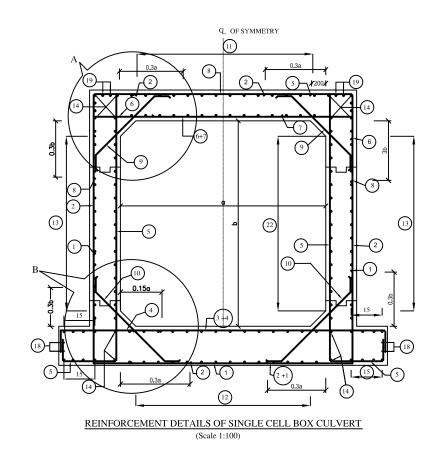

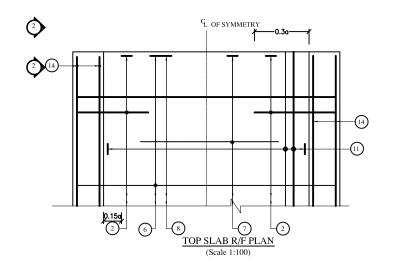


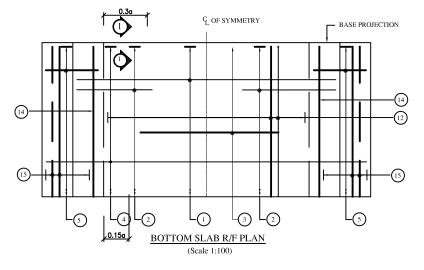





: TOP FACE BARS / OUTER FACE BARS

--- : BOTTOM FACE BARS / INNER FACE BARS

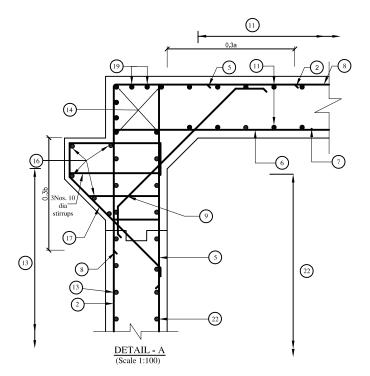

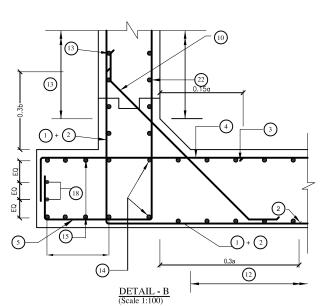

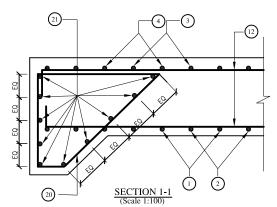

Nepal Urban Governance and Infrastructure Project (NUGIP) Office of the Municipal Executive Pokhara Metropolitan City Kaski District, Gandaki Province

CONSULTANT:
Plush Engineers and Architects (P.) Ltd. (PEA)
B.N. Consultancy Pvt. Ltd. (BN)
Soll Test Consultancy (P.) Ltd. (Soil Test)
Kathmandu, Nepal


Project Name:- Nepal Urban Governance and Infrastructure Project (NUGIP)

Sheet Title:-

Box Culvert Single Cell (ReInforcement Details) Section - I

DESIGNED BY:	Date : 2023
DRAWN BY:	Scale :
CHECKED BY :	Chainage:
APPROVED BY :	Sheet No. :3

	BOX-CELL DESIGNATION Nc/ab/Ec	Single Cell Box Culvert 2m x2.15m without earth cushion  Single Cell Box Culvert 3m x2.15m without earth cushion												Sing	gle Cell B	Box Culve	ert 2.5m x2.1	5m without	earth cushion									
BAR MARK		BAR DIA. in mm.	SPACING in mm.	M1 in mm.	M2 in mm.	LENGTH in mm.	NO. OF BARS	TOTAL LENGTH in mm.	Wt/m, kg	Weight, kg	BAR DIA.	SPACING in mm.	M1 in mm.	M2 in mm.	LENGTH in mm.	NO. OF BARS	TOTAL LENGTH in mm.	Wt/m, kg	Weight, kg	BAR DIA. in mm.	SPACING in mm.	M1 In mm.	M2 in mm.	LENGTH in mm.	NO. OF BARS	TOTAL LENGTH in mm.	Wt/m, kg	Weight, kg
1	M1 M2 M1	10	250	930	2500	4360	40	174400	0.62	108.1	10	200	1270	3740	6280	50	314000	0.62	194.7	10	200	1270	3240	5780	50	314000	0.62	194.7
2	M1 M2 M1	16	250	850	2630	4330	82	355060	1.58	561.0	16	200	1270	3000	5540	102	640560	1.58	1012.1	16	200	1270	3000	5540	102	640560	1.58	1012.1
3	M1					Bar not r	needed				12	200	2100	0	2100	50	105000	0.89	93.5	12	200	2100	0	2100	50	105000	0.89	93.5
4	M2 M1 M1	16	250	280	3500	4060	40	162400	1.58	256.6	16	200	320	5540	6180	50	309000	1.58	488.2	16	200	320	5040	5680	50	309000	1.58	488.2
5	0.2m. 0.2m. <u>M2</u>	16	250	2630	700	3730	80	298400	1.58	471.5	12	150	3000	1220	4620	100	536000	0.89	477.0	12	150	3000	1220	4620	100	536000	0.89	477.0
6	M2 M1 M1	16	250	250	2500	3000	40	120000	1.58	189.6	16	200	260	3740	4260	50	213000	1.58	336.5	16	200	260	3240	3760	50	213000	1.58	336.5
7	M1					Bar not r	needed								Bar not n	eeded								Bar not r	needed			
8	M2 M1 M1	10	250	900	2500	4300	40	172000	0.62	106.6	10	200	1270	3740	6280	50	314000	0.62	194.7	10	200	1270	3240	5780	50	314000	0.62	194.7
9	M1 M2	10	250	200	900	1300	80	104000	0.62	64.5	10	200	200	1160	1560	100	156000	0.62	96.7	10	200	200	1160	1560	100	156000	0.62	96.7
10	M1 M2 M1	12	250	200	940	1340	80	107200	0.89	95.4	10	200	200	1160	1560	100	156000	0.62	96.7	10	200	200	1160	1560	100	156000	0.62	96.7
11	M2 M1 M1	10	250	200	9900	10300	16	164800	0.62	102.2	10	200	200	9900	10300	28	288400	0.62	178.8	10	200	200	9900	10300	28	288400	0.62	178.8
12	M2 M1 M1	10	250	200	9900	10300	16	164800	0.62	102.2	12	200	200	9900	10300	28	288400	0.89	256.7	12	200	200	9900	10300	28	288400	0.89	256.7
13	M1 M2 M1	10	250	200	9900	10300	16	164800	0.62	102.2	10	200	200	9900	10300	28	288400	0.62	178.8	10	200	200	9900	10300	28	288400	0.62	178.8
14	M1 M2 M1	10	-	160	9900	10220	12	122640	0.62	76.0	10	-	160	9900	10220	12	122640	0.62	76.0	10	-	160	9900	10220	12	122640	0.62	76.0
15	M1 M2 M1	10	250	200	9900	10300	12	123600	0.62	76.6	10	200	200	9900	10300	24	247200	0.62	153.3	10	200	200	9900	10300	24	247200	0.62	153.3
16	M1	12	-	0	9900	9900	10	99000	0.89	88.1	12	-	0	9900	9900	10	99000	0.89	88.1	12	-	0	9900	9900	10	99000	0.89	88.1
17	M2 M2	12	250	1000	1250	2250	80	180000	0.89	160.2	12	200	1000	1260	2260	100	226000	0.89	201.1	12	200	1000	1260	2260	100	226000	0.89	201.1
18	M1 M2 M1	10	-	160	9900	10220	4	40880	0.62	25.3	10	-	160	9900	10220	4	40880	0.62	25.3	10	-	160	9900	10220	4	40880	0.62	25.3
19	M1 <u>M2</u> M1	10	-	1600	9900	13100	8	104800	0.62	65.0	10	-	160	9900	10220	8	81760	0.62	50.7	10	-	160	9900	10220	8	81760	0.62	50.7
20	M1 M1+0.20 m 0.20 m	10	150	1100	1550	4150	36	149400	0.62	92.6	10	200	1100	1550	4150	56	232400	0.62	144.1	10	200	1100	1550	4150	56	232400	0.62	144.1
21	M1 M2 M1	10	-	160	3500	3820	20	76400	0.62	47.4	10	-	160	5540	5860	20	117200	0.62	72.7	10	-	160	5540	5860	20	117200	0.62	72.7
22	M2 M1 M1	10	250	160	9900	10220	14	143080	0.62	88.7	10	200	210	9900	10320	28	288960	0.62	179.2	10	200	210	9900	10320	28	288960	0.62	179.2
	'								Total	2879.8							<u>'</u>		4594.9									4594.9

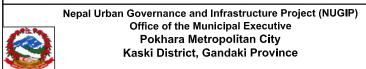






Project Name:- Nepal Urban Governance and Infrastructure Project (NUGIP)

Sheet Title:-


DESIGNED BY:	Date : 2023
DRAWN BY:	Scale :
CHECKED BY :	Chainage :
APPROVED BY :	Sheet No. :4

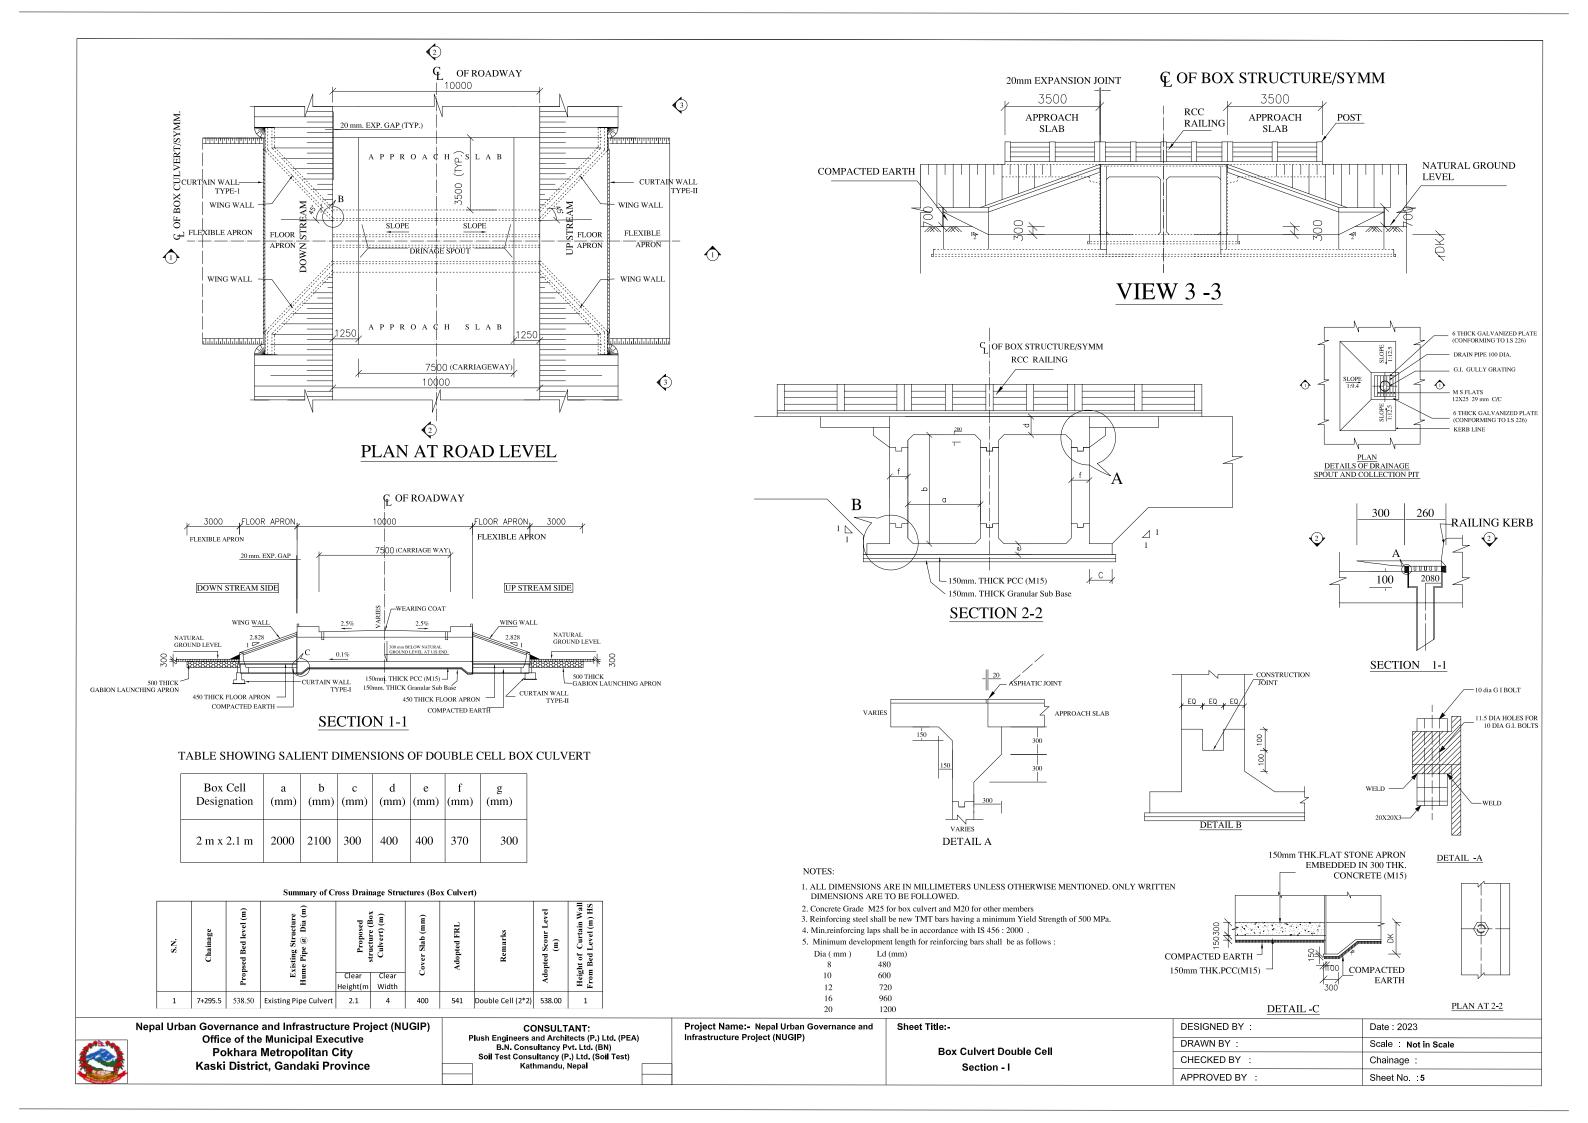


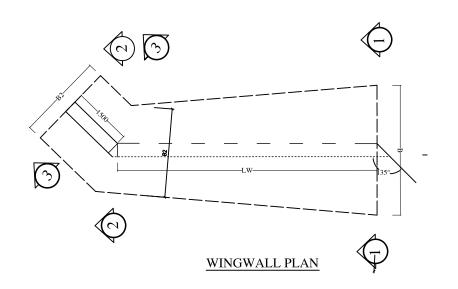


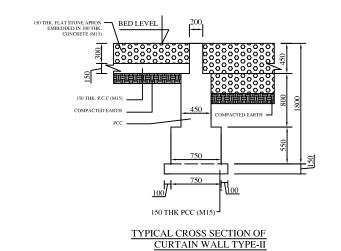

(UP STREAM SIDE)

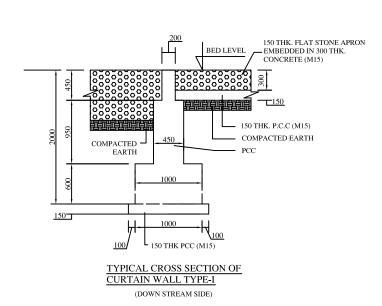


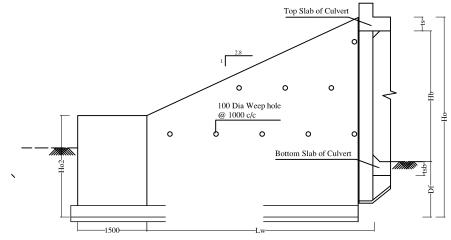


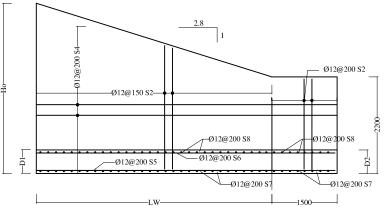


### WINGWALL ELEVATION

REINFORCEMENT DETAILS OF WINGWALL (BACK FACE)

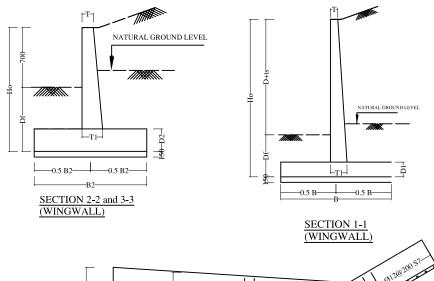

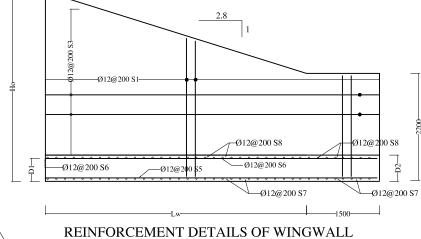


(FRONT FACE)

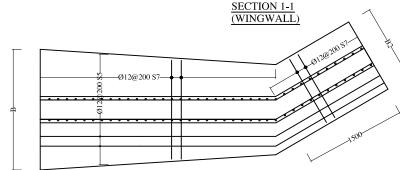

### REINFORCEMENT DETAILS OF WINGWALL PlAN (BOTTOM)


		Depth of		Length of		Section	on 1 -1		Sec	tion 2	-2 and	3 -3
S.No.		Foundation, Df (mm)	Ho (mm)	wing wall, Lw (mm)	1	T1 (mm)	1	D1 (mm)	T (mm)	T1 (mm)	B2 (mm)	D2 (mm)
1	2100	1500	4000	5000	200	420	1000	400	200	400	1000	400

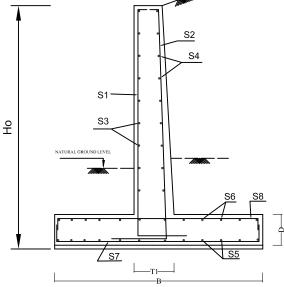

ARRANGEMENT OF REINFORCEMENTS

NOTES:

- 1. ALL DIMENSIONS ARE IN MILLIMETERS UNLESS OTHERWISE MENTIONED. ONLY WRITTEN DIMENSIONS ARE TO BE FOLLOWED.
- 2. FOR GENERAL NOTES AND REFERENCE DRAWINGS REFER DRG NO.
- 3. FOR REINFORCEMENT DETAIL REFER DRG. NO.
- 4. FOR DETAILS OF WING WALL REFER \DRG. NO.

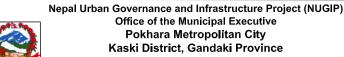



Project Name: - Nepal Urban Governance and Infrastructure Project (NUGIP)


Sheet Title:-

**Box Culvert Double Cell** Section - I

DESIGNED BY:	Date : 2023
DRAWN BY:	Scale : Not in Scale
CHECKED BY :	Chainage :
APPROVED BY :	Sheet No. : 6

( WING WALL)




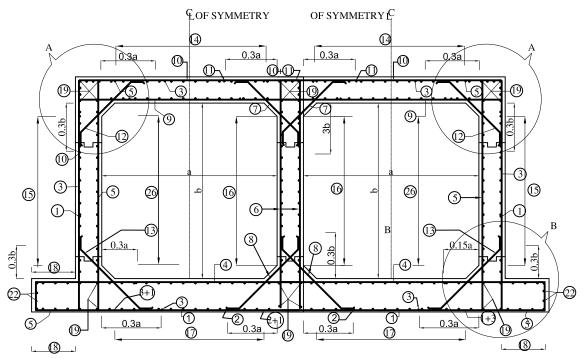

EOF SYMMETRY
0.3a


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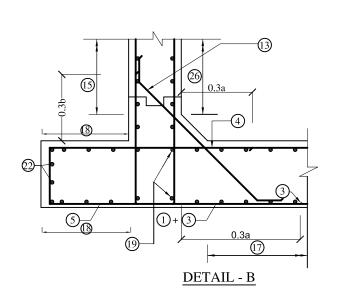
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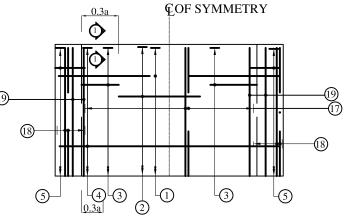


<u>VIEW 2 - 2</u>

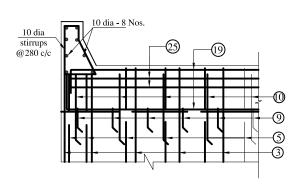
REINFORCEMENT DETAILS OF DOUBLE CELL BOX CULVERT






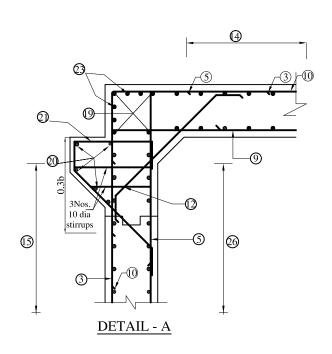

BOTTOM SLAB R/F PLAN

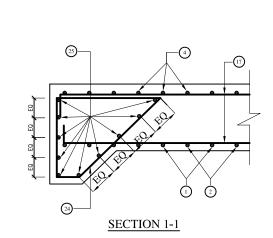


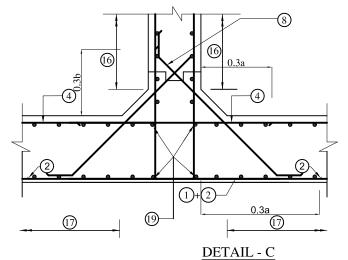


### LEGEND:

: TOP FACE BARS / OUTER FACE BARS : BOTTOM FACE BARS /

INNER FACE BARS

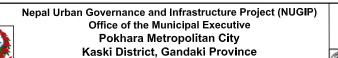



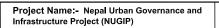



DESIGNED BY:	Date : 2023
DRAWN BY:	Scale :
CHECKED BY :	Chainage:
APPROVED BY :	Sheet No. :7
	·

	BOX-CELL DESIGNATION	Double Cell Box Culvert 2m x2.1m without earth cushion								
BAR MARK	Nc/ab/Ec SHAPE OF BARS (NOT TO SCALE)	BAR DIA. in mm.	SPACING in mm.	M1 in mm.	M2 in mm.	LENGTH in mm.	NO. OF BARS	TOTAL LENGTH in mm.	Wt/m, kg	Weight, kg
1	M M2 M1	10	200	950	4940	6840	51	348840	0.62	216.3
2	M1	10	200	1500	0	1500	50	75000	0.62	46.5
3	M1 M2 <u>M</u> 1	12	200	920	2700	4540	102	463080	0.89	412.1
4	M2 M1 M1	12	150	300	5540	6240	67	418080	0.89	372.1
5	M1 0.2m 0.2m <u>M2</u>	12	125	2700	570	5970	162	967140	0.89	860.8
6	M1 M2 <u>M</u> 1	16	200	260	2700	3220	102	328440	1.58	518.9
7	M1 M2	12	200	200	960	1360	102	138720	0.89	123.5
8	M1 M2 M1	12	200	200	960	1360	102	138720	0.89	123.5
9	M2 M1 M1	12	125	200	4940	5340	81	432540	0.89	385.0
10	M2 M1 M1	10	200	950	4940	6840	51	348840	0.62	216.3
11	M1	16	200	1500	0	1500	50	75000	1.58	118.5
12	M1 M2	12	200	200	1060	1460	102	148920	0.89	132.5
13	M1 M2 M1	12	200	200	1060	1460	102	148920	0.89	132.5
14	M2 M1 M1	8	150	200	9900	10300	46	473800	0.4	189.5
15	M2 M1 M1	8	150	200	9900	10300	23	236900	0.4	94.8
16	M2 M1 M1	8	150	200	9900	10300	24	247200	0.4	98.9
17	M2 M1 M1	8	150	200	9900	10300	48	494400	0.4	197.8
18	M2 M1 M1	8	150	200	9900	10300	10	103000	0.4	41.2
19	M2 M1 M1	10	-	160	9900	10220	16	163520	0.62	101.4
20	<u>M1</u>	12	-	9900	0	9900	10	99000	0.89	88.1
21	(M1) M2	12	200	1000	1260	2260	99	223740	0.89	199.1
22	M1 M2 M1	10	-	160	9900	10220	2	20440	0.62	12.7
23	M1 M2 M1	10	ı	180	9900	10260	4	41040	0.62	25.4
24	M1=0.20 m M1=0.20 m M2=0.20 m	10	150	1100	1550	4150	76	315400	0.62	195.5
25	M1 M2 M1	10	-	160	5540	5860	20	117200	0.62	72.7
26	M2 M1 M1	10	250	180	9900	10260	16	164160	0.62	101.8
										5077.3





Project Name:- Nepal Urban Governance and Infrastructure Project (NUGIP)

Sheet Title:-

Box Culvert Double Ce
(Reinforcement Details
Section - I


DESIGNED BY:	Date : 2023
DRAWN BY:	Scale :
CHECKED BY :	Chainage:
APPROVED BY :	Sheet No. :8

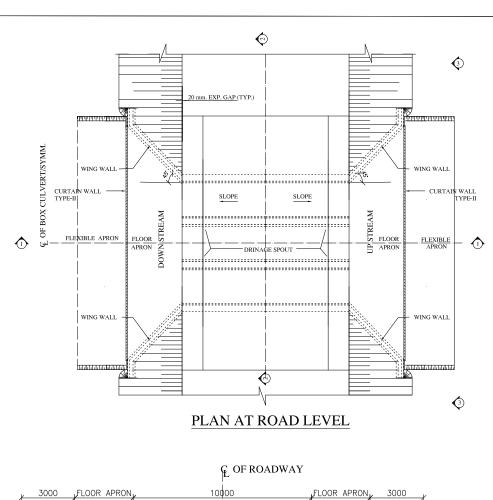

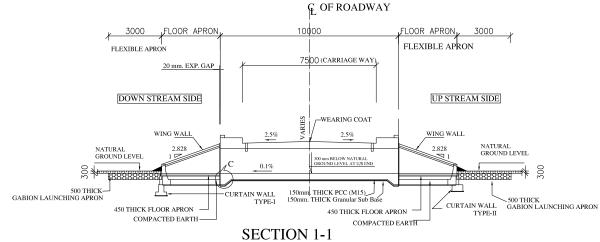

#### TABLE SHOWING SALIENT DIMENSIONS OF TRIPLE CELL BOX CULVERT

Box Cell	a	b	c	d	e	f	g	h	Design base
Designation	(mm)	Pressure t/m2							
3 m x 2.35 m	3000	2350	300	450	500	470	400	NA	7.1

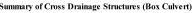

		Sui	umary or	Cluss Dia	image 5ti	uctures (1	JOX Cuivert)			
S.N.	Chainage	Propsed Bed level (m)	Clear Height(m	Culvert) (m) Clear Width	Cover Slab (mm)	Adopted FRL	Remarks	Adopted Scour Level (m)	Height of Curtain Wall From Bed Level (m) HS	
1	2+444	647.70	3.5	7	450	651.7	Triple Cell (3*2.33)	646.82	1	l

Nepal Urban Governance and Infrastructure Project (NUGIP) Office of the Municipal Executive Pokhara Metropolitan City Kaski District, Gandaki Province

CONSULTANT:
Plush Engineers and Architects (P.) Ltd. (PEA) B.N. Consultancy Pvt. Ltd. (BN)
Soil Test Consultancy (P.) Ltd. (Soil Test)

Project Name: - Nepal Urban Governance and Infrastructure Project (NUGIP)

Sheet Title:-

600

720

960

1200


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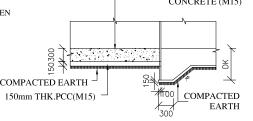
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16

**Box Culvert Triple Cell** Section - I

DETAIL -C DESIGNED BY: Date: 2023 DRAWN BY Scale : Not in Scale CHECKED BY Chainage APPROVED BY Sheet No. 9






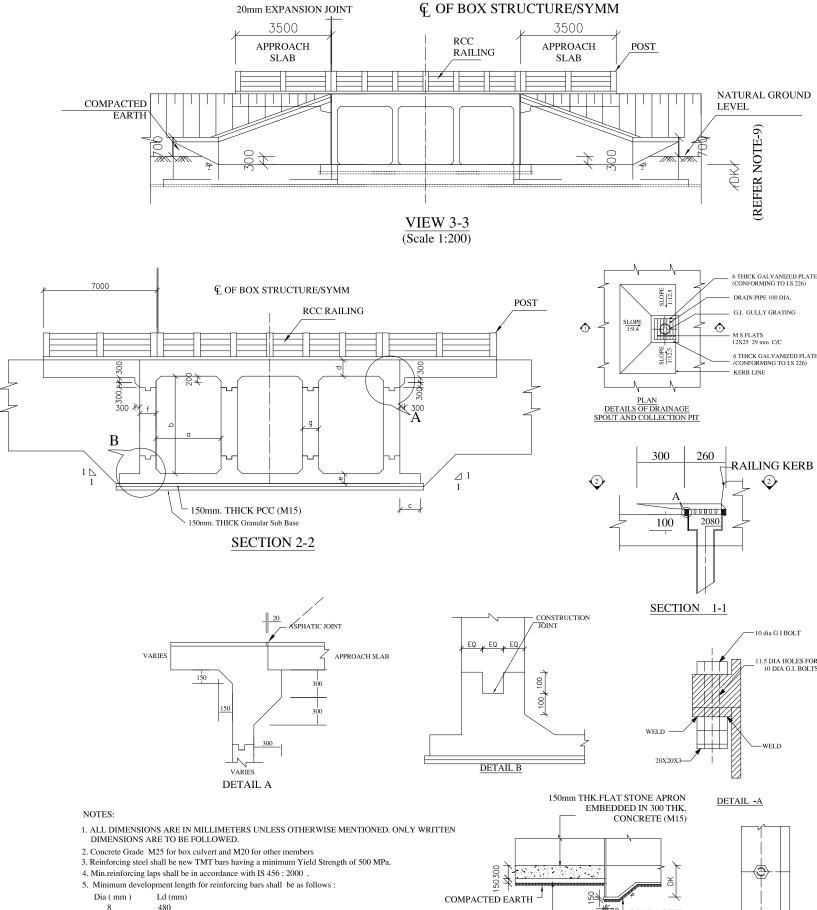


PLAN AT 2-2







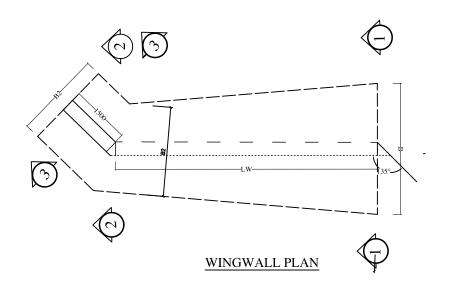


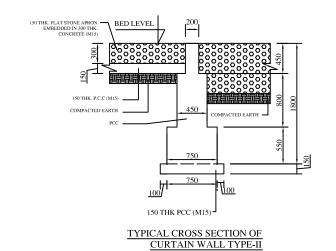

(UP STREAM SIDE)

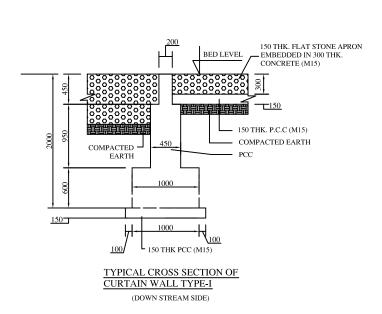


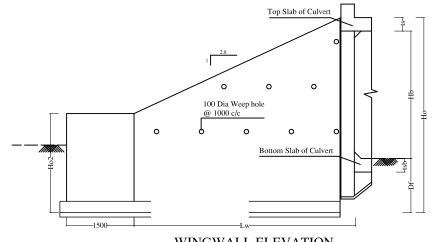


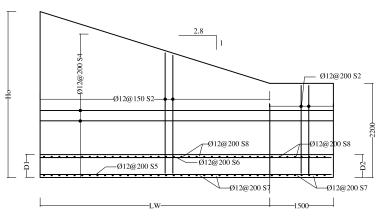

#### REINFORCEMENT DETAILS OF WINGWALL WINGWALL ELEVATION (BACK FACE)

−Ø12@200 S6

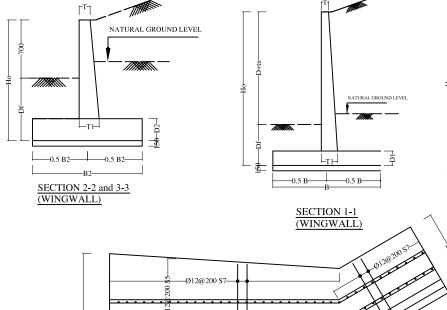

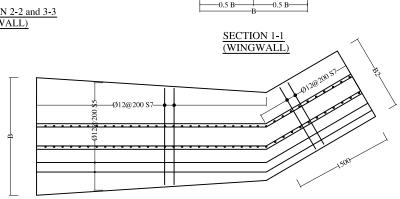

REINFORCEMENT DETAILS OF WINGWALL PlAN (BOTTOM)

G > 7		Depth of				Section	on 1 -1		Sec	tion 2	-2 and	3 -3
S.No.	Opening, Hb (mm)	Foundation, Df (mm)	Ho (mm)	wing wall, Lw (mm)	T (mm)	T1 (mm)	B (mm)	D1 (mm)	T (mm)	T1 (mm)	B2 (mm)	D2 (mm)
1	3500	1500	5450	9000		420	1000	, ,		400	1000	



<u>/ s7</u>

−Ø12@200 S8

---- Ø12@200 S6

Ŭ—Ø12@200 S7

−Ø12@200 S7

---Ø12@2**∮**0 **§**5

REINFORCEMENT DETAILS OF WINGWALL

(FRONT FACE)

ARRANGEMENT OF REINFORCEMENTS ( WING WALL)

NOTES:

- 1. ALL DIMENSIONS ARE IN MILLIMETERS UNLESS OTHERWISE MENTIONED. ONLY WRITTEN DIMENSIONS ARE TO BE FOLLOWED.
- 2. FOR GENERAL NOTES AND REFERENCE DRAWINGS REFER DRG NO.
- 3. FOR REINFORCEMENT DETAIL REFER DRG. NO.
- 4. FOR DETAILS OF WING WALL REFER \DRG. NO.

Nepal Urban Governance and Infrastructure Project (NUGIP) Office of the Municipal Executive Pokhara Metropolitan City





Project Name: - Nepal Urban Governance and Infrastructure Project (NUGIP)

Sheet Title:-


Box Culvert Triple Cell Section - I


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DRAWN BY:	Scale : Not in Scale
CHECKED BY :	Chainage:
APPROVED BY :	Sheet No. : 10

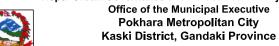

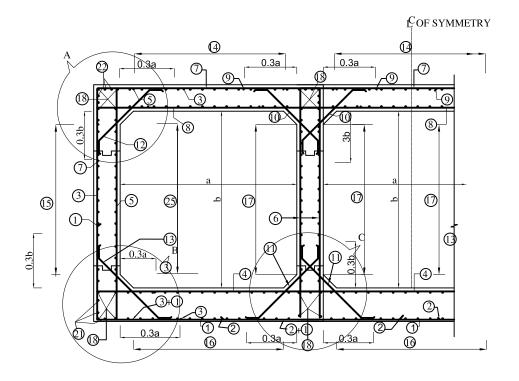


REINFORCEMENT DETAILS OF TRIPLE CELL BOX CULVERT

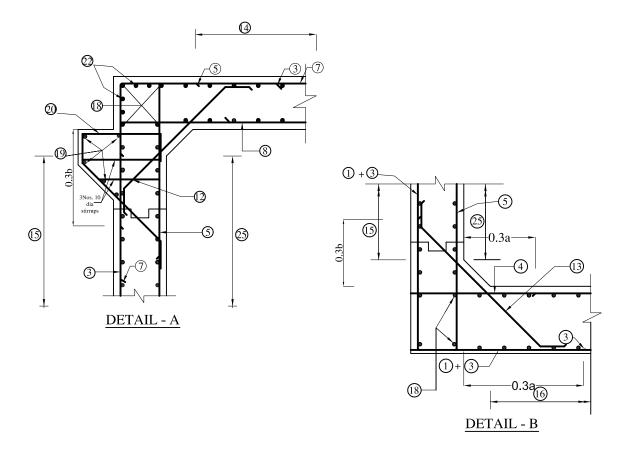


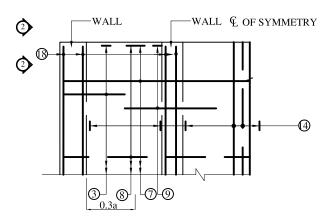


TOP SLAB R/F PLAN

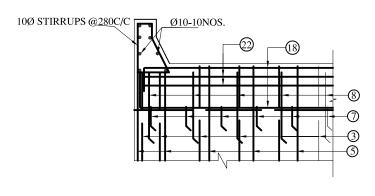


<u>VIEW 2 - 2</u>

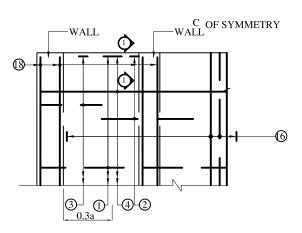

BOTTOM SLAB R/F PLAN

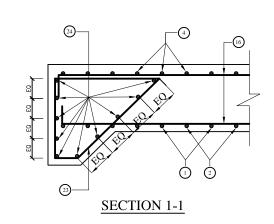

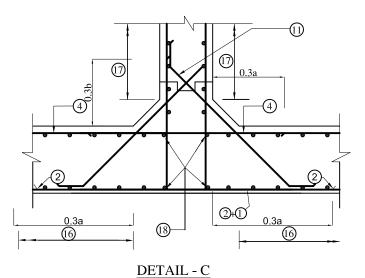

### LEGEND:


: TOP FACE BARS / OUTER FACE BARS

- : BOTTOM FACE BARS /

INNER FACE BARS

Nepal Urban Governance and Infrastructure Project (NUGIP)
Office of the Municipal Executive
Pokhara Metropolitan City
Kaski District, Gandaki Province



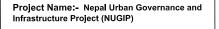

Sheet Title:-

Box Culvert Triple Cell (ReInforcement Details) Section - I


DESIGNED BY:	Date : 2023
DRAWN BY:	Scale :
CHECKED BY :	Chainage:
APPROVED BY :	Sheet No. :11

	BOX-CELL DESIGNATION			Triple (	Cell Box	Culvert 2.3	5m x3.5m v	vithout earth c	ushion	
BAR MARK	SHAPE OR SHAPE OR BARS (NOT TO SCALE)	BAR DIA.	SPACING	M1 in mm.	M2 in mm.	LENGTH in mm.	NO. OF BARS	TOTAL LENGTH in mm.	Wt/m, kg	Weight, kg
1	M1M1	16	200	1350	9640	12340	50	667000	1.58	1053.9
2	M1	12	200	2200	0	2200	100	220000	0.89	195.8
3	M1 M2 <u>M</u> 1	16	200	1320	3850	6490	102	661980	1.58	1045.9
4	M1 M2 M1	20	200	200	9640	10040	50	552000	2.47	1363.4
5	M1 M2 <u>M</u> 1	16	200	260	3850	4370	102	445740	1.58	704.3
6	M1 M2 <u>M</u> 1	20	200	320	3850	4490	204	915960	2.47	2262.4
7	M1 M1 M1	16	200	1300	9640	12240	50	662000	1.58	1046.0
8	M1 M2 M1	20	200	320	9640	10280	50	564000	2.47	1393.1
9	M1	16	200	2200	0	2200	102	224400	1.58	354.6
10	M1 M2	10	200	200	1170	1570	204	320280	0.62	198.6
11	M1 M2 M1	10	200	200	1240	1640	204	334560	0.62	207.4
12	M1 M2	10	200	200	1270	1670	102	170340	0.62	105.6
13	M1 M2 M1	10	200	200	1340	1740	102	177480	0.62	110.0
14	M2 M1 M1	10	200	270	9900	10440	82	856080	0.62	530.8
15	M2 M1 M1	12	200	230	9900	10360	28	290080	0.89	258.2
16	M2 M1 M1	12	200	250	9900	10400	82	852800	0.89	759.0
17	M2 M1 M1	12	200	190	9900	10280	56	575680	0.89	512.4
18	M2 M1 M1	12	-	200	9900	10300	32	329600	0.89	293.3
19	M1	12	-	9900	0	9900	10	99000	0.89	88.1
20	(MI M2)	12	200	1000	1300	2300	102	234600	0.89	208.8
21	M1M1	10	-	160	9900	10220	4	40880	0.62	25.3
22	M1 M2 M1 M1+0.20 m	10	-	160	9900	10220	4	40880	0.62	25.3
23	M1M2	12	200	1100	1550	4150	102	423300	0.89	376.7
24	M1 M1	12	-	190	10640	11020	20	220400	0.89	196.2
25	M1 M1	10	250	230	9900	10360	24	248640	0.62	154.2
										13469.2



CONSULTANT:
Plush Engineers and Architects (P.) Ltd. (PEA)
B.N. Consultancy Pvt. Ltd. (BN)
Soll Test Consultancy (P.) Ltd. (Soil Test)
Kathmandu, Nepal


Infrastructur

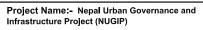


Sheet Title:-

Box Culvert Triple Cell
(ReInforcement Details)
Section - I

DESIGNED BY :	Date : 2023
DRAWN BY:	Scale :
CHECKED BY :	Chainage:
APPROVED BY :	Sheet No. :12

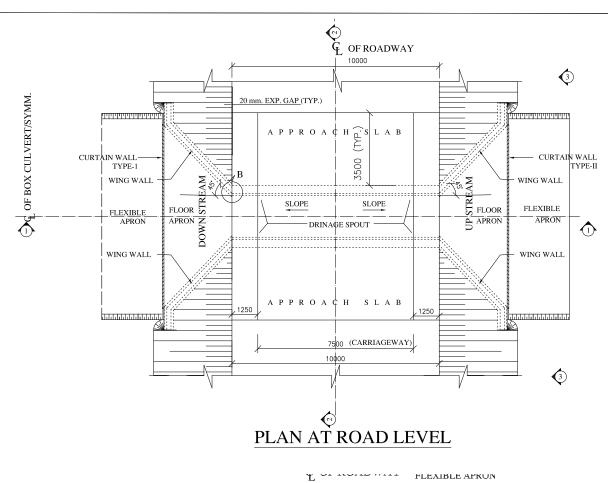

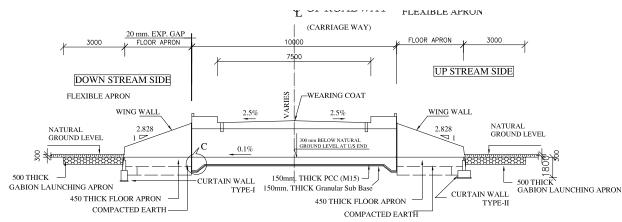


### **SECTION 1-1**


#### TABLE SHOWING SALIENT DIMENSIONS OF SINGLE CELL BOX CULVERT

Box Cell	a	b	c	d	e	f	g
Designation	(mm)						
3 m x 3 m	3000	3000	900	430	420	420	NA

S.N.	Chainage	l Bed level (m)	Proposec structure (Box Culvert)		er Slab	ted FRL	Remark
<b>3</b> 1	Ch	Propsed (i	Clear Height(m	Clear Width (m)	Cover	Adopted	Re
1	2+811	596.02	3.00	3.00	0.4	599.42	Extension of existing box culvert

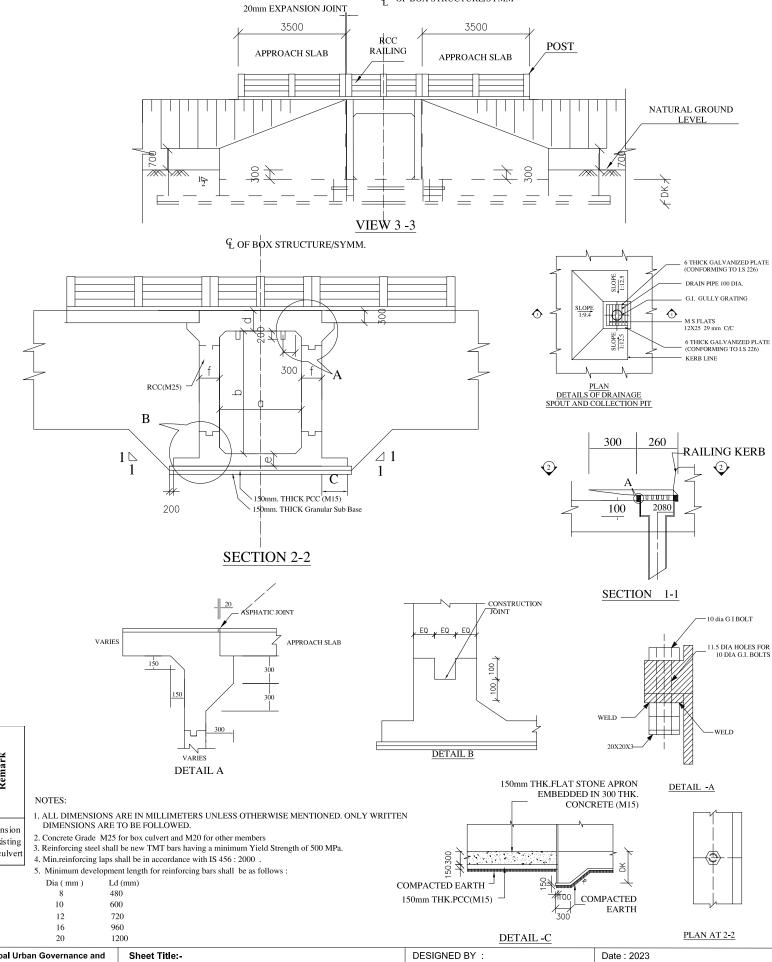

G. OF BOX STRUCTURE/SYMM

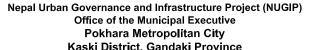


CONSULTANT:
Plush Engineers and Architects (P.) Ltd. (PEA) B.N. Consultancy Pvt. Ltd. (BN)
Soil Test Consultancy (P.) Ltd. (Soil Test)


Project Name:- Nepal Urban Governance and Infrastructure Project (NUGIP)


**Box Culvert Single Cell** Section - II

DRAWN BY Scale : Not in Scale CHECKED BY Chainage APPROVED BY Sheet No. :1

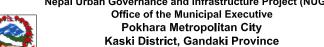





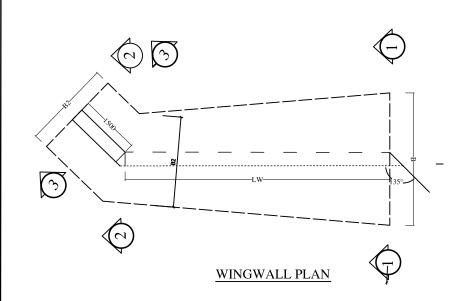


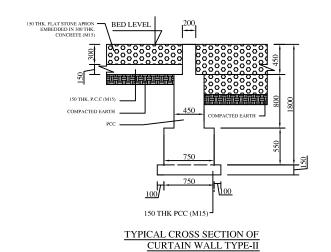

(UP STREAM SIDE)

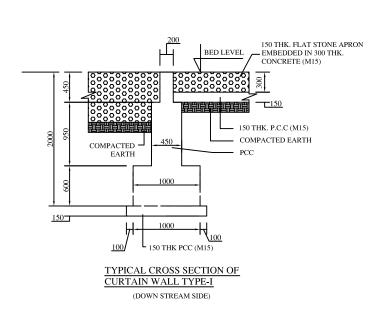

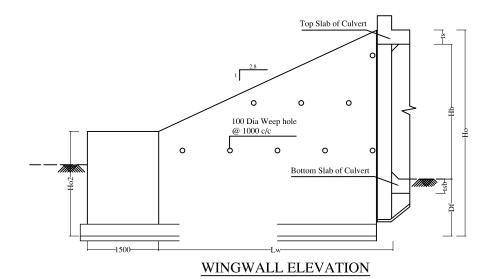

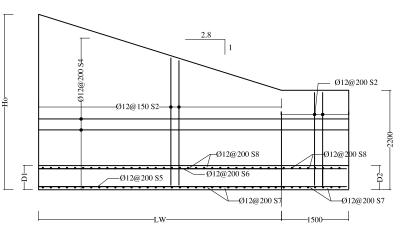

REINFORCEMENT DETAILS OF WINGWALL (BACK FACE)

−Ø12@200 S8

----Ø12@200 S6


−Ø12@200 S7


—Ø12@2**∮**0 **\$**:

−Ø12@200 S6

Ø12@200 S8

−Ø12@200 S7

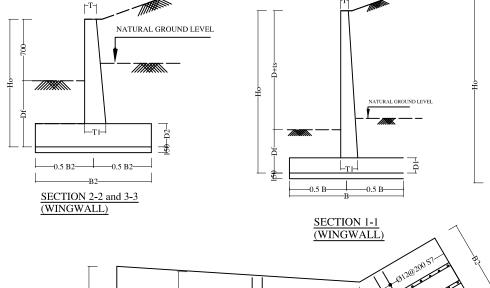

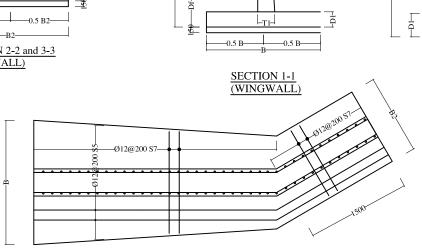

REINFORCEMENT DETAILS OF WINGWALL PIAN (BOTTOM)

a 1.	_	Depth of		Length of		Section	on 1 -1		Sec	tion 2	-2 and	. 3 -3
S.No.		Foundation, Df (mm)	Ho (mm)	wing wall, Lw (mm)	T (mm)	T1 (mm)	B (mm)	D1 (mm)	T (mm)	T1 (mm)	B2 (mm)	D2 (mm)
1	3000	1500	4930	7720	200	420	1000	400	200	400	1000	400

REINFORCEMENT DETAILS OF WINGWALL (FRONT FACE)

<u>/ s7</u>

ARRANGEMENT OF REINFORCEMENTS ( WING WALL)

1. ALL DIMENSIONS ARE IN MILLIMETERS UNLESS OTHERWISE MENTIONED. ONLY WRITTEN DIMENSIONS ARE TO BE FOLLOWED.

2. FOR GENERAL NOTES AND REFERENCE DRAWINGS REFER DRG NO.

3. FOR REINFORCEMENT DETAIL REFER DRG. NO.

4. FOR DETAILS OF WING WALL REFER \DRG. NO.

Nepal Urban Governance and Infrastructure Project (NUGIP) Office of the Municipal Executive Pokhara Metropolitan City Kaski District, Gandaki Province




Project Name: - Nepal Urban Governance and


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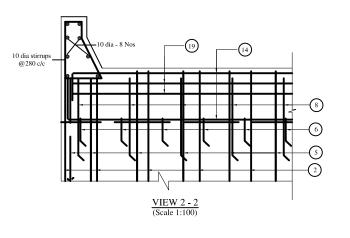
**Box Culvert Single Cell** Section - II


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DRAWN BY:	Scale : Not in Scale
CHECKED BY :	Chainage:
APPROVED BY :	Sheet No. : 2





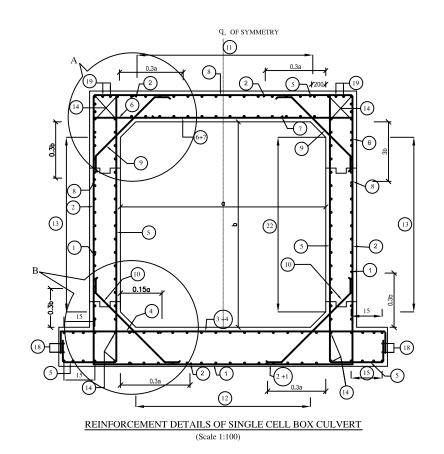

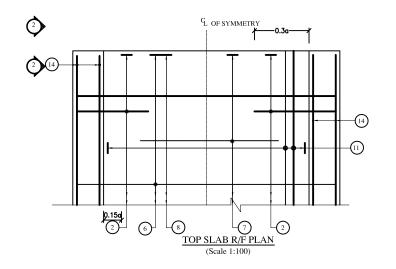


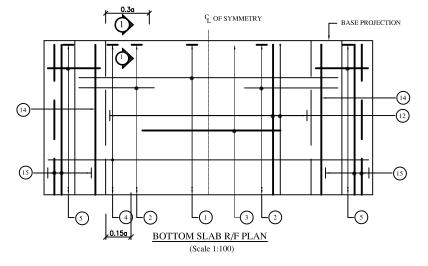



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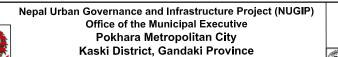
: TOP FACE BARS / OUTER FACE BARS

--- : BOTTOM FACE BARS / INNER FACE BARS



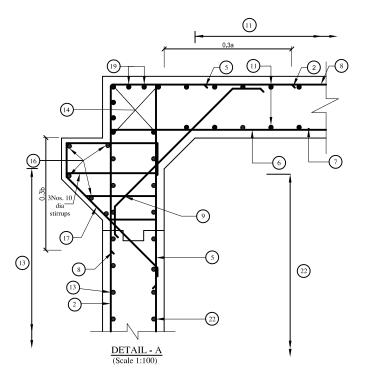

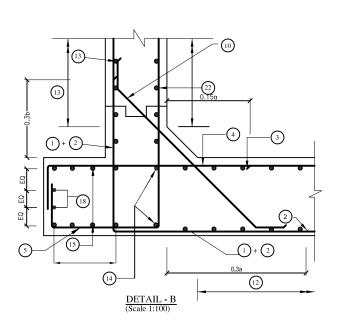

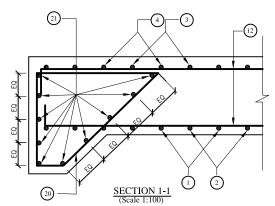



Project Name:- Nepal Urban Governance and Infrastructure Project (NUGIP)

Sheet Title:-


Box Culvert Single Cell (ReInforcement Details) Section - II

DESIGNED BY:	Date : 2023
DRAWN BY:	Scale :
CHECKED BY :	Chainage:
APPROVED BY :	Sheet No. :3

	BOX-CELL DESIGNATION		S	ingle Cel	l Box Cul	vert 3m x3n	n without ear	th cushion		
BAR MARK	NC/ab/Ec SHAPE OF BARS (NOT TO SCALE)	BAR DIA. in mm.	SPACING in mm.	M1 in mm.	M2 in mm.	LENGTH in mm.	NO. OF BARS	TOTAL LENGTH in mm.	Wt/m, kg	Weight, kg
1	M1 M2 M1	10	200	1270	3740	6280	50	314000	0.62	194.7
2	M1 M2 M1	16	200	1270	3740	6280	102	640560	1.58	1012.1
3	MI	12	200	2100	0	2100	50	105000	0.89	93.5
4	M2 M1 M1	16	200	320	5540	6180	50	309000	1.58	488.2
5	M1 0.2m. 0.2m. <u>M2</u>	12	150	3740	1220	5360	100	536000	0.89	477.0
6	M1 M1 M1	16	200	260	3740	4260	50	213000	1.58	336.5
7	M1					Bar not r	eeded			
8	M2 M1 M1	10	200	1270	3740	6280	50	314000	0.62	194.7
9	M1 M2 M1	10	200	200	1160	1560	100	156000	0.62	96.7
10	M1 M2 M1	10	200	200	1160	1560	100	156000	0.62	96.7
11	M2 M1 M1	10	200	200	9900	10300	28	288400	0.62	178.8
12	M2 M1 M1	12	200	200	9900	10300	28	288400	0.89	256.7
13	M1 M2 M1	10	200	200	9900	10300	28	288400	0.62	178.8
14	M1 M2 M1	10	-	160	9900	10220	12	122640	0.62	76.0
15	M1 M2 M1	10	200	200	9900	10300	24	247200	0.62	153.3
16	<u>M1</u>	12	-	0	9900	9900	10	99000	0.89	88.1
17	M2 M2	12	200	1000	1260	2260	100	226000	0.89	201.1
18	M1 <u>M2</u> M1	10	ı	160	9900	10220	4	40880	0.62	25.3
19	M1 <u>M2</u> M1	10	-	160	9900	10220	8	81760	0.62	50.7
20	M1 M1+0.20 m M2	10	200	1100	1550	4150	56	232400	0.62	144.1
21	M1 M2 M1	10	-	160	5540	5860	20	117200	0.62	72.7
22	M2 M1 M1	10	200	210	9900	10320	28	288960	0.62	179.2
										4594.9




CONSULTANT:
Plush Engineers and Architects (P.) Ltd. (PEA)
B.N. Consultancy Pvt. Ltd. (BN)
Soil Test Consultancy (P.) Ltd. (Soil Test)
Kathmandu, Nepal 

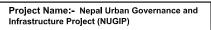


Sheet Title:-

Box Culvert Single Cell (ReInforcement Details) Section - II

DESIGNED BY :	Date : 2023
DRAWN BY:	Scale :
CHECKED BY :	Chainage:
APPROVED BY :	Sheet No. :4

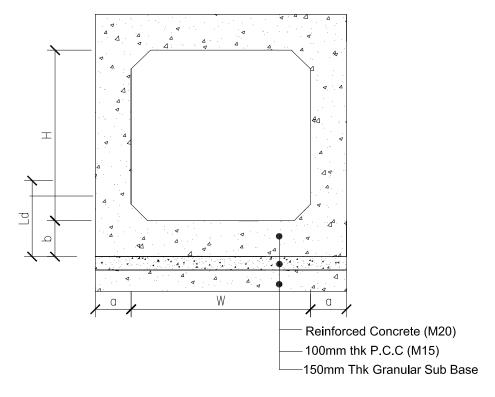

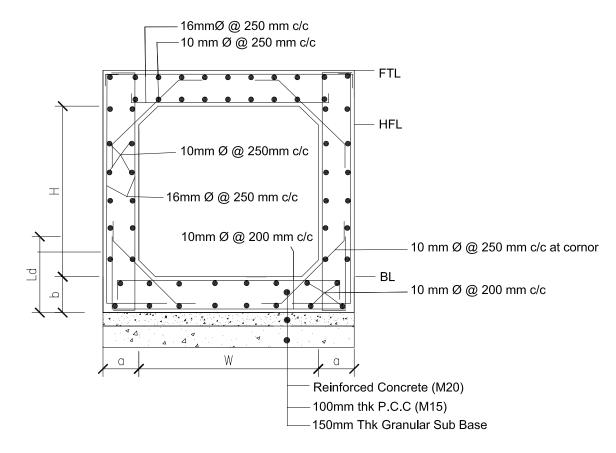


**Drain Crossing** 

Reinforcement Details at Drain Crossing

S.N.	Chainage	Proposed Structure	Proposed size (H*W)m	Cover Slab (mm)	a (mm)	b (mm)
1.	1+089.7	Drain Crossing	2*1.5	350	300	300
2.	9+447	Drain Crossing	1*1	250	200	200



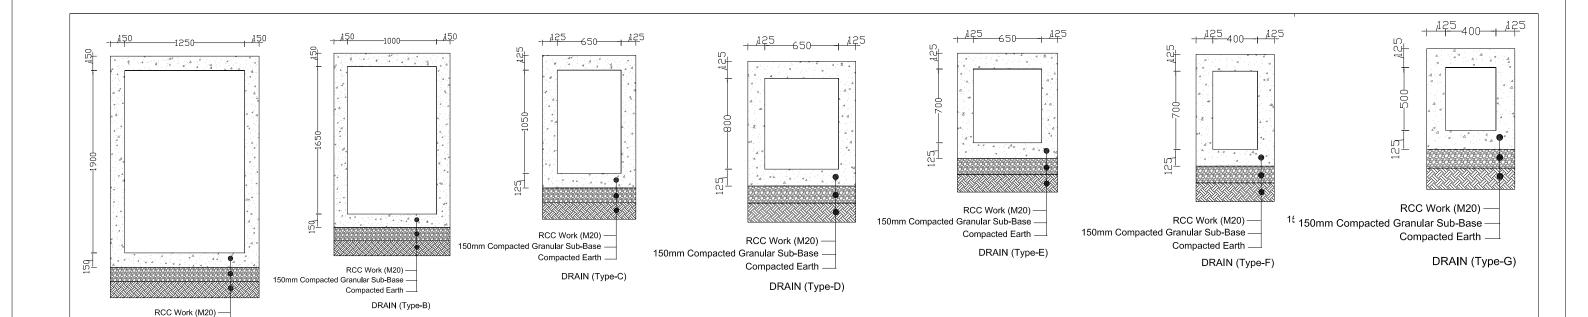

С	H	Length	Width	Final Gross Depth	Catageroy	Remarks
From	To	L	b	D		
Km	ı+m	m	m	m		
0+500.0	1+089.7	589.70	1.250	1.900	Α	
0+000.0	0+500.0	500.00	1.000	1.650	В	
1+592.0	2+080.0	488.00	0.650	1.050	С	
1+092.0	1+592.0	500.00	0.650	0.800	D	
3+328.0	3+793.0	1093.00	0.650	0.700	E	
4+680.0	5+308.0	1093.00	0.000	0.700	E	
6+750.0	7+124.0					
7+299.5	7+124.0					
8+951.0	9+447.0					
2+780.0	2+329.7					
2+780.0	3+111.5	3146.80	0.400	0.700	F	
5+549.0	5+880.0					
5+880.0	6+270.0					RCC
8+320.0	7+989.0	Ì				Rectagular
8+560.0	8+827.5					Drain
2+244.0	2+329.7					
3+328.0	3+111.5					
4+110.7	3+793.0					
5+549.0	5+308.0					
6+360.0	6+481.0	<b> </b>				
6+481.0	6+750.0	<b>†</b>				
7+344.5	7+295.5					
7+344.5	7+400.0	2498.56	0.400	0.500	G	
7+535.7	7+400.0	]				
7+726.2	7+531.0	1				
7+969.4	7+721.3	†				
7+969.4	7+989.0	†				
8+447.0	8+320.0	†				
8+447.0	8+560.0	†				
8+827.5	8+951.0	†				
9+447.0	9+628.0	ł		l		

Summary of sizes of Road Side Drain -Left Sides							
СН		Length	Width	Final Gross Depth	Catageroy	Remarks	
From	To	L	b	D	1		
Km	+m	m	m	m			
0+500.0	1+089.7	589.70	1.250	1.900	А		
0+000.0	0+500.0	500.00	1.000	1.650	В		
1+092.0	1+592.0						
1+592.0	2+243.0	1352.00	0.650	0.700	E		
6+280.0	6+481.0						
2+781.3	3+111.5						
8+560.0	8+827.5	1093.70	0.400	0.700	F		
8+951.0	9+447.0						
2+781.3	2+540.0					rectangular	
3+328.0	3+111.5						RCC drain
3+328.0	3+793.0						
4+110.7	3+793.0						
4+540.0	5+308.0	2753.78	0.400	0.500	G		
6+500.0	6+750.0						
6+750.0	6+820.0						
8+439.3	8+560.0						
8+827.5	8+951.0						
9+447.0	9+628.0						

Nepal Urban Governance and Infrastructure Project (NUGIP)
Office of the Municipal Executive
Pokhara Metropolitan City
Kaski District, Gandaki Province

150mm Compacted Granular Sub-Base

Compacted Earth — DRAIN (Type-A)

CONSULTANT:
Plush Engineers and Architects (P.) Ltd. (PEA)
B.N. Consultancy Pvt. Ltd. (BN)
Soil Test Consultancy (P.) Ltd. (Soil Test)
Kathmandu, Nepal





Project Name: - Nepal Urban Governance and	d
Infrastructure Project (NUGIP)	


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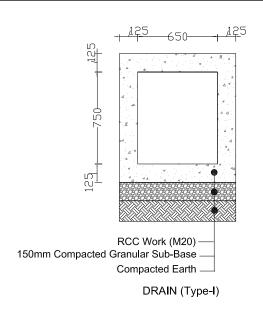
Typical Side Drain- ( Section I )

DESIGNED BY:	Date : 2023
DRAWN BY	Scale:
CHECKED BY :	Chainage:
APPROVED BY :	Sheet No. : 1



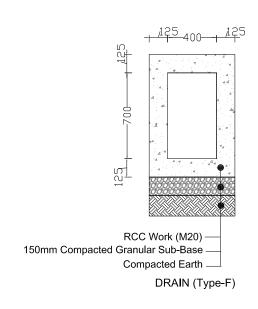

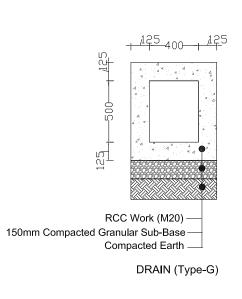

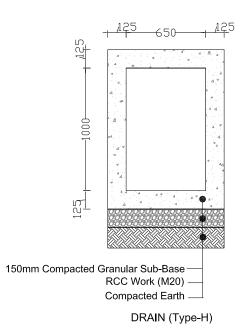

Summary	of sizes o	f Rad Side	Drain - Ri	ght Sides				
СН		Length	Width	Final Gross Depth	Catageroy	Remarks		
From	To	L	b	D				
Km	ı+m	m	m	m				
0+000.0	0+446.0	575.00	575.00 0.400	575 00		0.700	F	
0+752.0	0+623.0			0.700				
0+560.0	0+446.0	384.04				Rectangular		
0+832.5	0+752.0		0.400	0.500	G	RCC Drain		
1+780.0	1+900.0		304.04 0.400	0.400	0.500			
1+969.5	1+900.0							

Summary of sizes of Road Side Drain - Left Sides						
СН		Length	Width	Final Gross Depth	Catageroy	Remarks
From	To	L	b	D		
Km	ı+m	m	m	m		
1+969.5	2+629.0	659.47	0.650	1.000	Н	
1+351.0	1+900.0	549.00	0.650	0.750	I	
1+351.0	0+954.0					
2+629.0	2+812.0	1025.99	0.400	0.700	F	Rectangular
0+000.0	0+446.0					RCC Drain
0+560.0	0+446.0					
0+954.0	0+832.5	305.04	0.400	0.500	G	
1+969.5	1+900.0					













Project Name:- Nepal Urban Governance and
Infrastructure Project (NUGIP)

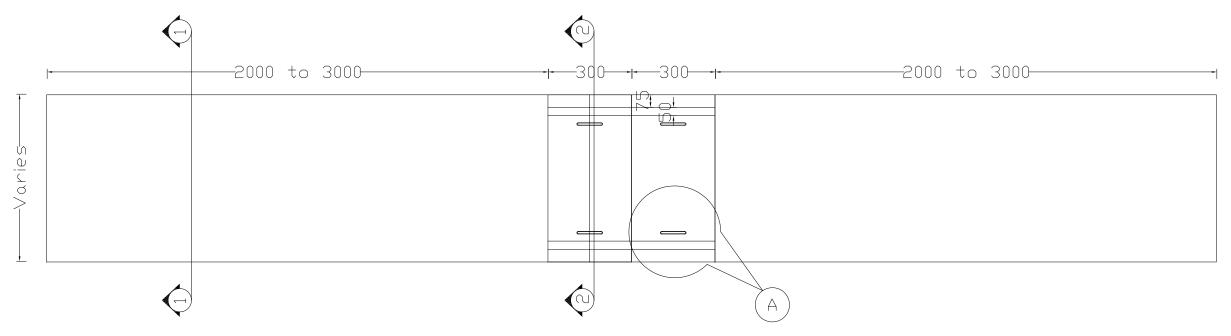

### PLAN OF DRAIN

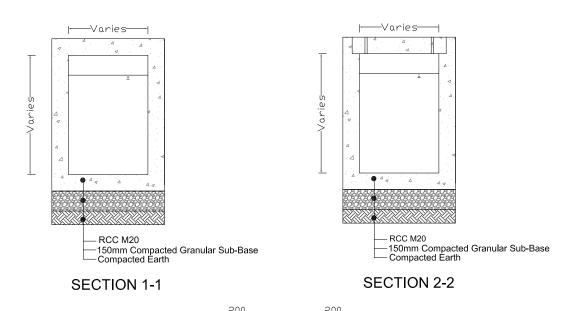

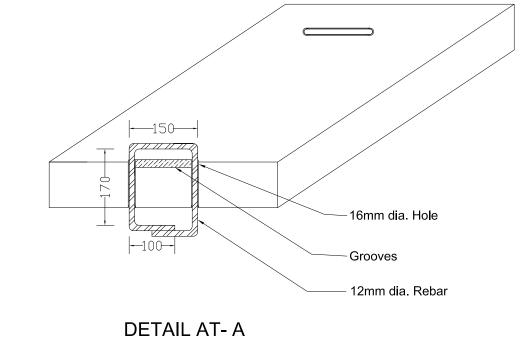

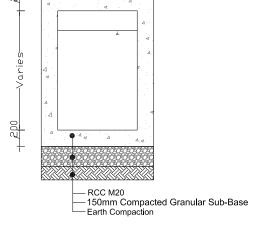

AT ROAD CROSSING

Nepal Urban Governance and Infrastructure Project (NUGIP)
Office of the Municipal Executive
Pokhara Metropolitan City
Kaski District, Gandaki Province

CONSULTANT:
Plush Englneers and Architects (P.) Ltd. (PEA)
B.N. Consultancy Pvt. Ltd. (BN)
Soil Test Consultancy (P.) Ltd. (Soil Test)
Kathmandu, Nepal

Project Name:- Nepal Urban Governance and Infrastructure Project (NUGIP)

Sheet Title:-

Typical Side Drain


 DESIGNED BY :
 Date : 2023

 DRAWN BY :
 Scale :


 CHECKED BY :
 Chainage :

 APPROVED BY :
 Sheet No. : 3



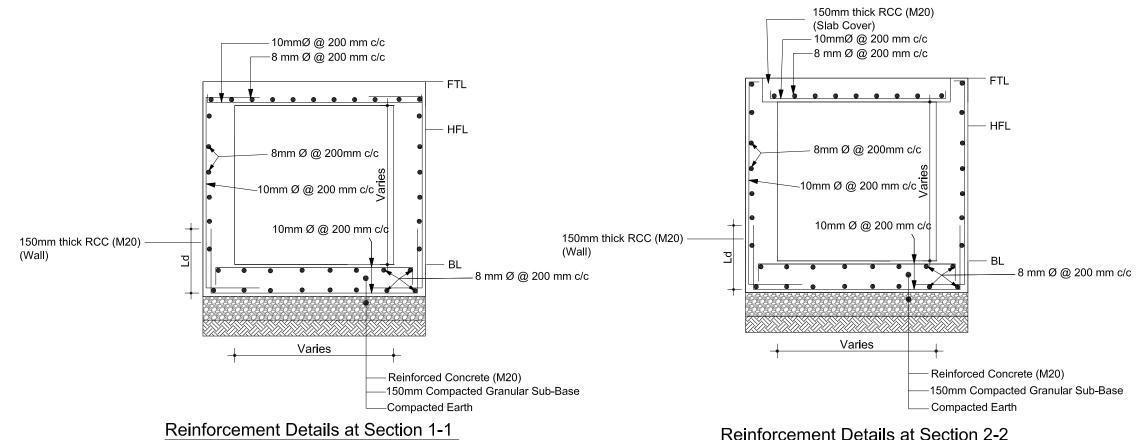

Reinforcement Details at Section 2-2

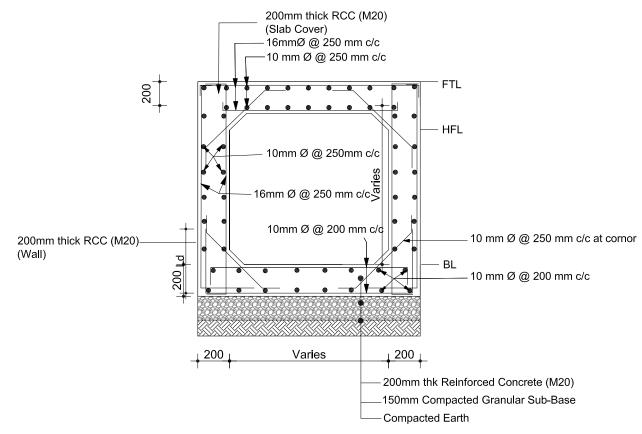

### Reinforcement Details at Road Crossing





Project Name:- Nepal Urban Governance and Infrastructure Project (NUGIP)

Sheet Title:-


Typical Side Drain

DESIGNED BY:	Date : 2023
DRAWN BY:	Scale:
CHECKED BY :	Chainage:
APPROVED BY :	Sheet No.: 4

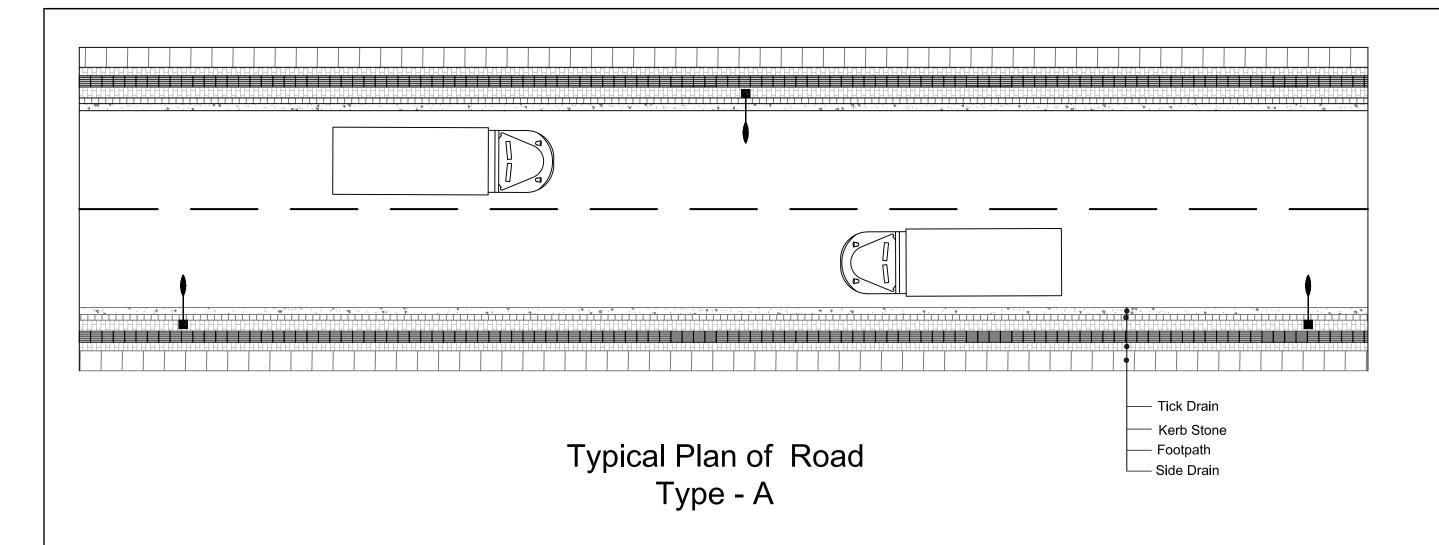

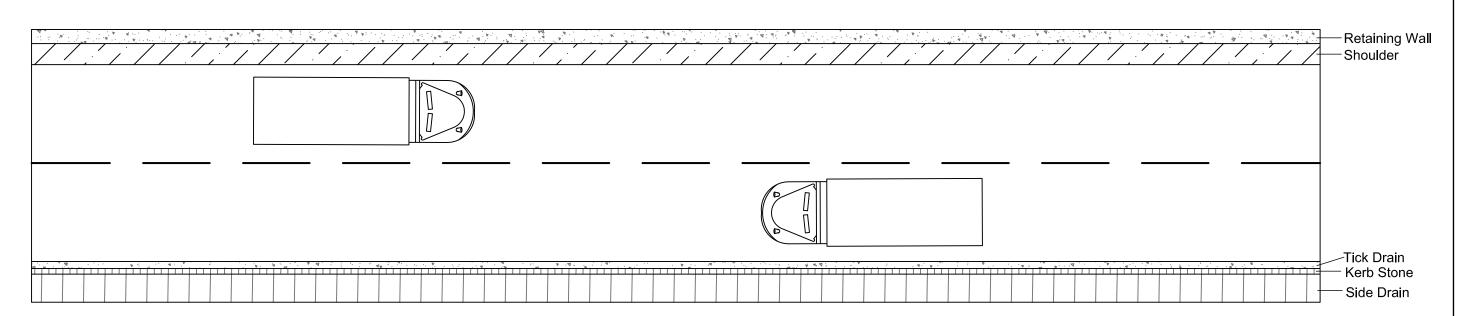

# Typical Plan of Road Type - B

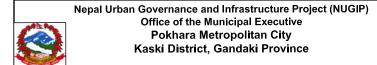

CONSULTANT:
Plush Englneers and Architects (P.) Ltd. (PEA)
B.N. Consultancy Pvt. Ltd. (BN)
Soil Test Consultancy (P.) Ltd. (Soil Test)
Kathmandu, Nepal

Project Name:- Nepal Urban Governance and Infrastructure Project (NUGIP)

Sheet Title:-


Typical Plan of Road

 DESIGNED BY :
 Date : 2023

 DRAWN BY :
 Scale :

 CHECKED BY :
 Chainage :

 APPROVED BY :
 Sheet No. : 1

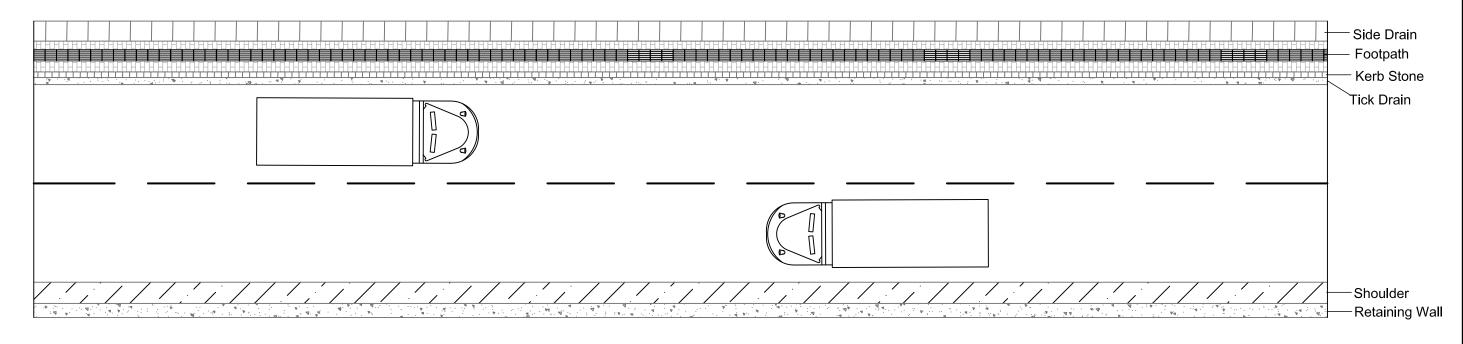


Typical Plan of Road Type - C




CONSULTANT:
Plush Englneers and Architects (P.) Ltd. (PEA)
B.N. Consultancy Pvt. Ltd. (BN)
Soil Test Consultancy (P.) Ltd. (Soil Test)
Kathmandu, Nepal




Typical Plan of Road

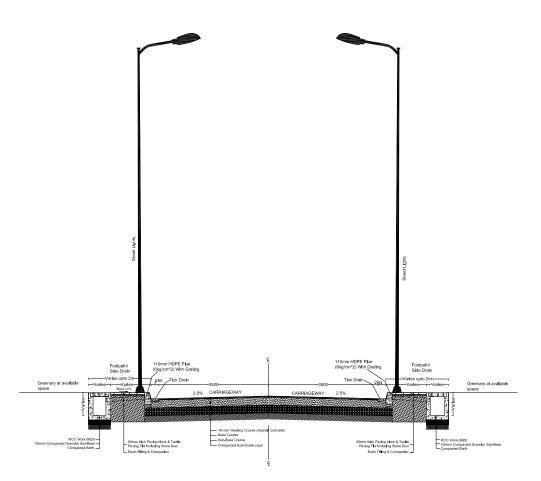


**Typical Cross Section of Road** 

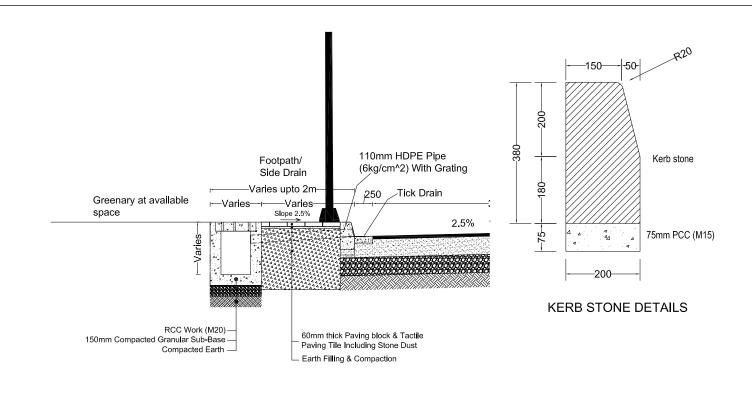


**Typical Cross Section of Footpath** 

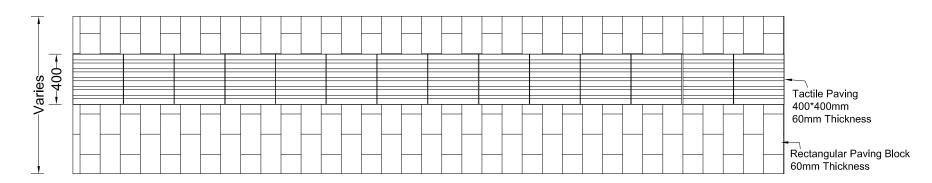

Footpath Plan

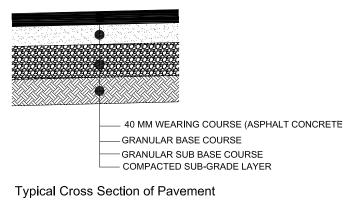

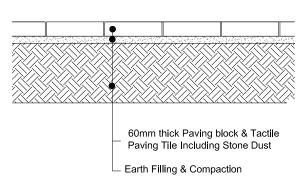

FOOTPATH DETAILS




Nepal Urban Governance and Infrastructure Project (NUGIP) Office of the Municipal Executive Pokhara Metropolitan City Kaski District, Gandaki Province

CONSULTANT:
Plush Englneers and Architects (P.) Ltd. (PEA)
B.N. Consultancy Pvt. Ltd. (BN)
Soil Test Consultancy (P.) Ltd. (Soil Test)
Kathmandu, Nepal

Project Name:- Nepal Urban Governance and Infrastructure Project (NUGIP)

Sheet Title:-

DESIGNED BY: Date : 2023 DRAWN BY Scale Chainage CHECKED BY APPROVED BY Sheet No. : 1

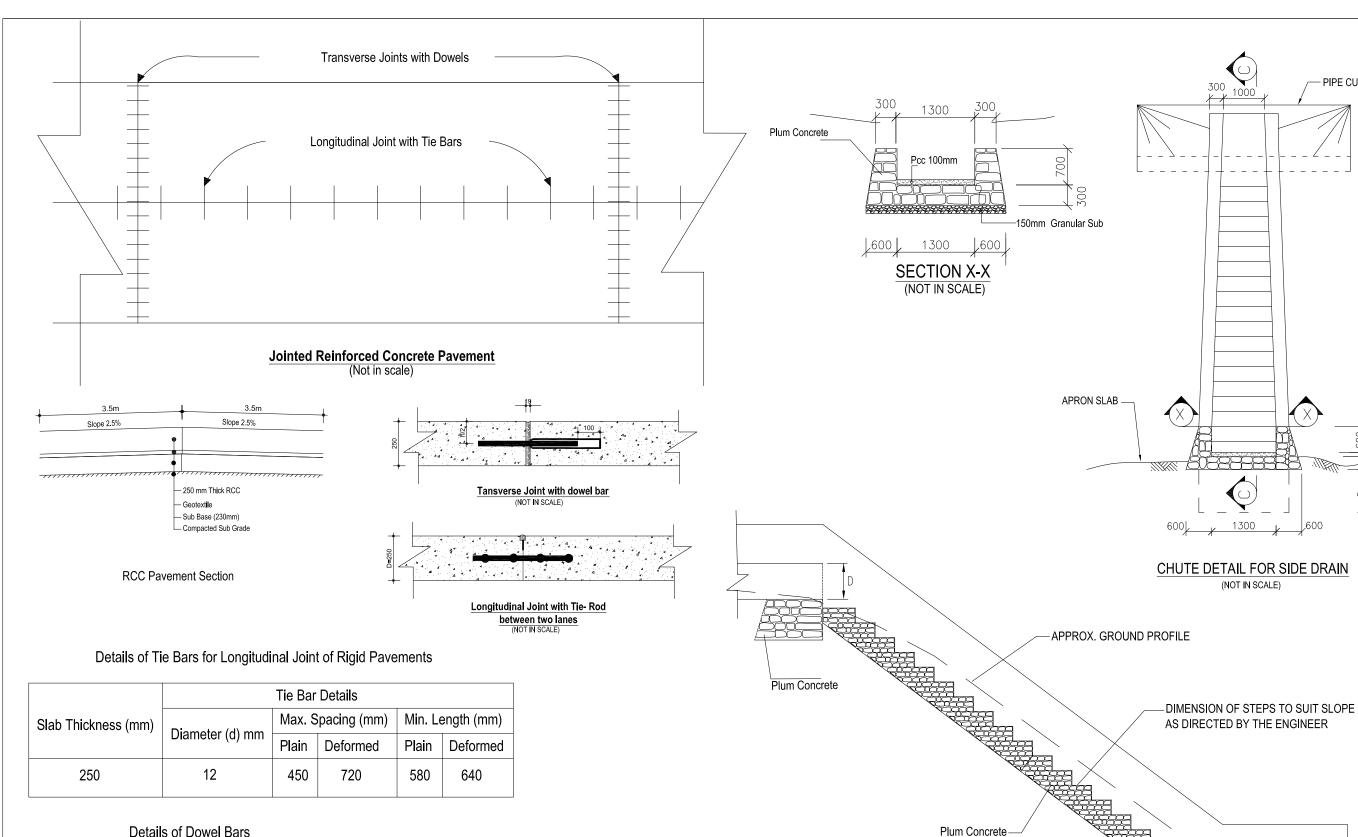

**Details of Dowel Bars** 

Slab Thickness (mm)	Dowel Bar Details			
	Diameter (d) mm	Length (mm)	Spacing (mm)	
250	32	450	300	

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Soil Test Consultancy (P.) Ltd. (Soil Test)

Project Name: Nepal Urban Governance and Infrastructure Project (NUGIP)

Sheet Title:-

REINFORCEMENT CONCRETE PAVEMENT AND CHUTE DETAIL


SECTION C-C (NOT IN SCALE)


> DESIGNED BY Date : 2023 DRAWN BY: Scale : CHECKED BY Chainage : APPROVED BY Sheet No. : 1

600

PIPE CULVERT END SECTION



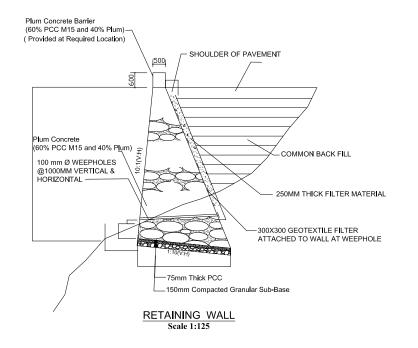

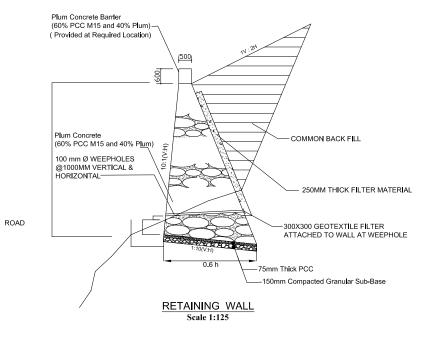

#### NOTES:

- 1. Wall height is to be modified as per actual site condition or as directed by the Engineer.
- 2. Wall height for more than 6.0 m, soil investigation is to be done or as directed by the Engineer.
- Expansion Joint is to be provided maximum at a distance of 10.0 m C/C .lt should be located, wherever possible, at every major changes in the wall height or as directed by the Engineer.
- 4. Mortar joint width to be 25mm to 35mm. Exposed face of masonry is to be free from mortar stains.
- 5. Minimum depth of foundation shall be 600mm or as directed by the Engineer.
- 6. Lowest weep hole should not be more than 200mm above final ground level at the toe of wall or as directed by the Engineer.
- 7. Place the foundation inclined at 10% slope
- 8. Retaining wall shall be curved in plan & profile to the center line of road where directed by the Engineer.
- 9. Wall interior is not to be filled with dry stone rubble.
- 10. Others not mentioned shall be in accordance with the specifications and special provisions

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Kaski District, Gandaki Province

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Soil Test Consultancy (P.) Ltd. (Soil Test)
Kathmandu, Nepal





Project Name:- Nepal Urban Governance and Infrastructure Project (NUGIP)

Sheet Title:-


Typical Retaining Wall

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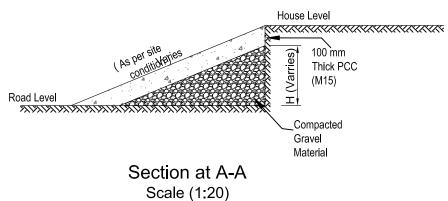


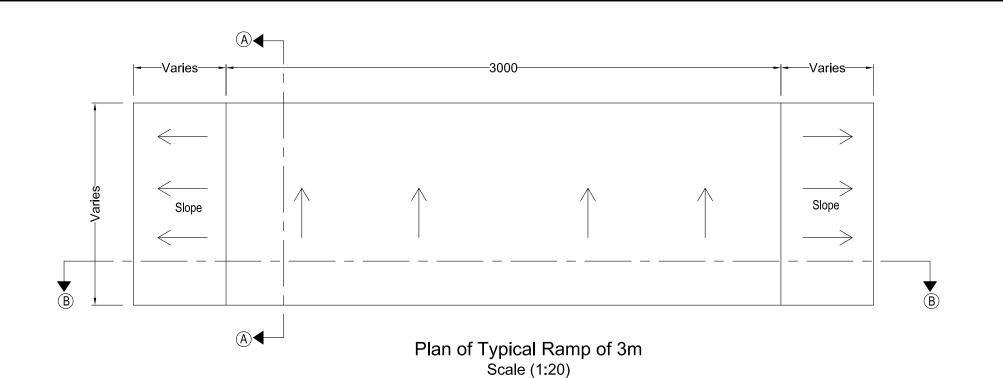Plan of Typical Ramp of 1m Scale (1:20)

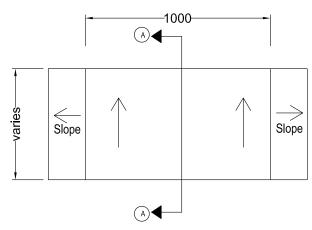

Section at B-B

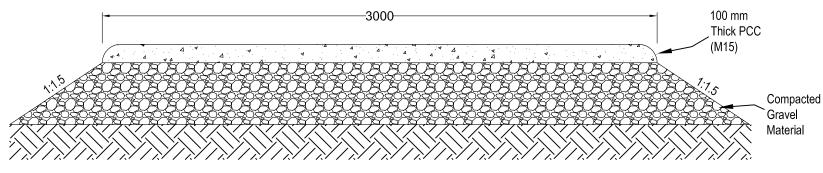Scale (1:20)



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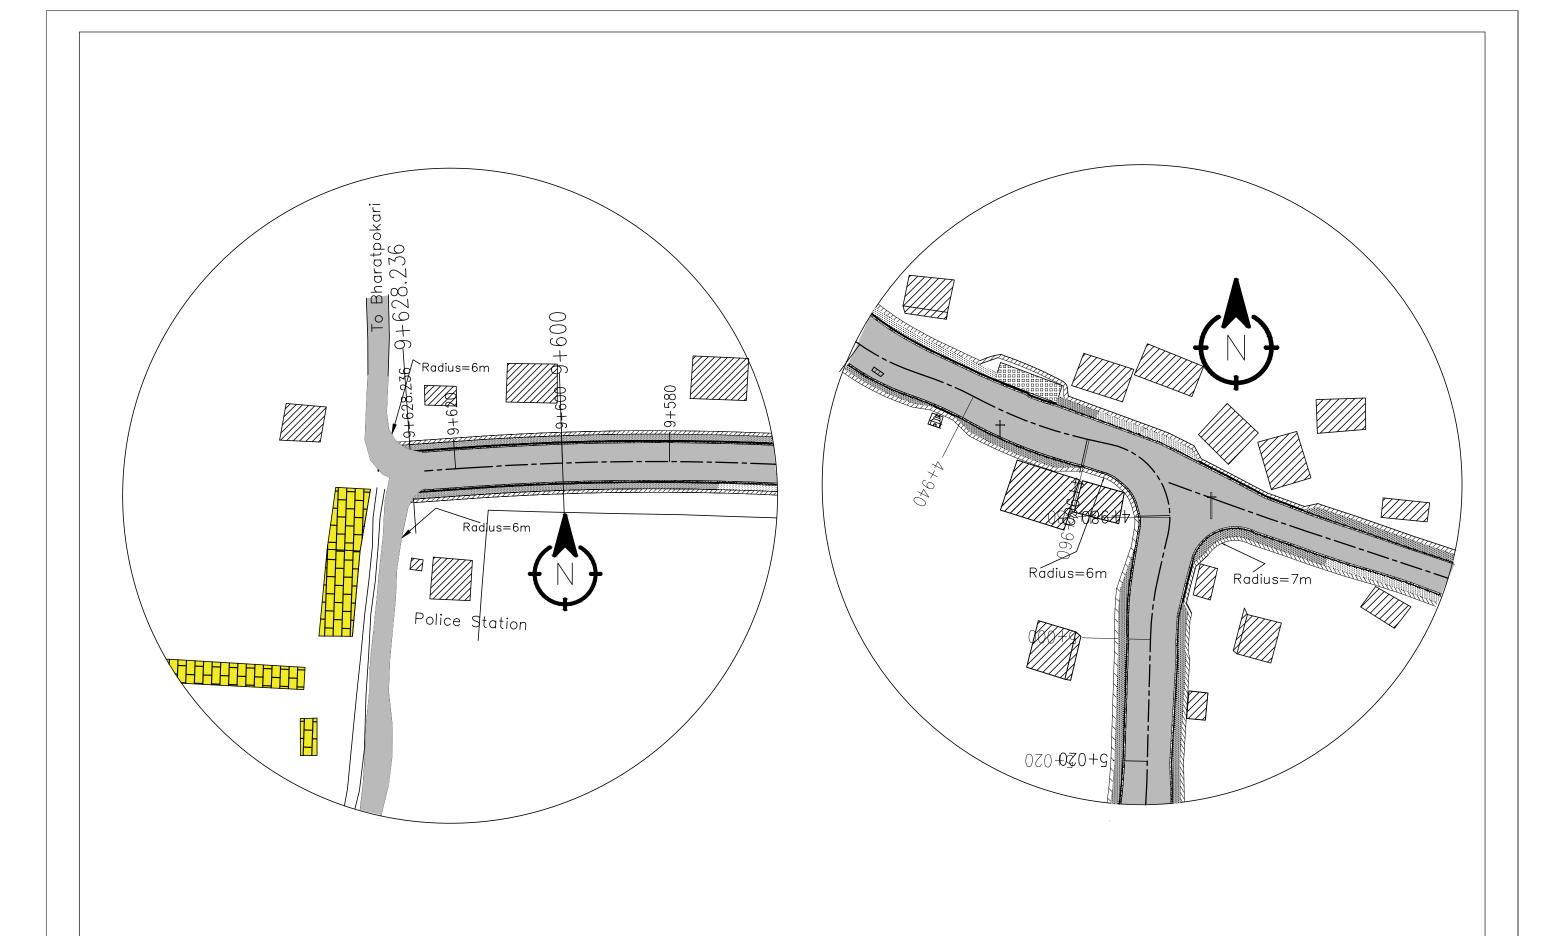


Project Name:- Nepal Urban Governance and Infrastructure Project (NUGIP)

Sheet Title:-

Ramp

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Kaski District,Gandaki Province

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B.N. Consultancy Pvt. Ltd. (BN)
Soil Test Consultancy (P.) Ltd. (Soil Test)
Kathmandu, Nepal



**Project Name:-** Nepal Urban Governance and Infrastructure Project (NUGIP)

SHEET TITLE:
Intersection


 DESIGNED BY:
 Date: 2023


 DRAWN BY:
 Scale: not in scale


 CHECKED BY:
 Chainage:

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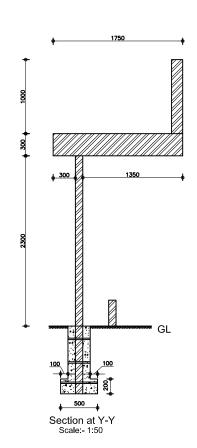





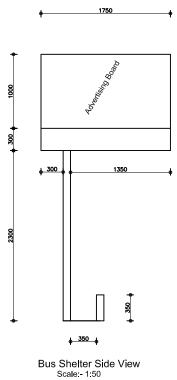

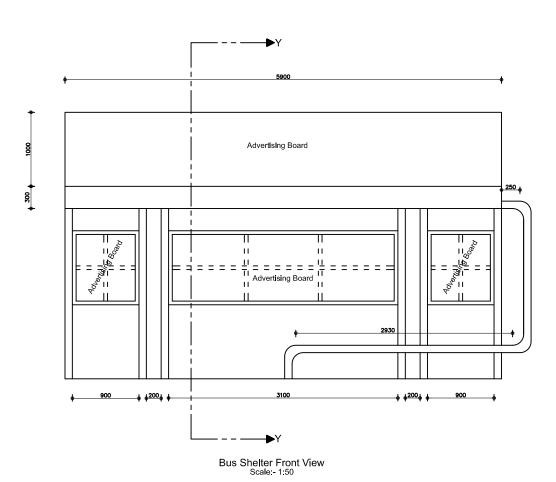

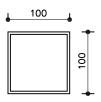Detail at A Hollow Square Pipe (Mild steel) Size:- 100\*100\*4 mm



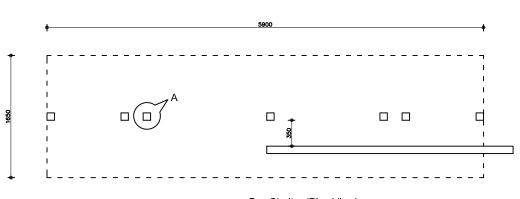

Bus Shelter (Plan View) Scale:- 1:50



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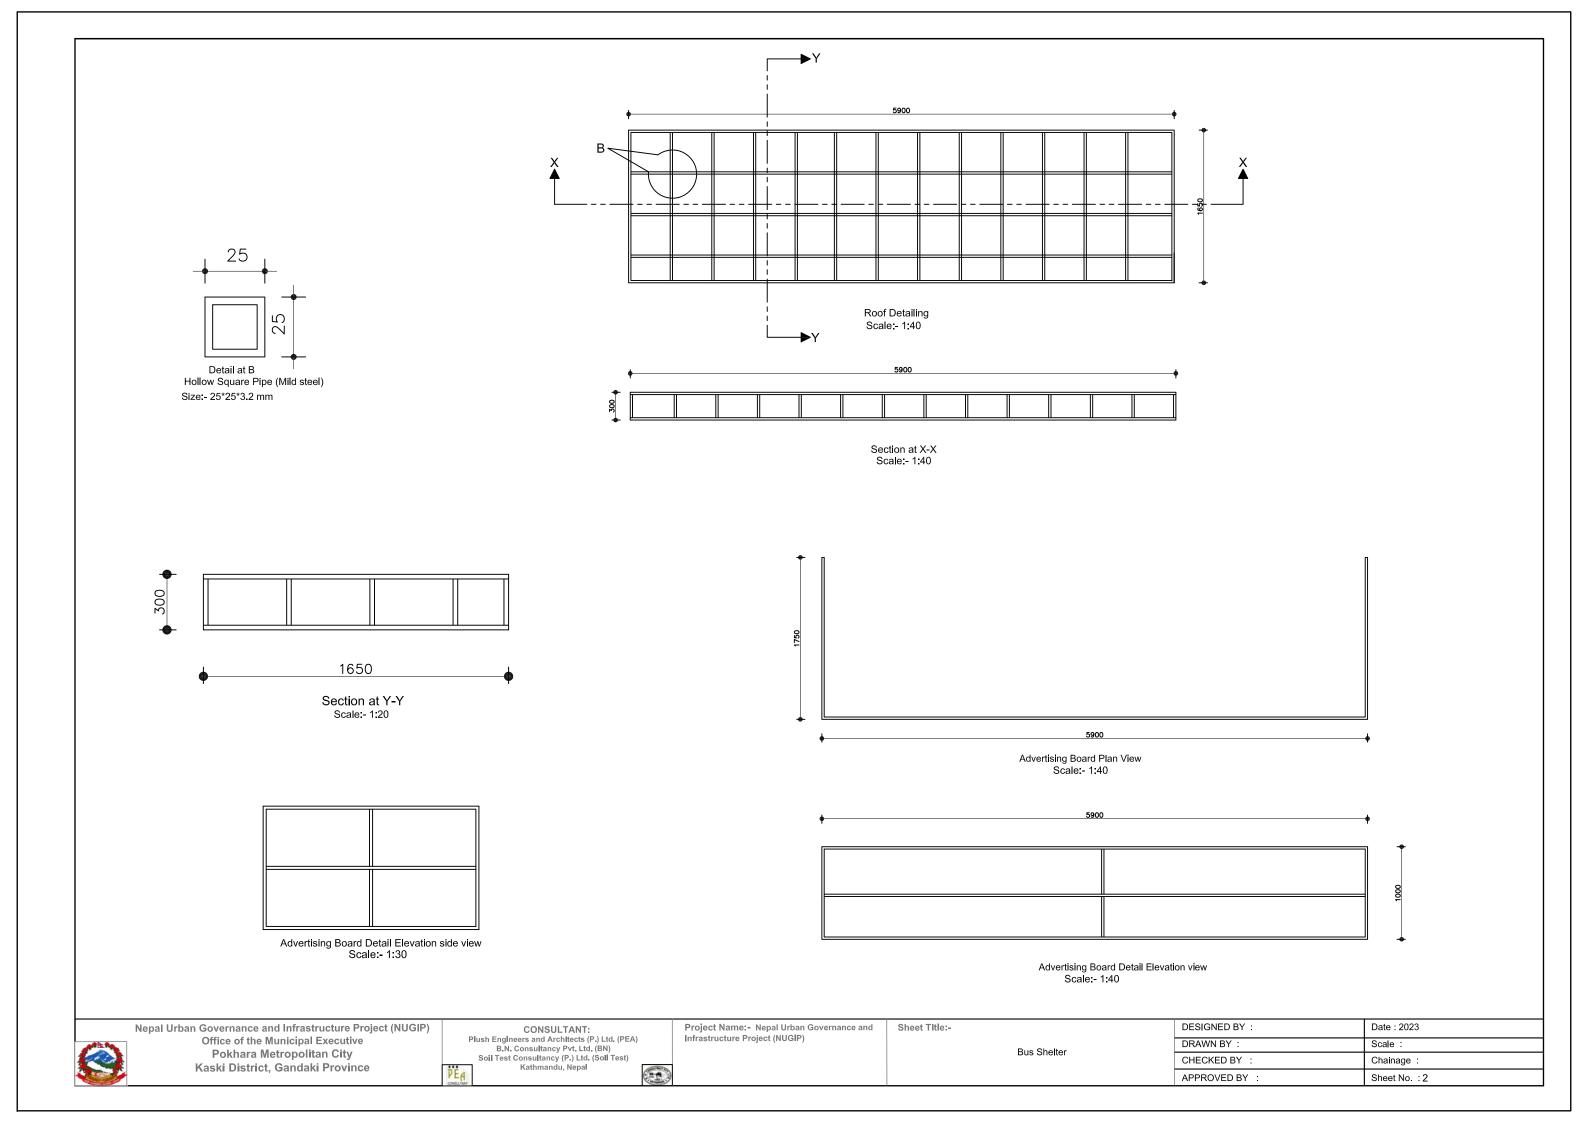



Project Name:- Nepal Urban Governance and Infrastructure Project (NUGIP)

Sheet Title:-

Bus Shelter

DESIGNED BY:	Date : 2023
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CHECKED BY :	Chainage:
APPROVED BY :	Sheet No.: 1



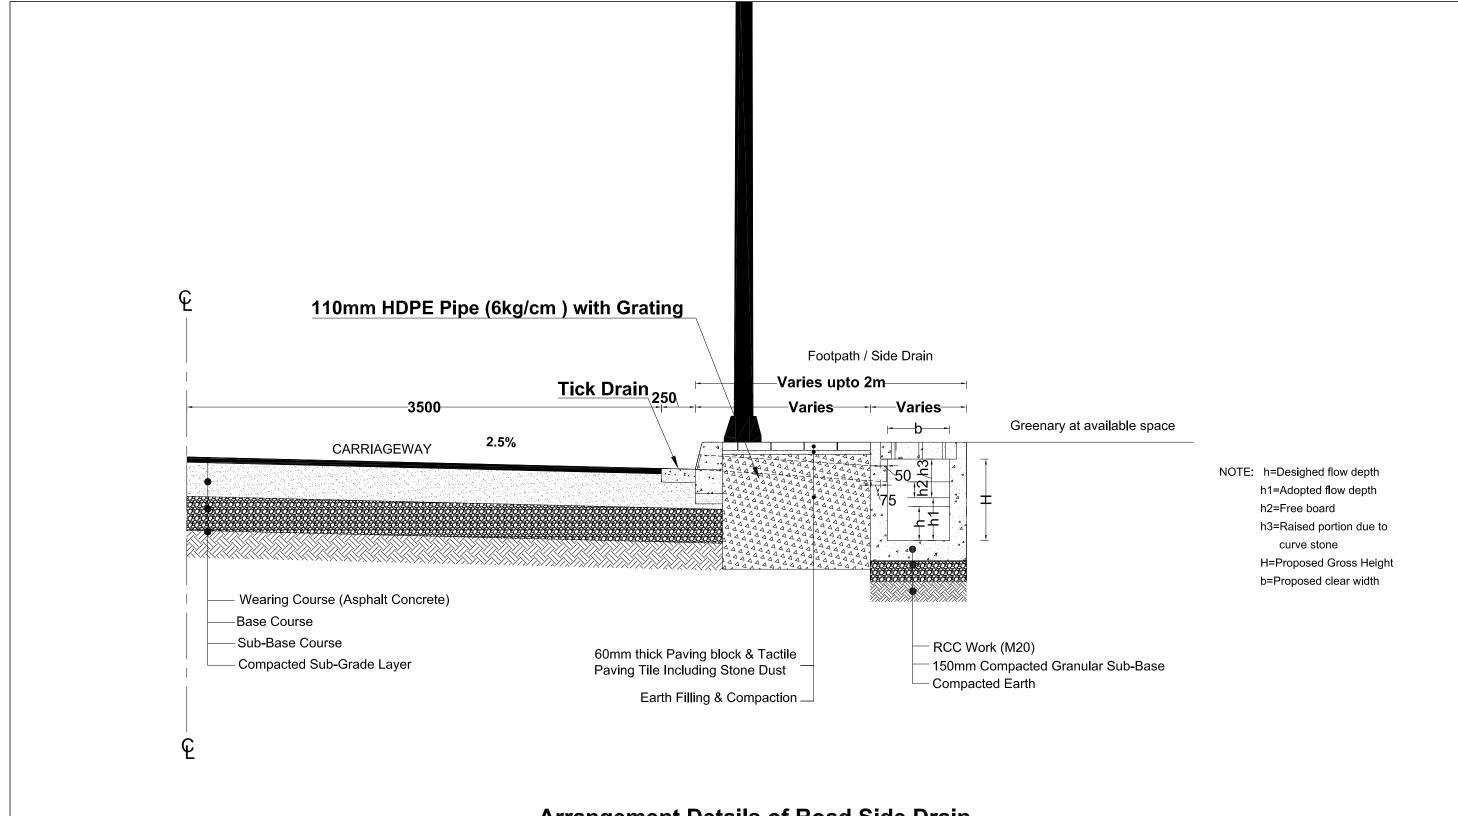

## **Arrangement Details of Road Side Drain**



CONSULTANT:
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B.N. Consultancy Pvt. Ltd. (BN)
Soil Test Consultancy (P.) Ltd. (Soil Test)
Kathmandu, Nepal

Project Infrastru

Project Name:- Nepal Urban Governance and Infrastructure Project (NUGIP)


Sheet Title:-


Arrangement Details of Road Side Drain 
 DESIGNED BY :
 Date : 2023


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 Scale :


 CHECKED BY :
 Chainage :

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 Sheet No. : 1

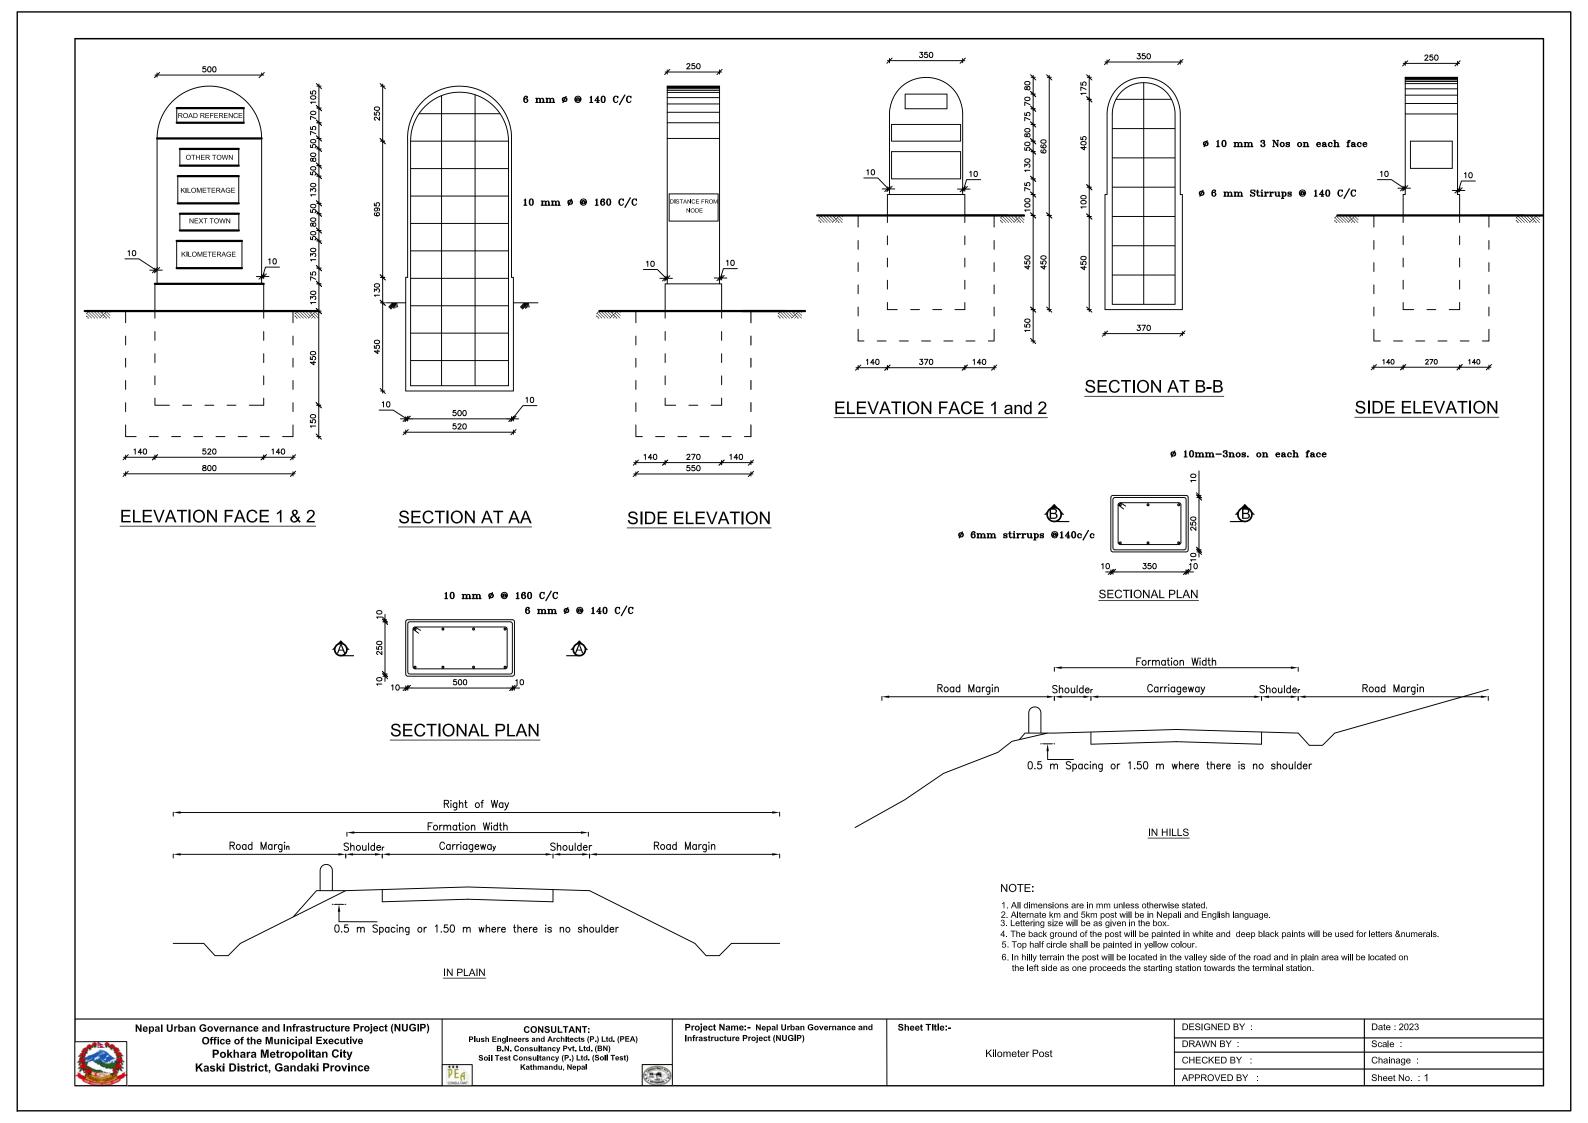

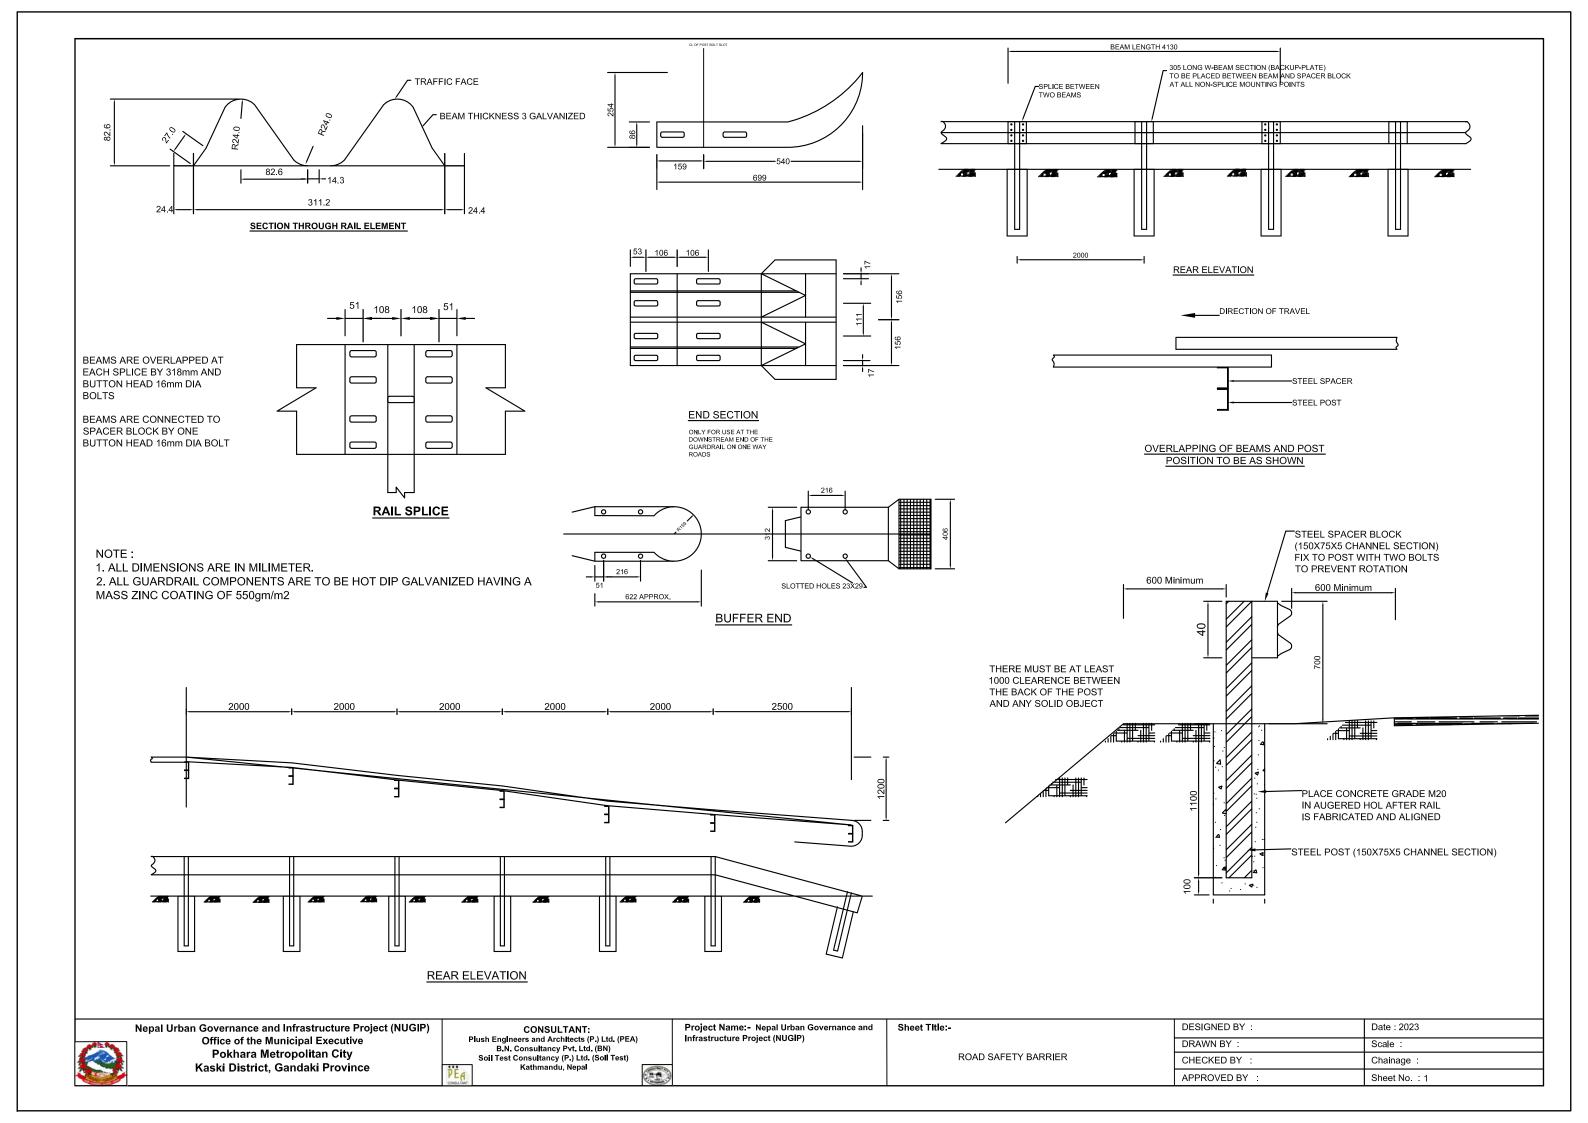


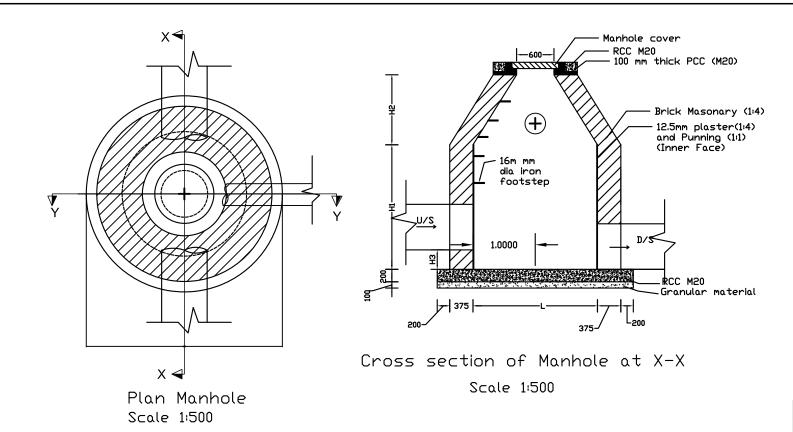


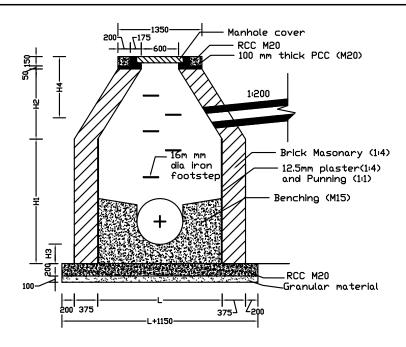


Cross section of Manhole Y-Y Scale 1:500

H1	H2	L	H3 and H4
H1<1.5m	0.5m	0.9m	Varies according to side condition
1.5m <h1<2m< td=""><td>0.5m</td><td>1.0m</td><td>Varies according to side condition</td></h1<2m<>	0.5m	1.0m	Varies according to side condition
2m <h1<3m< td=""><td>1.5m</td><td>1.1m</td><td>Varies according to side condition</td></h1<3m<>	1.5m	1.1m	Varies according to side condition

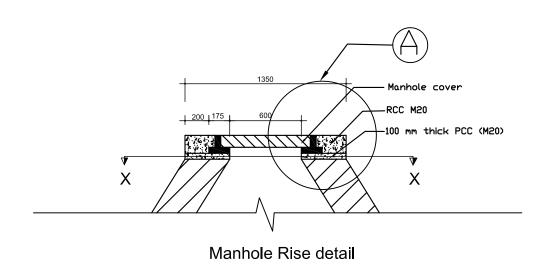

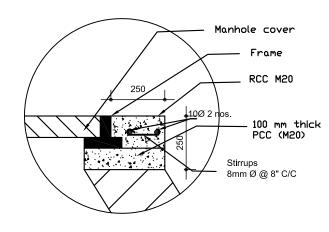

Reinforcement Detail at A

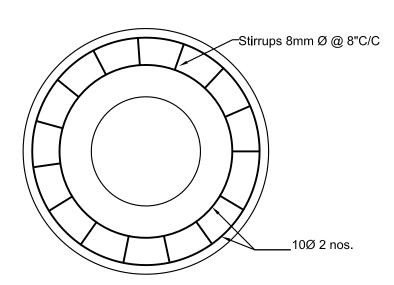

Reinforcement Detail at X-X



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Kaski District, Gandaki Province




Project Name:- Nepal Urban Governance and Infrastructure Project (NUGIP)

Sheet Title:-

Pipe For Disposal of Side Drain Water

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Kathmandu, Nepal

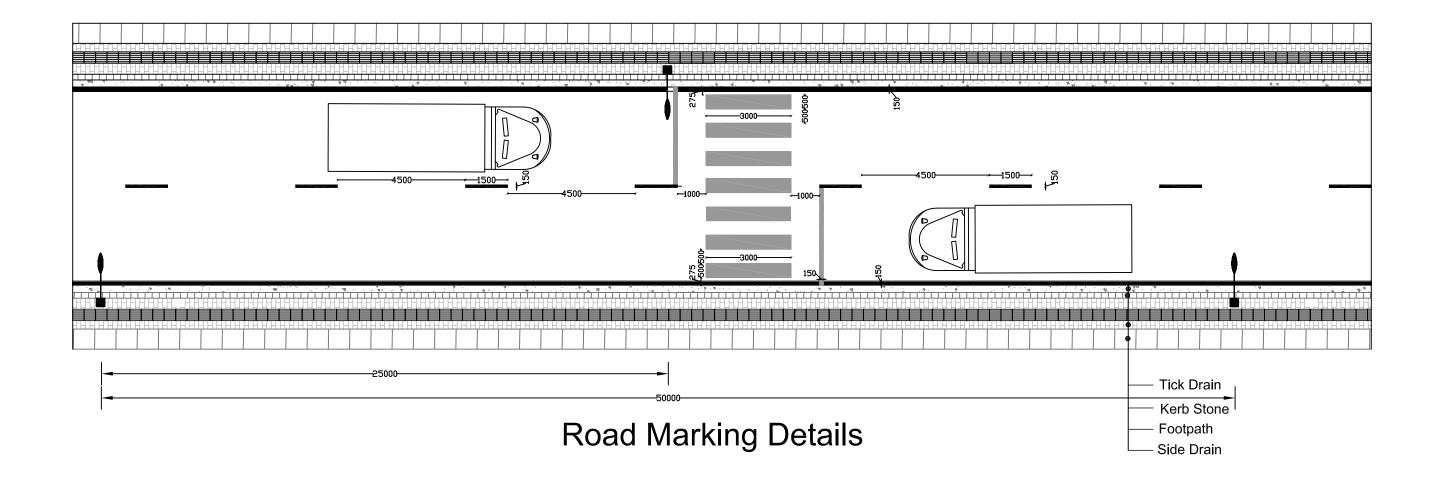

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CHECKED BY :	Chainage:
APPROVED BY :	Sheet No.: 1

# TRAFFIC SIGNS











170

No use of hom

GO





WARNING SIGNS













On approaches to junctions

On approaches to junctions alternative style



background

Temporary diversion signs - yellow







Along the carriageway



Along the edge of the carriageway



































₹ ₩









4









TRAFFIC LIGHT SIGNALS

For control of vehicles



The signal









#### For controlling pedestrian crossing movements













# **REGULATORY SIGNS**





A



No U-turns

























**DIRECTION SIGNS** 

Signs on national highways - green backgrounds

# INFORMATION SIGNS



1.

































### Traffic Engineering and Safety Unit, Department of Roads, 1997

२ कि.मी.को लागि For 2 km

बसहरु बाहेक Except buses

एकपंक्ति सवारी

Single track road

 $\rightarrow$ 

11111

SUPPLEMENTARY PLATES

Examples:

२०० मी. 200m

विद्यालय School

बाढीग्रस्त

Flooding


Nepal Urban Governance and Infrastructure Project (NUGIP) Office of the Municipal Executive Pokhara Metropolitan City Kaski District, Gandaki Province

CONSULTANT: Plush Engineers and Architects (P.) Ltd. (PEA) B.N. Consultancy Pvt. Ltd. (BN)

Project Name:-Nepal Urban Governance and Infrastructure Project (NUGIP)

SHEET TITLE: Standard Drawing of Traffic Sign

DESIGNED BY: Date: 2023 Scale: DRAWN BY: CHECKED BY: Sheet No: 1 APPROVED BY:

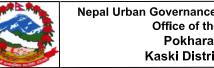






Normal height 2000


Dimensions: millimetres


Figure F2 Angle of sign Plate

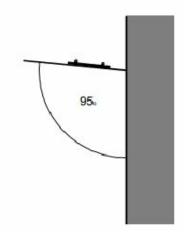


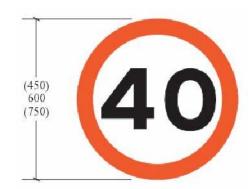


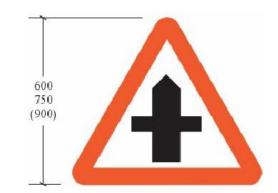


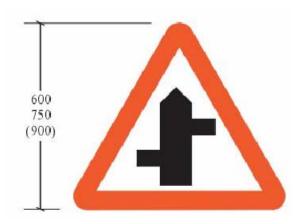


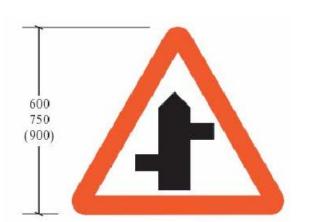

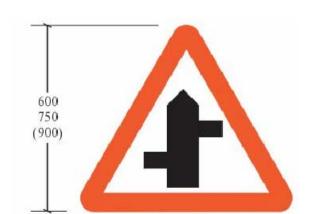

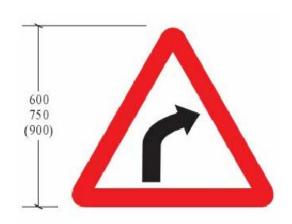

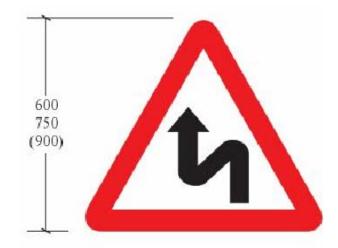

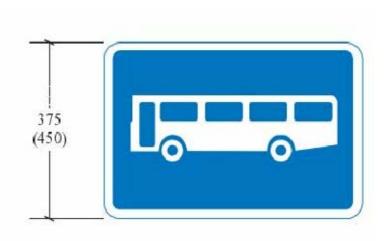




Nepal Urban Governance and Infrastructure Project (NUGIP)
Office of the Municipal Executive
Pokhara Metropolitan City
Kaski District, Gandaki Province


CONSULTANT:
Plush Engineers and Architects (P.) Ltd. (PEA)
B.N. Consultancy Pvt. Ltd. (BN)
Soil Test Consultancy (P.) Ltd. (Soil Test)
Kathmandu, Nepal

Project Name:-Nepal Urban Governance and Infrastructure Project (NUGIP)

SHEET TITLE: Standard Drawing of Traffic Sign

DESIGNED BY:	Date: 2023
DRAWN BY:	Scale:
CHECKED BY:	Chalnage:
APPROVED BY:	Sheet No: 2

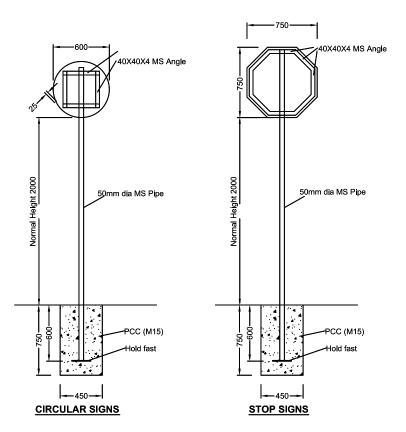

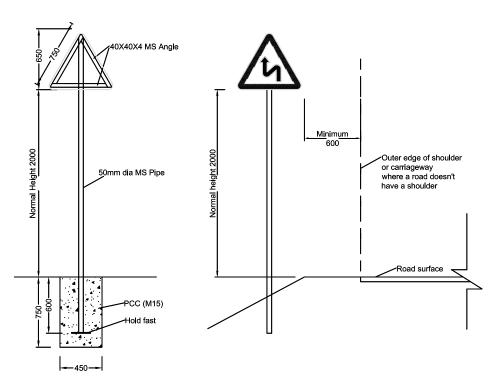















































































































































































**EQUILATERAL TRIANGULAR SIGNS** 

**SIGNS POSITIONING** 

Note: For the dimensions of board signs and letter, please refer Traffic Signs Manual Vol 1 & 2



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CONSULTANT:
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B.N. Consultancy Pvt. Ltd. (BN) Soil Test Consultancy (P.) Ltd. (Soil Test)


Kathmandu, Nepal


Project Name:-Nepal Urban Governance and Infrastructure Project (NUGIP)

SHEET TITLE:

Standard Drawing of Traffic Sign

DESIGNED BY: Date: 2023 Scale: DRAWN BY: CHECKED BY: Chalnage: Sheet No: 3 APPROVED BY:

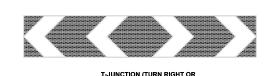

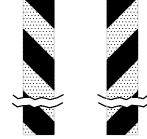





SHARP BEND (TEMPORARY DIVERSION)










DANGEROUS OBSTRUCTION DANGEROUS OBSTRUCTION





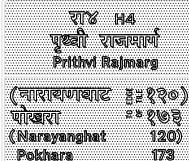

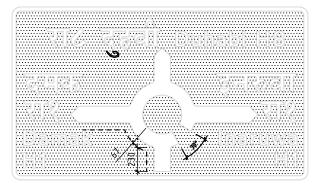

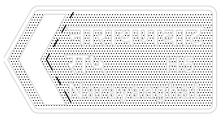





AT THE JUNCTION


ROUTE CONFIRMATION SIGN-AFTER JUNCTIONS

ON APPROACH TO JUNCTION

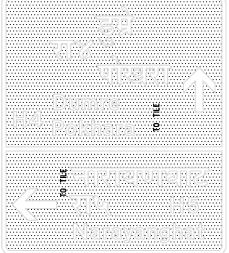

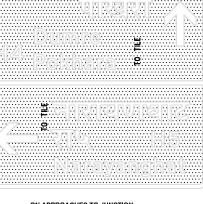



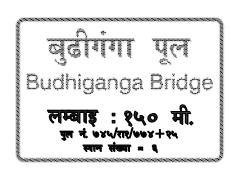





AT THE JUNCTION

BRIDGE NAME PLATE

Note: For the dimensions of board signs and letter, please refer Traffic Signs Manual Vol 1 & 2





SUPPLEMENTARY PLATES

DI SHELE TRACK BRIDGE



बाटो बन्द Road Closed

DIO ROAD CLOSED



प्रवेशको लागि बाहेक

Except for access















D26 EHD







SUPPLEMENTARY PLATES


SUPPLEMENTARY PLATES WHITE BLACK

SUPPLEMENTARY PLATES






Project Name:-Nepal Urban Governance and Infrastructure Project (NUGIP)

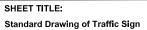


DESIGNED BY:	Date: 2023
DRAWN BY:	Scale:
CHECKED BY:	Chalnage:
APPROVED BY:	Sheet No: 4





Pokhara Metropolitan City Kaski District, Gandaki Province

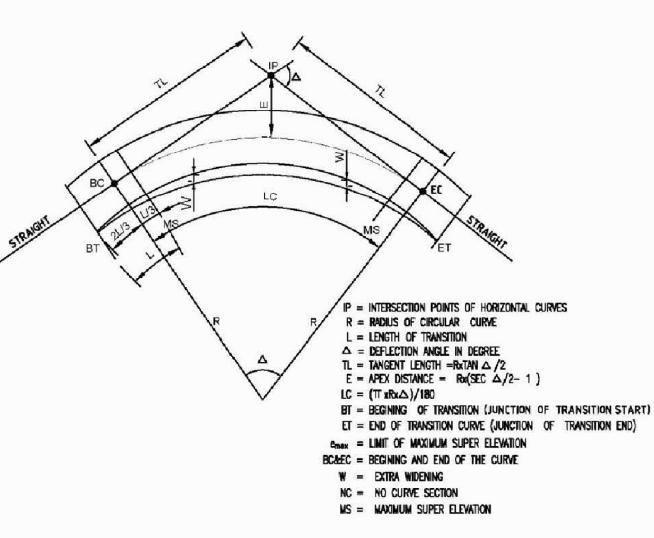

# **ELEMENTS OF HORIZONTAL CURVE**

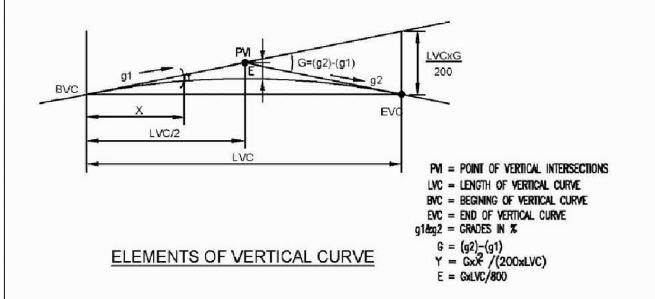

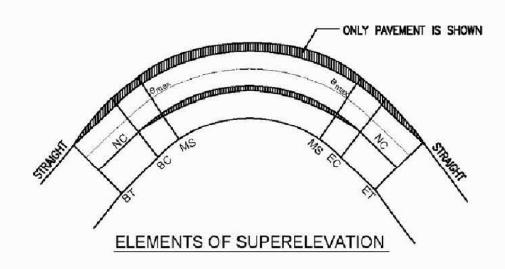

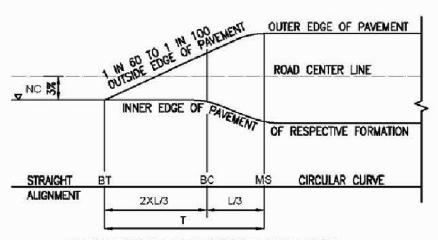

**ELEVATION OF SUPERELEVATION** 

T		1	e2-e1	)/100	X	RATE	OF	CHANGE	OF	SUPER	ELEVATION	×	RW/2
Wh	ere	,											
T = TRANSITION LENGTH IN METRE													
<b>e</b> 1	=		PRECE	DING :	SUP	ER E	EVA	TION IN	%				
e2	=	5	FOLLO	MING S	SUP	ERELE	VATI	ON IN 5					

SUPER ELEVATION (SE)

MIN. e = 3.0% = TO THE CAMBER SLOPE

MAX. e = 6.0%

RATE OF CHANGE OF SE = 1 IN 60 TO 1 IN 100




Nepal Urban Governance and Infrastructure Project (NUGIP)
Office of the Municipal Executive
Pokhara Metropolitan City
Kaski District, Gandaki Province


CONSULTANT:
Plush Engineers and Architects (P.) Ltd. (PEA)
B.N. Consultancy Pvt. Ltd. (BN)
Soil Test Consultancy (P.) Ltd. (Soil Test)
Kathmandu, Nepal


Project Name:-Nepal Urban Governance and Infrastructure Project

(NUGIP)

SHEET TITLE: Standard Drawing of Traffic Sign DESIGNED BY:
DRAWN BY:
Scale:
CHECKED BY:
Chalnage:
APPROVED BY:
Sheet No: 5

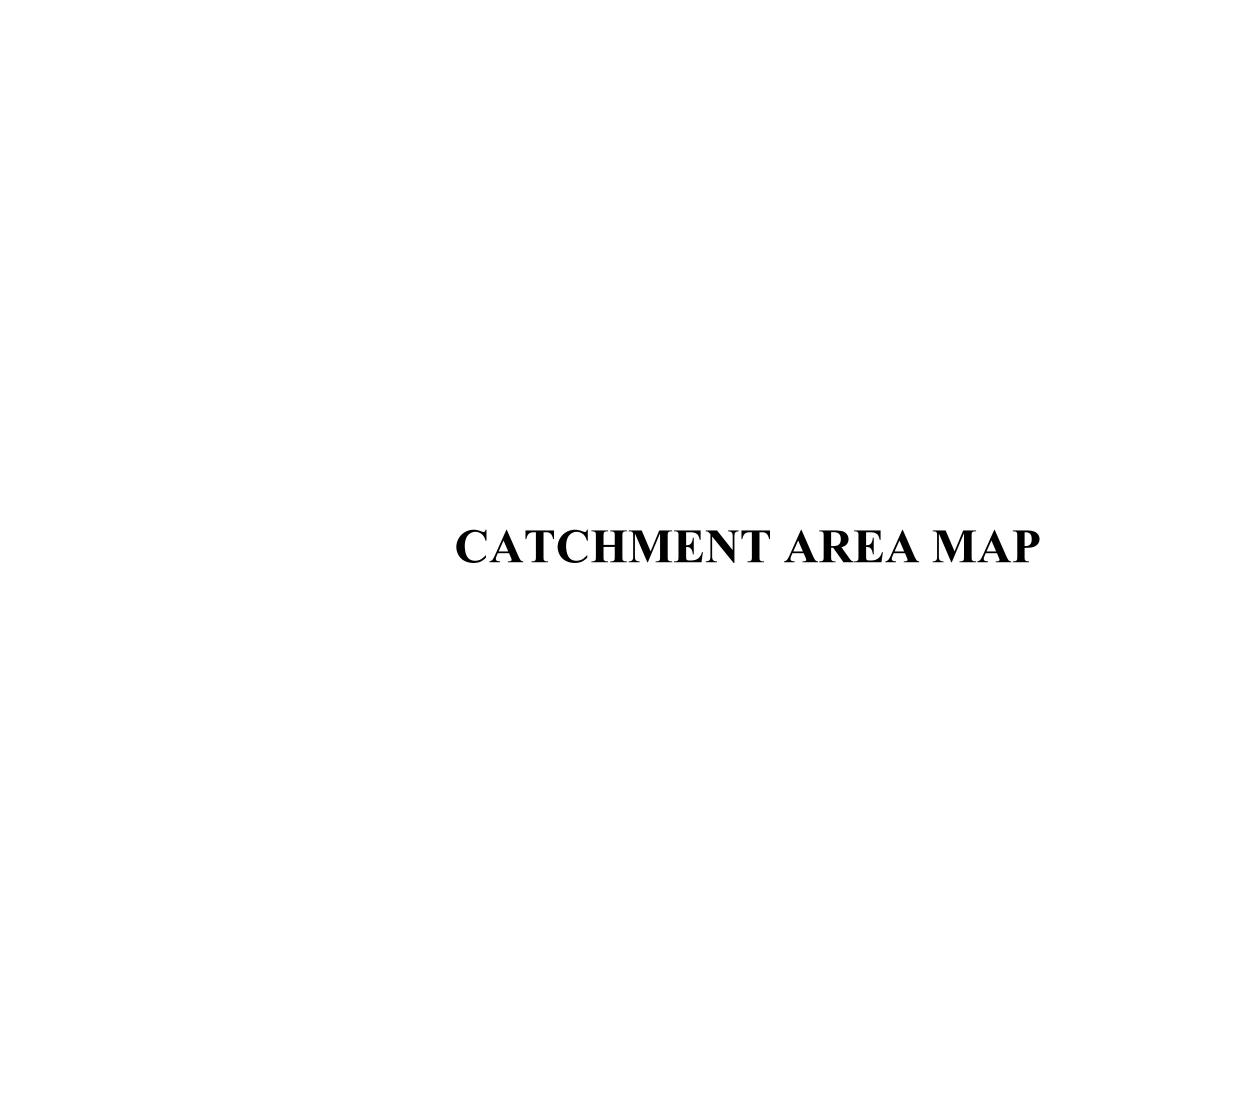

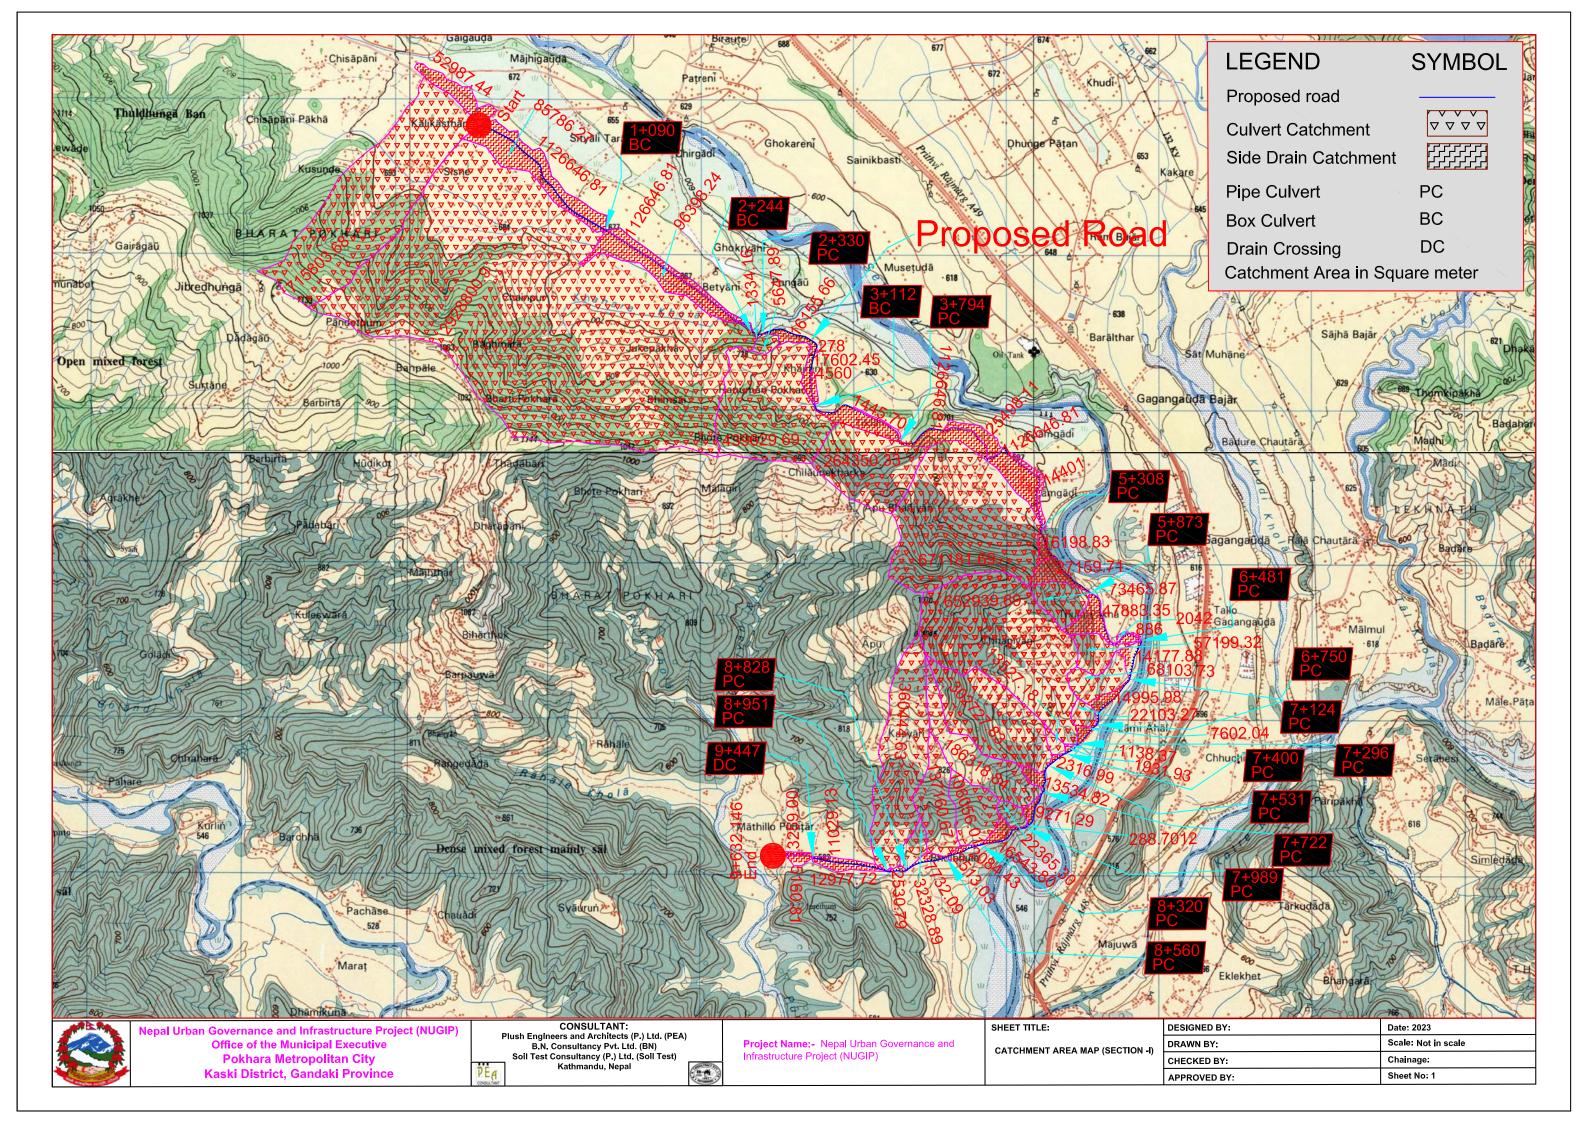

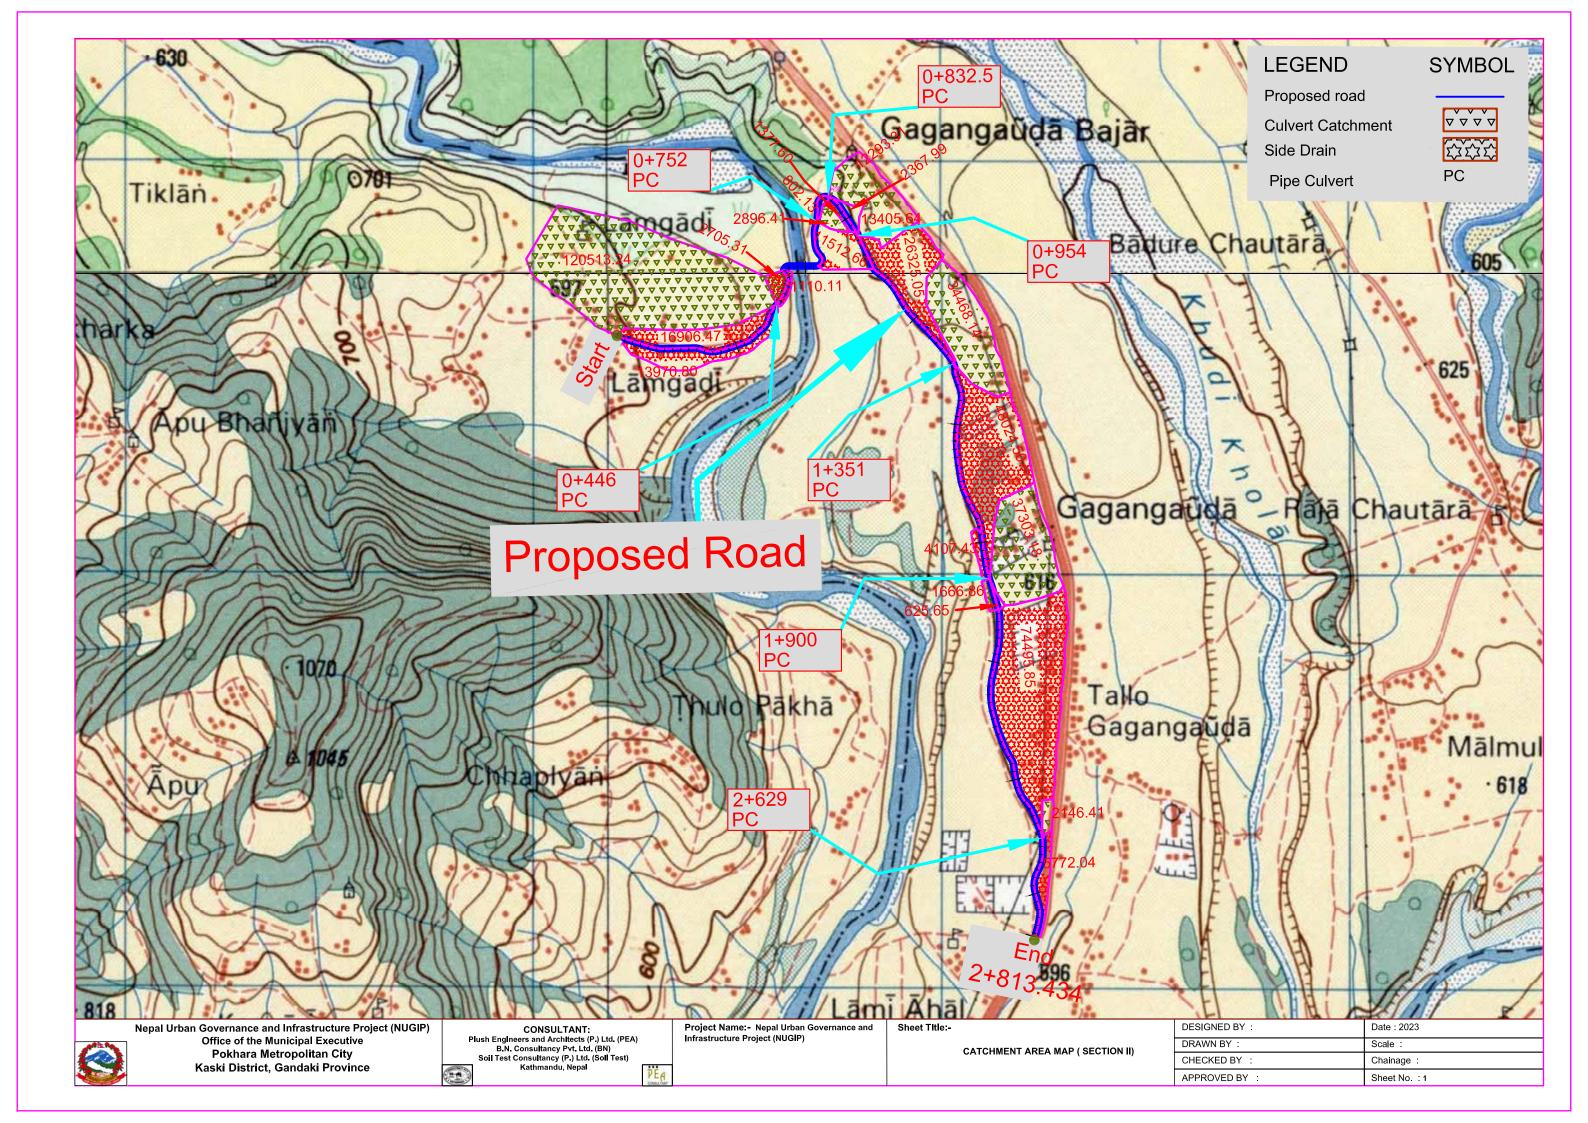



# DESCRIPTION CARD

Bench Mark No.: BM-1 Place Name: Kalikasthan


Municipality/Rural Municipality Name: Pokhara Metropolitan City- 33

District: Kaski

Station	Easting	Northing	Elevation	Remarks
BM-1	209814.401	3116642.935	691.920	Slab

# Reference Point

10.5 m rec	R1 = 9.50m Fence	R2 = 16.34m Tree	R3 = 17.75m HC
------------	------------------	------------------	----------------

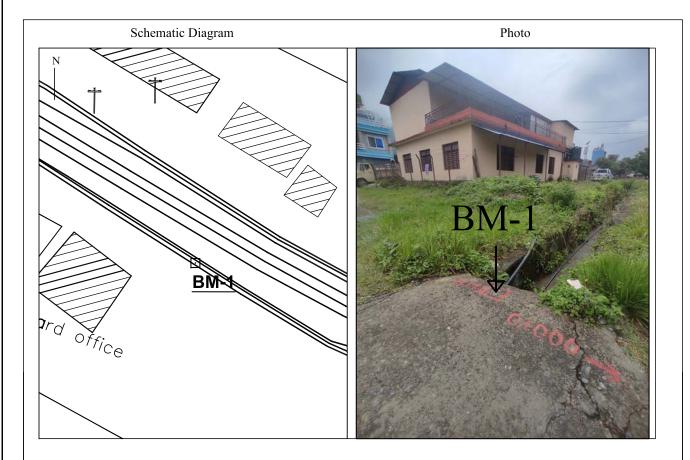

### **General Information**

This point is established at Kalikasthan near 33 no ward office of Pokhara Metropolitan City. The point is marked on the slab near drain by nail and painted with red enamel. The BM2 is visible from BM 1.

# **ROAD PROJECT**

### DESCRIPTION CARD

Bench Mark No.: BM-2 Place Name: Kalikasthan


Metropolitan Name: Pokhara Metropolitan City- 33

District: Kaski

Station	Easting	Northing	Elevation	Remarks
BM-2	209843.259	3116627.019	691.006	Concrete Pillar

#### Reference Point

R1 = 4.75m Stone	R2 = 13.20m Tree	R3 = 30.51m HC
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### General Information

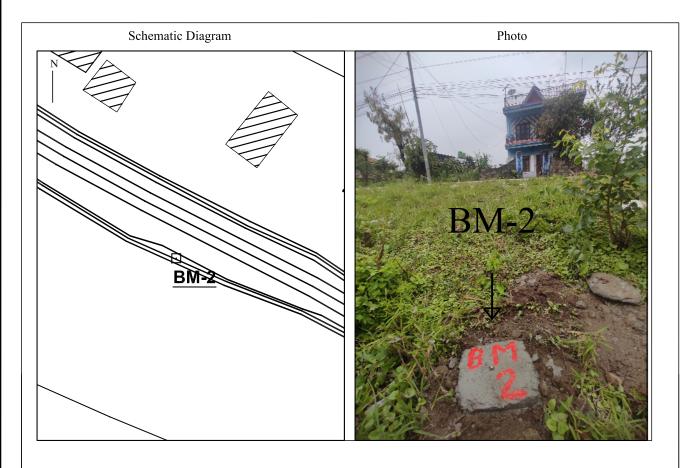
This point is established at Kalikasthan near 33 no ward office of Pokhara Metropolitan City. The point is marked on the concrete pillar on east side of BM1 at a distance about 50m. The BM1 is visible from BM 2.



Nepal Urban Governance and Infrastructure Project (NUGIP) Office of the Municipal Executive Pokhara Metropolitan City Kaski District, Gandaki Province



CONSULTANT: Plush Engineers and Architects (P.) Ltd. (PEA)
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SHEET TITLE: DESCRIPTION CARD OF BAGMARA SECTION I

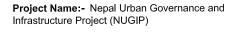DESIGNED BY:	Date: 2023
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APPROVED BY:	Sheet No: 1

# DESCRIPTION CARD

Bench Mark No.: BM-3 Place Name:Bareli Chowk


Metropolitan Name: Pokhara Metropolitan City- 33

District: Kaski

Station	Easting	Northing	Elevation	Remarks
BM-3	210434.958	3116035.234	678.563	Slab

### Reference Point

R1 = 3.25m EP	R2 = 6.45 m DT	R3 = 12.0m DT
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### **General Information**

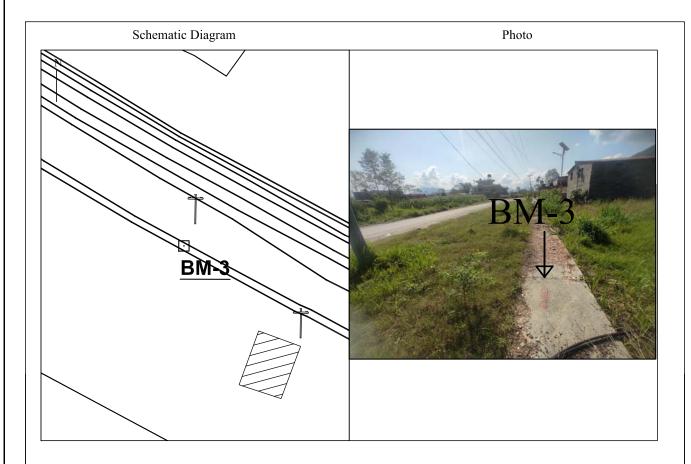This point is established at Bareli Chowk at front side of Keshar Acharya. The point is marked on the cover slab of drain by nail painted with red enamel. The BM4 is visible from BM 3.

# **ROAD PROJECT**

### DESCRIPTION CARD

Bench Mark No. : BM-4 Place Name:Bareli Chowk


Metropolitan Name: Pokhara Metropolitan City- 33

District: Kaski

Station	Easting	Northing	Elevation	Remarks
BM-4	210488.044	3116006.543	678.054	Slab

#### Reference Point

R1 = 1.80m EP	R2 = 10.0m HC	R3 = 9.40m HC
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### General Information

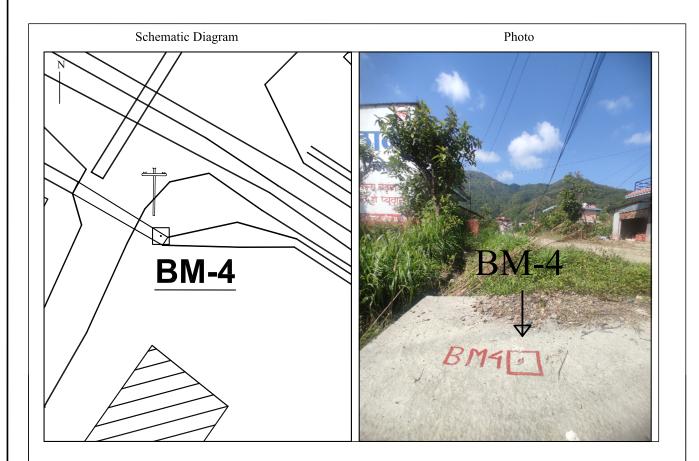This point is established at Bareli Chowk. The point is marked on the cover slab of drain by nail painted with red enamel. The BM 3 is visible from BM 4.



Nepal Urban Governance and Infrastructure Project (NUGIP)
Office of the Municipal Executive
Pokhara Metropolitan City
Kaski District, Gandaki Province



CONSULTANT:
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B.N. Consultancy Pvt. Ltd. (BN)
Soil Test Consultancy (P.) Ltd. (Soil Test)
Kathmandu Nenal



**Project Name:-** Nepal Urban Governance and Infrastructure Project (NUGIP)

DESCRIPTION CARD OF BAGMARA SECTION I

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 APPROVED BY:
 Sheet No: 2

# DESCRIPTION CARD

Bench Mark No. : BM-5 Place Name:Khahare Khola


Metropolitan Name: Pokhara Metropolitan City- 33

District: Kaski

Station	Easting	Northing	Elevation	Remarks
BM-5	211425.668	3115357.867	651.584	Bridge

### Reference Point

R1 =	3.30m Wall	R2 =	5.85m Bridge	R3 =	9.45m Bridge
	515 0H1 11 WH	1 1 1 2	Diodin Briage	1 10	

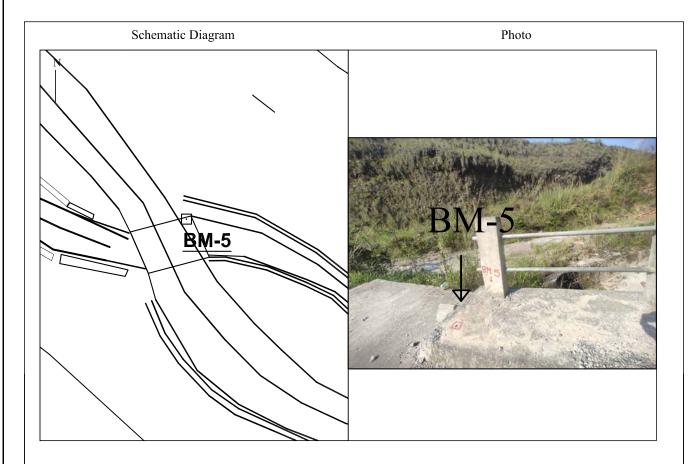

### **General Information**

This point is established at Bridge of Khahare Khola. The point is marked on the left side corner of the bridge by nail painted with red enamel. The BM6 is visible from BM 5.

# **ROAD PROJECT**

### DESCRIPTION CARD

Bench Mark No. : BM-6 Place Name:Khahare Khola


Metropolitan Name: Pokhara Metropolitan City- 33

District: Kaski

Station	Easting	Northing	Elevation	Remarks
BM-6	211460.477	3115321.960	647.829	Slab

#### Reference Point

R1 =	6.70m Wall	R2 =	3.30m Wall	R3 =	2.10 Wall
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# General Information

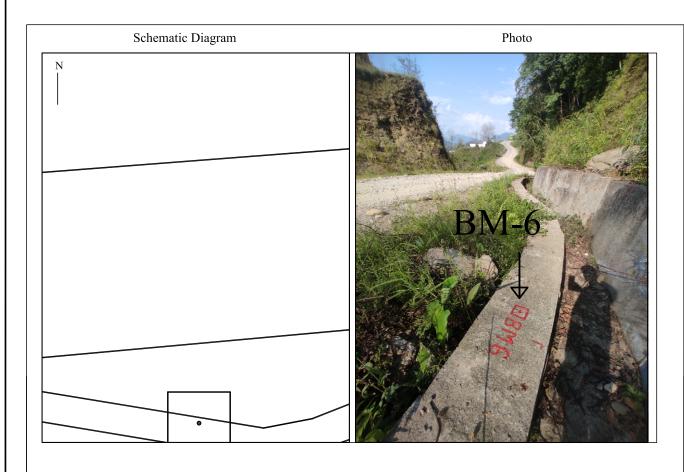This point is established at Khahare Khola. The point is marked on the right side of drain nearby Khola by nail painted with red enamel. The BM5 is visible from BM 6



Nepal Urban Governance and Infrastructure Project (NUGIP)
Office of the Municipal Executive
Pokhara Metropolitan City
Kaski District, Gandaki Province



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Kathmandu, Nepal



**Project Name:-** Nepal Urban Governance and Infrastructure Project (NUGIP)

SHEET TITLE:

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APPROVED BY:	Sheet No: 3

# DESCRIPTION CARD

Bench Mark No. : BM-7 Place Name:Khaireni Kholsi


Metropolitan Name: Pokhara Metropolitan City- 33

District: Kaski

Station	Easting	Northing	Elevation	Remarks
BM-7	211829.701	3114851.910	655.792	Concrete Pillar

### Reference Point

R1 =	5.0m Wall	R2 =	11.60m Tree	R3 =	10.80m Wall	

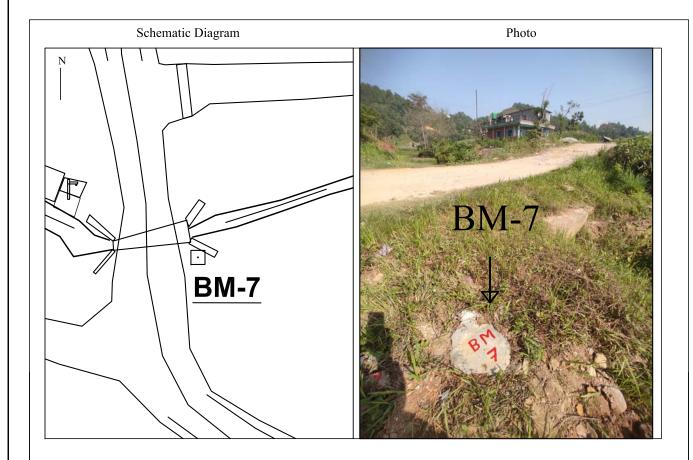

### **General Information**

This point is established at Khaireni Kholsi. The point is marked on the concrete pillar on right side of culvert. The BM8 is visible from BM 7.

# **ROAD PROJECT**

### DESCRIPTION CARD

Bench Mark No. : BM-8 Place Name:Khaireni


Metropolitan Name: Pokhara Metropolitan City- 33

District: Kaski

Station	Easting	Northing	Elevation	Remarks
BM-8	211968.528	3114805.225	662.296	Slab


#### Reference Point

R1 = 10.40m Wall	R2 = 6.90m HC	R3 = 3.20m Wall
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# General Information

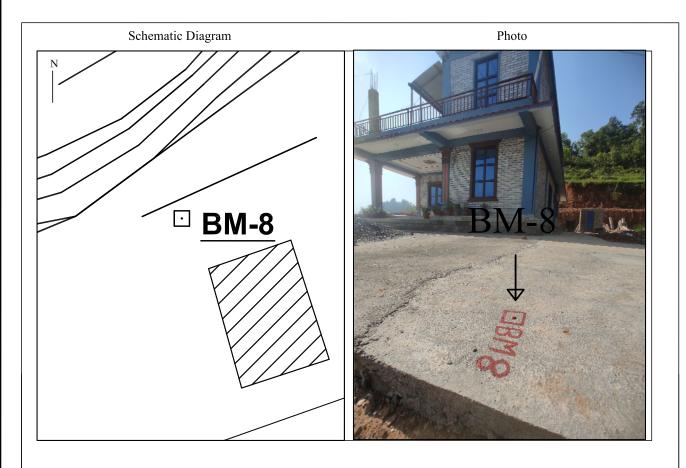This point is established at Khaireni. The point is marked on the concrete pillar on land of Sushil Malla. The BM7 is visible from BM 8.



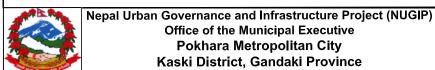

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# DESCRIPTION CARD

Bench Mark No.: BM-9 Place Name:Lamgadi Badarkot


Metropolitan Name: Pokhara Metropolitan City- 33

District: Kaski

Station	Easting	Northing	Elevation	Remarks
BM-9	212654.230	3114672.693	683.520	Concrete Pillar

### Reference Point

R1 = 16.0m Wall	R2 = 4.15m EP	R3 = 8.50m Tree
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### **General Information**

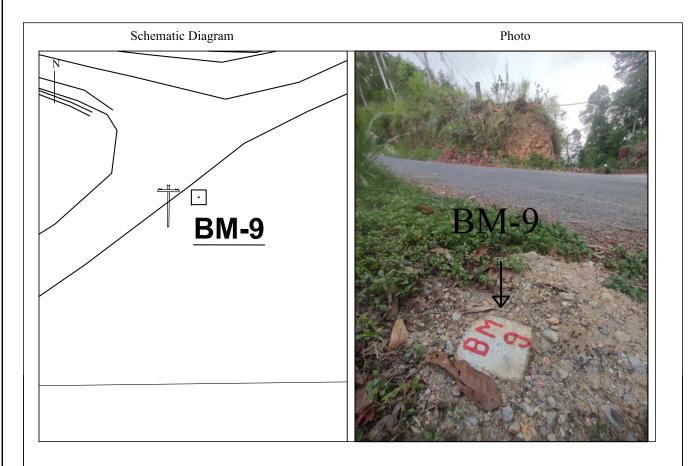This point is established at Lamgadi Badarkot Apubhanjyang. The point is marked on the land of Parbati Lamichhane.

# **ROAD PROJECT**

### DESCRIPTION CARD

Bench Mark No.: BM-10 Place Name:Lamgadi Badarkot


Metropolitan Name: Pokhara Metropolitan City- 33

District: Kaski

Station Coordinate	Easting	Northing	Elevation	Remarks
BM-10	212654.838	3114697.662	688.826	Concrete Pillar


#### Reference Point

R1 = 3.80m Tree R2 = 6.60m Tree	R3 = 9.70m Tree
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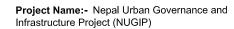

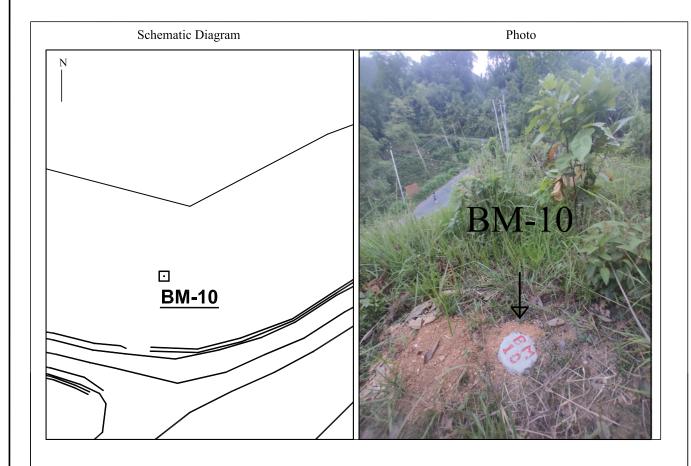
# General Information

This point is established at Lamgadi Badarkot. The point is marked on the land of Krishna Giri.

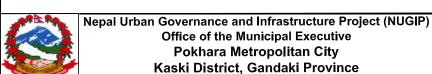

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# DESCRIPTION CARD

Bench Mark No. : BM-11 Place Name:Lamgadi


Metropolitan Name: Pokhara Metropolitan City- 33

District: Kaski

Station	Easting	Northing	Elevation	Remarks
BM-11	213245.164	3114261.778	604.951	Slab

### Reference Point

R1 = 4.10 m Wall $R2 = 4.10 m Wall$ $R3 = 10.0 m Tree$
--

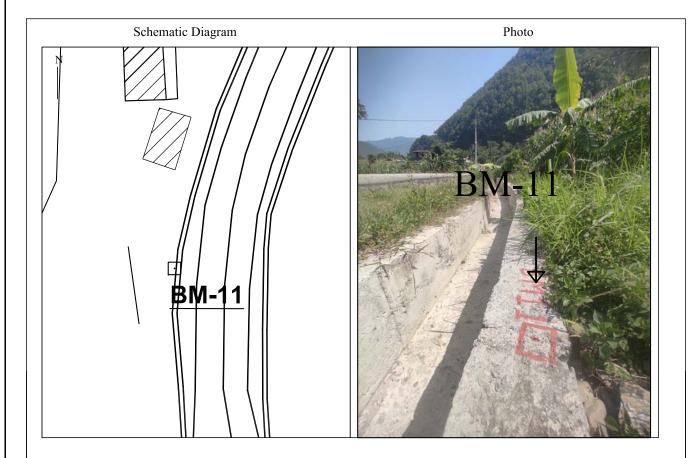

### **General Information**

This point is established at Lamgadi Badarkot. The point is marked on right side of the drain top near Fadar Maila land.

# **ROAD PROJECT**

### DESCRIPTION CARD

Bench Mark No. : BM-12 Place Name:Lamgadi


Metropolitan Name: Pokhara Metropolitan City- 33

District: Kaski

Station	Easting	Northing	Elevation	Remarks
BM-12	213256.654	3114231.336	603.831	Slab


#### Reference Point

R1 = 4.50m Wall R2 = 7.0m Wall	R3 = 9.10 EP
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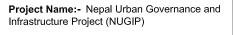
# General Information

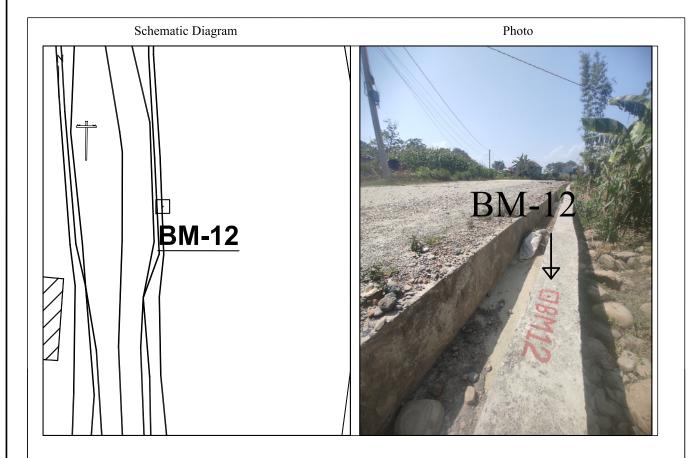This point is established at front side of Mamata Shrestha House. The point is marked on left side of road on top of drain.



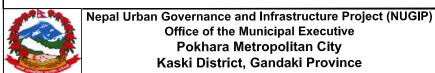

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SHEET TITLE:

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BAGMARA SECTION I

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# DESCRIPTION CARD


Bench Mark No.: BM-13 Place Name: Chyaplyang

Metropolitan Name: Pokhara Metropolitan City- 33

District: Kaski

Station	Easting	Northing	Elevation	Remarks
BM-13	213611.854	3113619.023	599.332	Boulder

### Reference Point

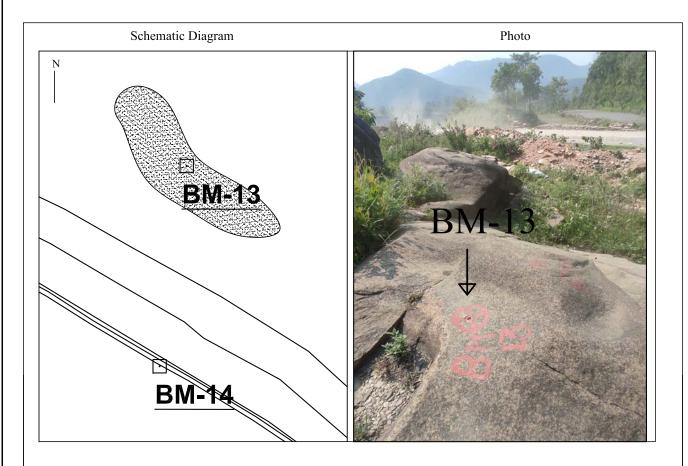

### General Information

This point is established at Chyaplyang right side of road carved on the big stone by nail.

# **ROAD PROJECT**

### DESCRIPTION CARD

Bench Mark No.: BM-14 Place Name: Chyaplyang


Metropolitan Name: Pokhara Metropolitan City- 33

District: Kaski

Station Coordinate	Easting	Northing	Elevation	Remarks
BM-14	213608.984	3113597.808	598.251	Slab

#### Reference Point

R1 = 12.0m Wall	R2 = 4.30m Wall	R3 = 19.0m Boulder
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# General Information

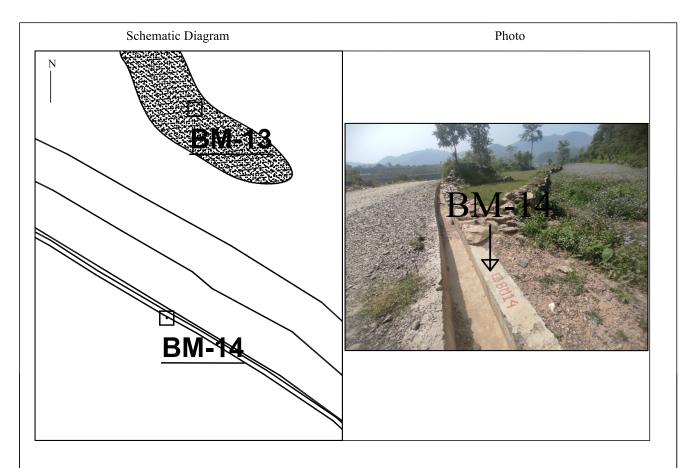
This point is established at Chaplyang near Jiban Prashad Pun land. The point is marked on the right side of road on drain top.



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Office of the Municipal Executive
Pokhara Metropolitan City
Kaski District, Gandaki Province



CONSULTANT:
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Soil Test Consultancy (P.) Ltd. (Soil Test)
Kathmandu. Nepal

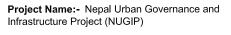

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# DESCRIPTION CARD

Bench Mark No. : BM-15 Place Name:Thula Khet


Metropolitan Name: Pokhara Metropolitan City- 33

District: Kaski

Station	Easting	Northing	Elevation	Remarks
BM-15	213482.388	3112607.861	539.700	Concrete Pillar

# Reference Point

R1 = 15.60m EP	R2 =	11.90m Boulder	R3 =	21.50m Gabin Wall
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### **General Information**

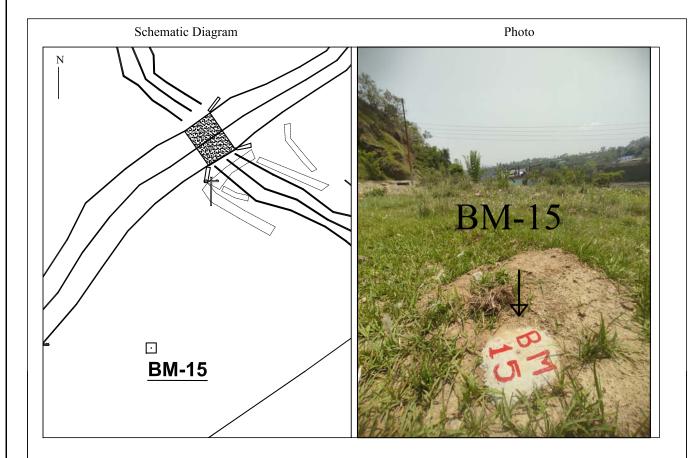This point is established at Thula Khet near Sansari Block Factory. The point is marked on a concrete pillar right side of Chalise Khola.

# **ROAD PROJECT**

### DESCRIPTION CARD

Bench Mark No. : BM-16 Place Name:Thula Khet


Metropolitan Name: Pokhara Metropolitan City- 33

District: Kaski

Station Coordinate	Easting	Northing	Elevation	Remarks
BM-16	213456.736	3112593.531	539.860	Concrete Pillar

#### Reference Point

R1 =	15.20m EP	R2 =	4.90m Boulder	R3 =	8.20m Boulder
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# General Information

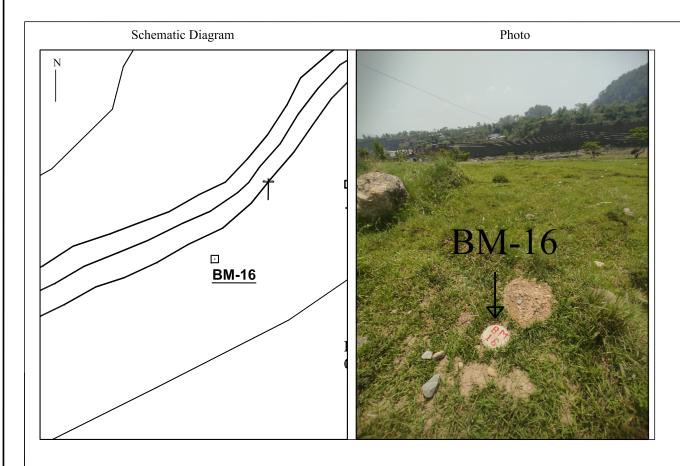
This point is established at land of Ram Bahadur Sahi. The point is marked on a concrete pillar near Chalise Khola.



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Office of the Municipal Executive
Pokhara Metropolitan City
Kaski District, Gandaki Province



CONSULTANT:
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Soil Test Consultancy (P.) Ltd. (Soil Test)
Kathmandu Nenal

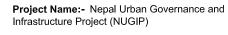

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# DESCRIPTION CARD

Bench Mark No.: BM-17 Place Name: Upallo Pudi


Metropolitan Name: Pokhara Metropolitan City- 33

District: Kaski

Station	Easting	Northing	Elevation	Remarks
BM-17	213012.191	3112015.272	600.573	Concrete Pillar

# Reference Point

R1 =	3.20m Tree	R2 =	10.60m Tree	R3 =	16.40m Boulder
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### **General Information**

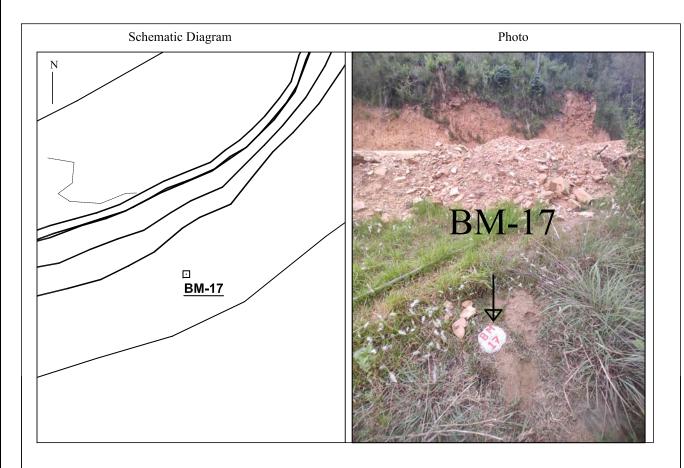This point is established above the Seti Khola Power House Tunnel place called Pudi on the left side of road land.

# **ROAD PROJECT**

### DESCRIPTION CARD

Bench Mark No.: BM-18 Place Name: Upallo Pudi


Metropolitan Name: Pokhara Metropolitan City- 33

District: Kaski

Station	Easting	Northing	Elevation	Remarks
BM-18	212971.875	3112001.192	600.032	Concrete Pillar

#### Reference Point

R1 = 7.40 m Tree	R2 = 4.60m Tree	R3 = 8.20m Tree
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# General Information

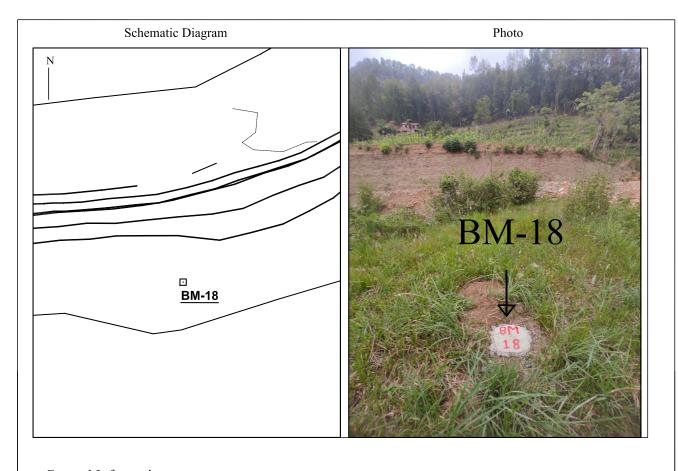This point is established above the Seti Khola Power House Tunnel place called Pudi on the left side of road land.



Nepal Urban Governance and Infrastructure Project (NUGIP) Office of the Municipal Executive Pokhara Metropolitan City Kaski District, Gandaki Province



CONSULTANT: Plush Engineers and Architects (P.) Ltd. (PEA)
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Project Name: - Nepal Urban Governance and Infrastructure Project (NUGIP)

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DESCRIPTION CARD OF BAGMARA SECTION I

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# DESCRIPTION CARD

Bench Mark No.: BM-19 Place Name: Upallo Pudi


Metropolitan Name: Pokhara Metropolitan City- 33

District: Kaski

Station	Easting	Northing	Elevation	Remarks
BM-19	212068.782	3111875.744	591.321	Slab

### Reference Point

R1 = 2.50m EP	
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### **General Information**

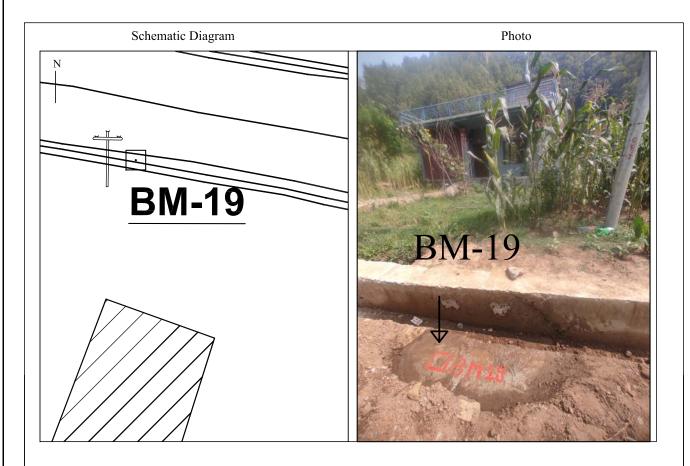This point is established at Upallo Pudi. The point is marked on the top of top drain.

# **ROAD PROJECT**

### DESCRIPTION CARD

Bench Mark No.: BM-20 Place Name: Upallo Pudi


Metropolitan Name: Pokhara Metropolitan City- 33

District: Kaski

Station	Easting	Northing	Elevation	Remarks
BM-20	212059.955	3111887.097	591.128	Slab

#### Reference Point

R1 = 2.40m Wall	R2 = 1.70m Tap	R3 = 4.0m Wall
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# General Information

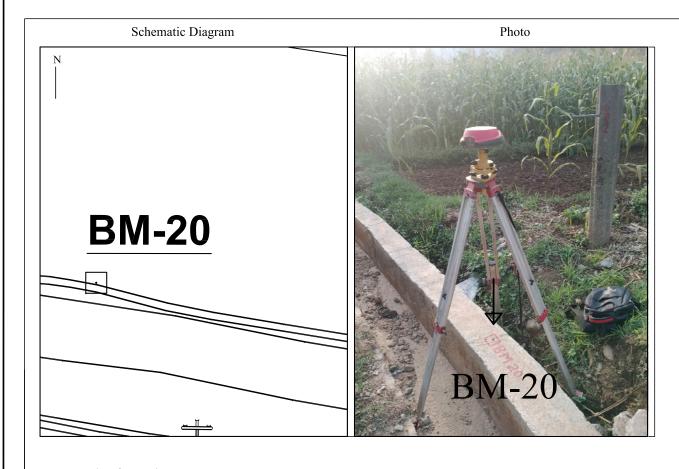This point is established at Upallo Pudi. The point is marked on the top of top drain.




Nepal Urban Governance and Infrastructure Project (NUGIP) Office of the Municipal Executive Pokhara Metropolitan City Kaski District, Gandaki Province



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CONSULTANT:

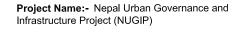

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# DESCRIPTION CARD

Bench Mark No. : BM-1 Place Name: Kalikasthan


Municipality/Rural Municipality Name: Pokhara Metropolitan City- 33

District: Kaski

Station	Easting	Northing	Elevation	Remarks
BM-1	213283.1172	3114367.67	606.3030	Concrete Pillar

### Reference Point

R1 = 4.635m Fence	R2 = 12.345 Fence	R3 = 17.75m HC
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### **General Information**

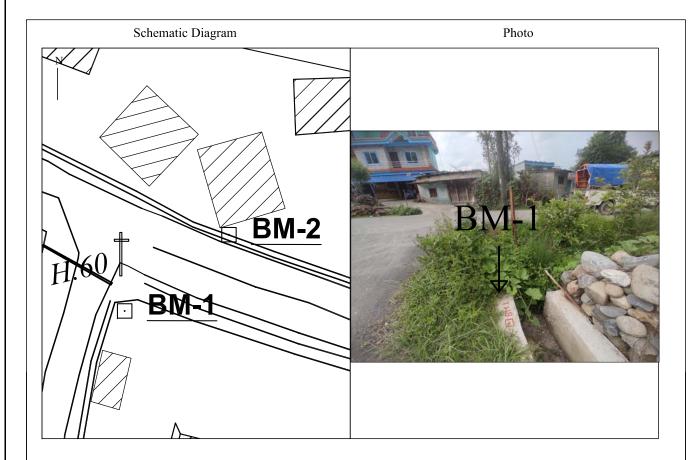This point is established at Kalikasthan near 33 no ward office of Pokhara Metropolitan City. The point is marked on the slab near drain by nail and painted with red enamel. The BM2 is visible from BM 1.

# **ROAD PROJECT**

### DESCRIPTION CARD

Bench Mark No. : BM-2 Place Name:Kalikasthan


Metropolitan Name: Pokhara Metropolitan City- 33

District: Kaski

Station Coordinate	Easting	Northing	Elevation	Remarks
BM-2	213290.9170	3114373.4850	605.8680	Concrete Pillar

#### Reference Point

R1 = 1.0932 Fence	R2 = 9.1650 Fence	R3 = 30.51m HC
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### General Information

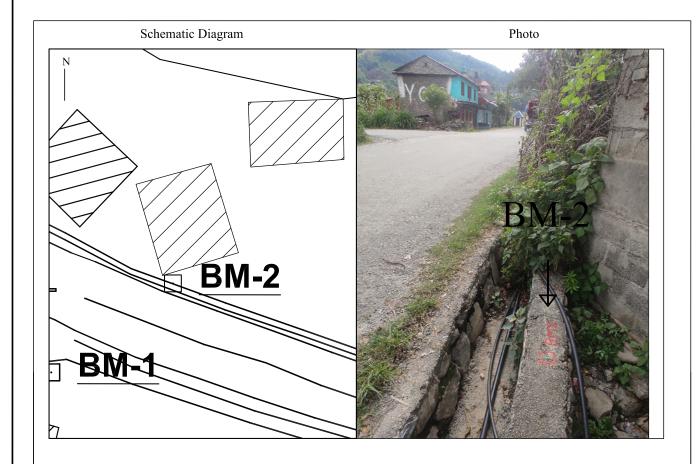
This point is established at Kalikasthan near 33 no ward office of Pokhara Metropolitan City. The point is marked on the concrete pillar on east side of BM1 The BM1 is visible from BM 2.



Nepal Urban Governance and Infrastructure Project (NUGIP)
Office of the Municipal Executive
Pokhara Metropolitan City
Kaski District, Gandaki Province



CONSULTANT:
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B.N. Consultancy Pvt. Ltd. (BN)
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Kathmandu. Neoal

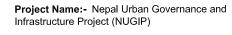

SHEET	TITLE:
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# DESCRIPTION CARD

Bench Mark No.: BM-3 Place Name:Block Chowk


Metropolitan Name: Pokhara Metropolitan City- 30

District: Kaski

Station	Easting	Northing	Elevation	Remarks
BM-3	214088.951	3114289.428	602.951	Concrete Pillar

### Reference Point

R1 = 3.50m Wall	R2 =	6.0m B Wall	R3 =	4.50m Boulder
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### **General Information**

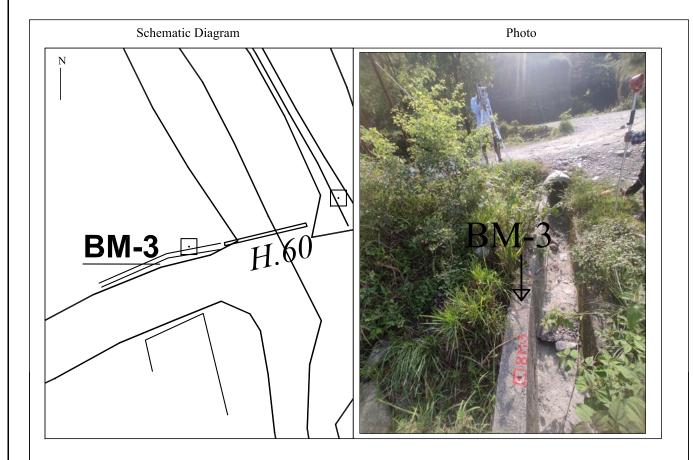This point is established at Gagangauda. The point is marked on the way to Kutre on the right side of road 250m North from Gyan Jyoti School on drain top.

# **ROAD PROJECT**

### DESCRIPTION CARD

Bench Mark No.: BM-4 Place Name:Block Chowk


Metropolitan Name: Pokhara Metropolitan City - 30

District: Kaski

Station Coordinate	Easting	Northing	Elevation	Remarks
BM-4	214102.260	3114293.751	604.031	Concrete Pillar

#### Reference Point

R1 = 6.70m Wall	R2 =	12.70m Boulder	R3 =	3.0m Pipe
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# General Information

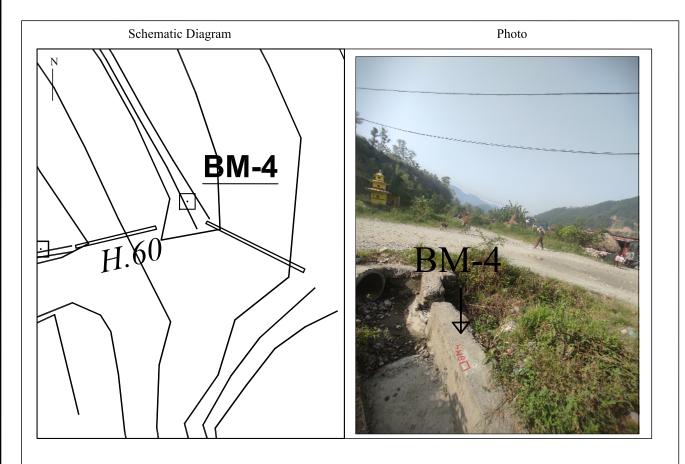
This point is established at Gagangauda. The point is marked on the way to Kutre on the left side of road 250m North from Gyan Jyoti School on drain top.



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CONSULTANT: Plush Engineers and Architects (P.) Ltd. (PEA)
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Soil Test Consultancy (P.) Ltd. (Soil Test)



SHEET TITLE: DESCRIPTION CARD OF BAGMARA SECTION II

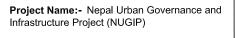	DESIGNED BY:	Date: 2023
Γ	DRAWN BY:	Scale: Not In Scale
ſ	CHECKED BY:	Chalnage:
ſ	APPROVED BY:	Sheet No: 2

# DESCRIPTION CARD

Bench Mark No.: BM-5 Place Name: Prithvi Highway


Metropolitan Name: Pokhara Metropolitan City- 30

District: Kaski

Station	Easting	Northing	Elevation	Remarks
BM-5	214262.148	3112879.643	597.563	Concrete Pillar

### Reference Point

R1 = 1.50m Boulder $R2 = 4.50$ m Boulder $R3 = 3.40$ m Boulder	R1 = 1.50m Boulder	K2		R3 =	
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### **General Information**

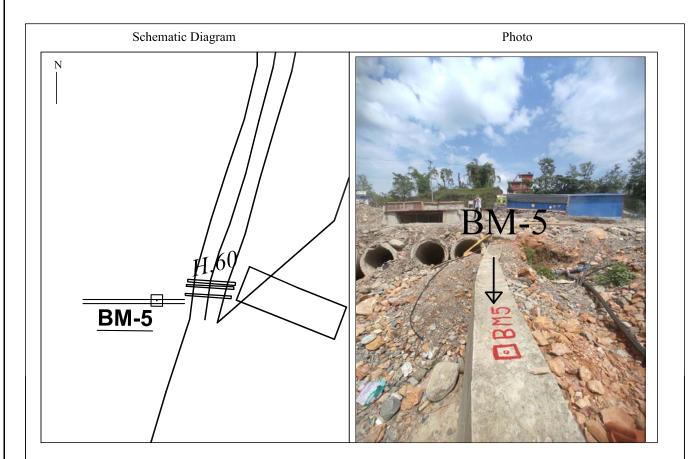This point is established at Tallo Gagangauda. The point is marked near on the junction of Prithvi Highway.

# **ROAD PROJECT**

### DESCRIPTION CARD


Bench Mark No.: BM-6 Place Name: Prithvi Highway

Metropolitan Name: Pokhara Metropolitan City - 30

District: Kaski

Station	Easting	Northing	Elevation	Remarks
BM-6	214251.082	3112860.484	596.734	Concrete Pillar

#### Reference Point

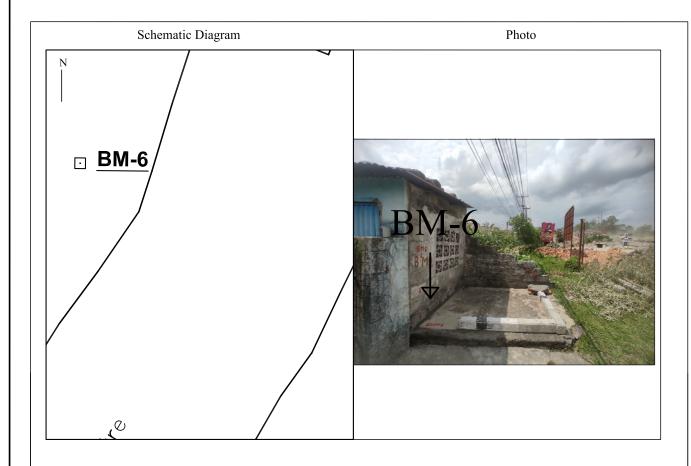

# General Information


This point is established at Tallo Gagangauda. The point is marked near by House and on the junction of Prithvi Highway.



Nepal Urban Governance and Infrastructure Project (NUGIP)
Office of the Municipal Executive
Pokhara Metropolitan City
Kaski District, Gandaki Province



CONSULTANT:
Plush Engineers and Architects (P.) Ltd. (PEA)
B.N. Consultancy Pvt. Ltd. (BN)
Soil Test Consultancy (P.) Ltd. (Soil Test)
Kathmandu. Nepal

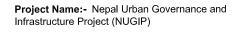

DESCRIPTION CARD OF

DESIGNED BY:	Date: 2023
DRAWN BY:	Scale: Not In Scale
CHECKED BY:	Chalnage:
APPROVED BY:	Sheet No: 3