Nepal Urban Governance and Infrastructure Project (NUGIP) Office of Municipal Executive Pokhara Metropolitan City Kaski District, Gandaki Province







DETAIL PROJECT REPORT

OF

UPGRADATION OF SISUWA- SISHAGHAT (SISUWA - KHUDHI KHOLA SECTION) ROAD

VOLUME – I	Main Report
VOLUME – II	Cost Estimate
VOLUME – III	Drawing
VOLUME – IV	Annex

October 2023 (Revised November 2023)


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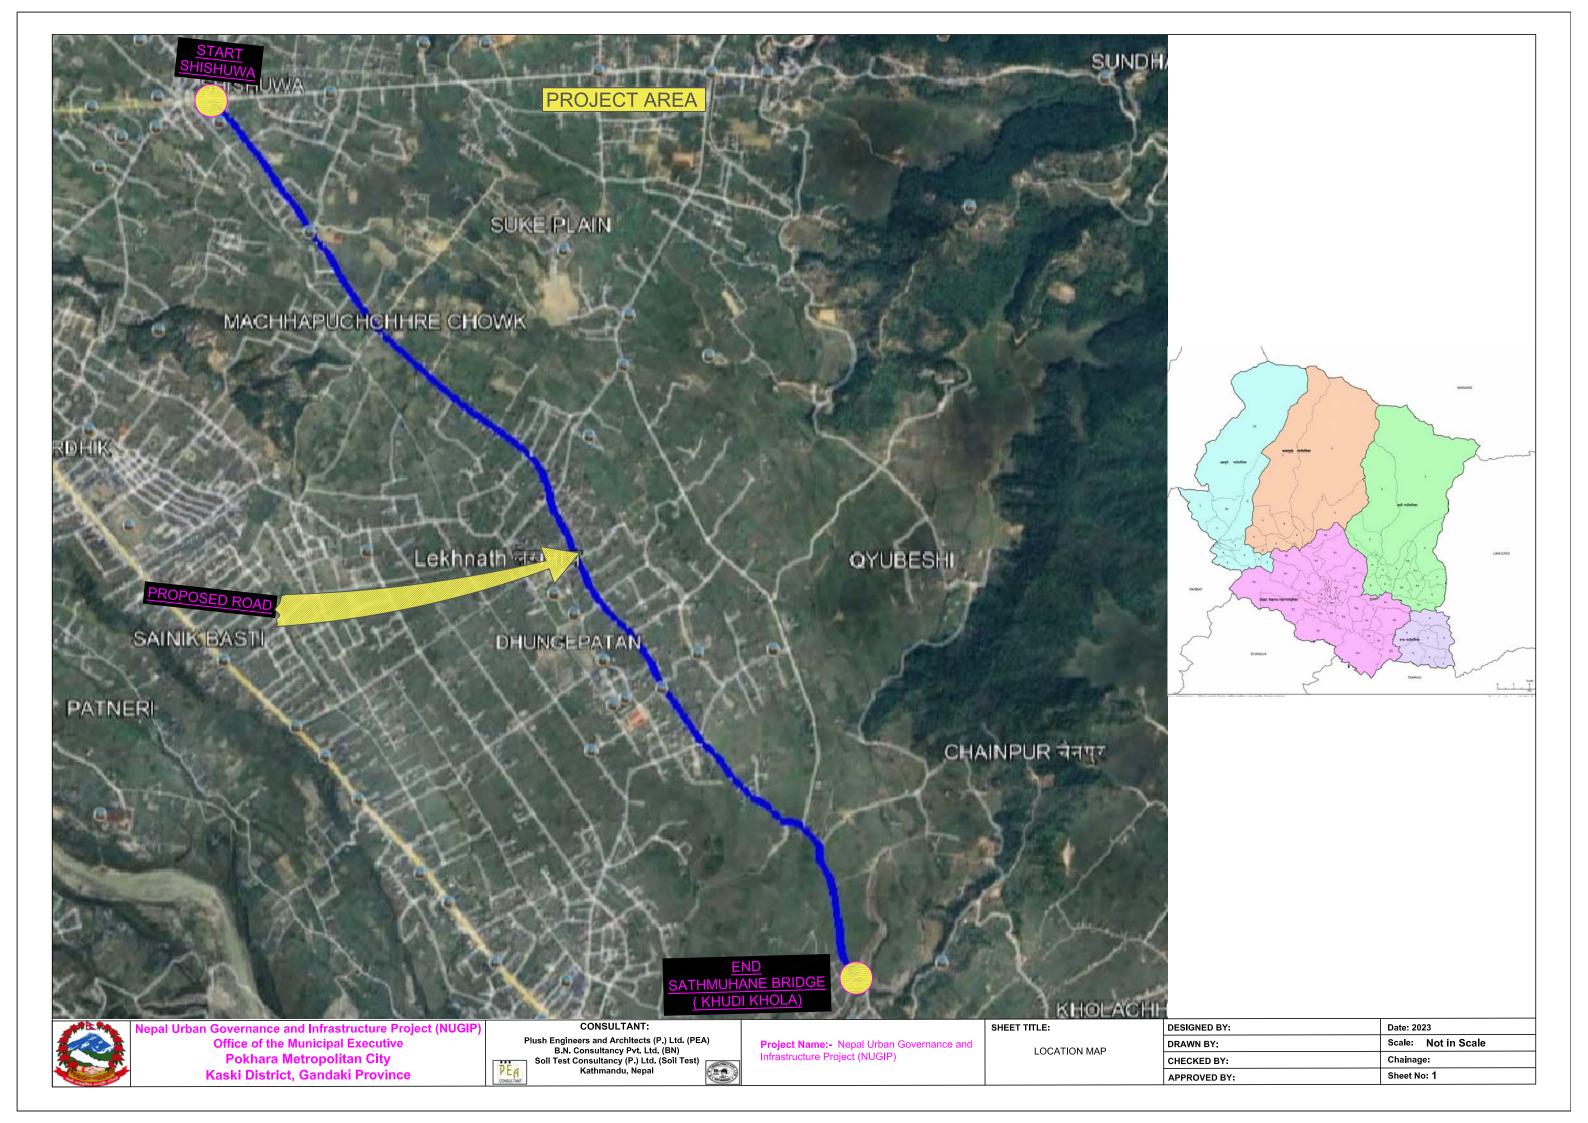
Plush Engineers and Architects (P.) Ltd. (PEA)
B.N. Consultancy Pvt. Ltd. (BN)
SOIL TEST (P.) Ltd.
(PEA-BN-Soil Test) JV Kathmandu, Nepal


Table of Content


S.No.	Content		Pages
1	Index Map & Location Map	Index Map	1
		Location Map	1
2	Proposed Typical Cross Section of Road		1 to 2
3	Proposed Plan & Profile		1 to 14
4	Detailed Cross Section At 20 m Interval		1 to 24
5	Side Drain Plan & Profile		1 to 14
6	Typical Drawings	Box Culvert	1 to 4
		Irrigation Crossing	1 to 16
		Typical side drain	1 to 3
		Typical Plan of Road	1
		Footpath Details	1
		Retaining wall	1
		Ramp	1
		Bus Shelter	1 to 2
		Arrangement Details of Road Side Drain	1
		Kilometer Post	1
		Road Safety Barrier	1
		Shed Details	1 to 6
		Intersection	1
		Irrigation Canal Gate	1
		Detail of End Chainage	1
7	Road Marking , Traffic Sign and Signal	Raod Marking Details	1
		Traffic Sign and Signal	1 to 5
8	Catchment Area Map		1
9	Description Card		1 to 14






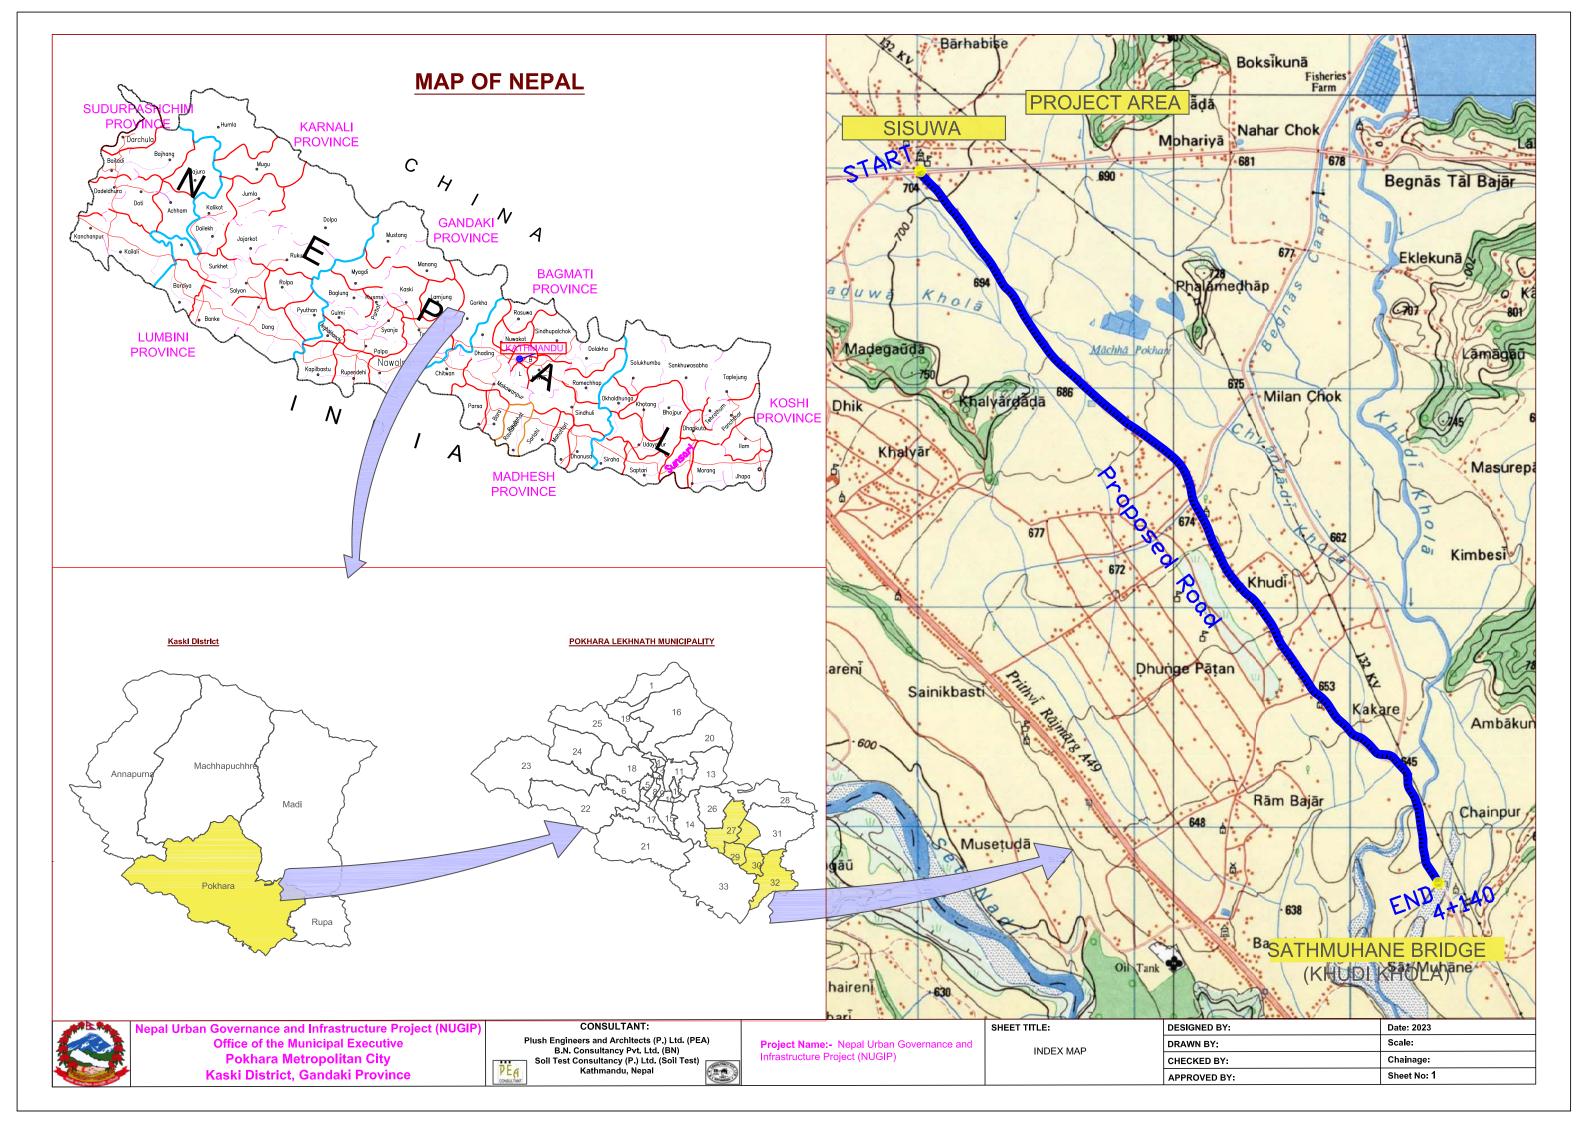

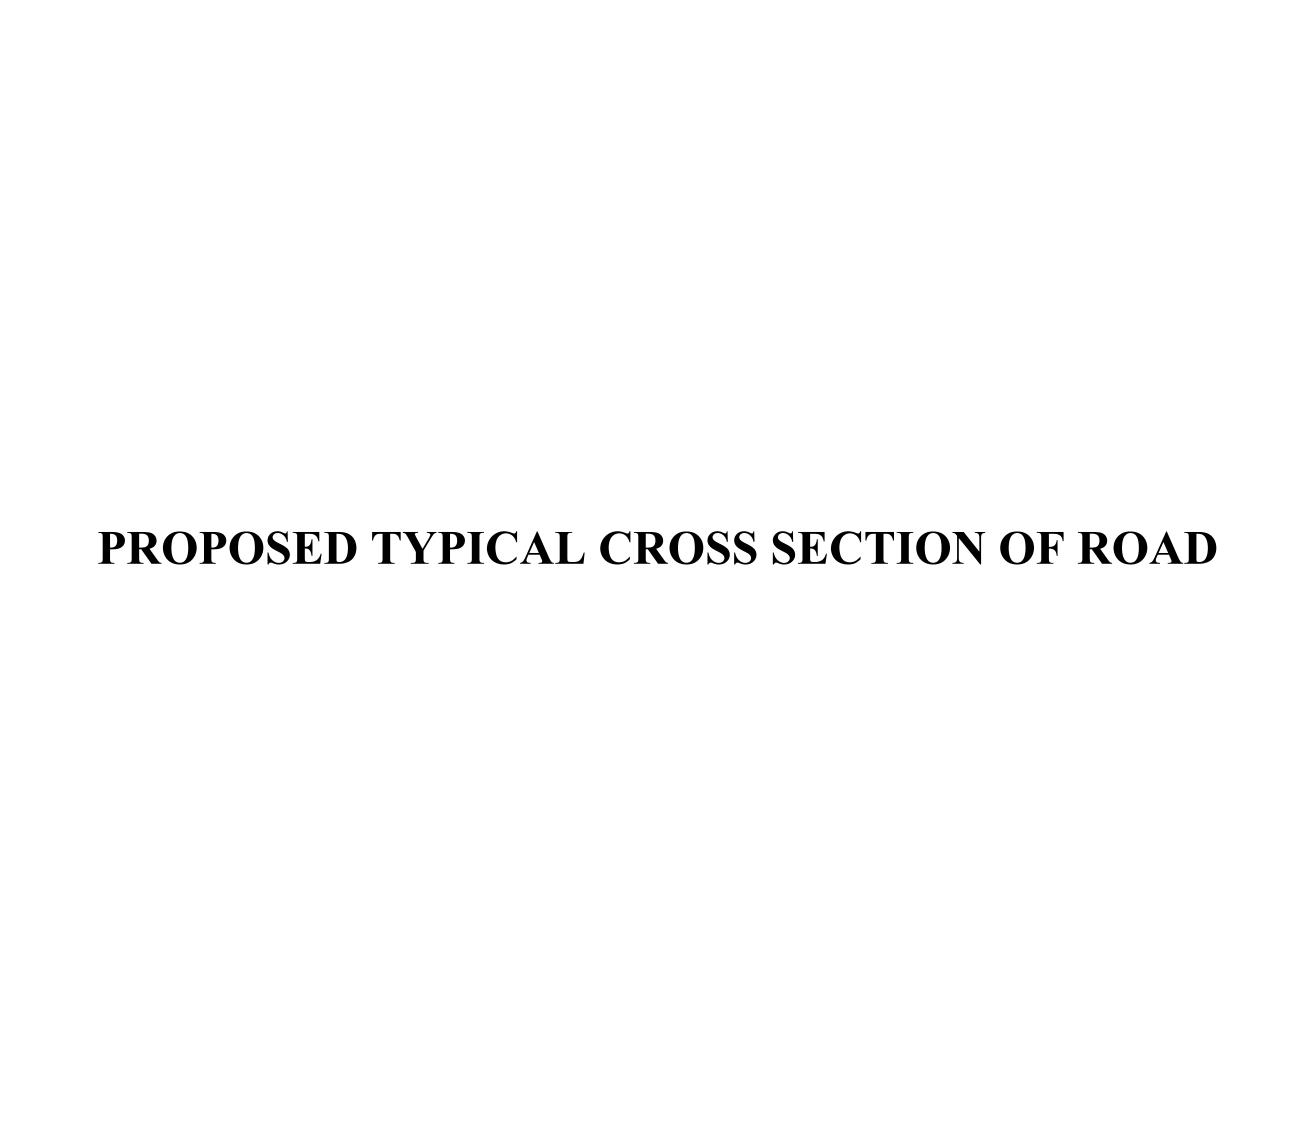

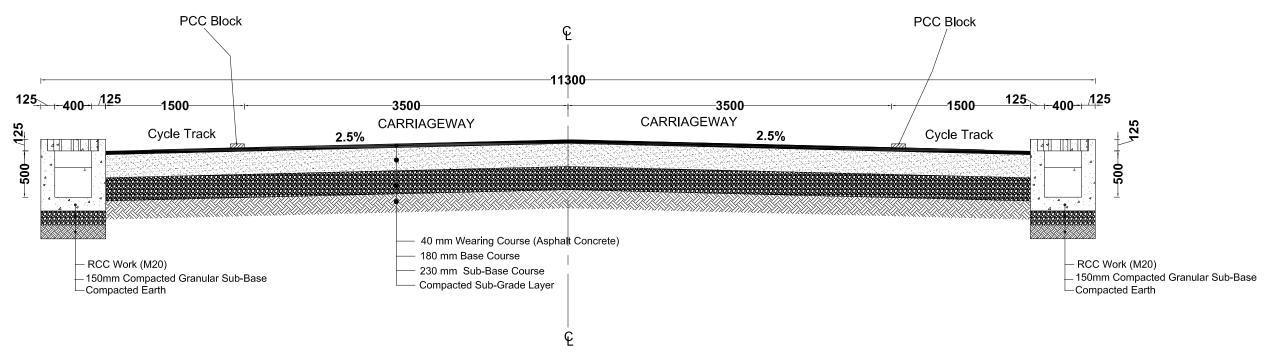

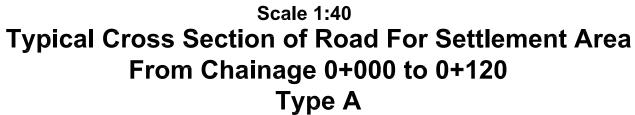







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Sheet Title:-

Proposed Typical Cross Section Of Road

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	CHECKED BY :	Chainage:
	APPROVED BY :	Sheet No.: 1



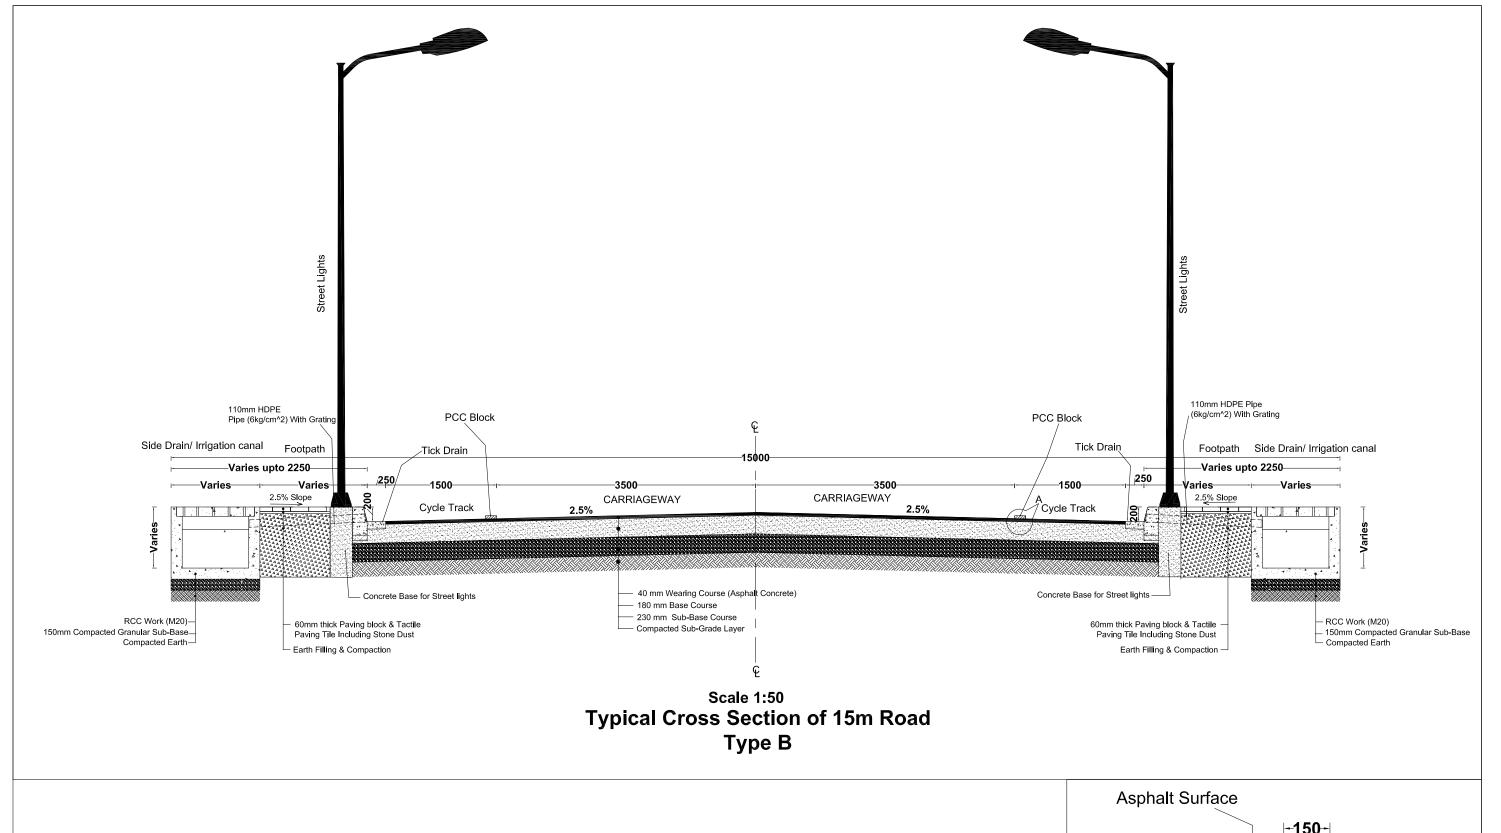

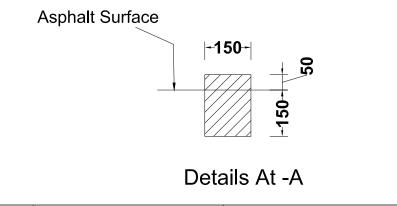

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Office of the Municipal Executive
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CONSULTANT:
Plush Engineers and Architects (P.) Ltd. (PEA)
B.N. Consultancy Pvt. Ltd. (BN)
Soil Test Consultancy (P.) Ltd. (Soil Test)
Kathmandu, Nepal

Project Name:- Nepal Urban Governance and Infrastructure Project (NUGIP)

Sheet Title:-

Proposed Typical Cross Section Of Road
 DESIGNED BY :
 Date : 2023

 DRAWN BY :
 Scale : 1:50

 CHECKED BY :
 Chainage :

 APPROVED BY :
 Sheet No. : 2




LEGEND	SYMBOL
Bench Mark	<u>BM-1</u>
Houses	
Temple	
RCC Electric pole	
Pipe Culvert	
Centreline	
Chainage	
Tick Drain	\(\tag{\tau} \)
Foot Path	
kerb stone	
Side Drain	
Bamboo	

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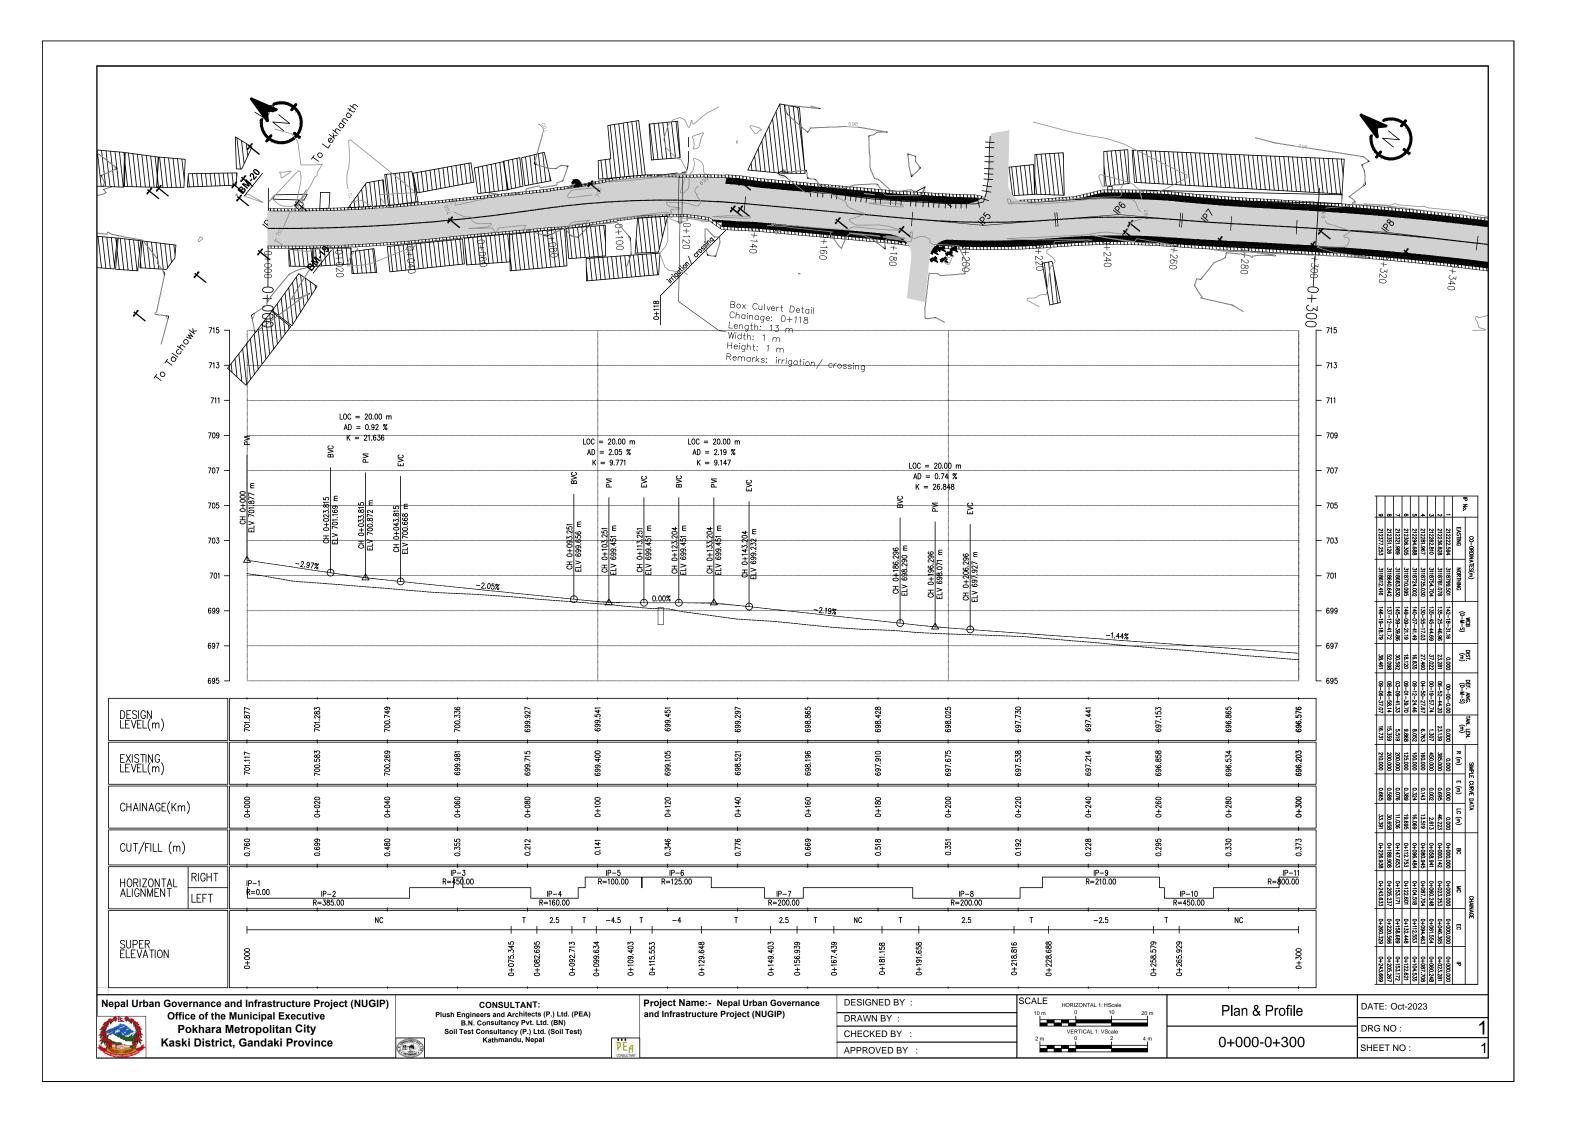



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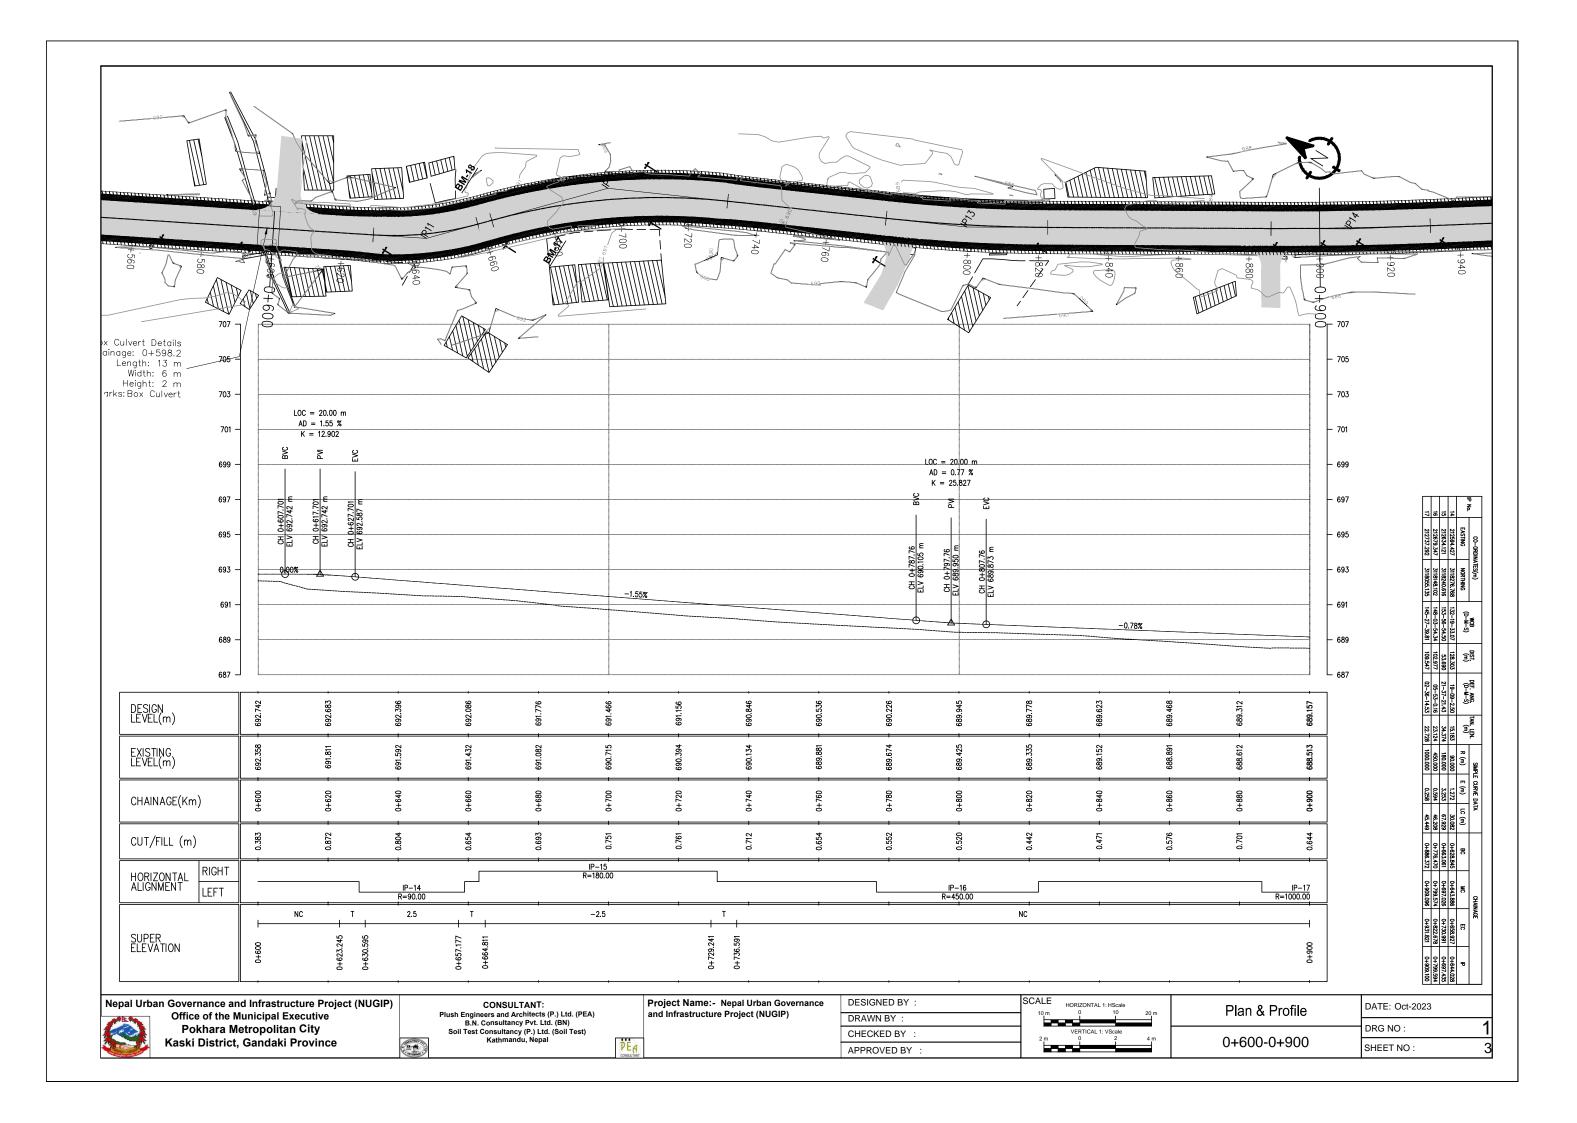
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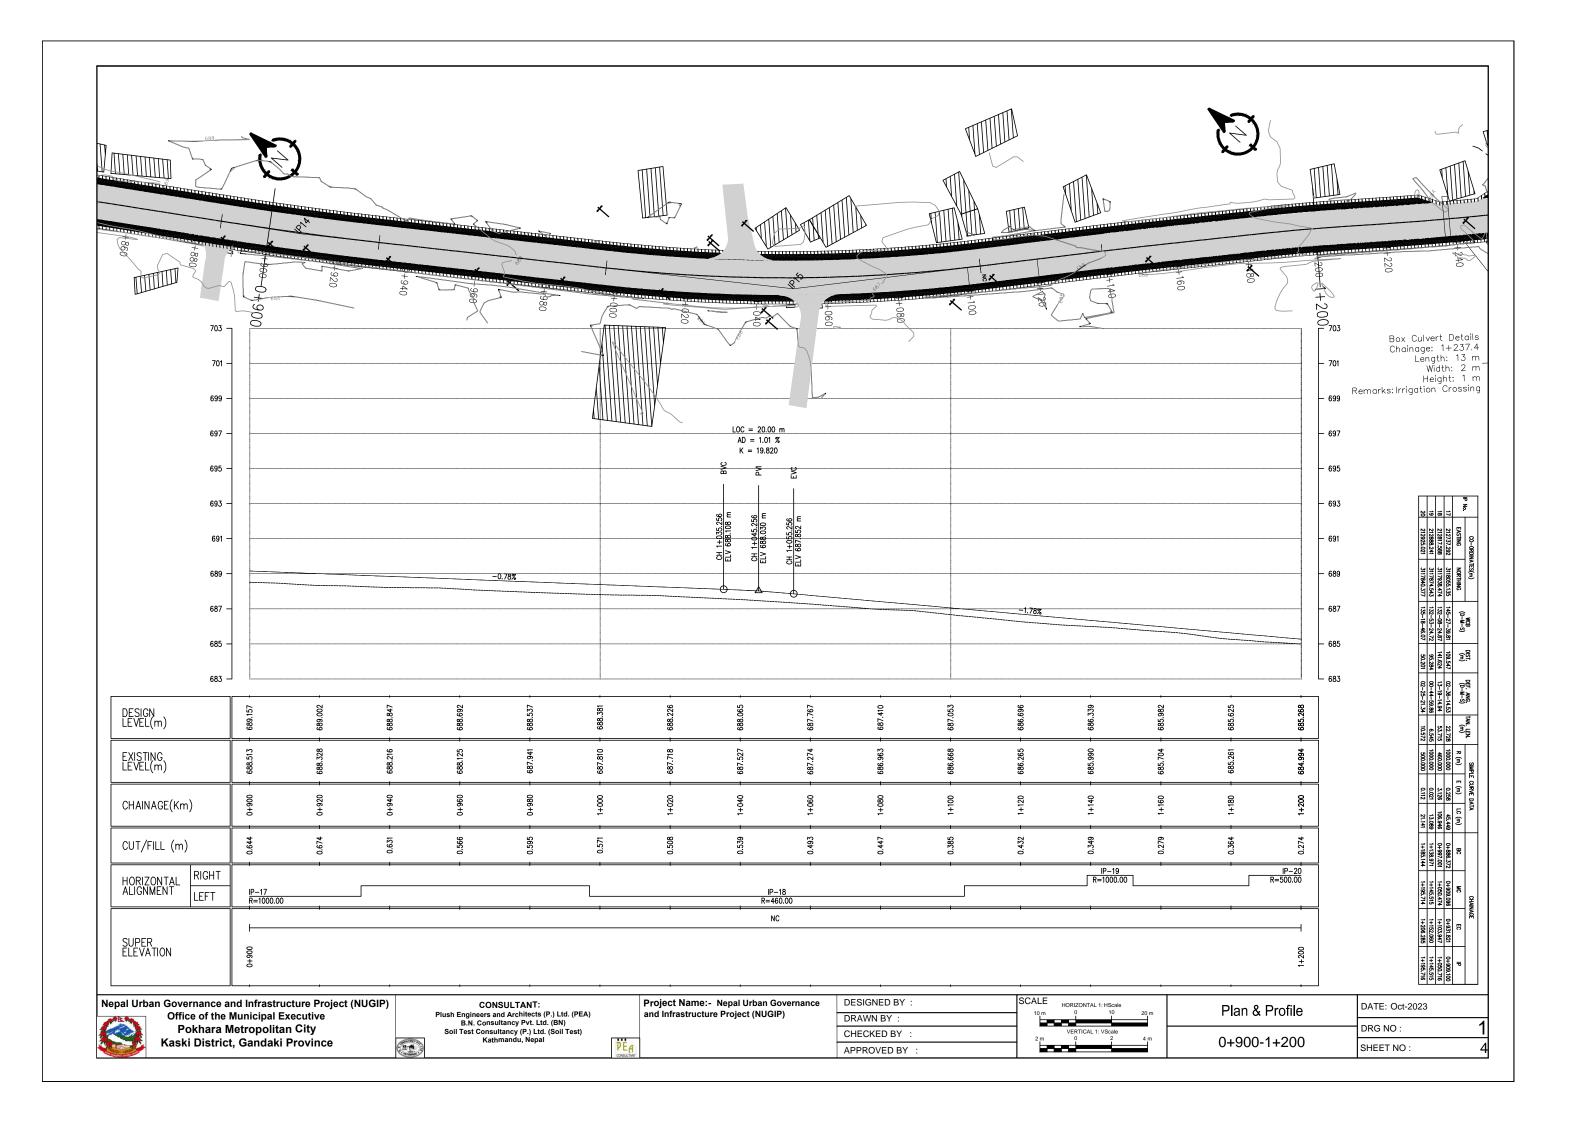



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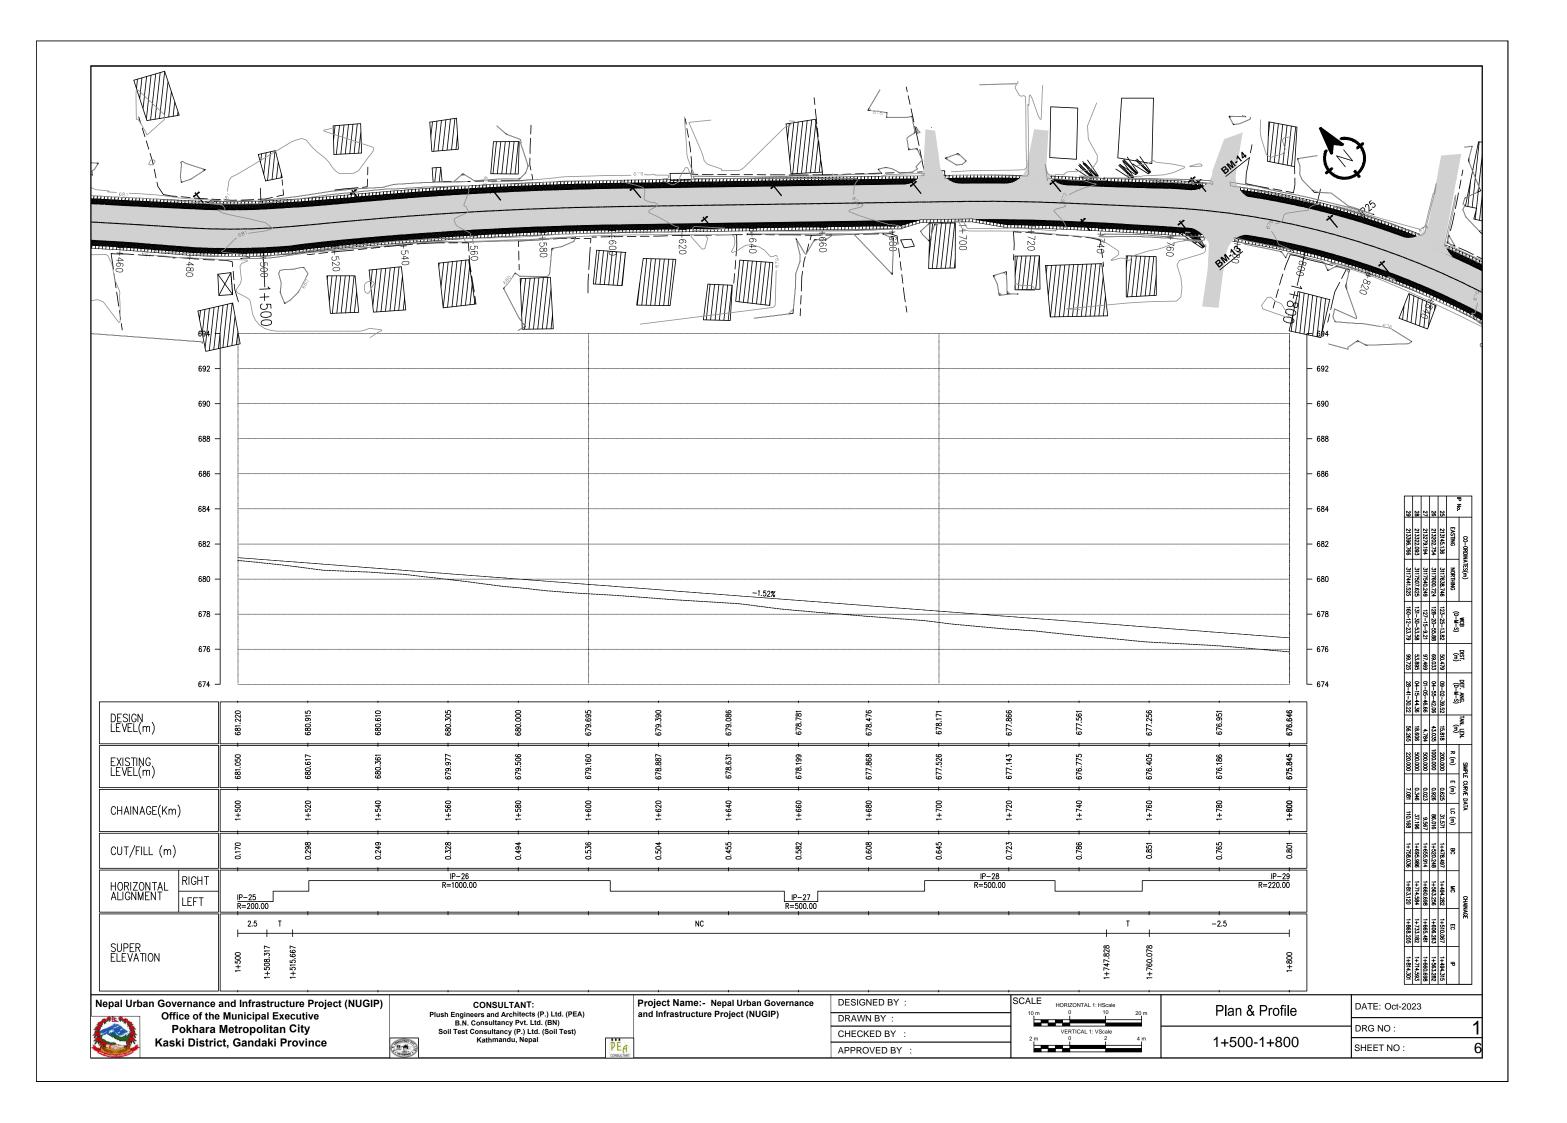





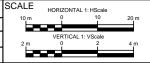





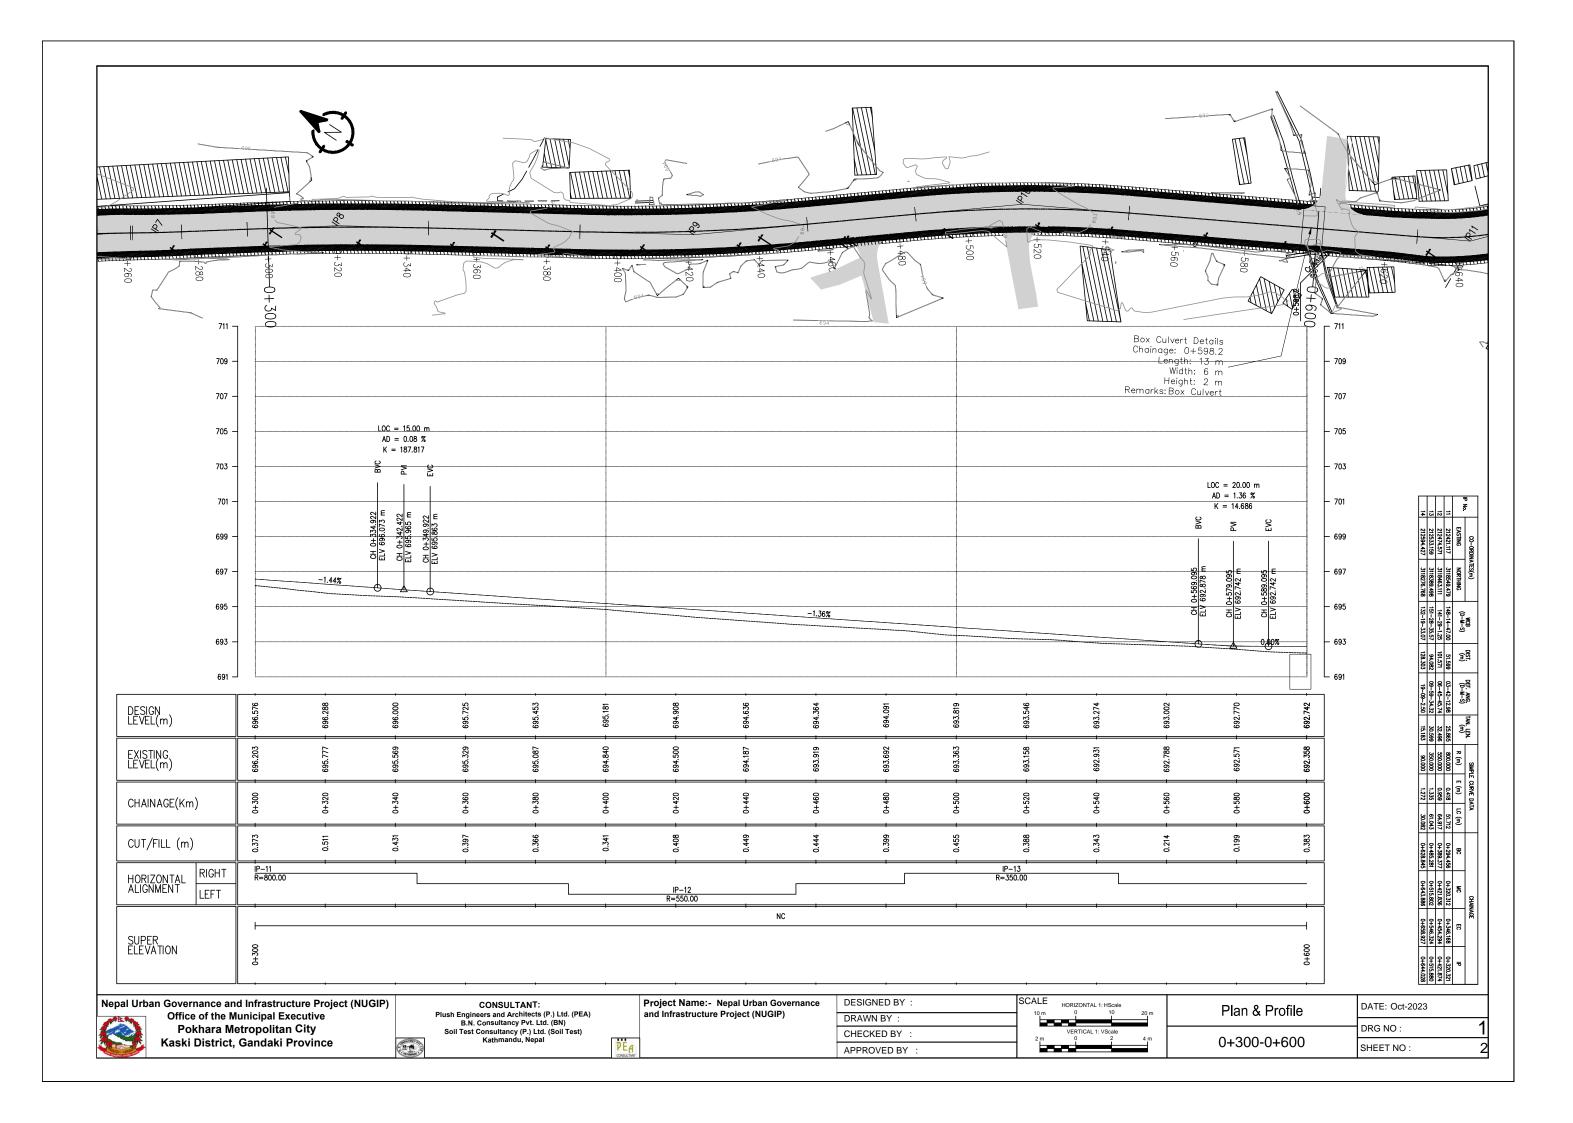


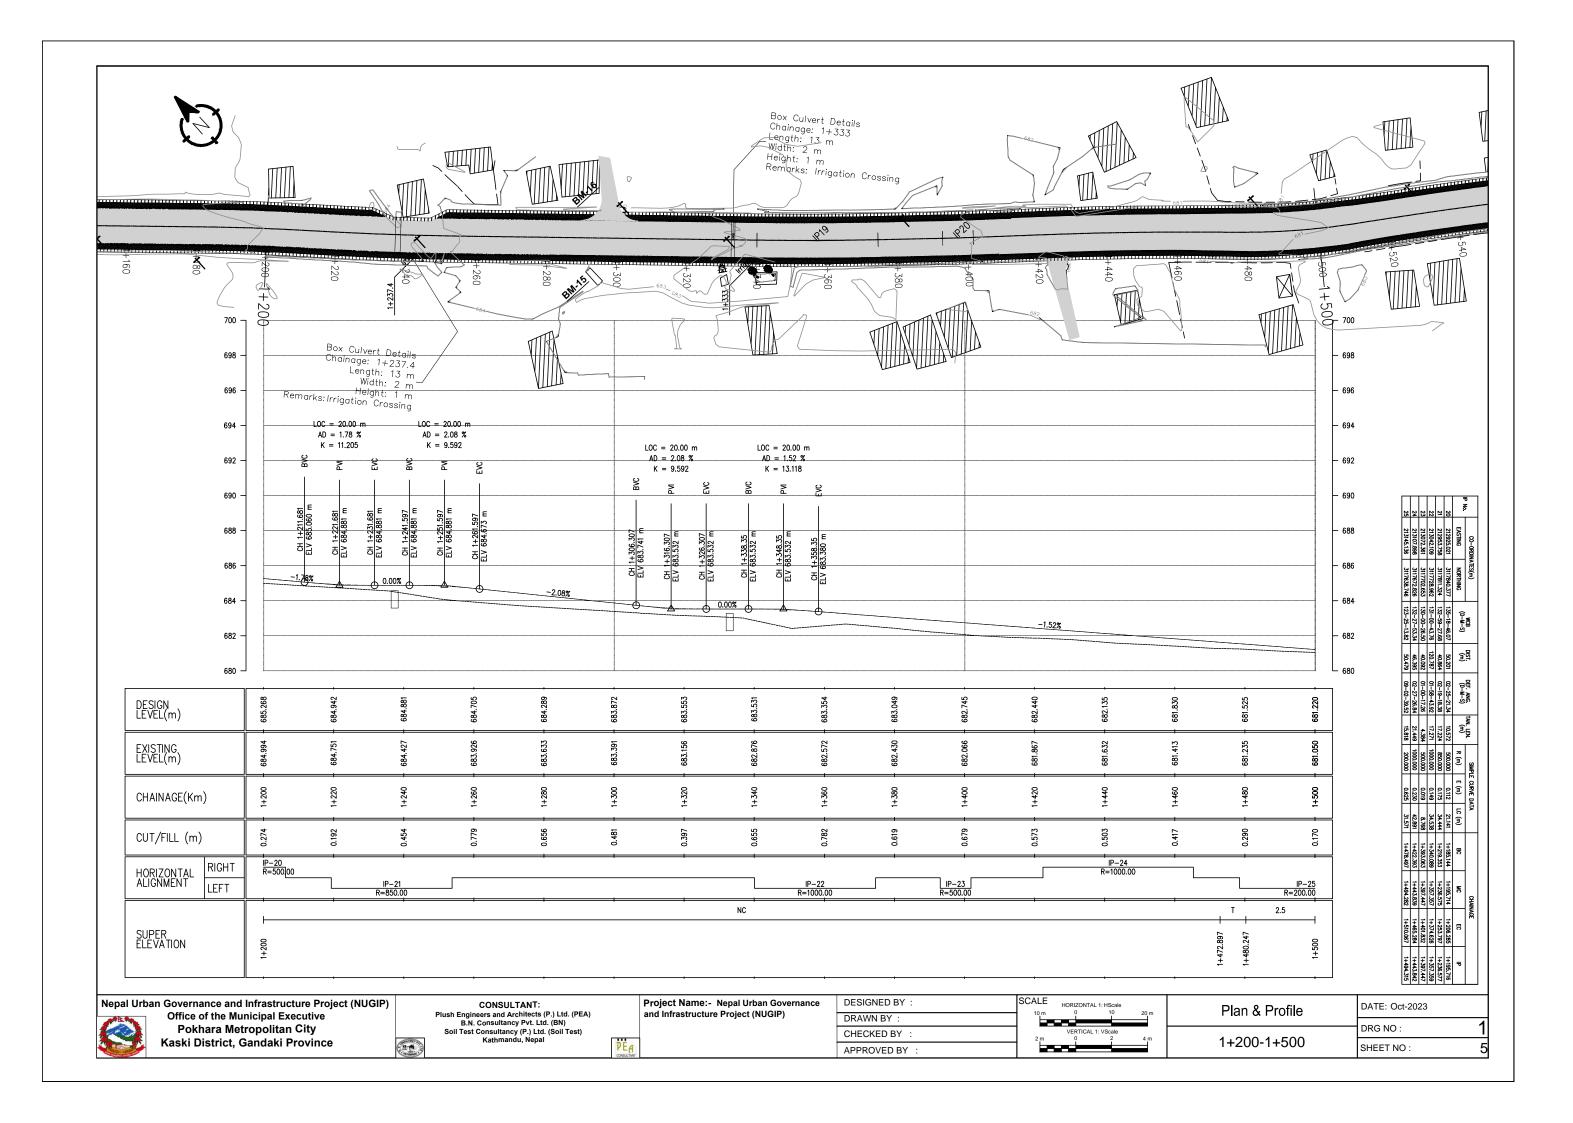


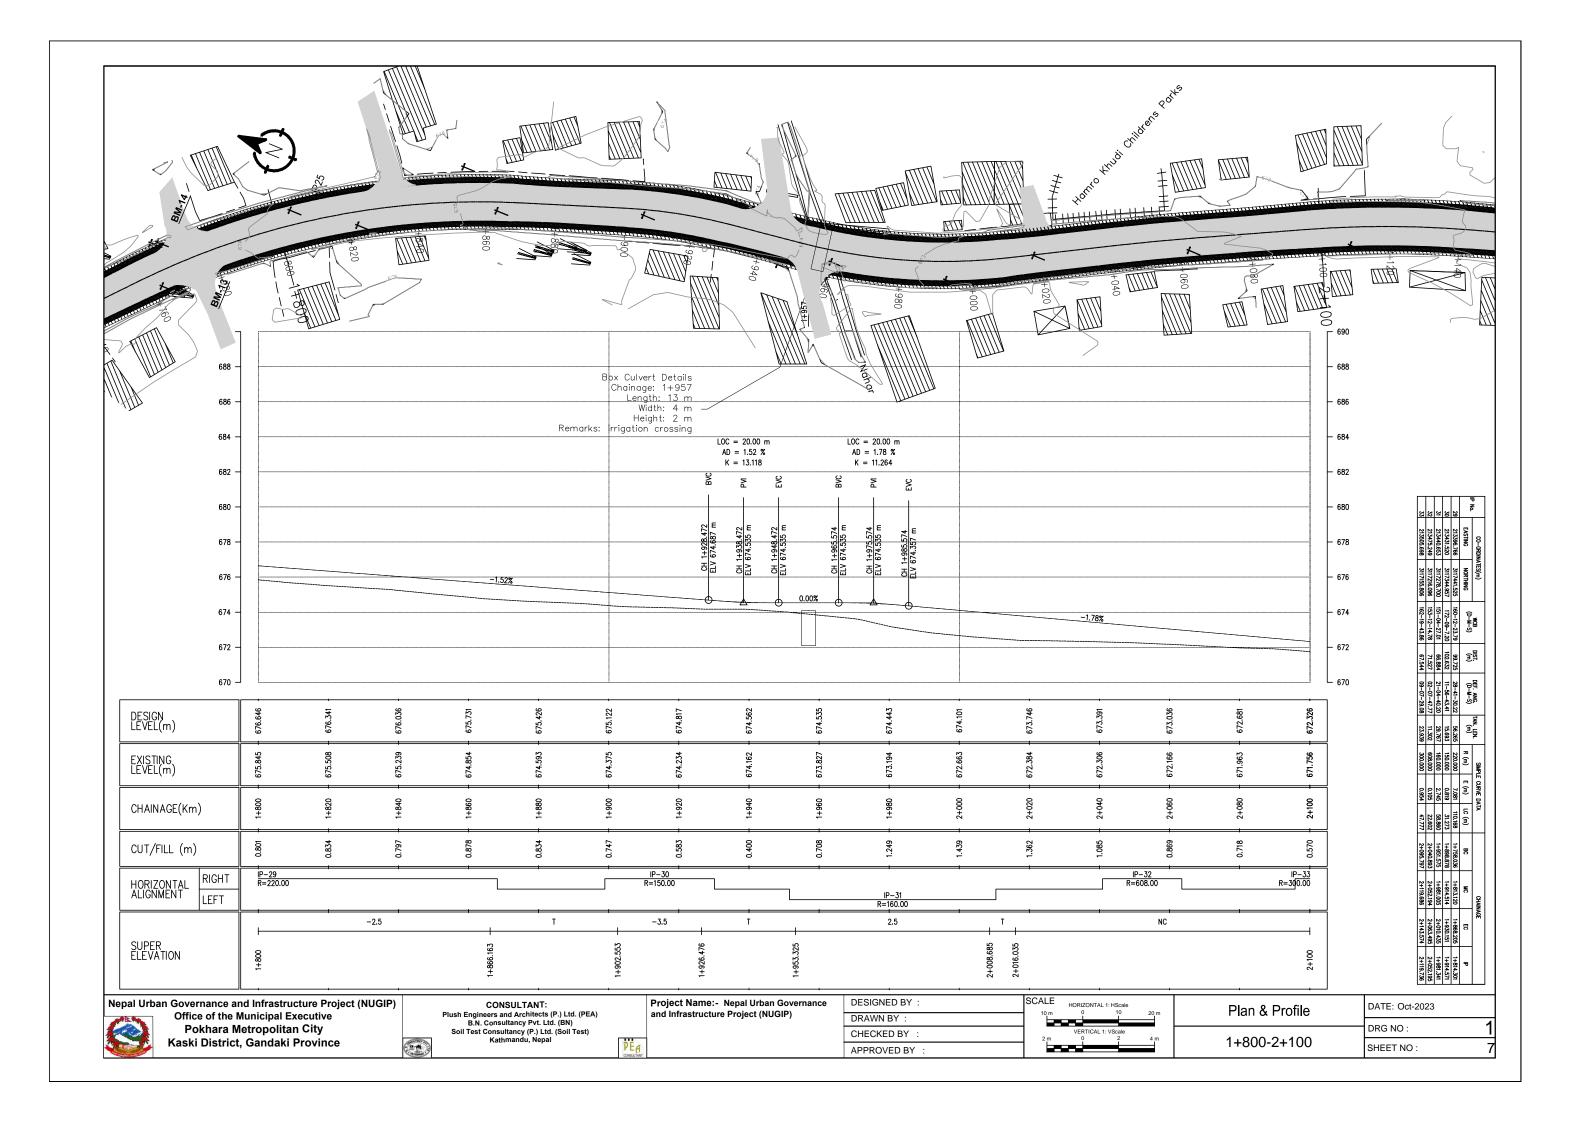


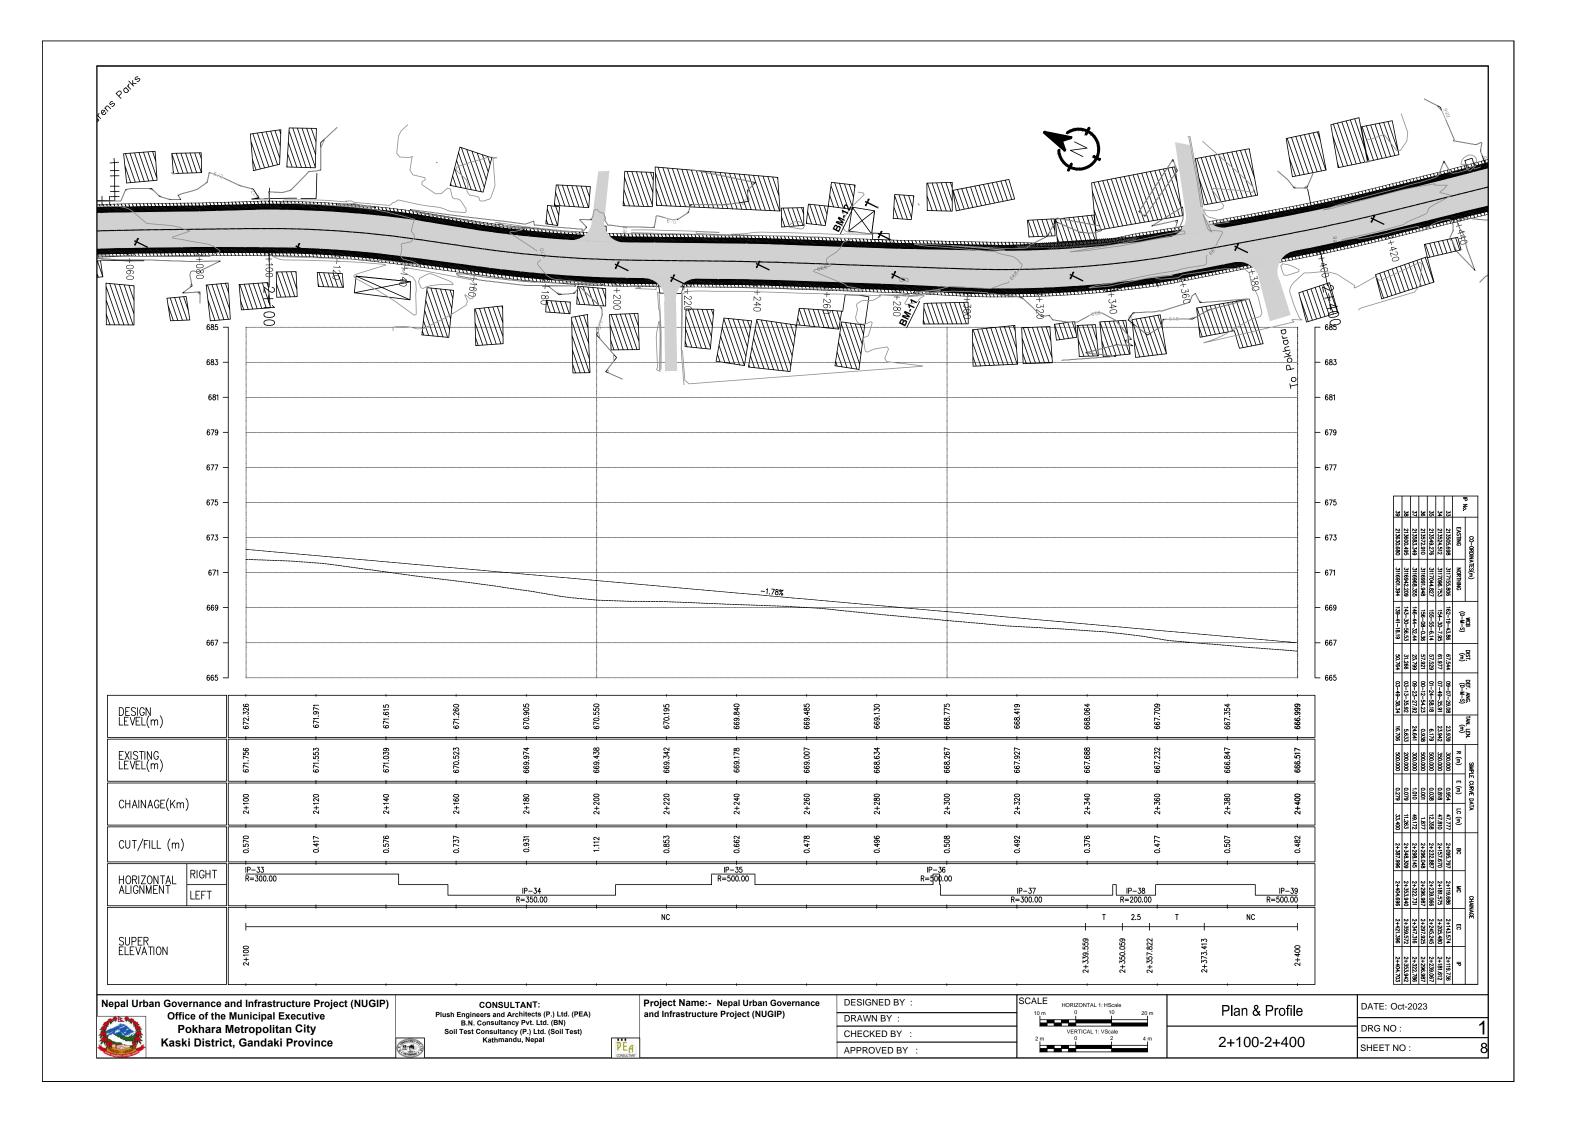


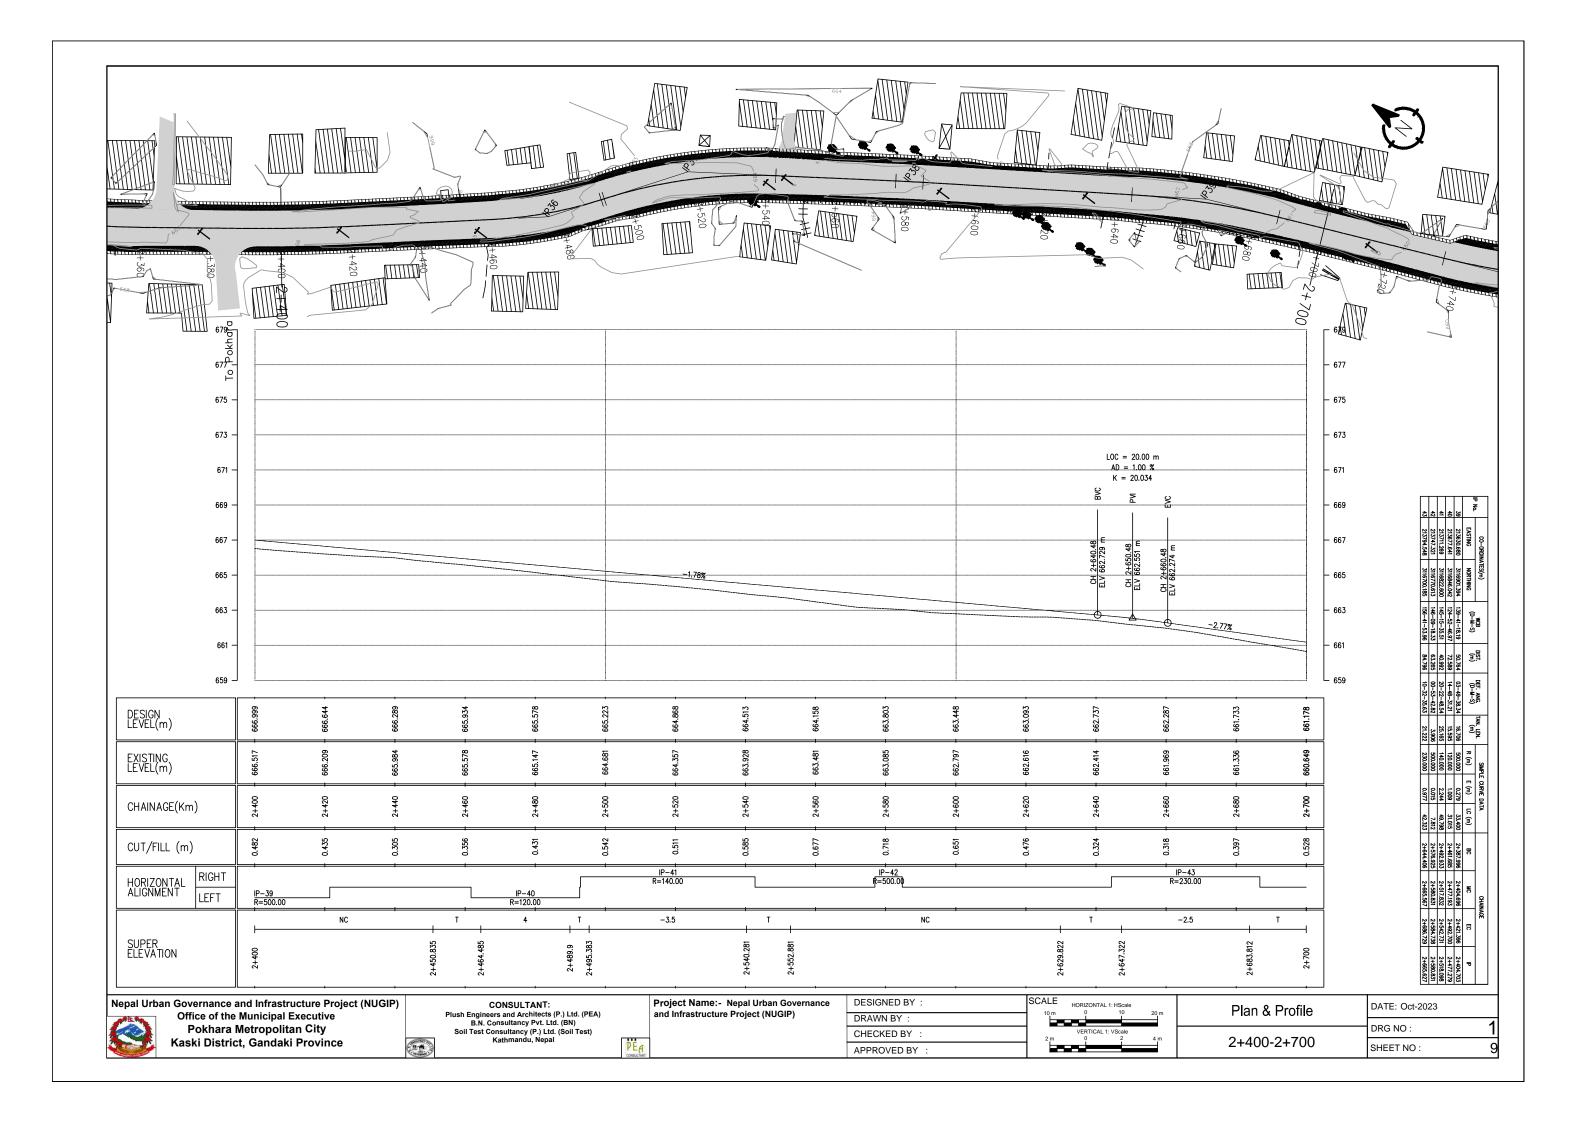


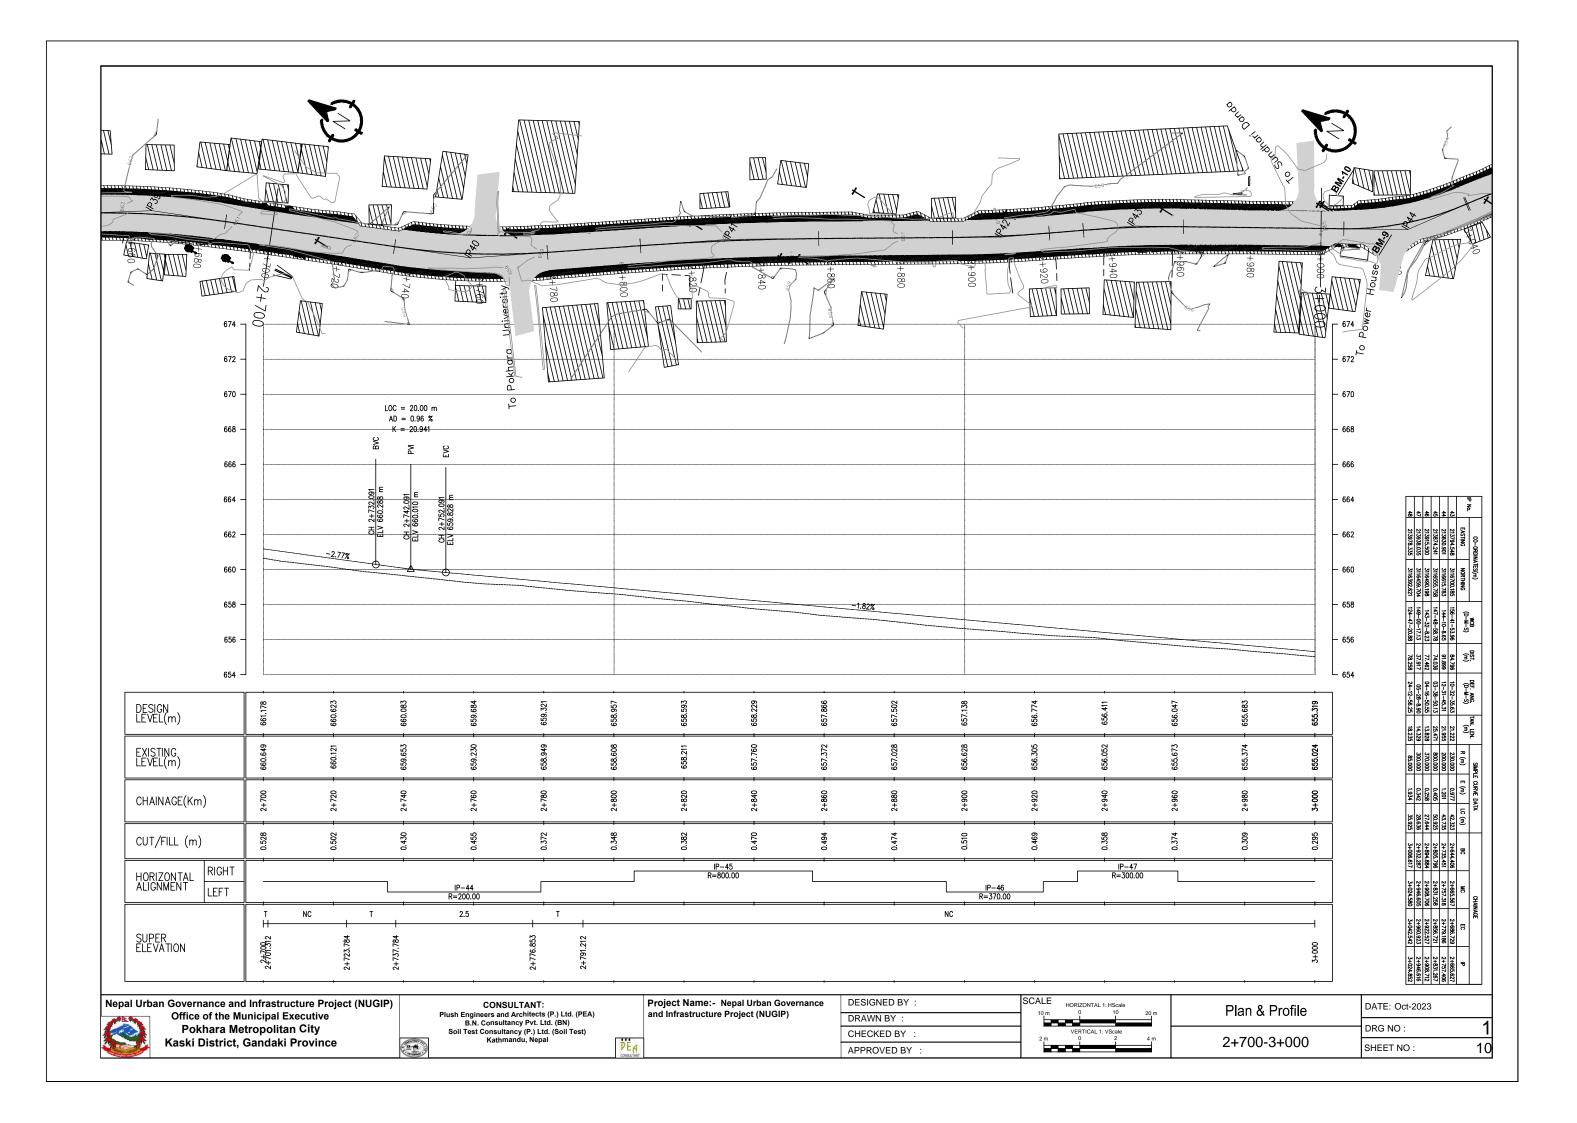


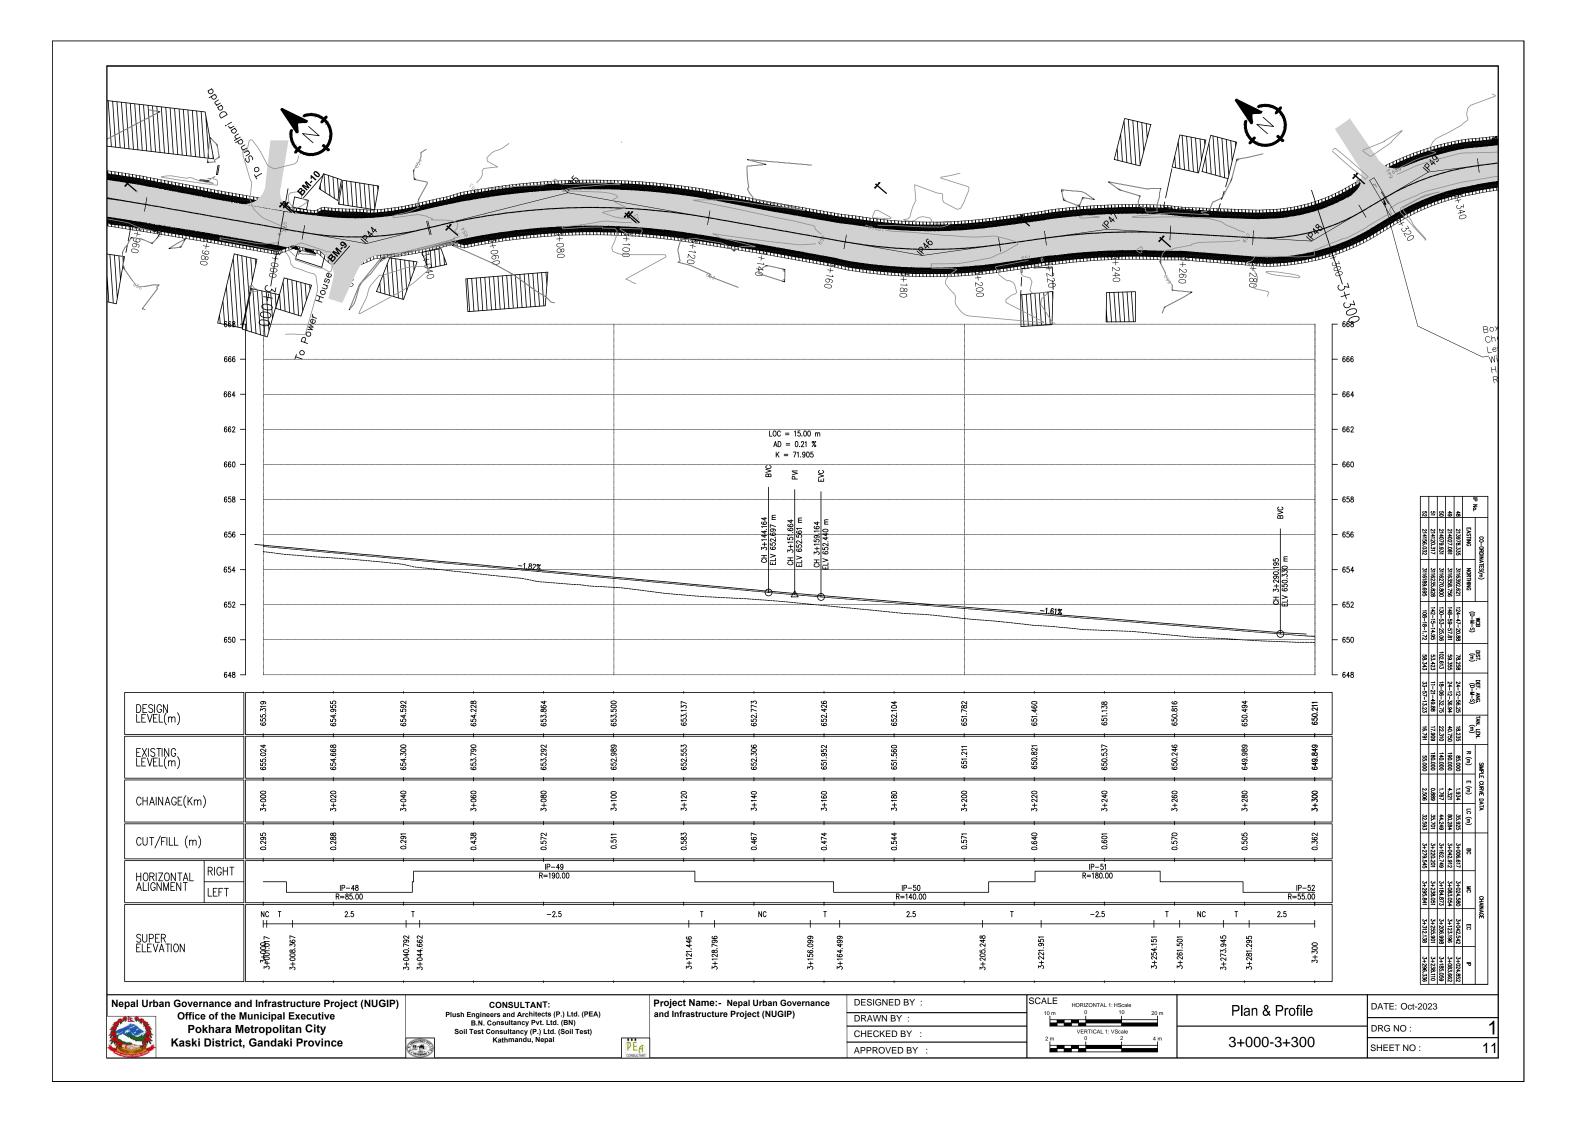


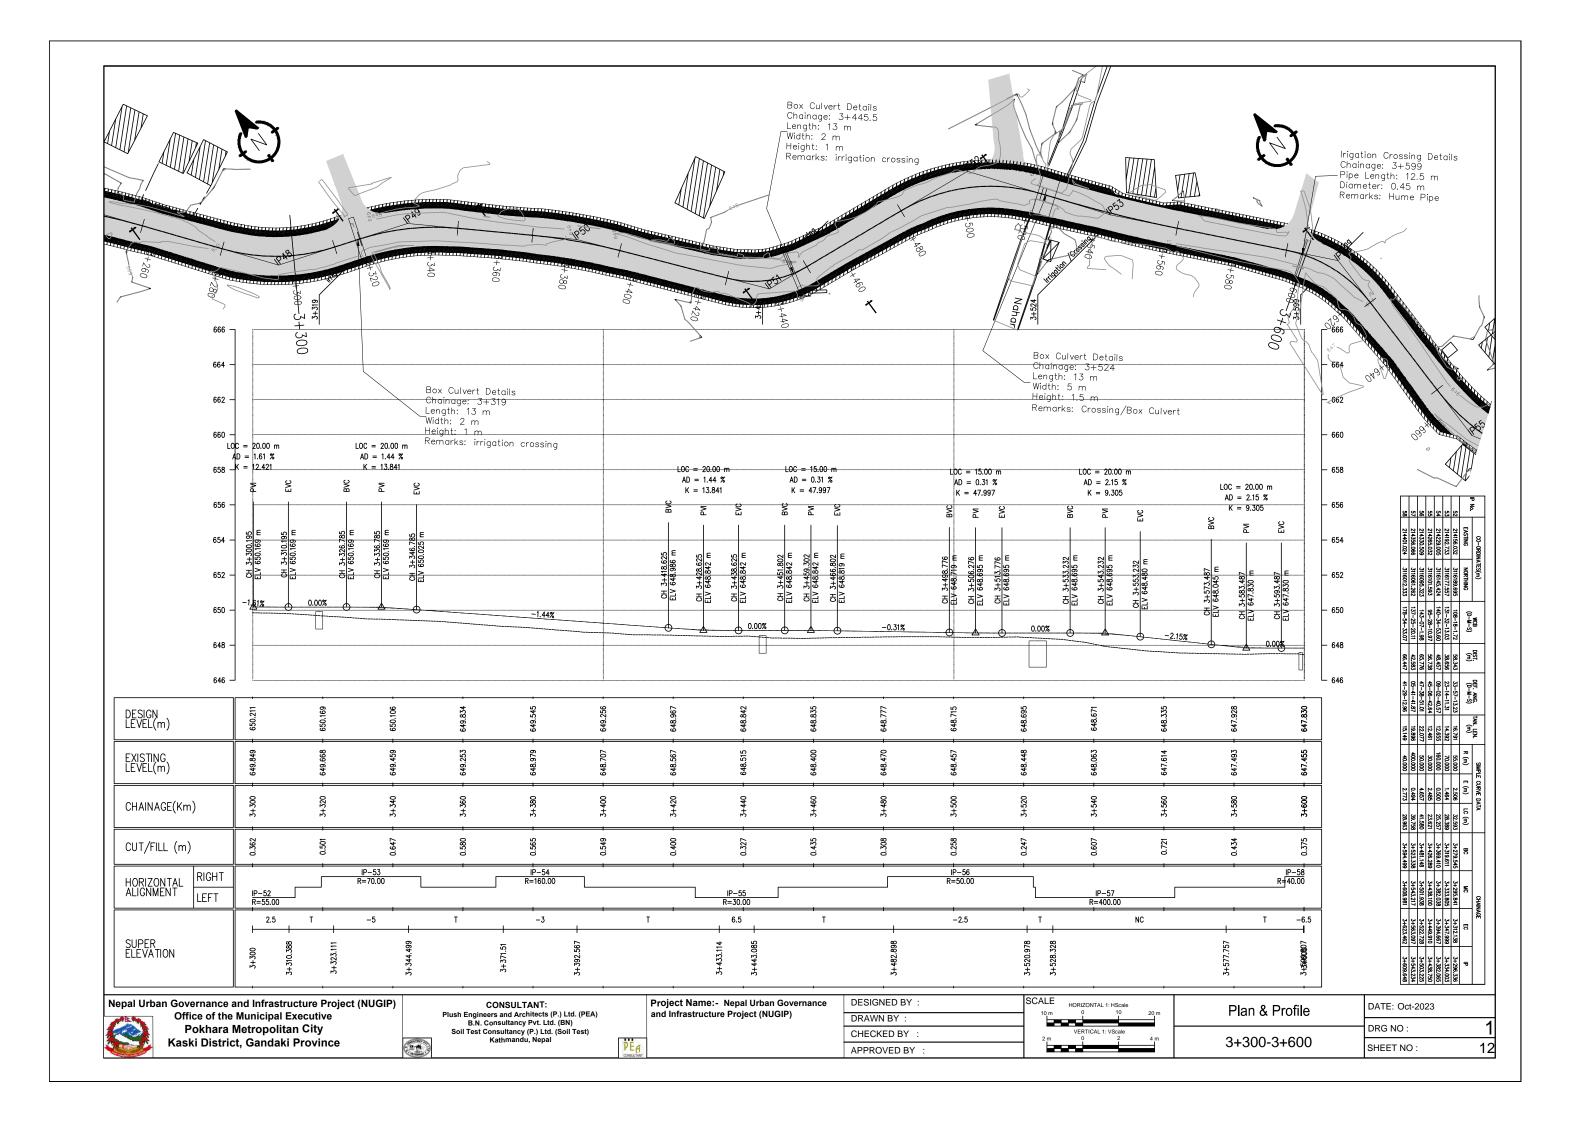


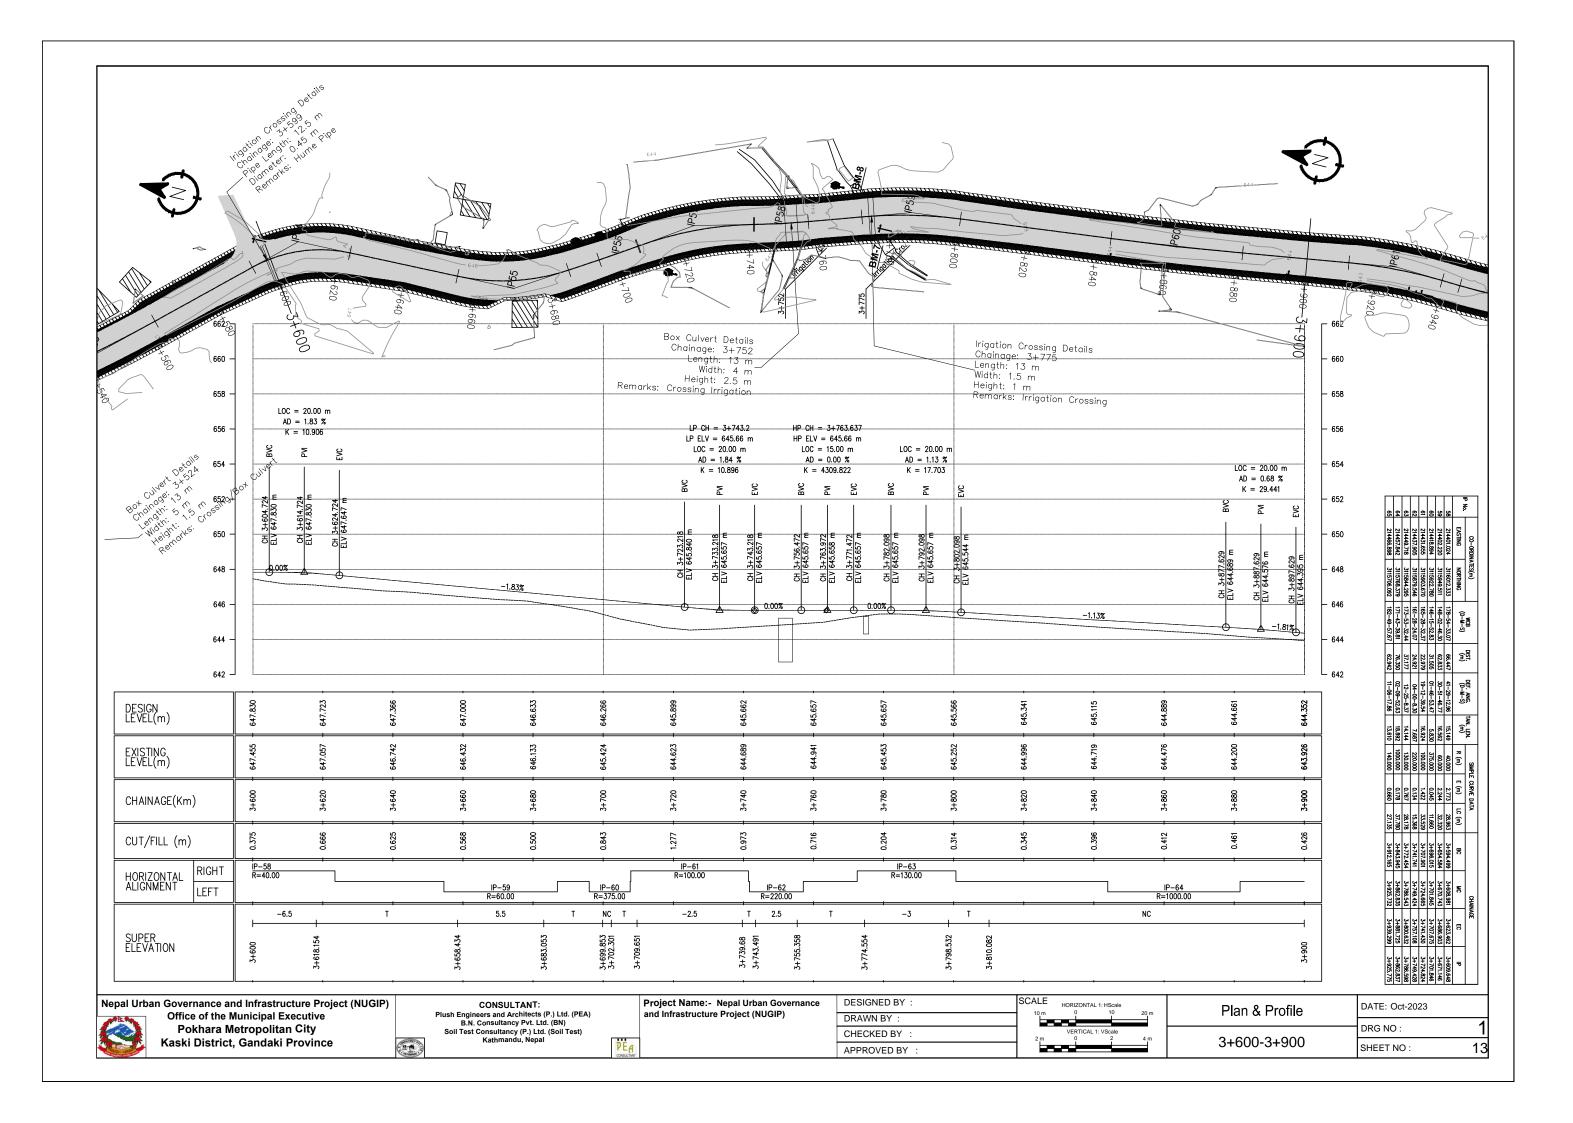


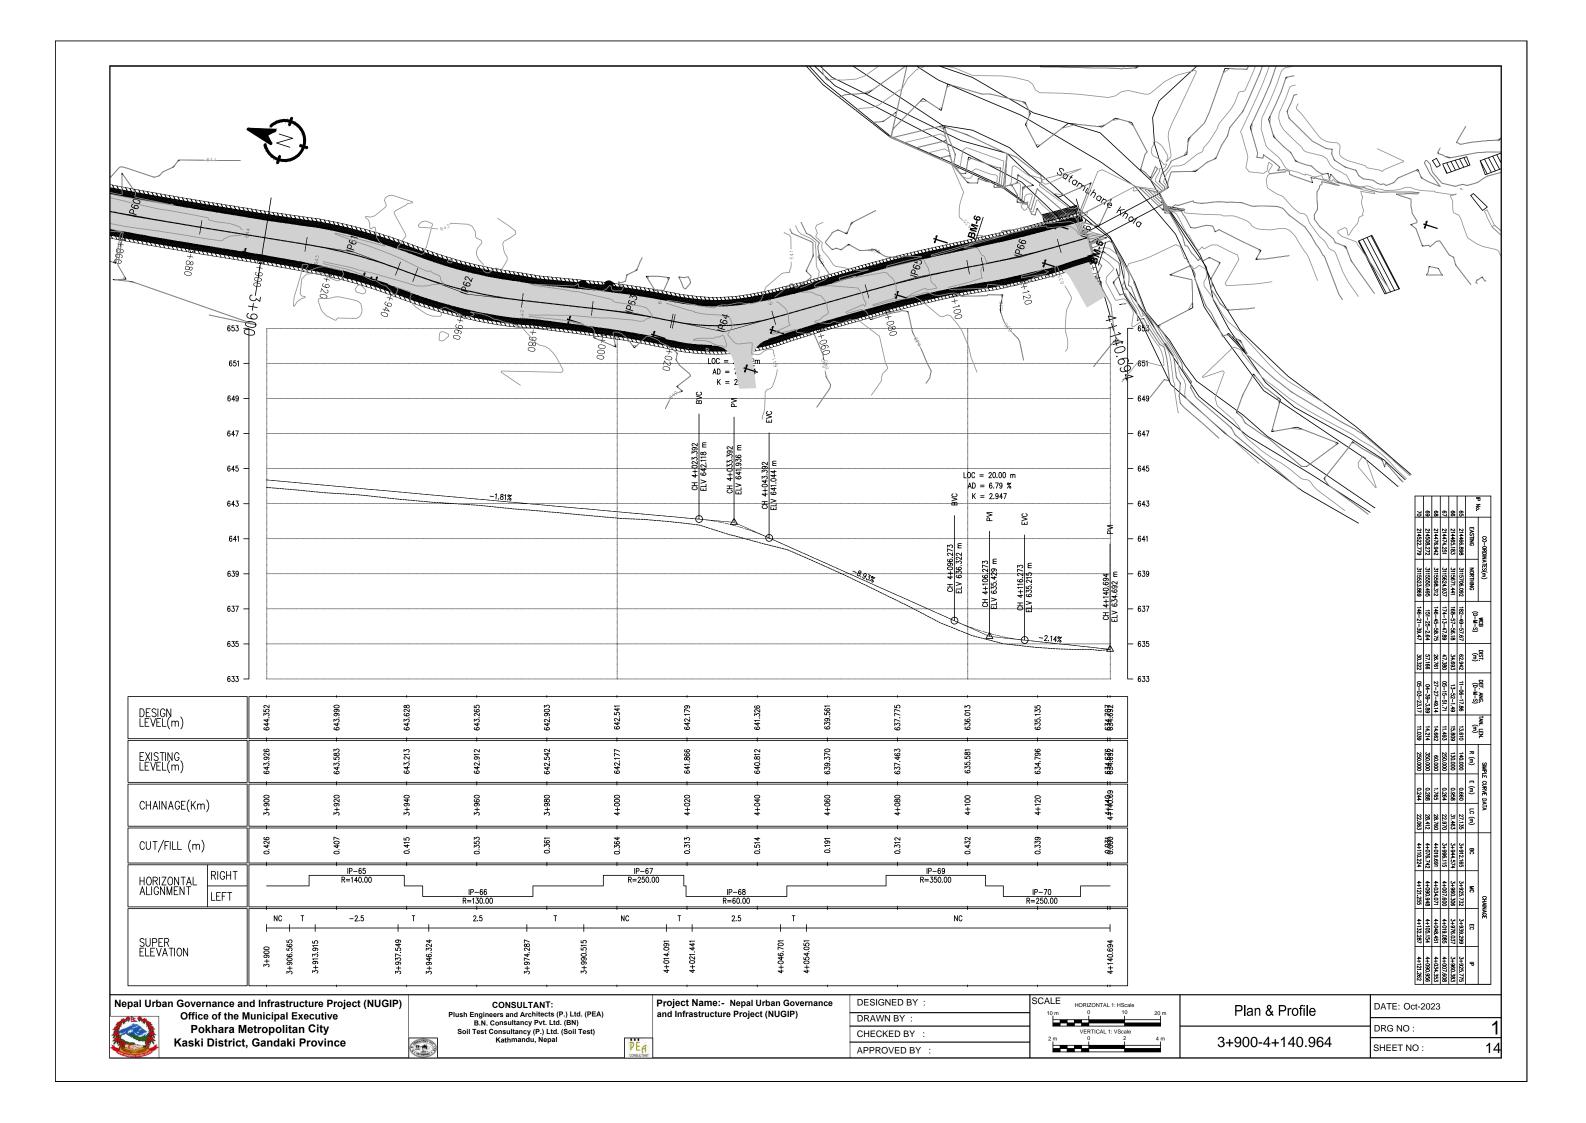


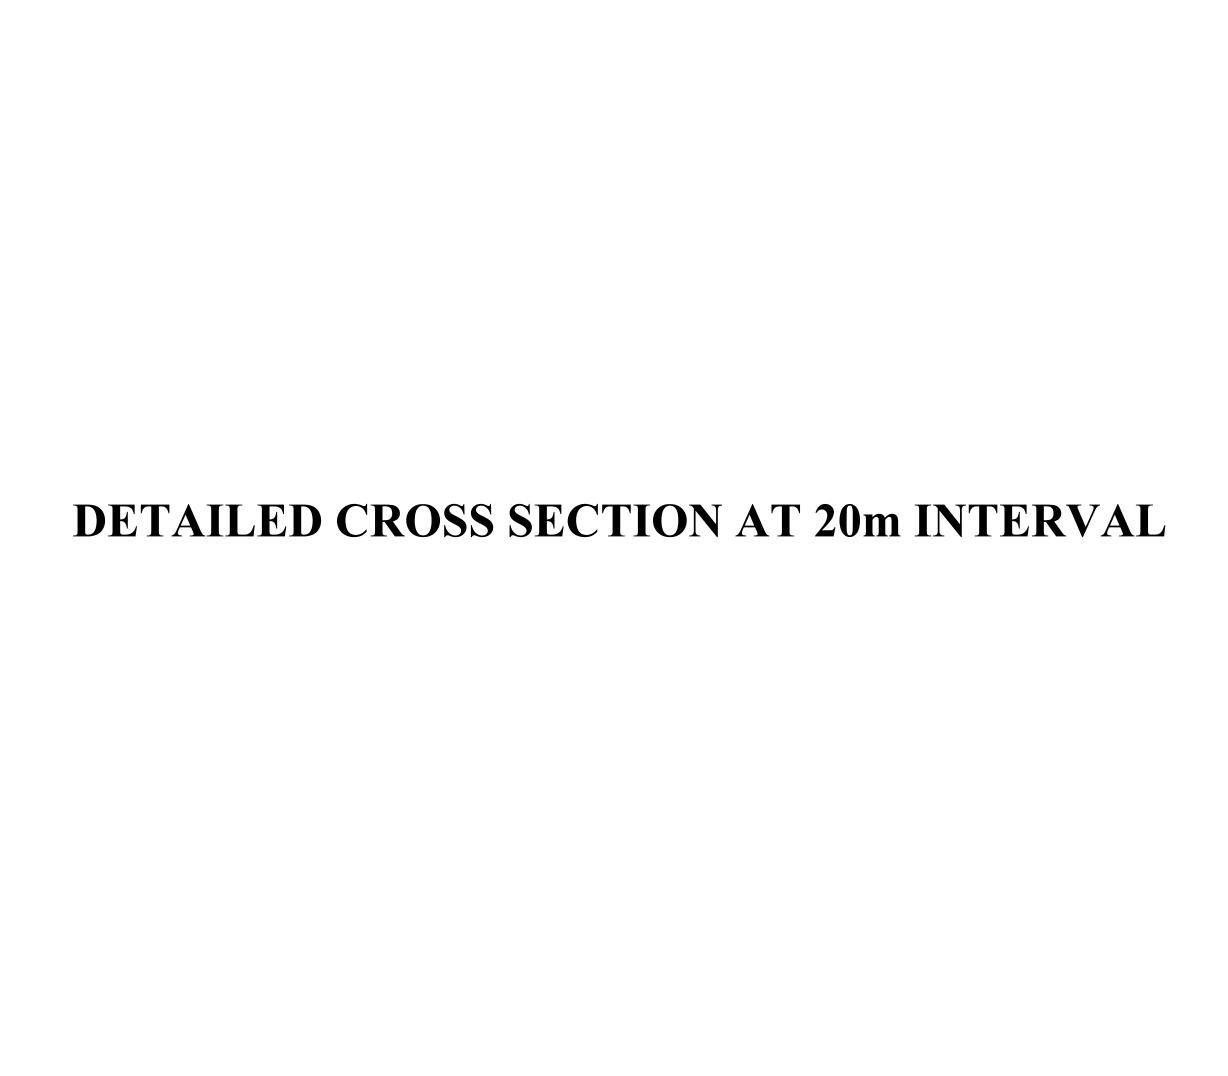


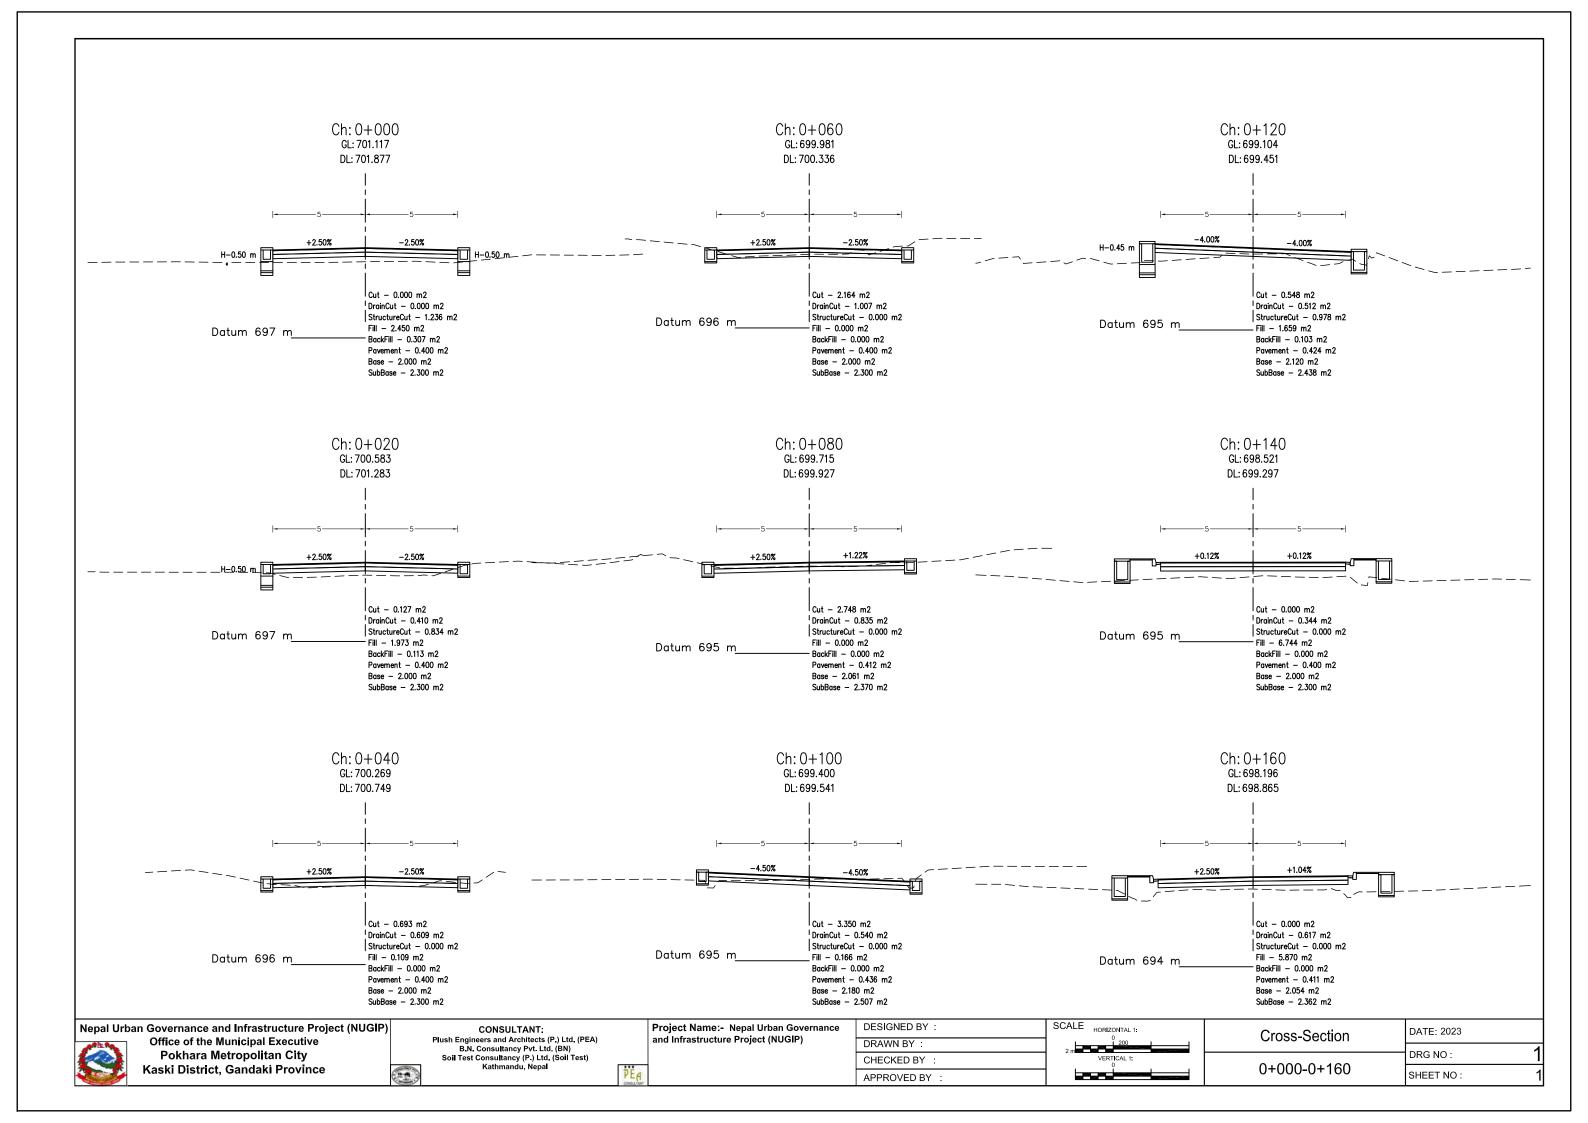


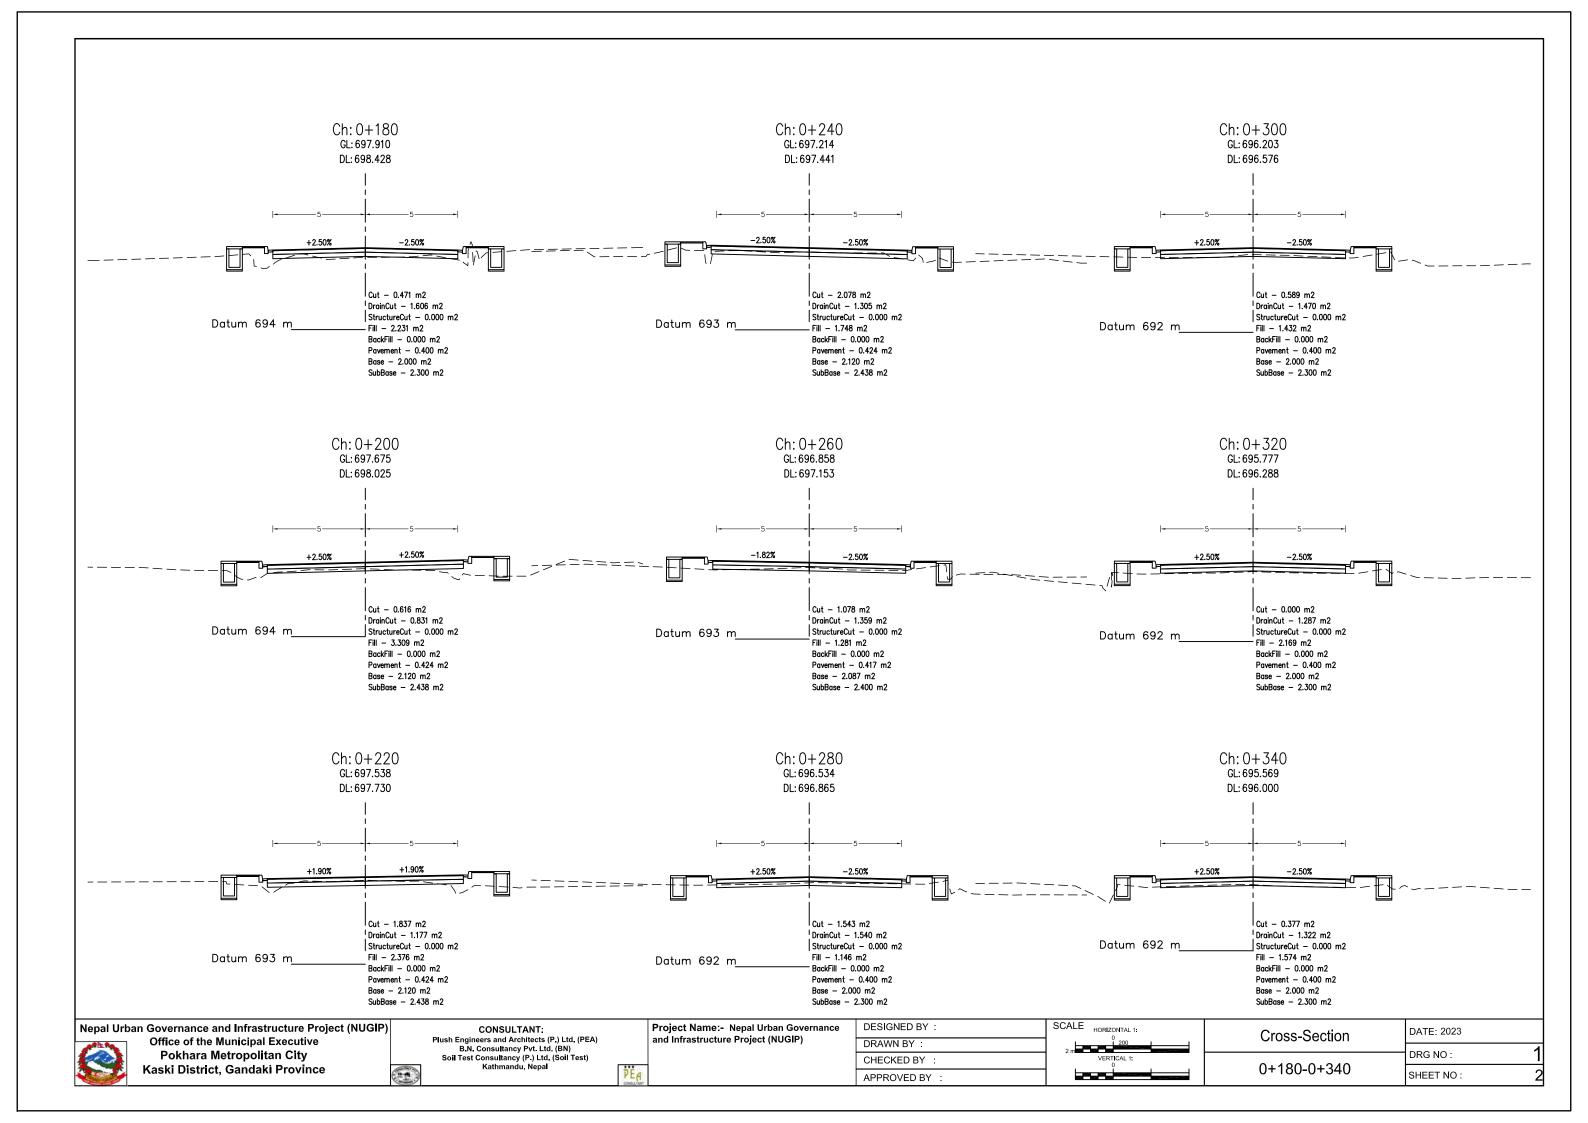


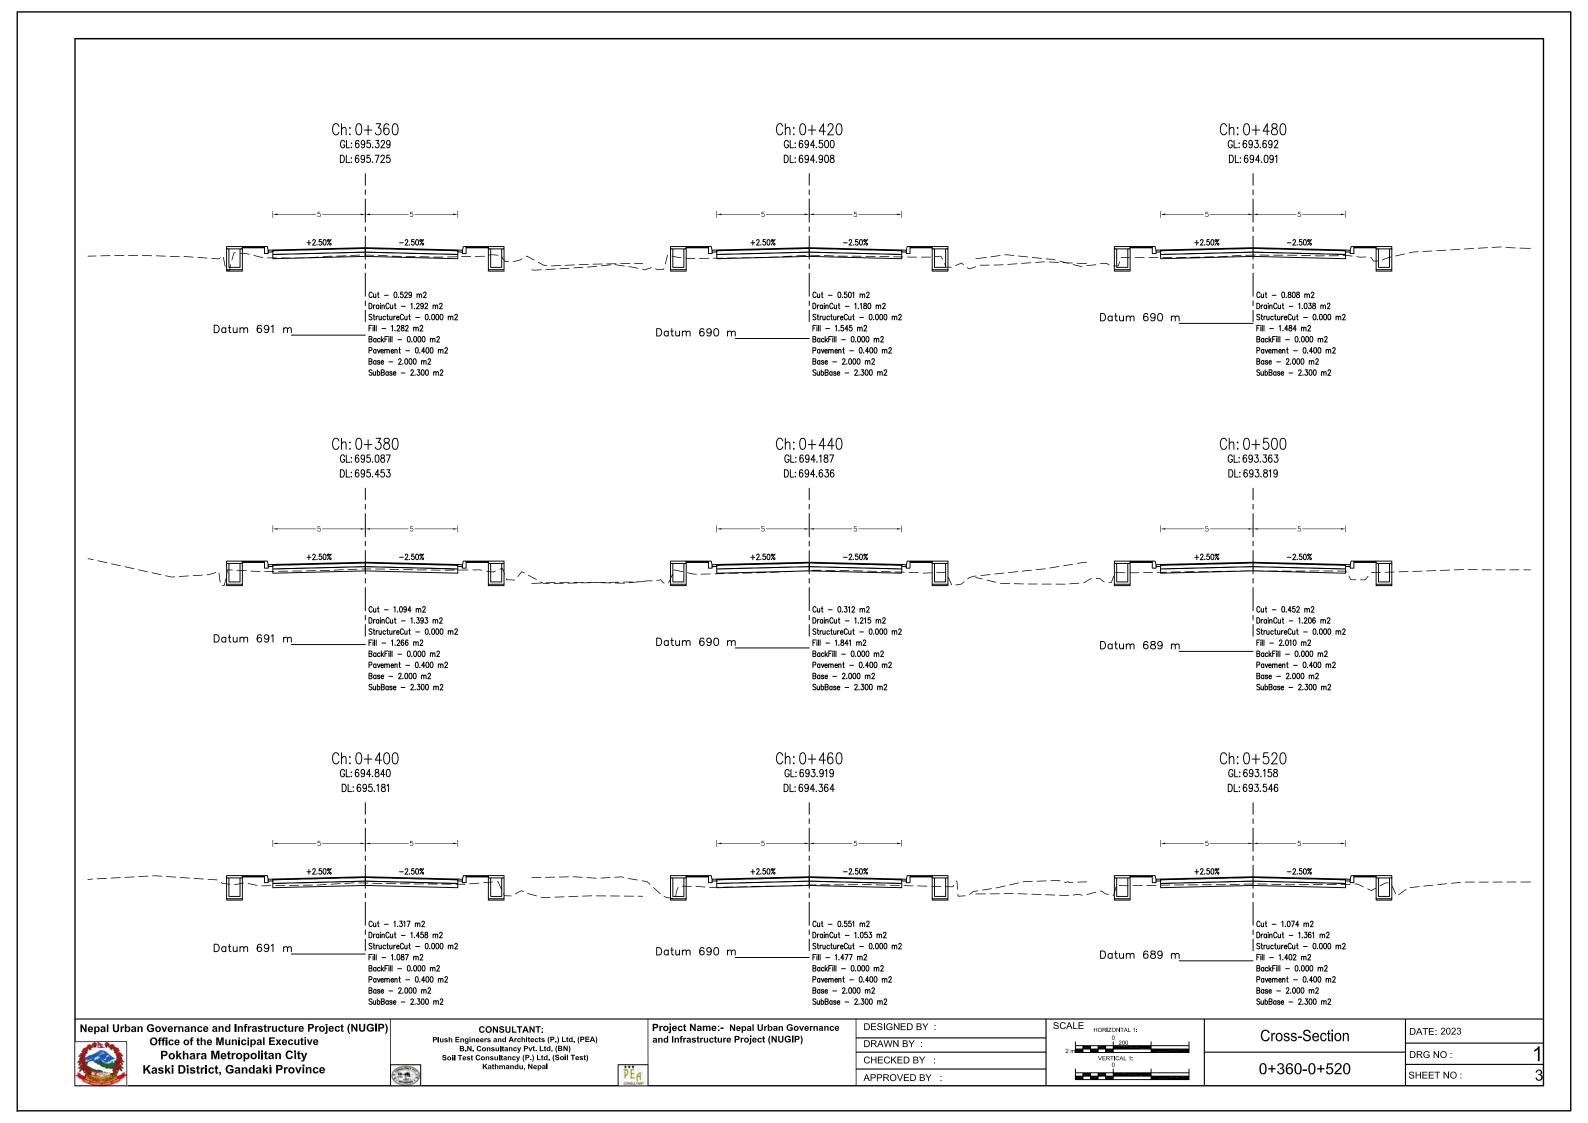


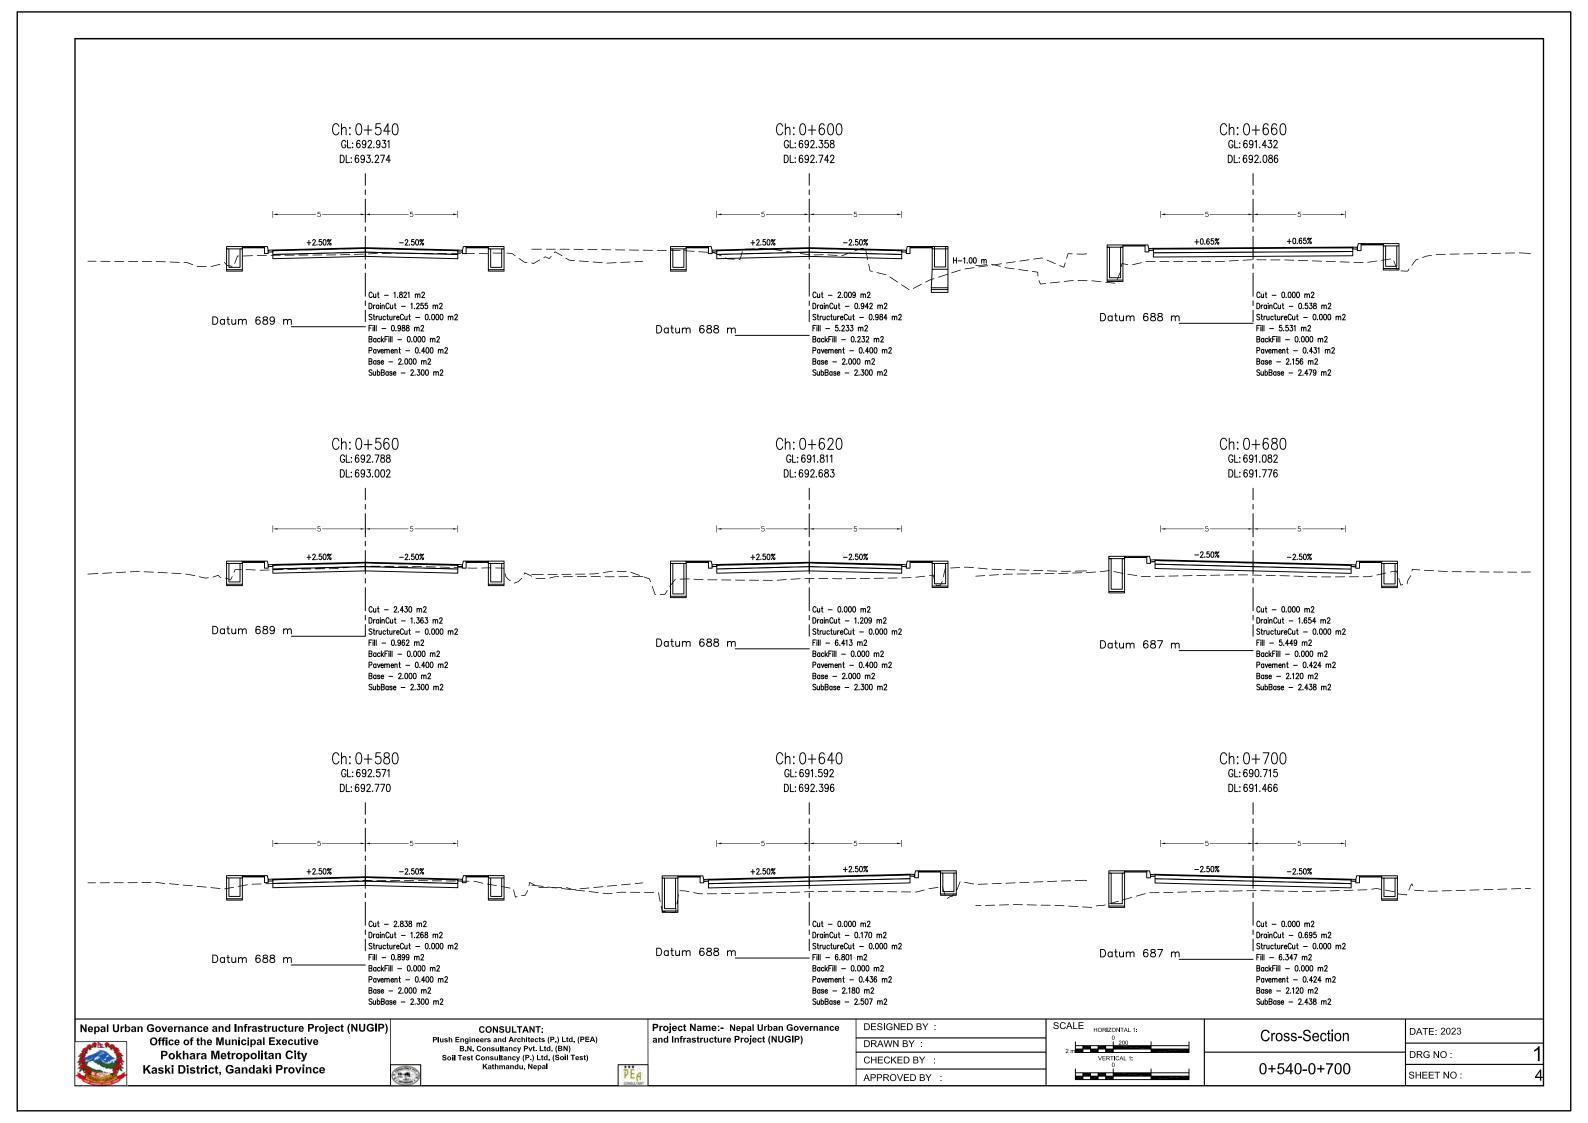


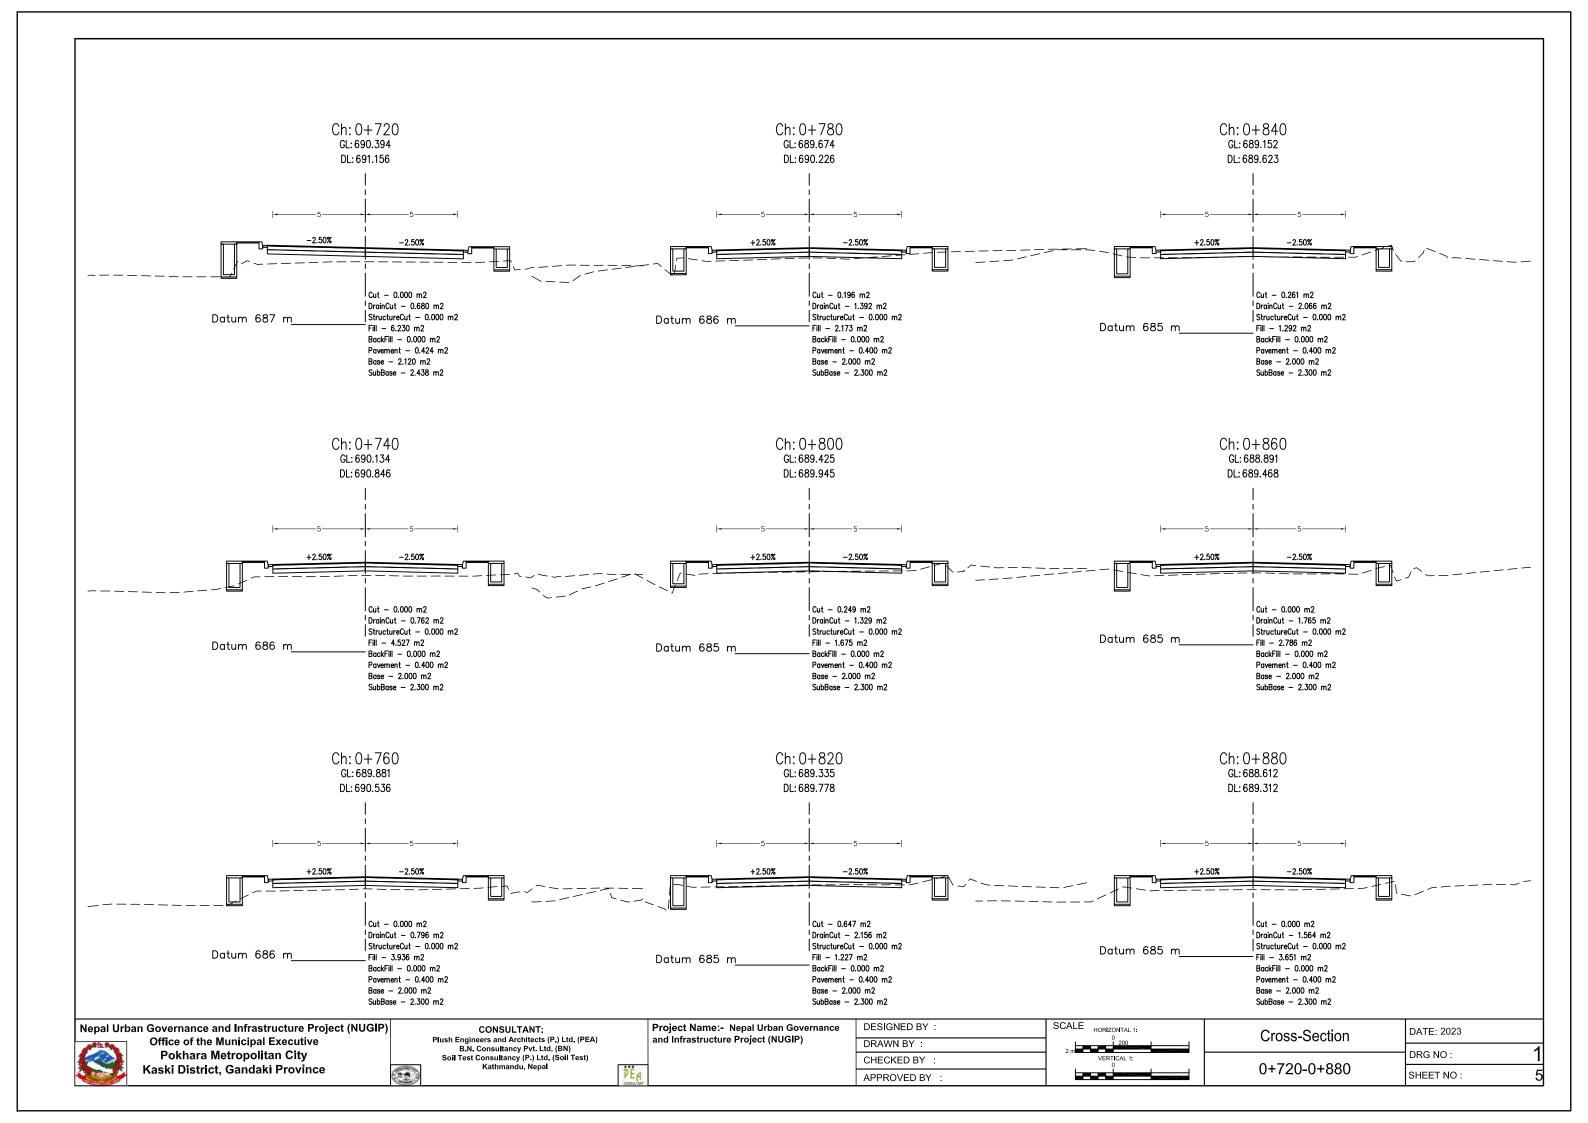


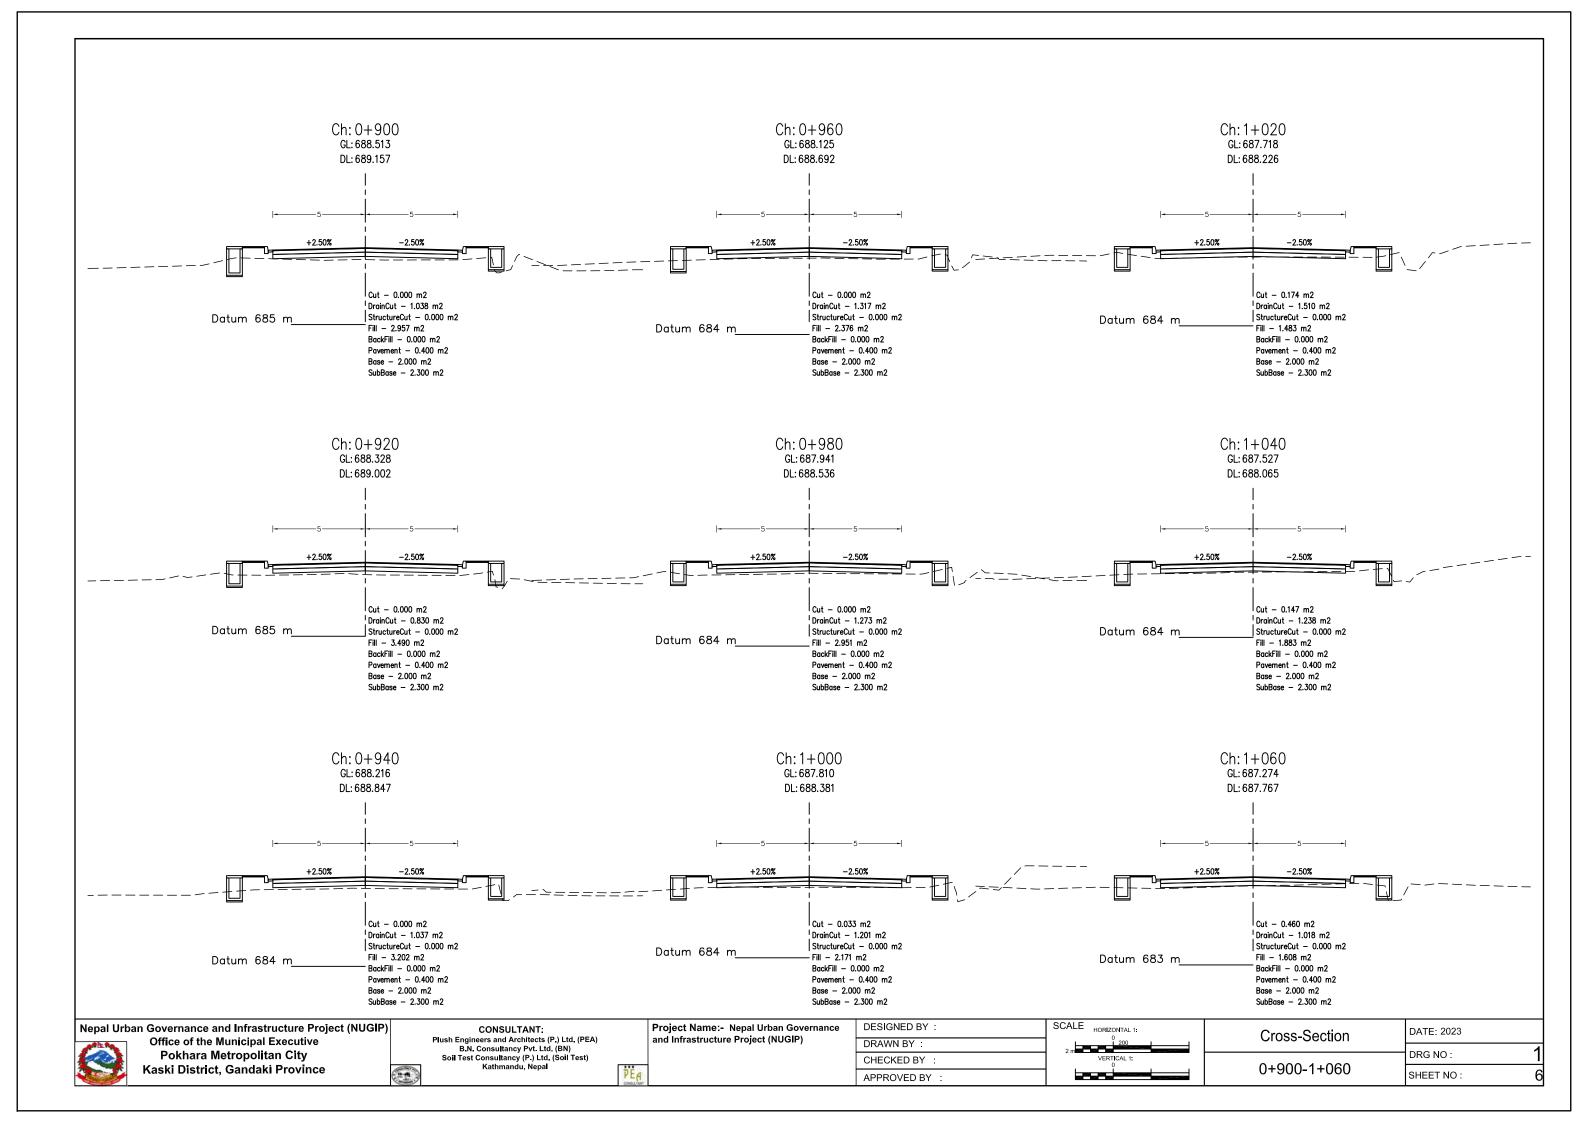


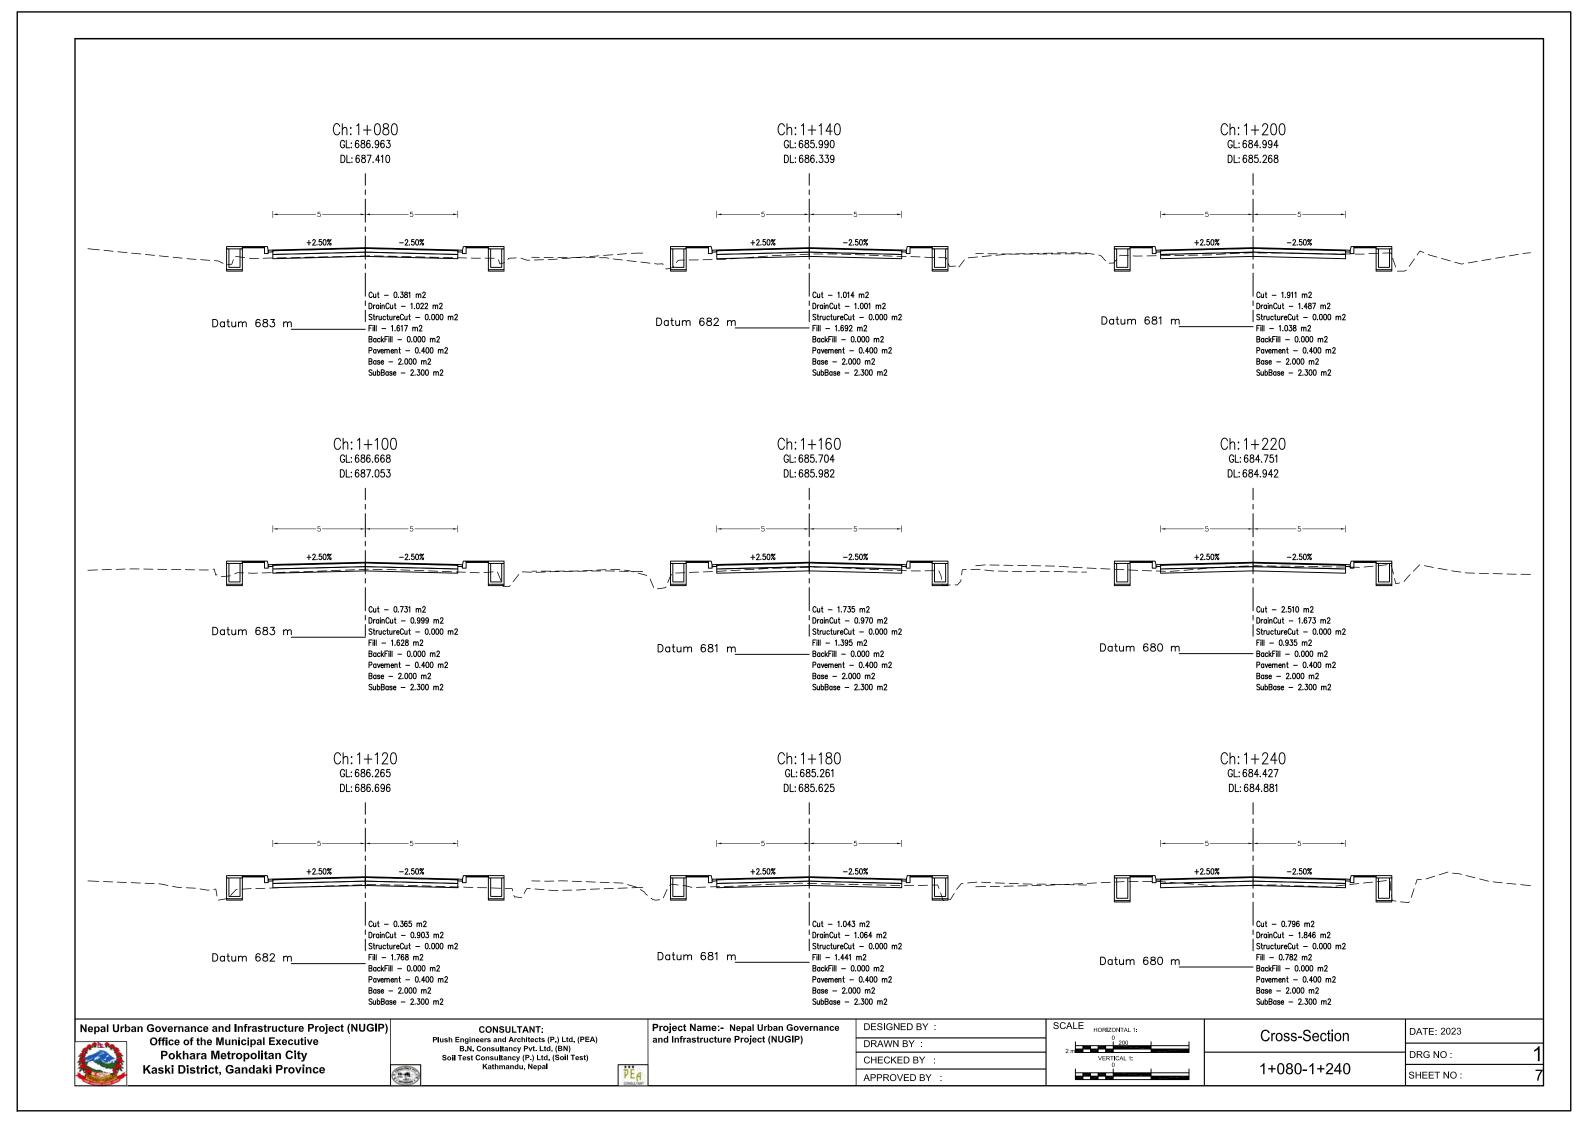


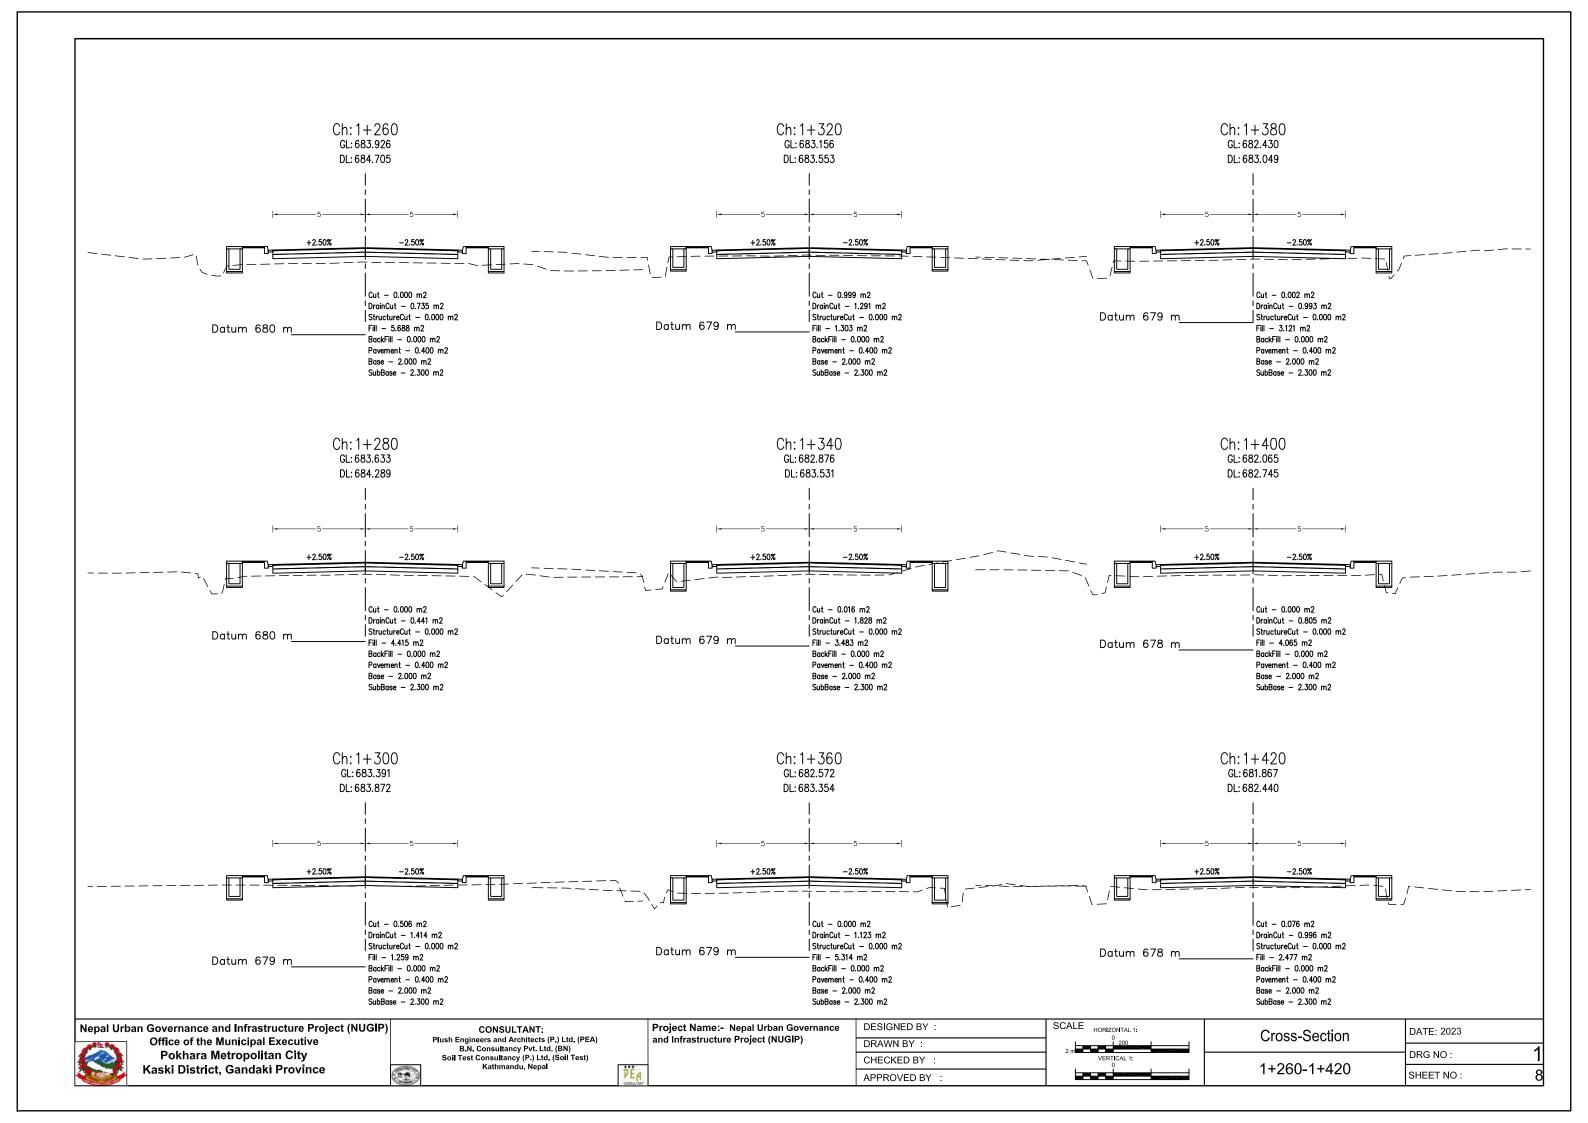


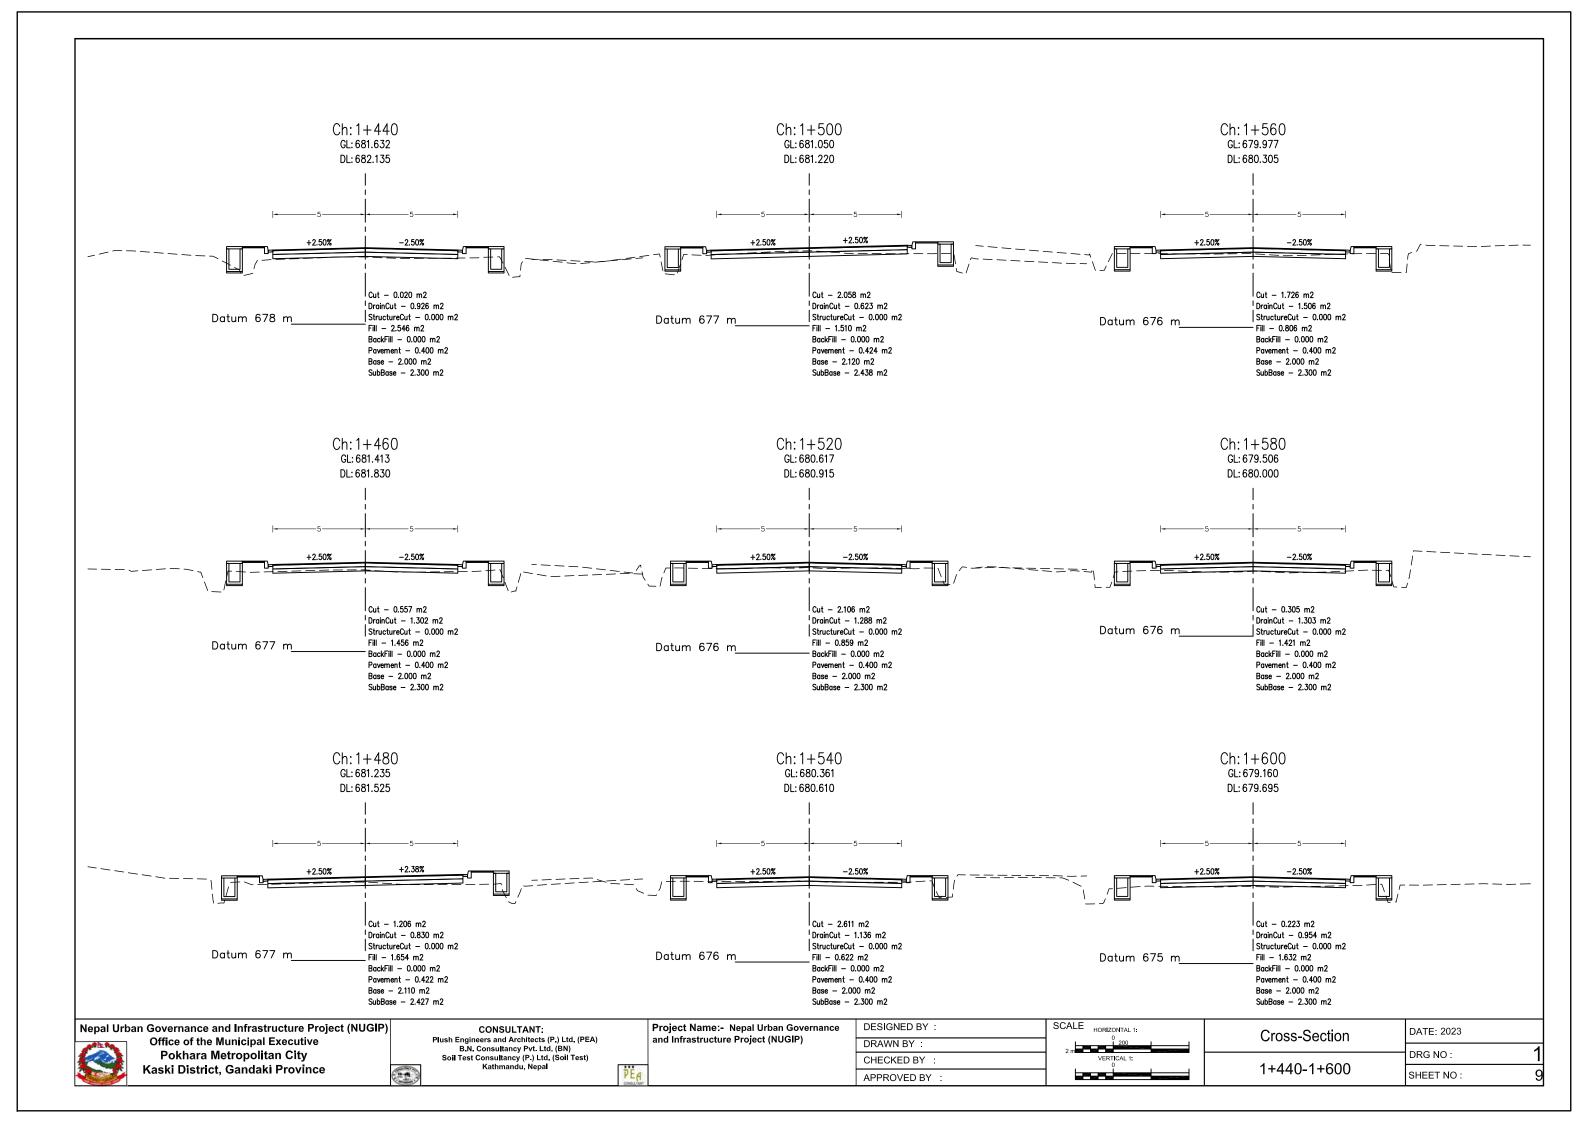


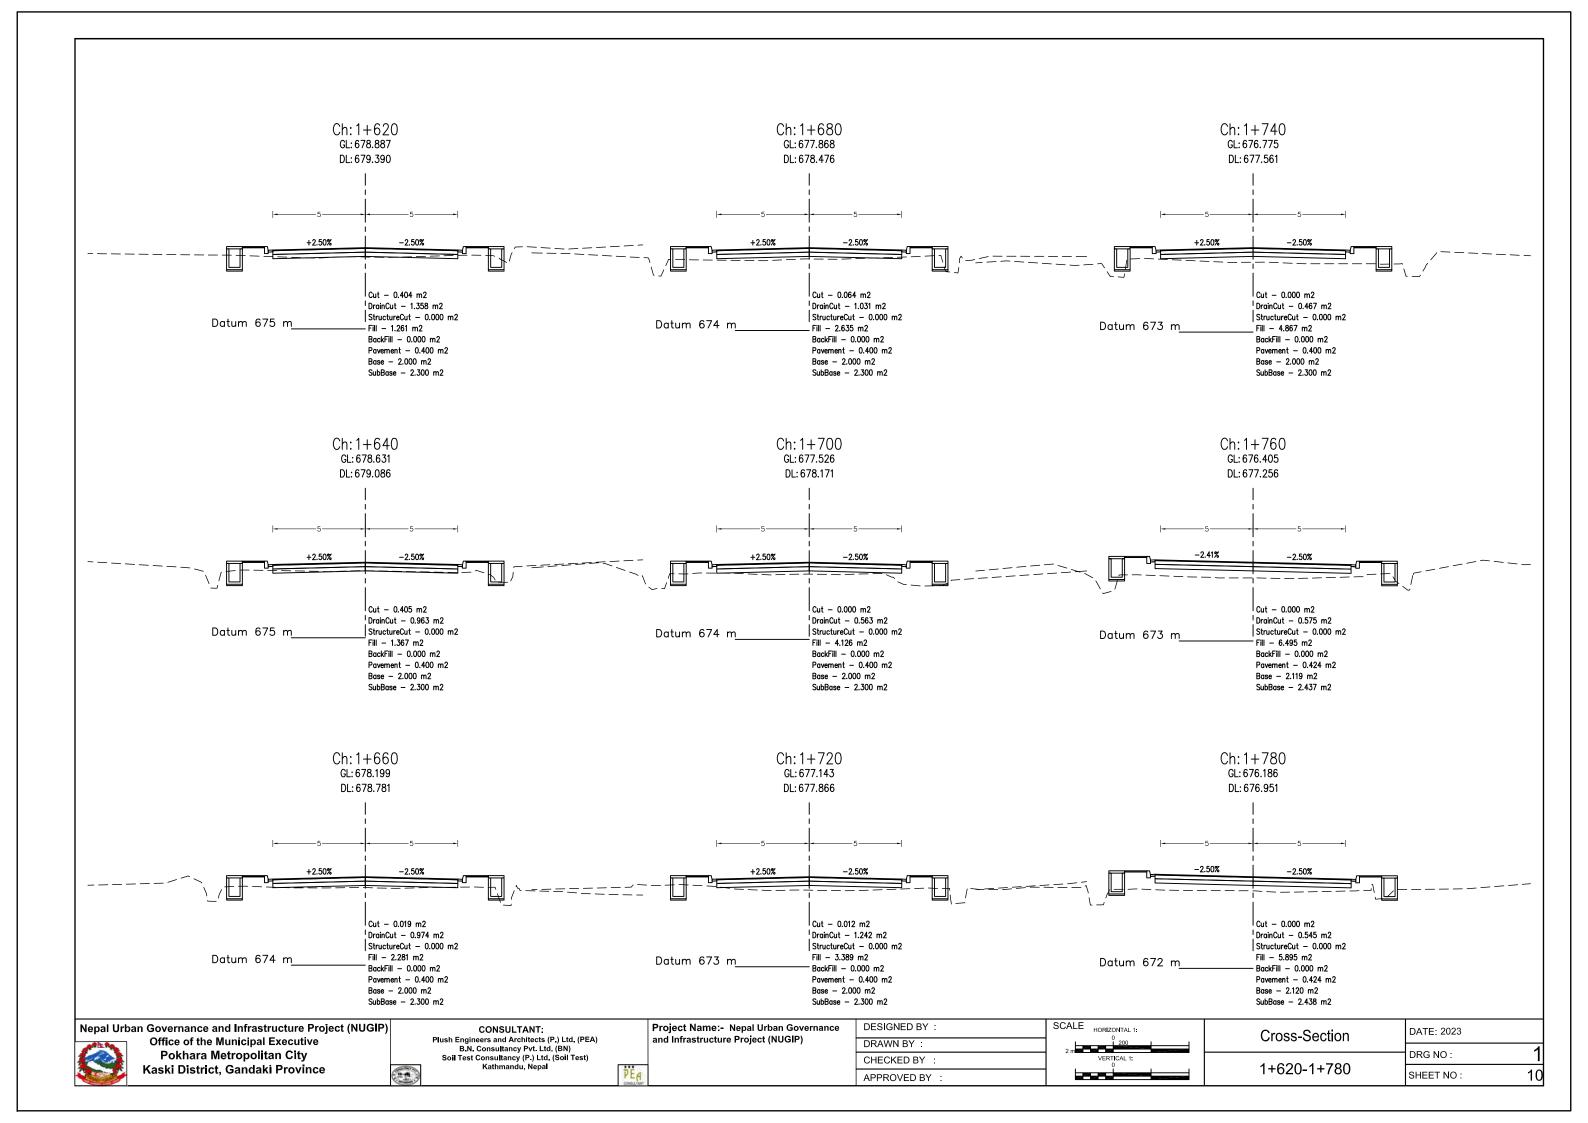


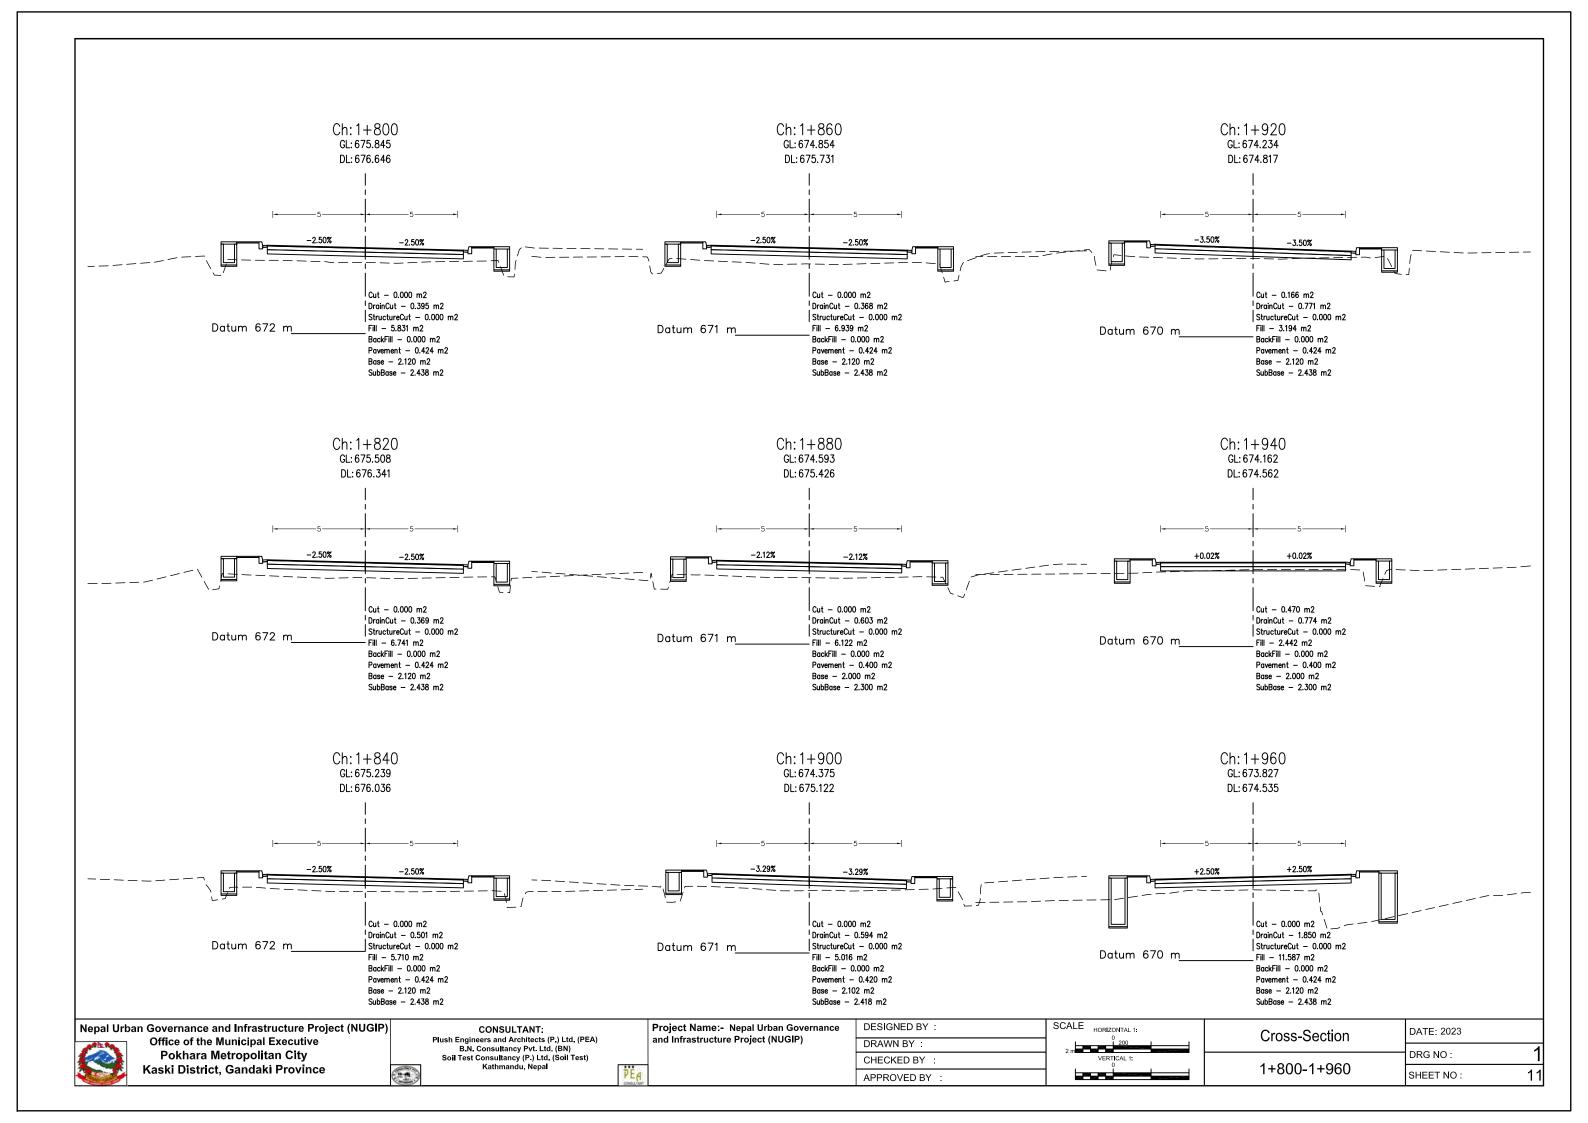


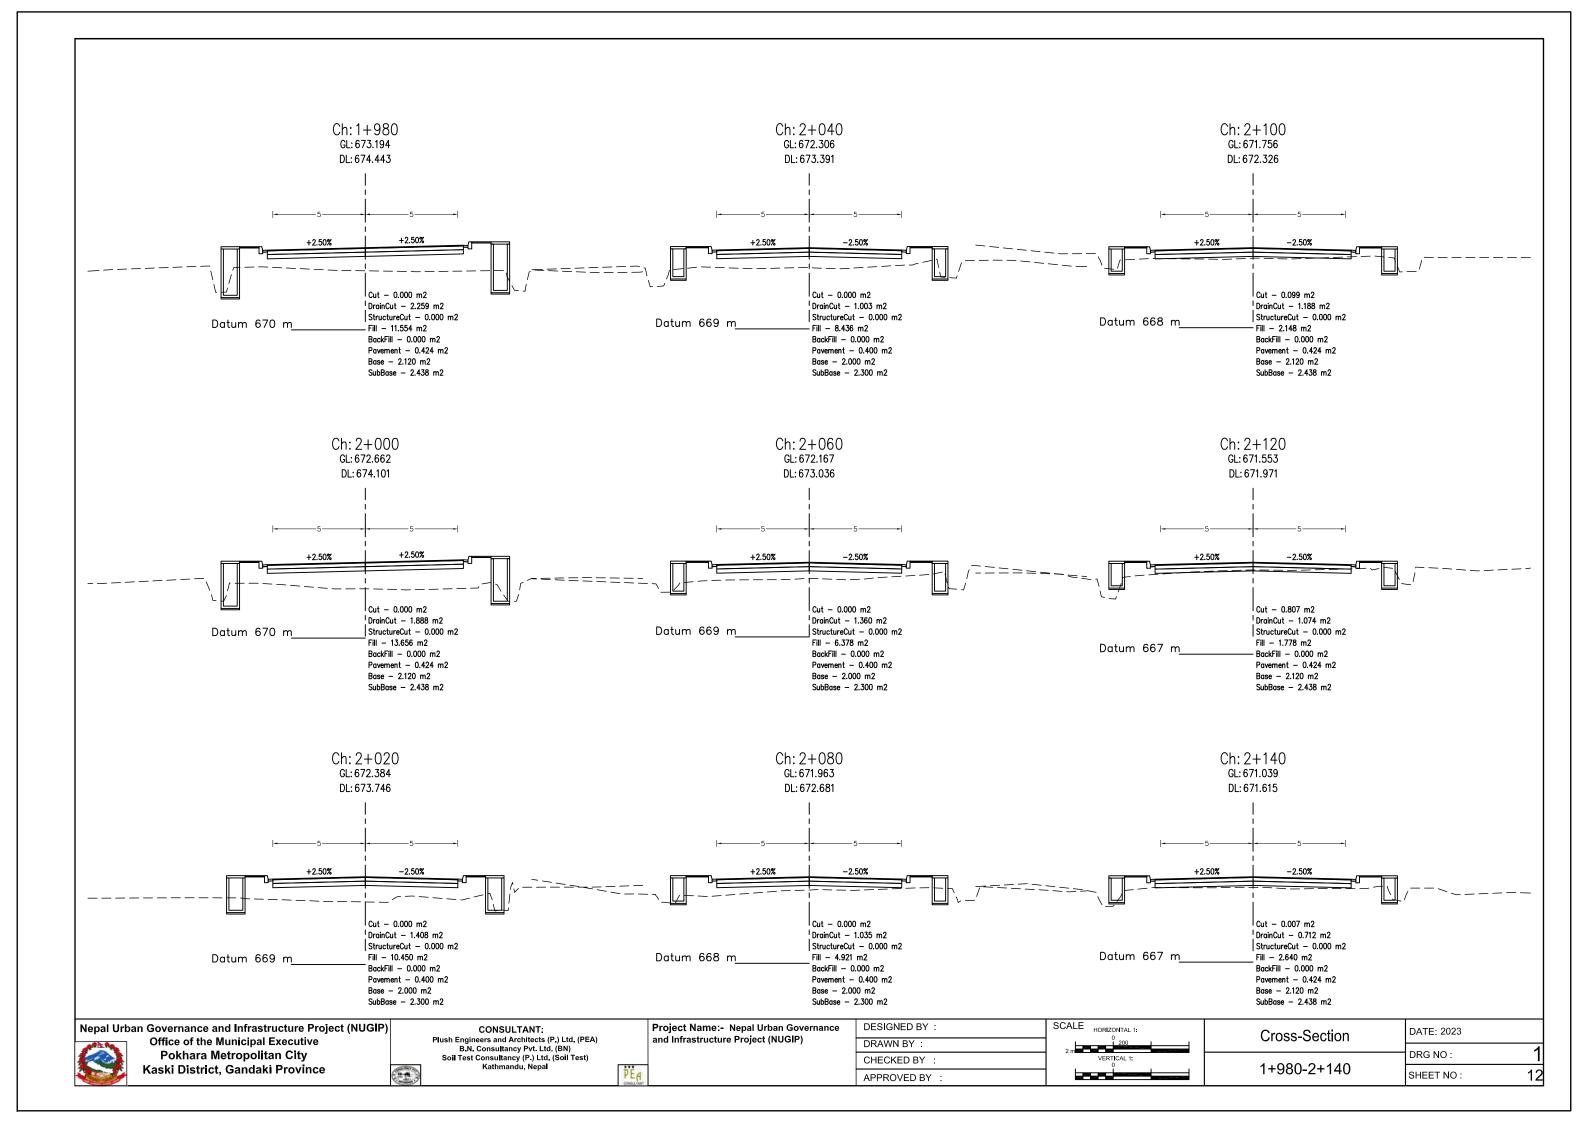


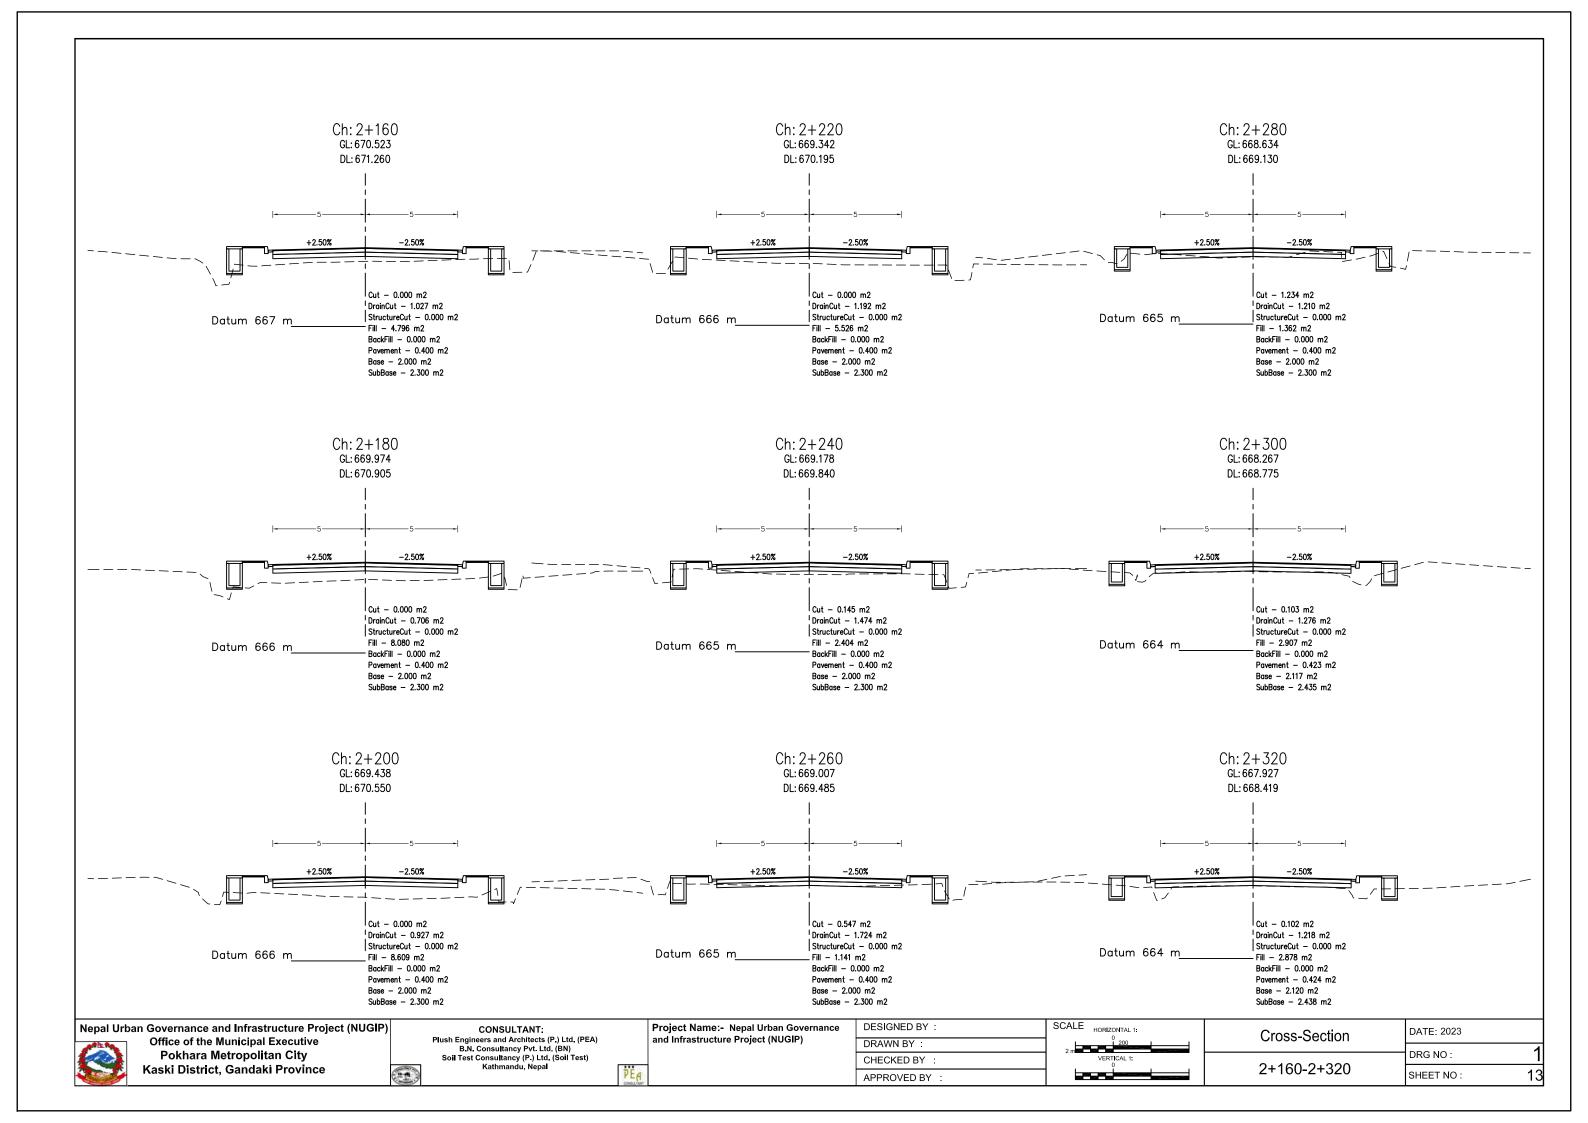


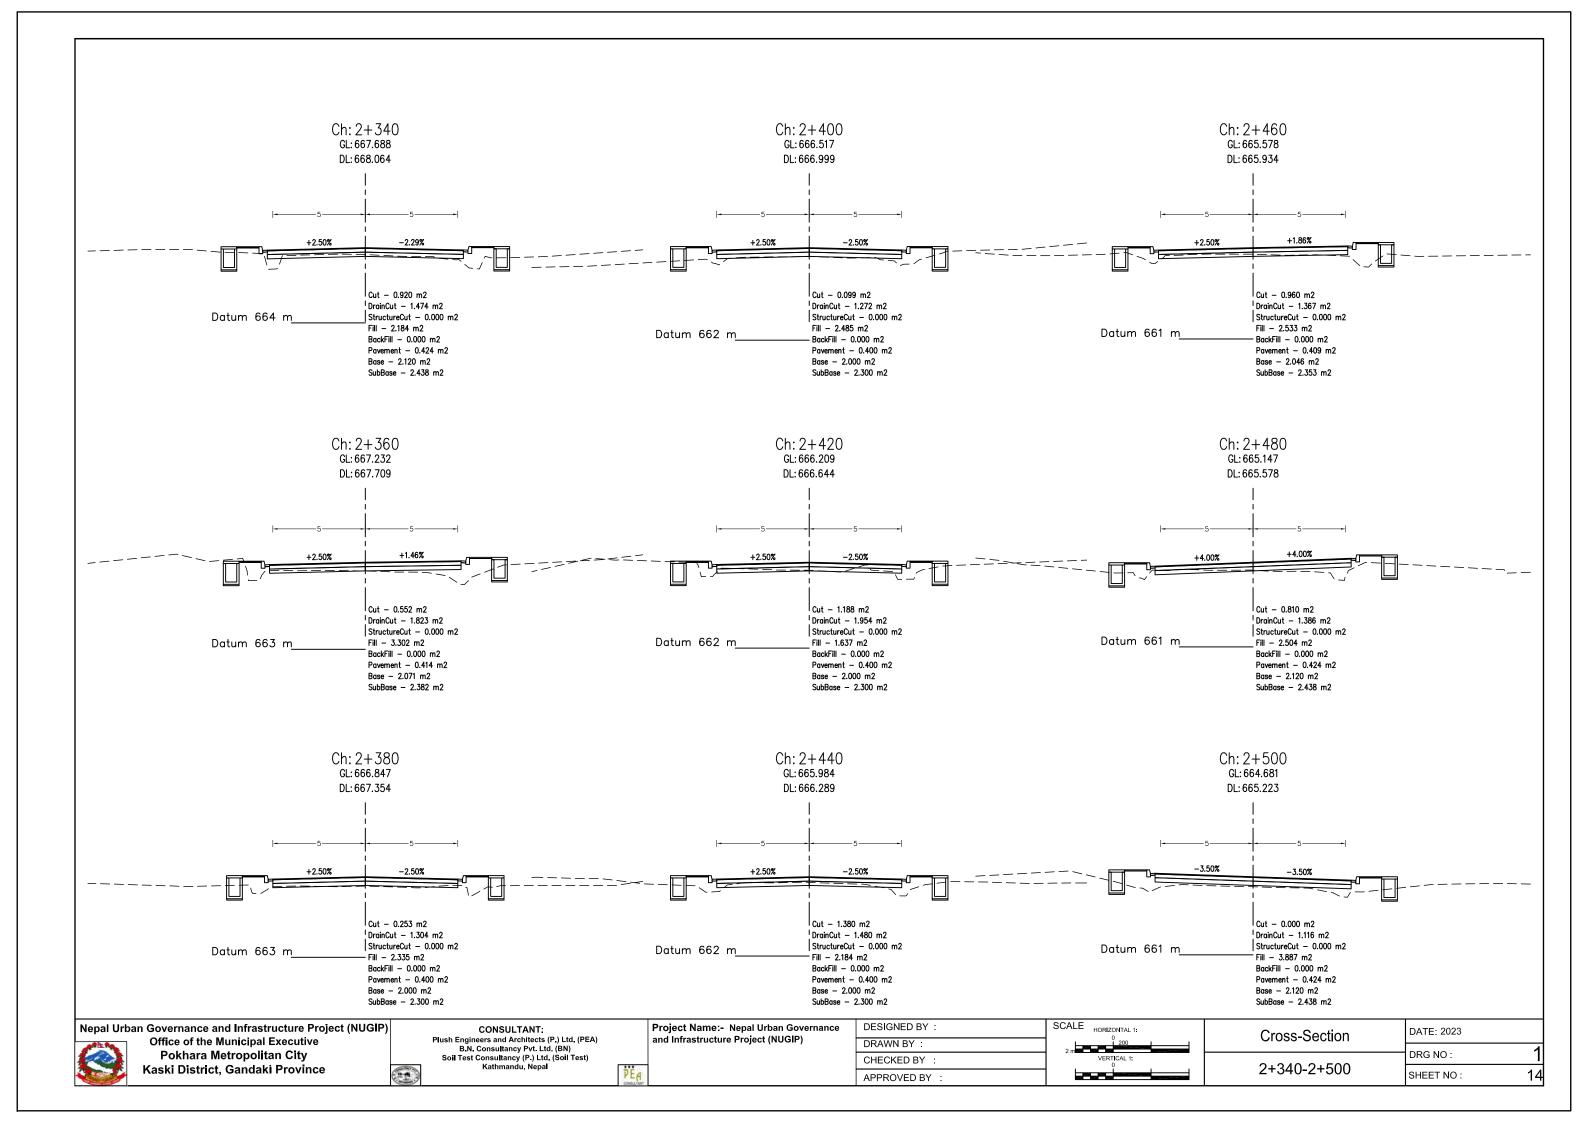


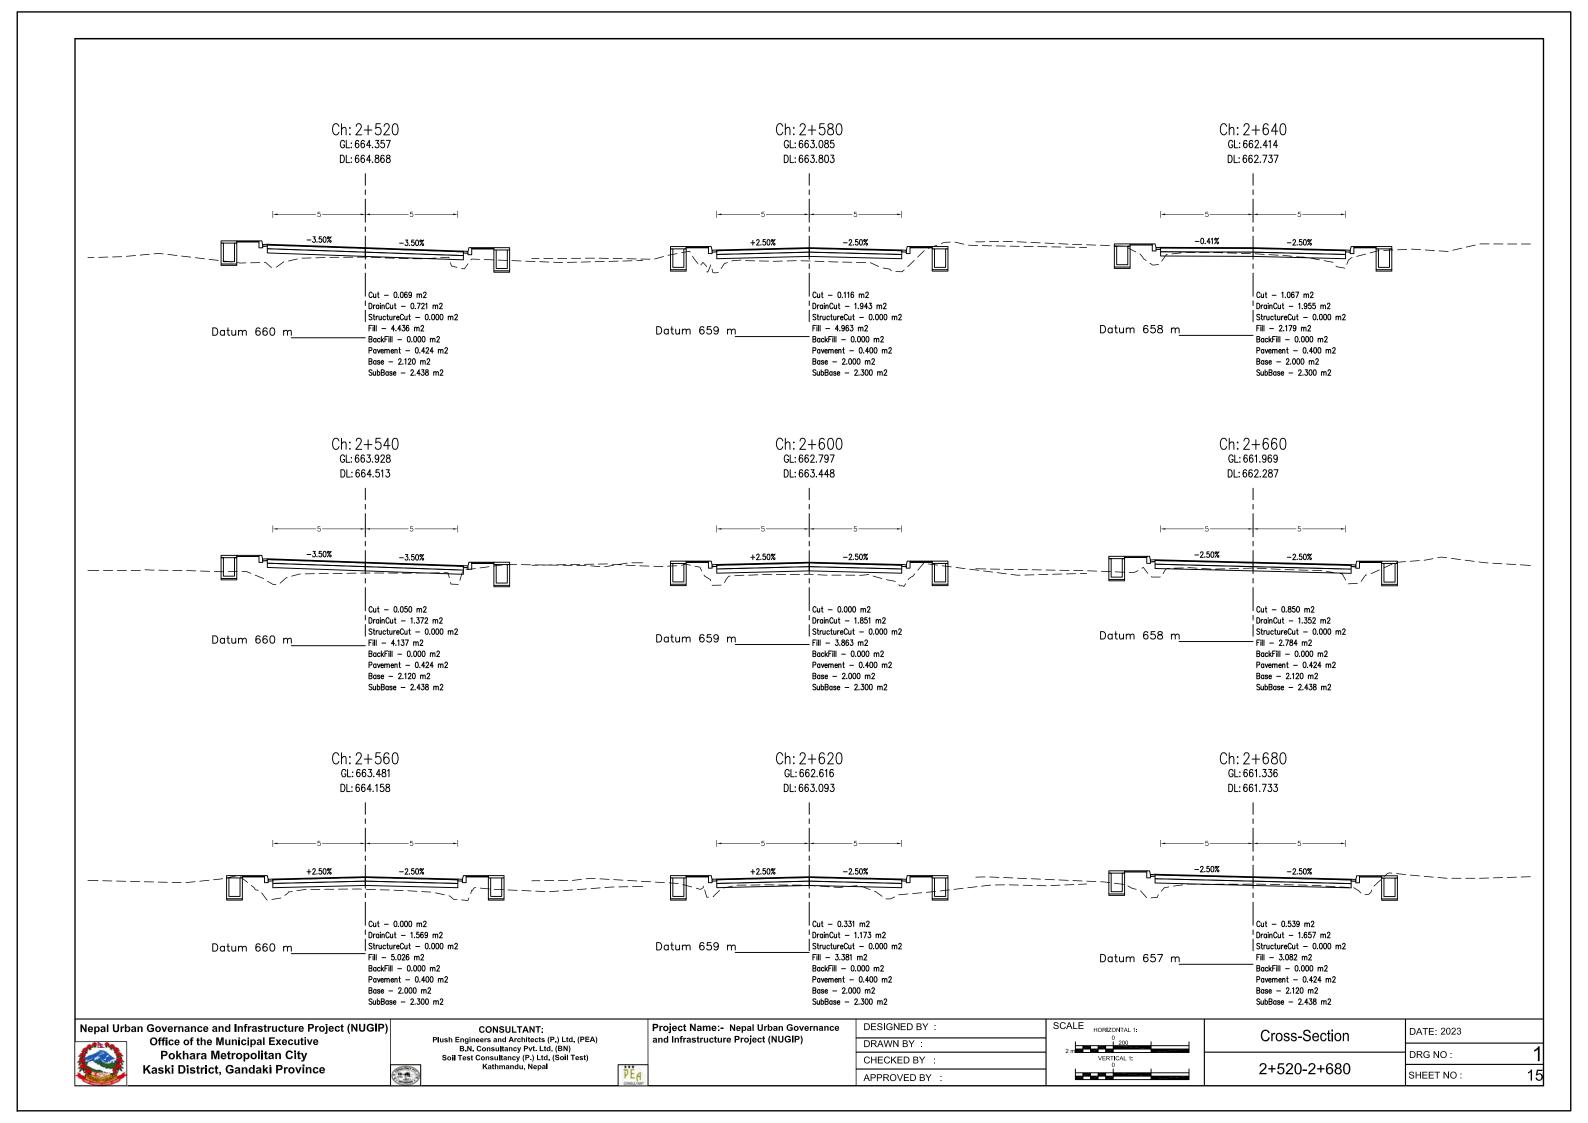


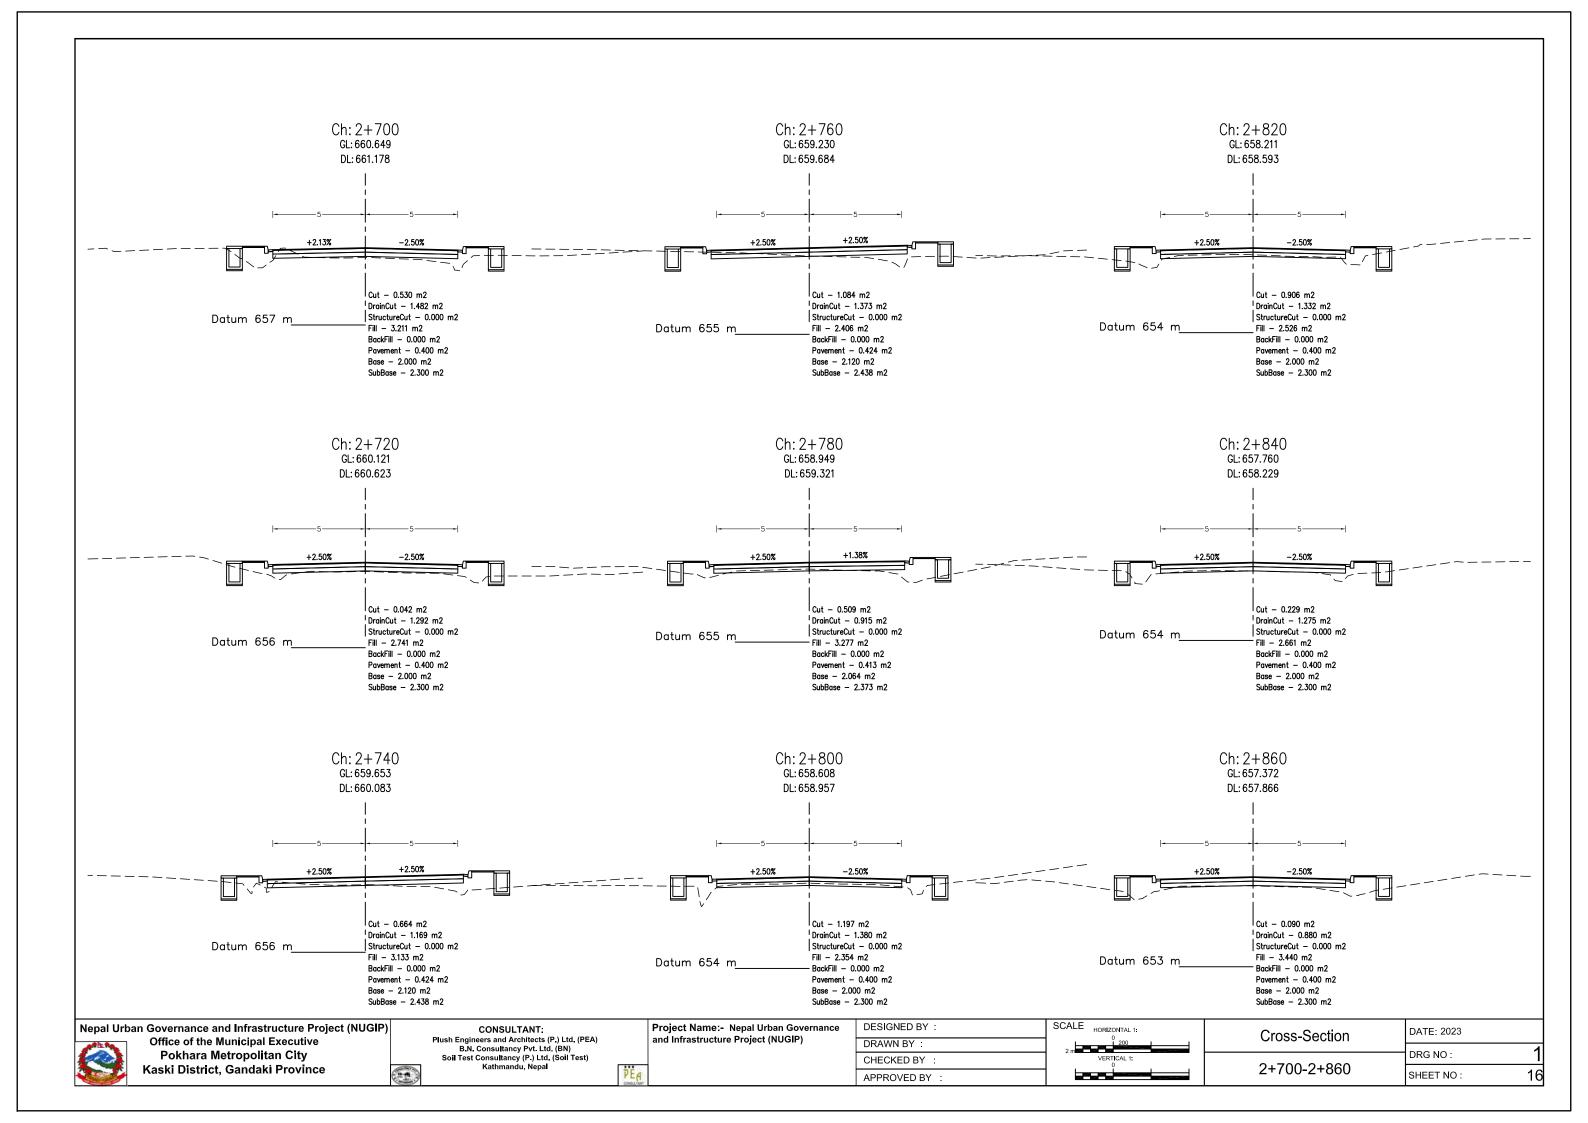


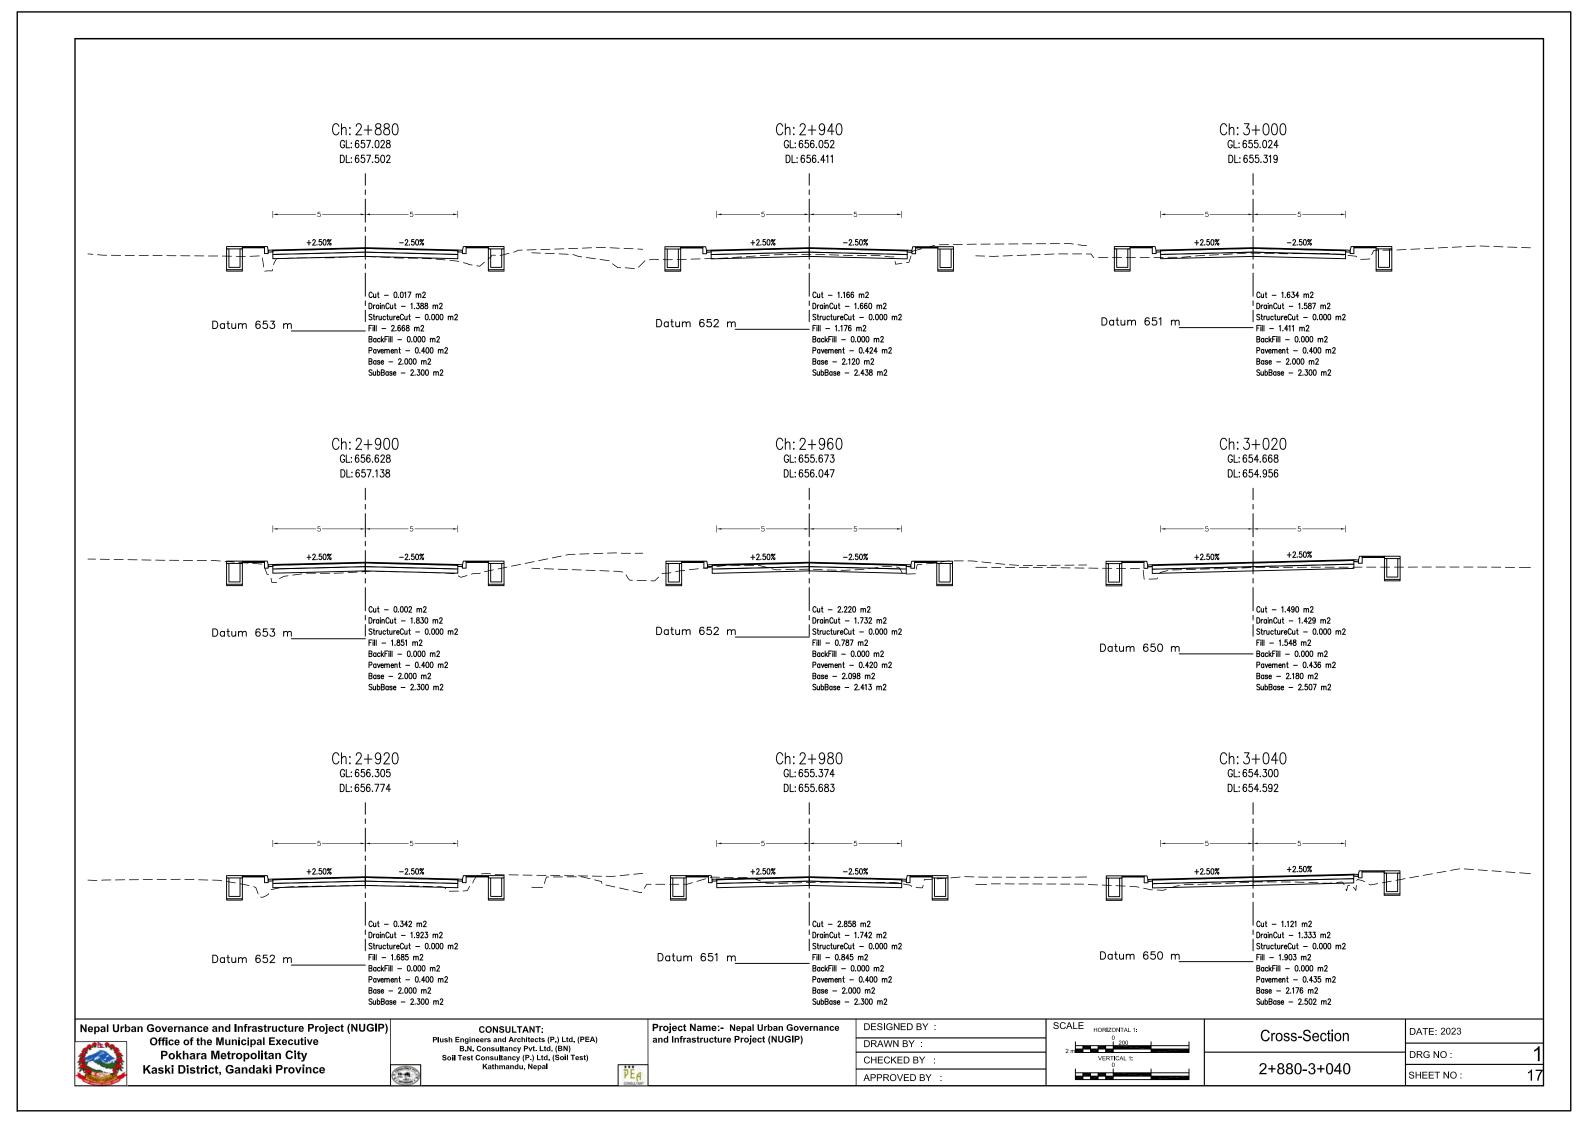


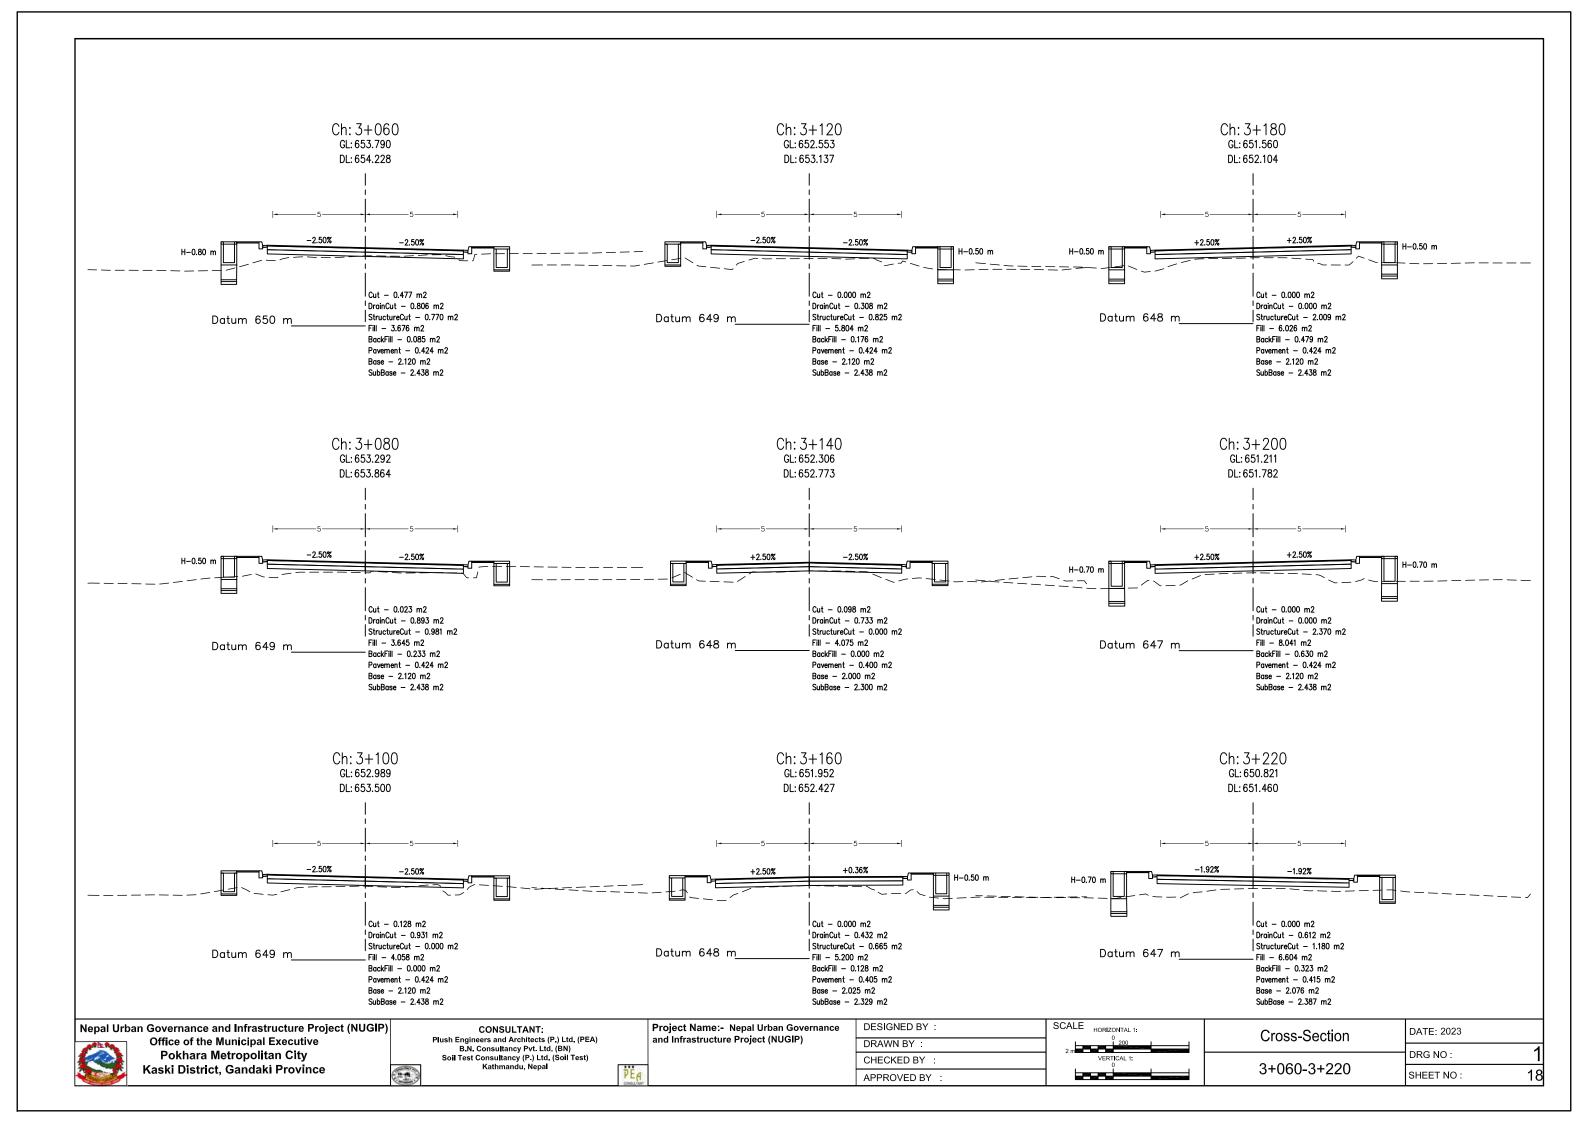


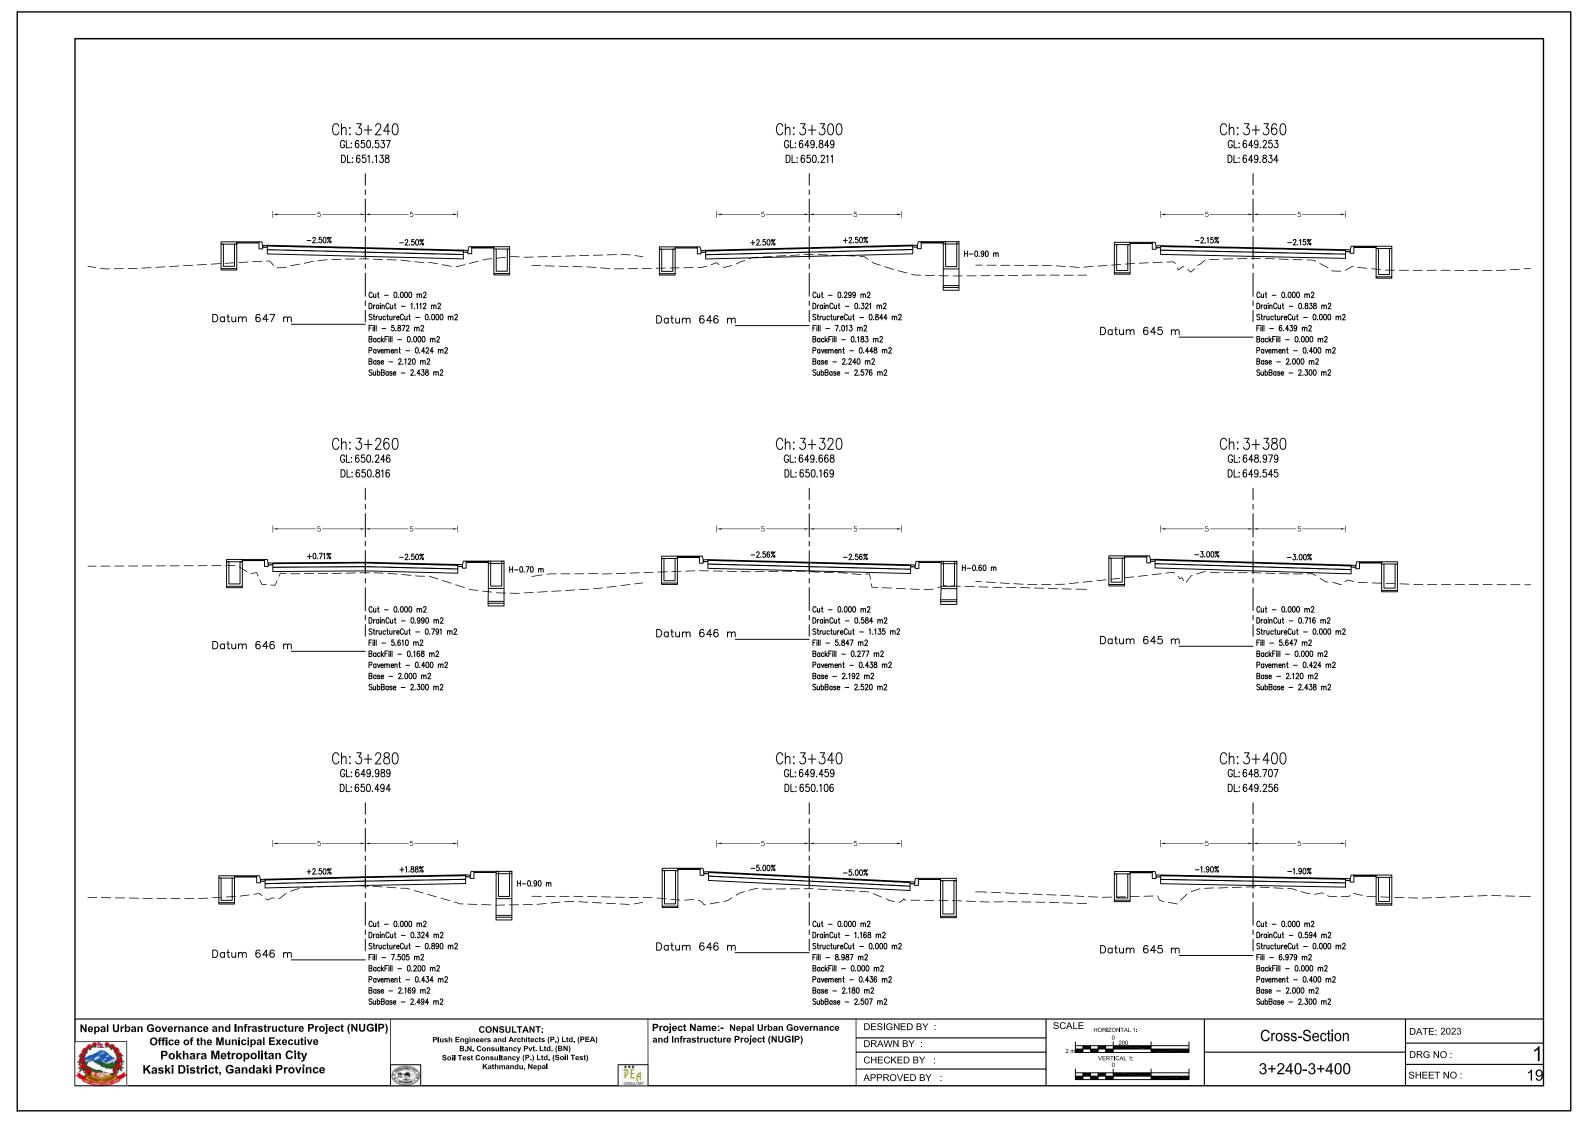


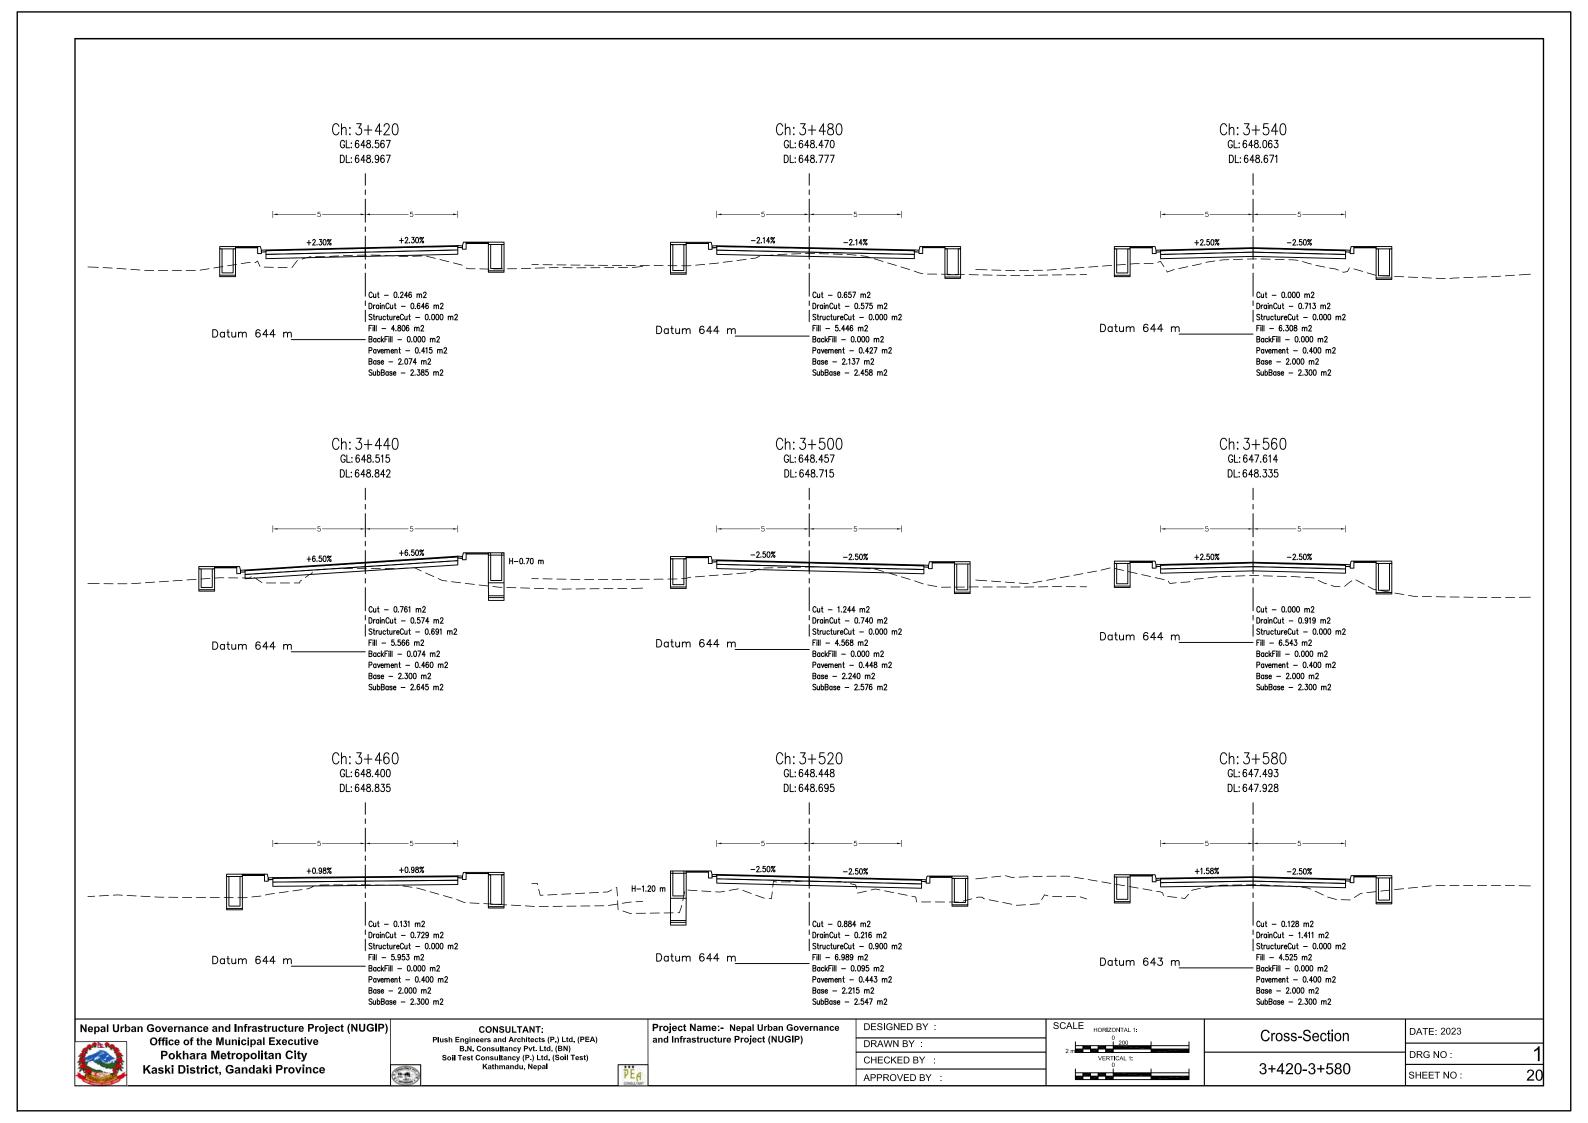

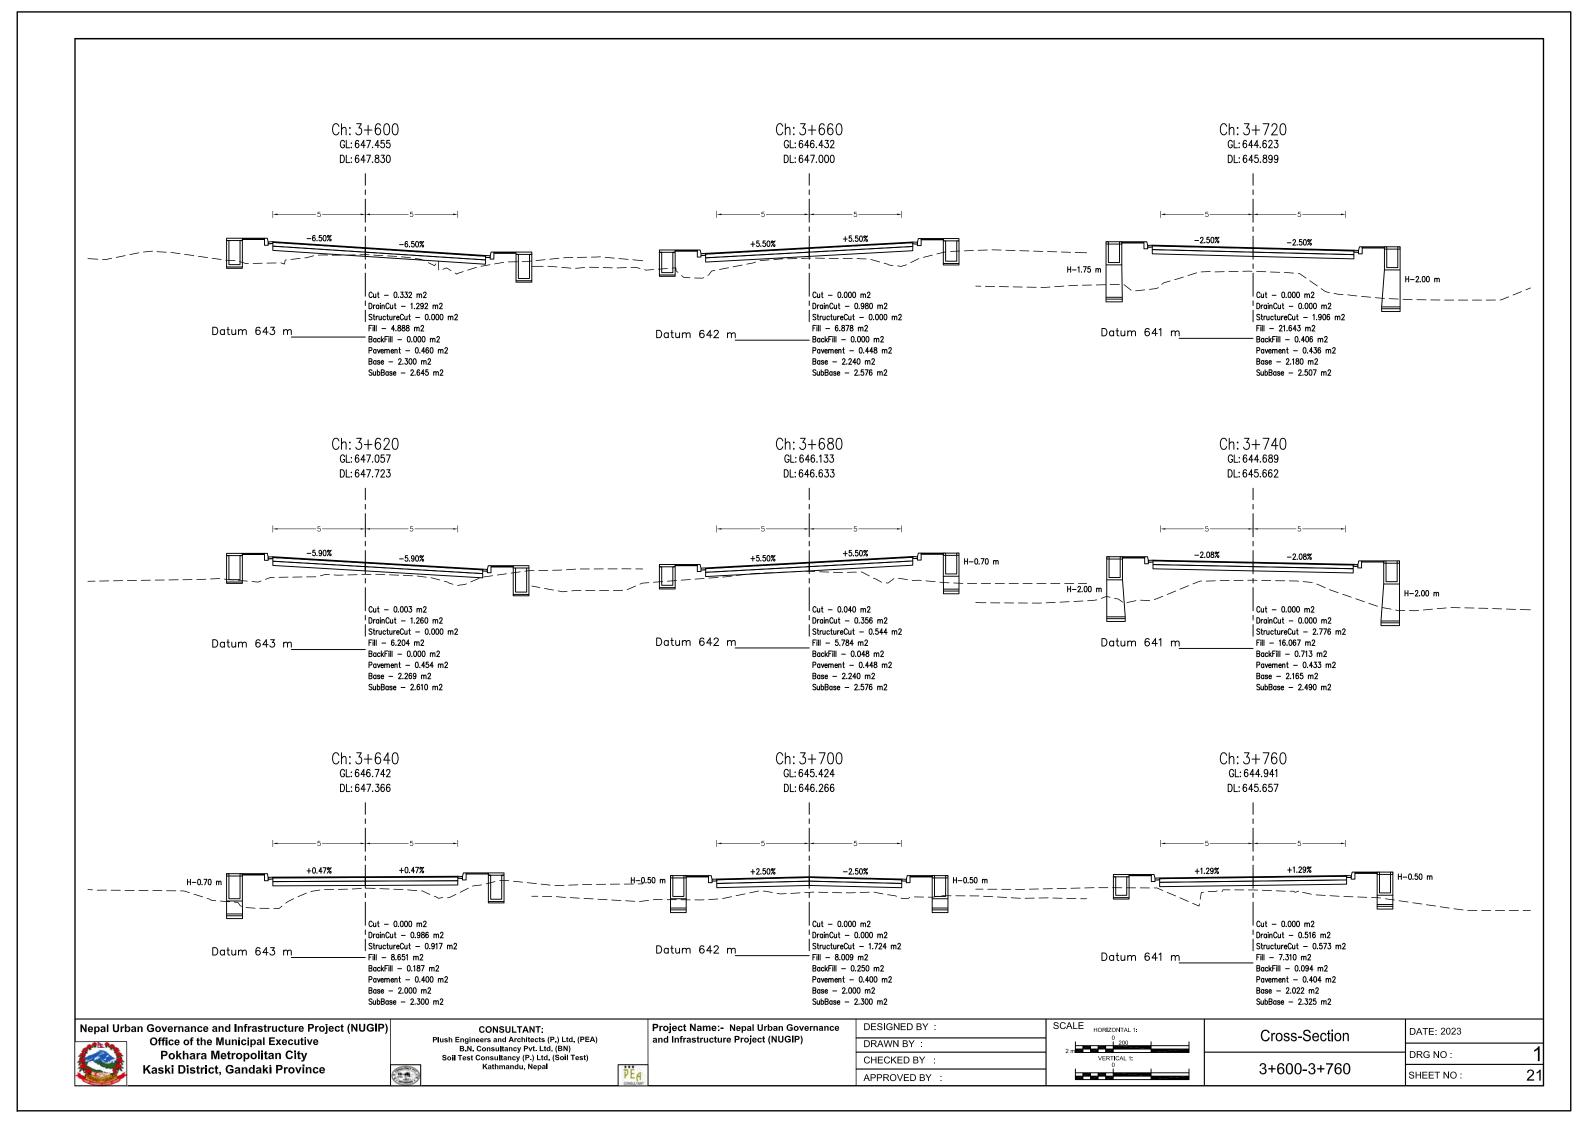

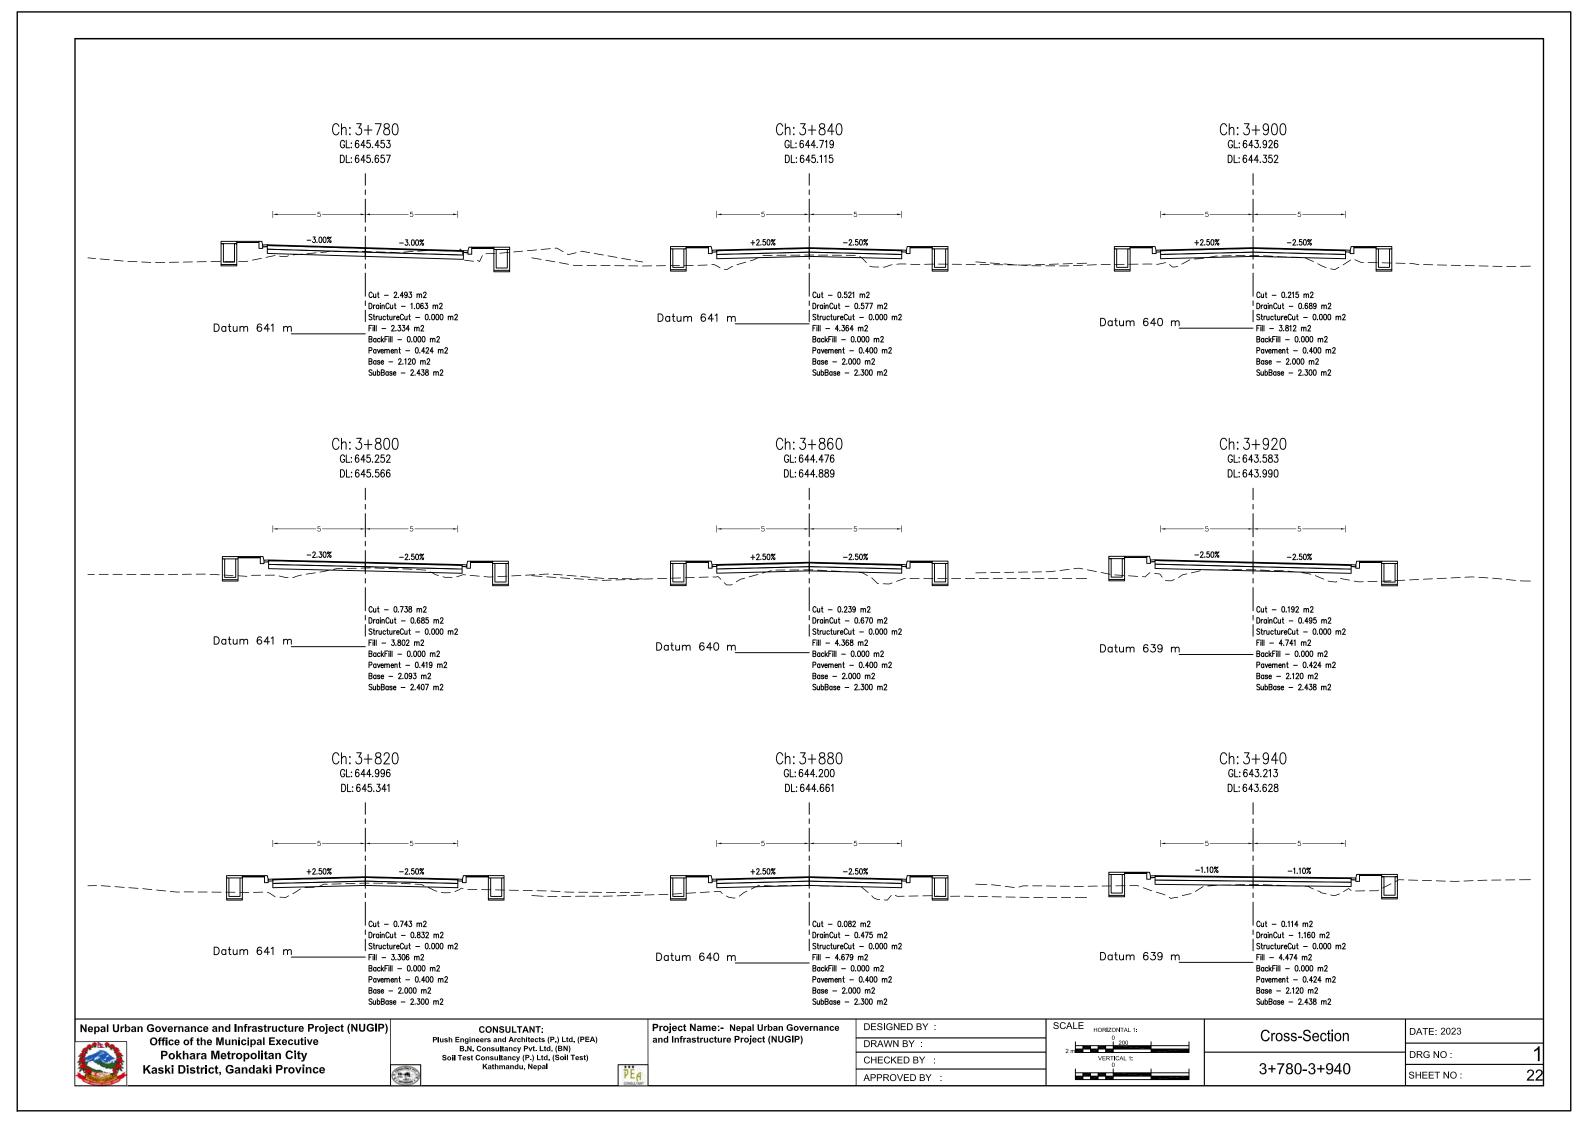

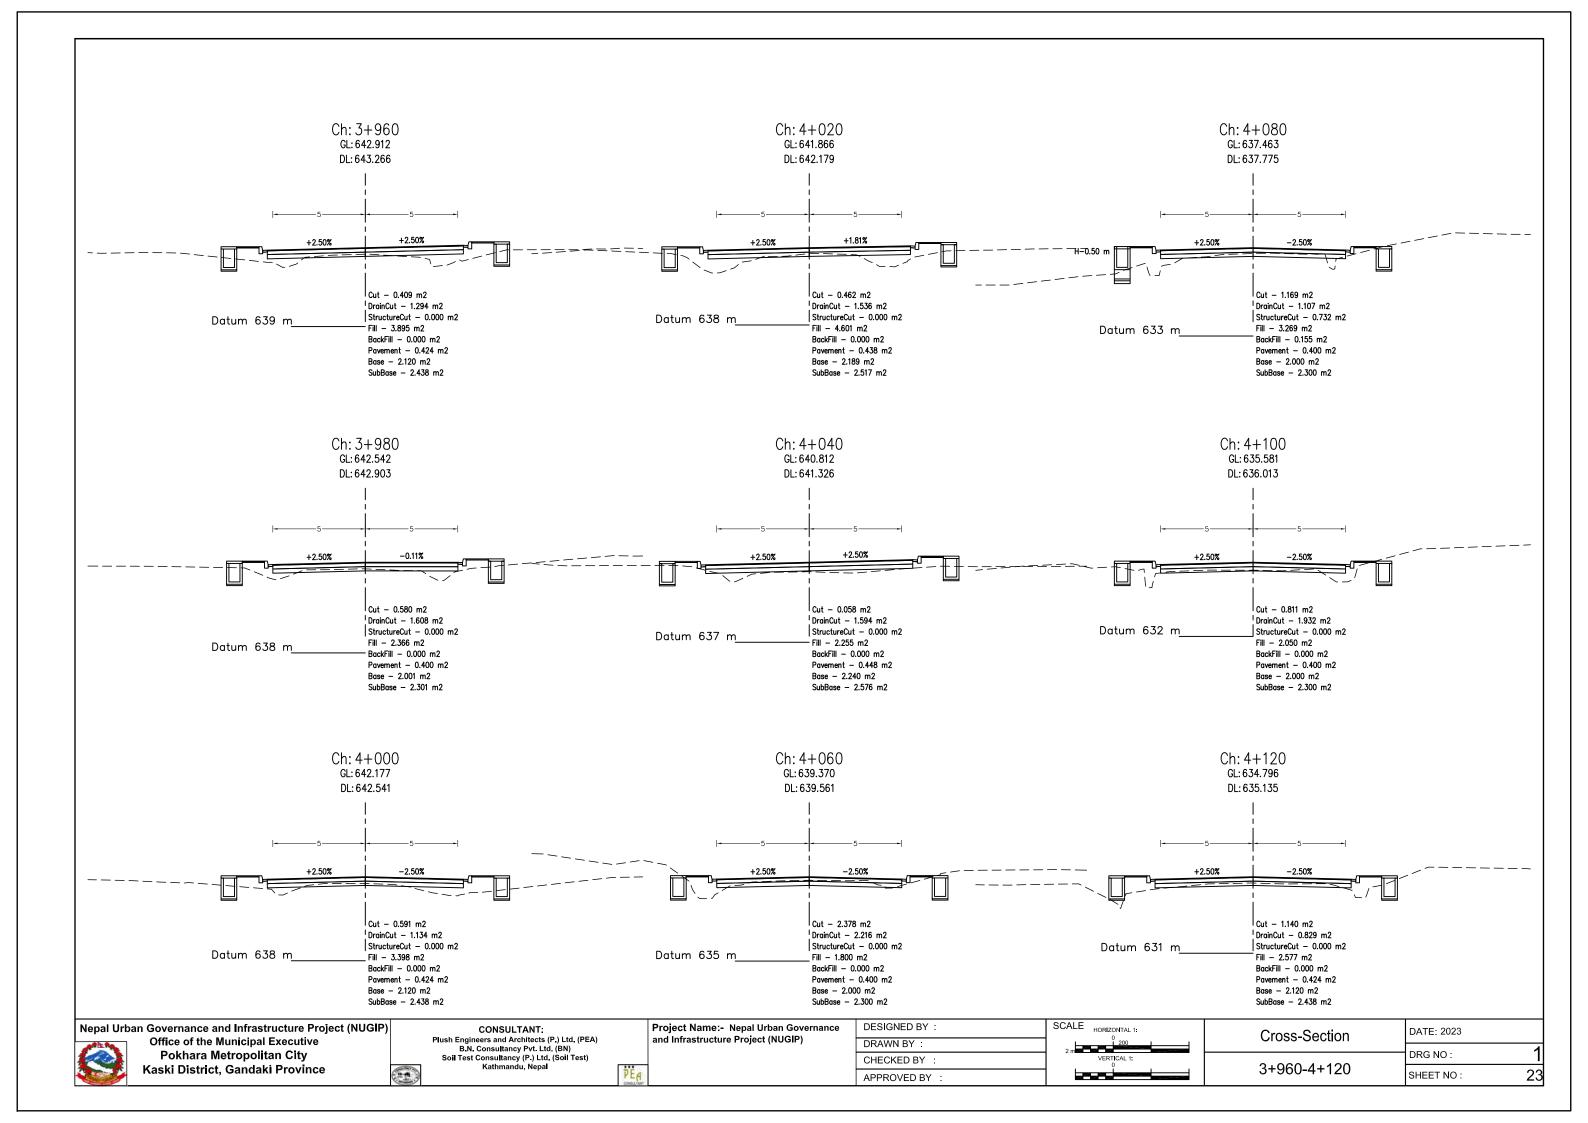

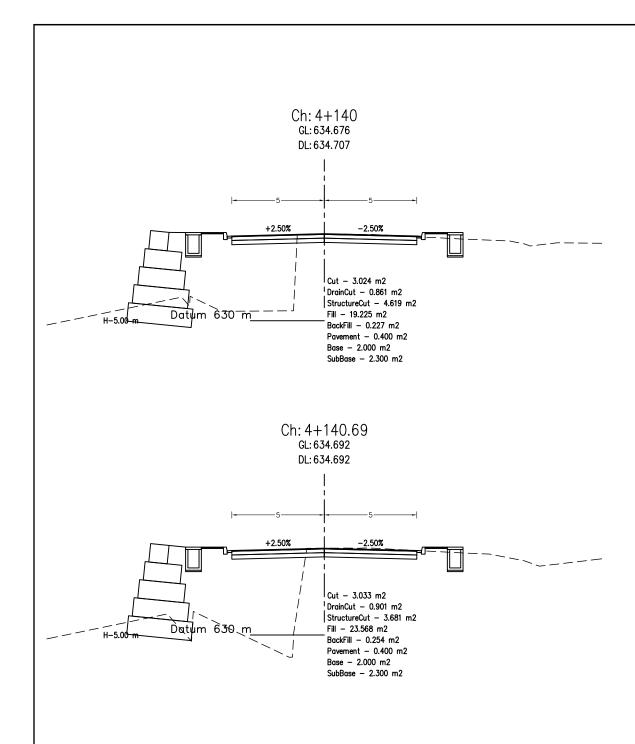

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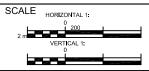
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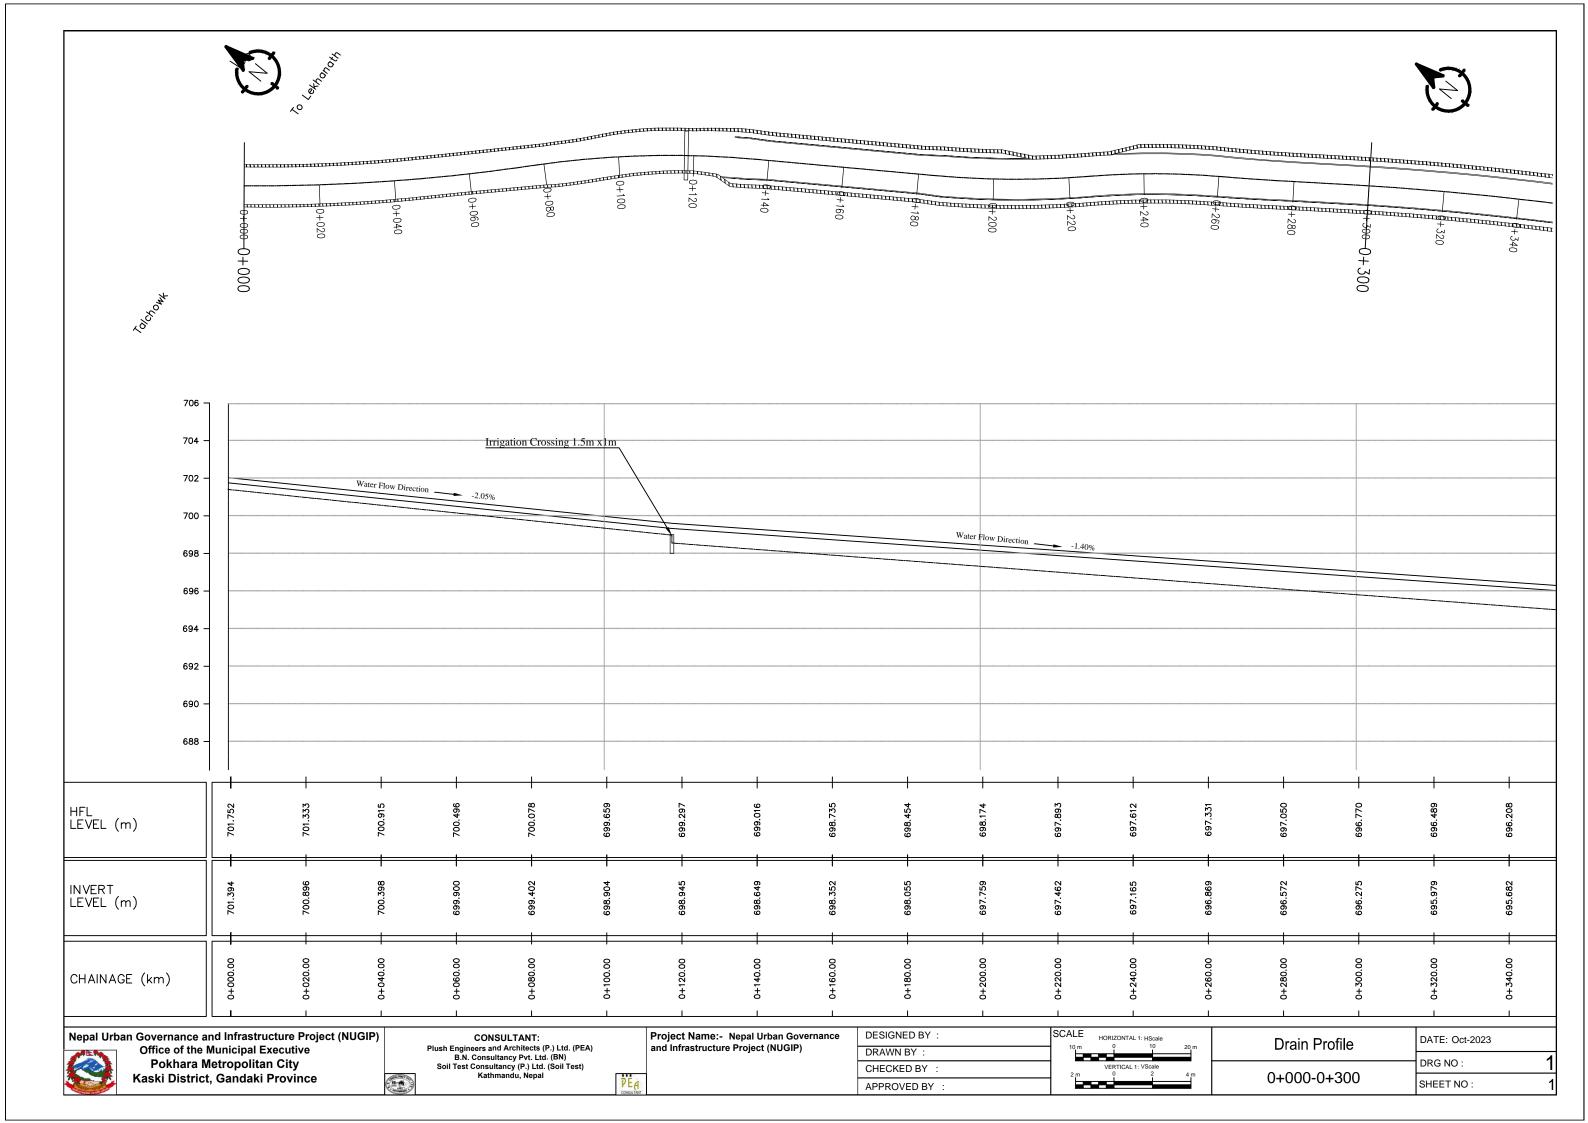
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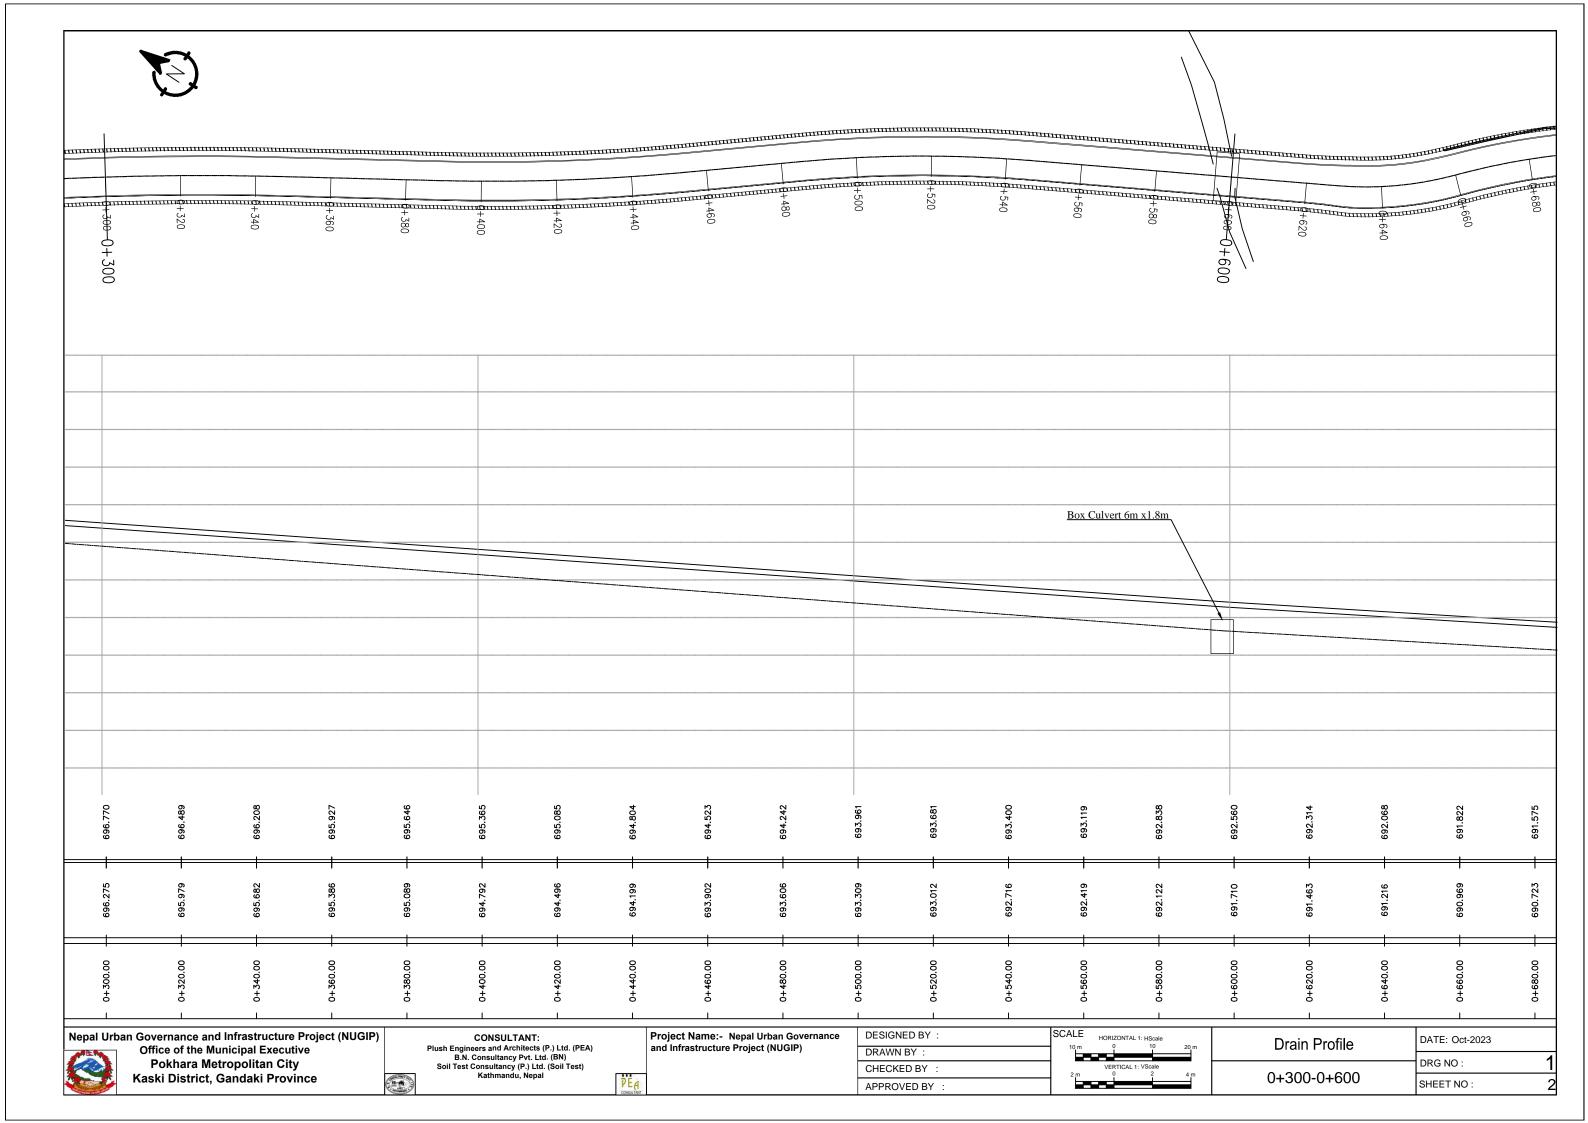



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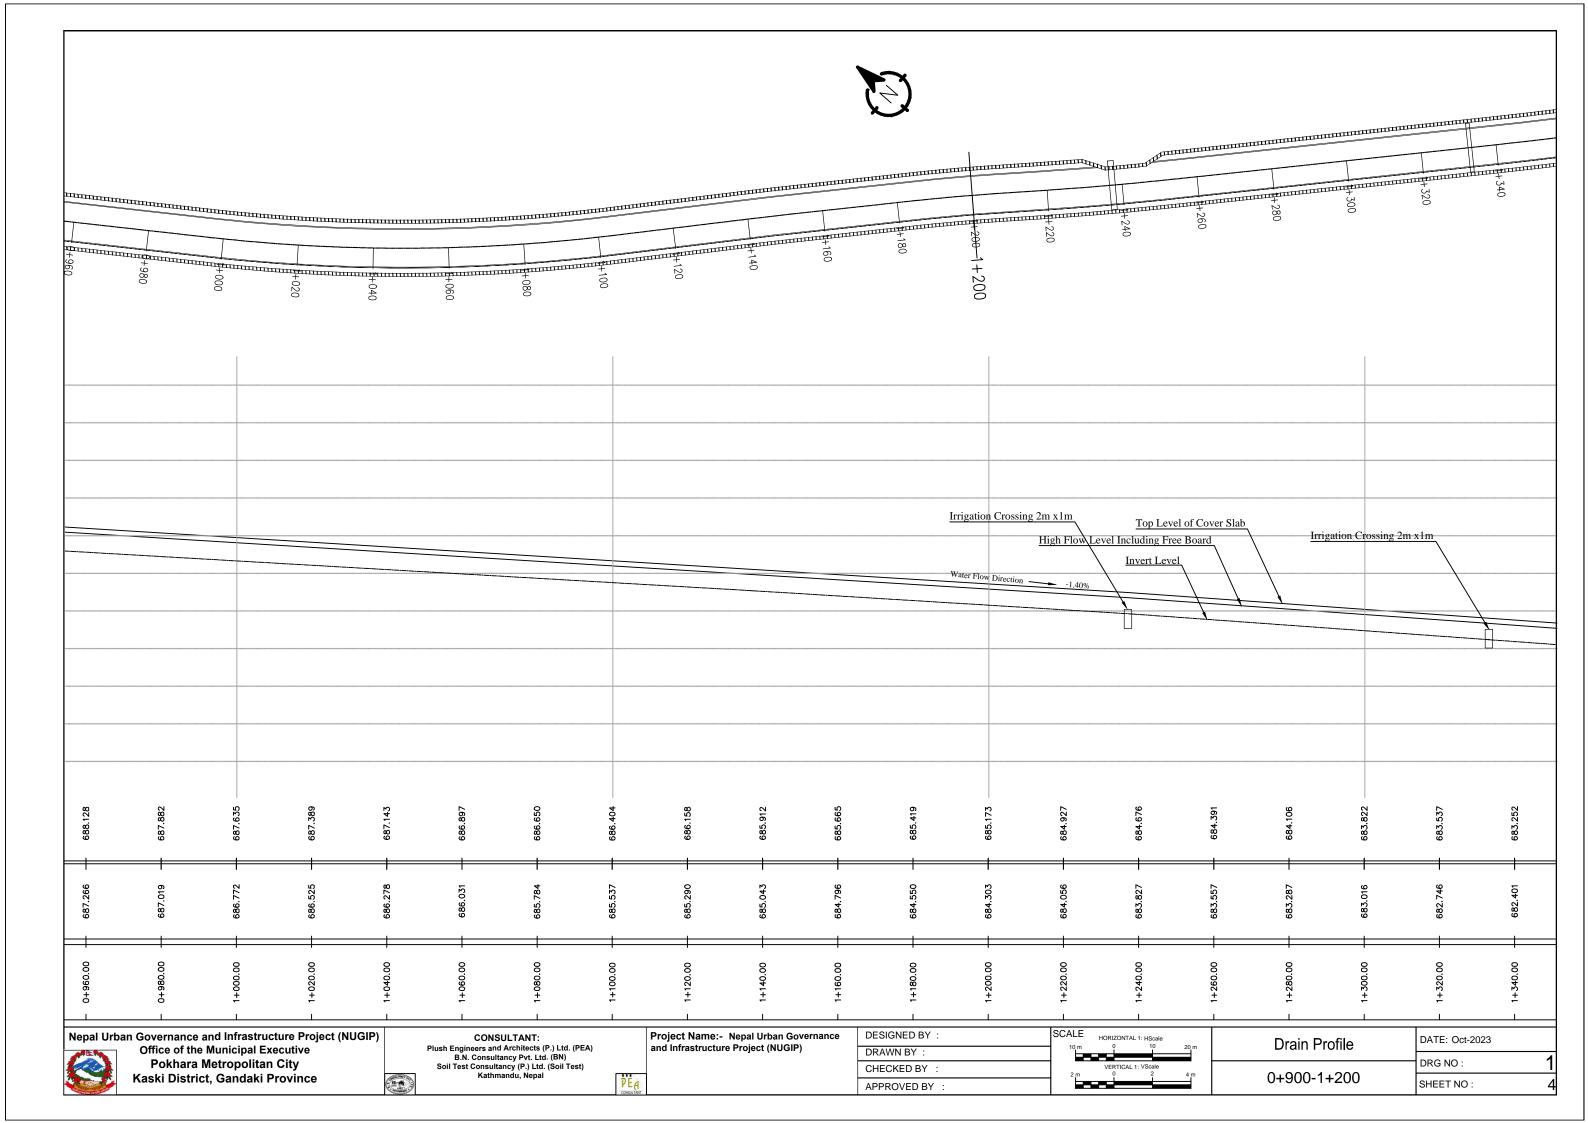
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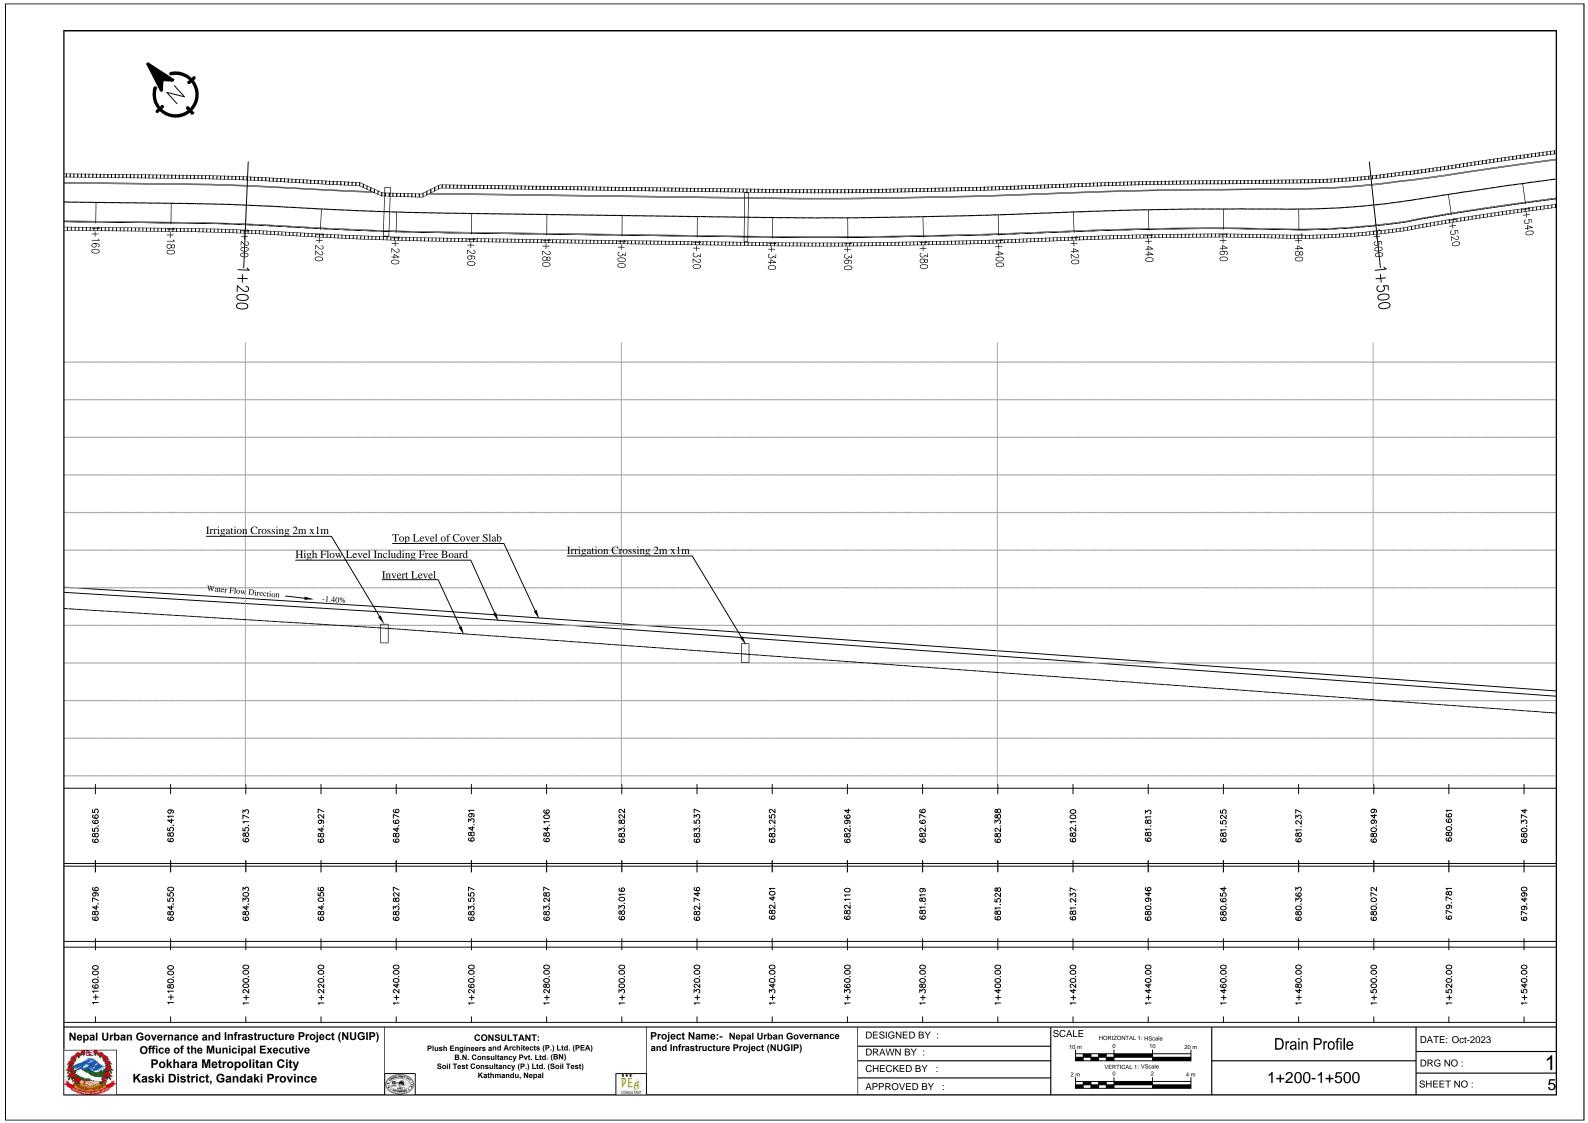














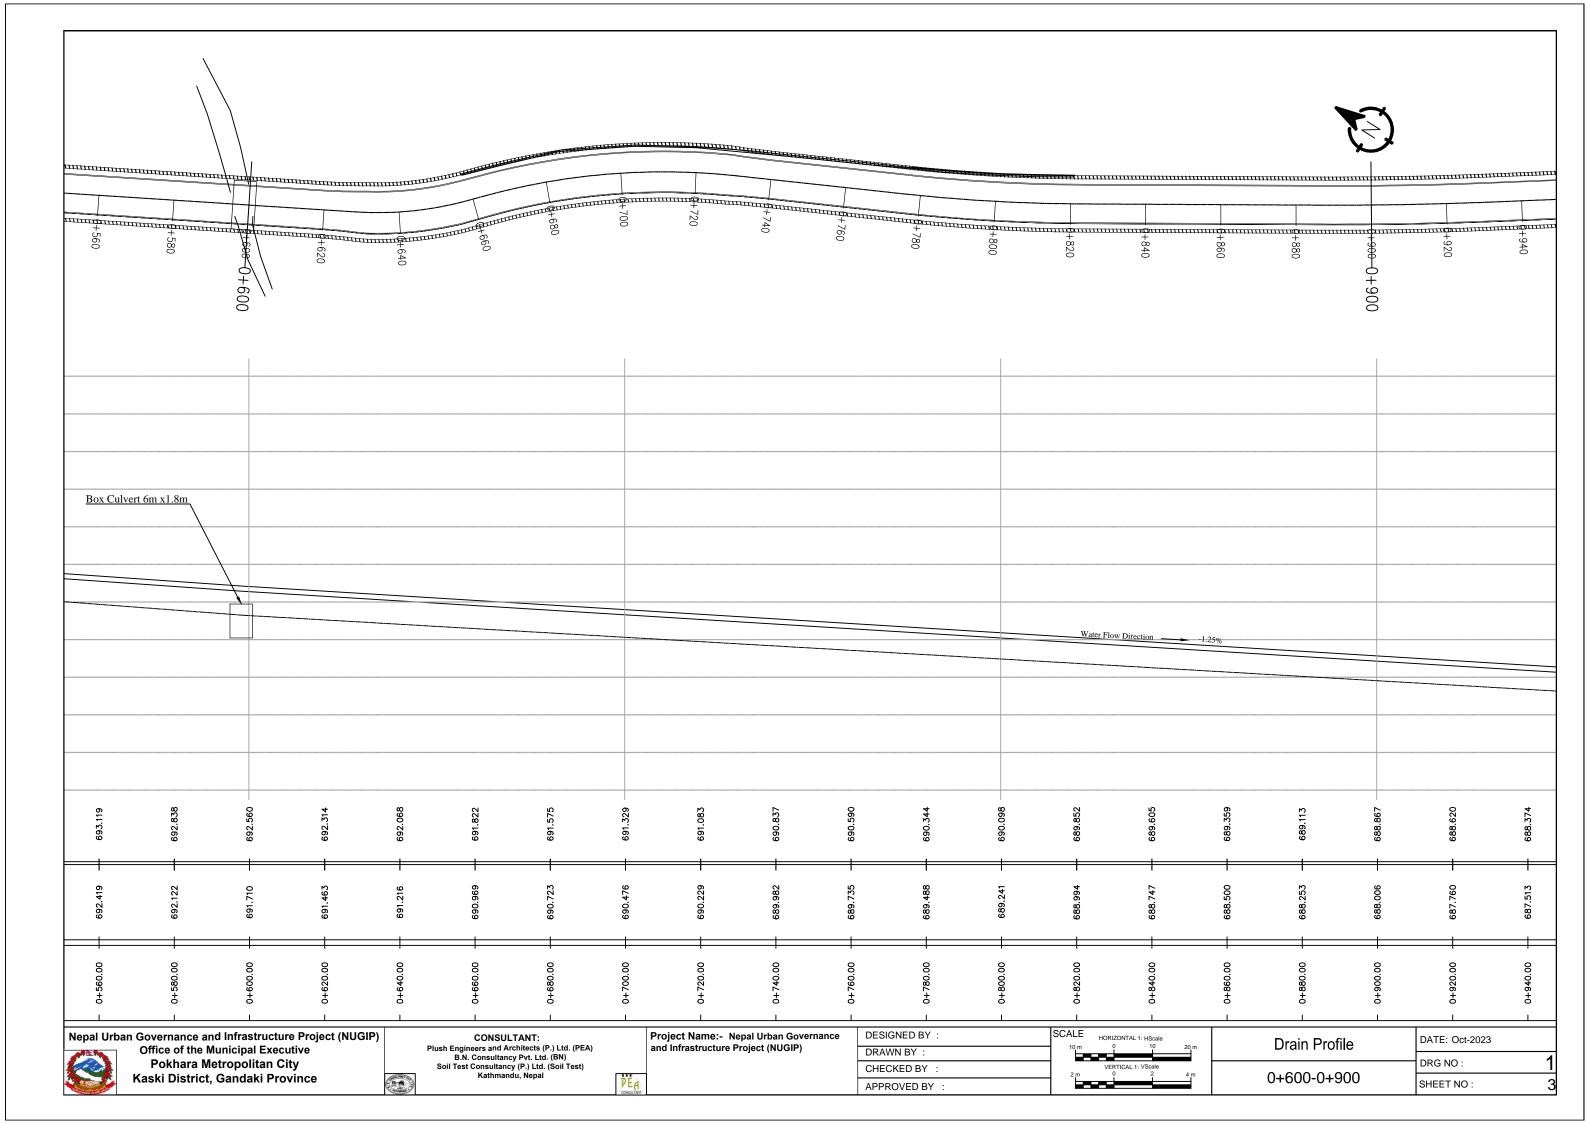


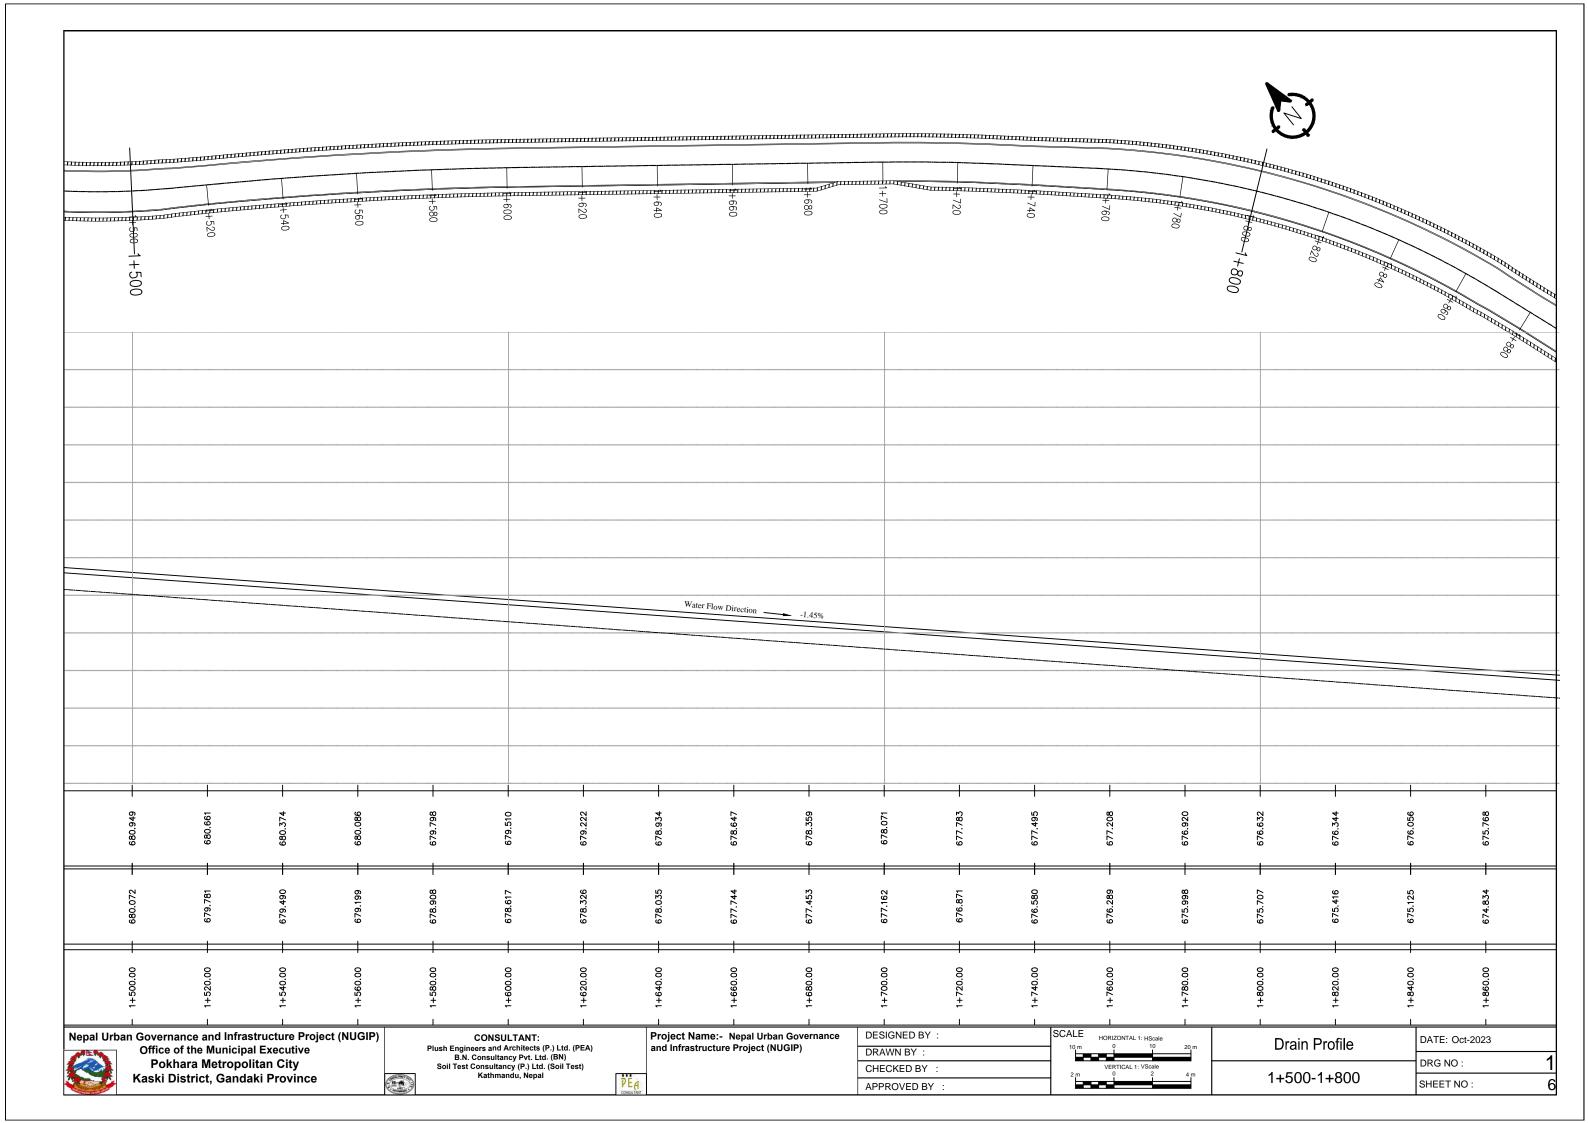


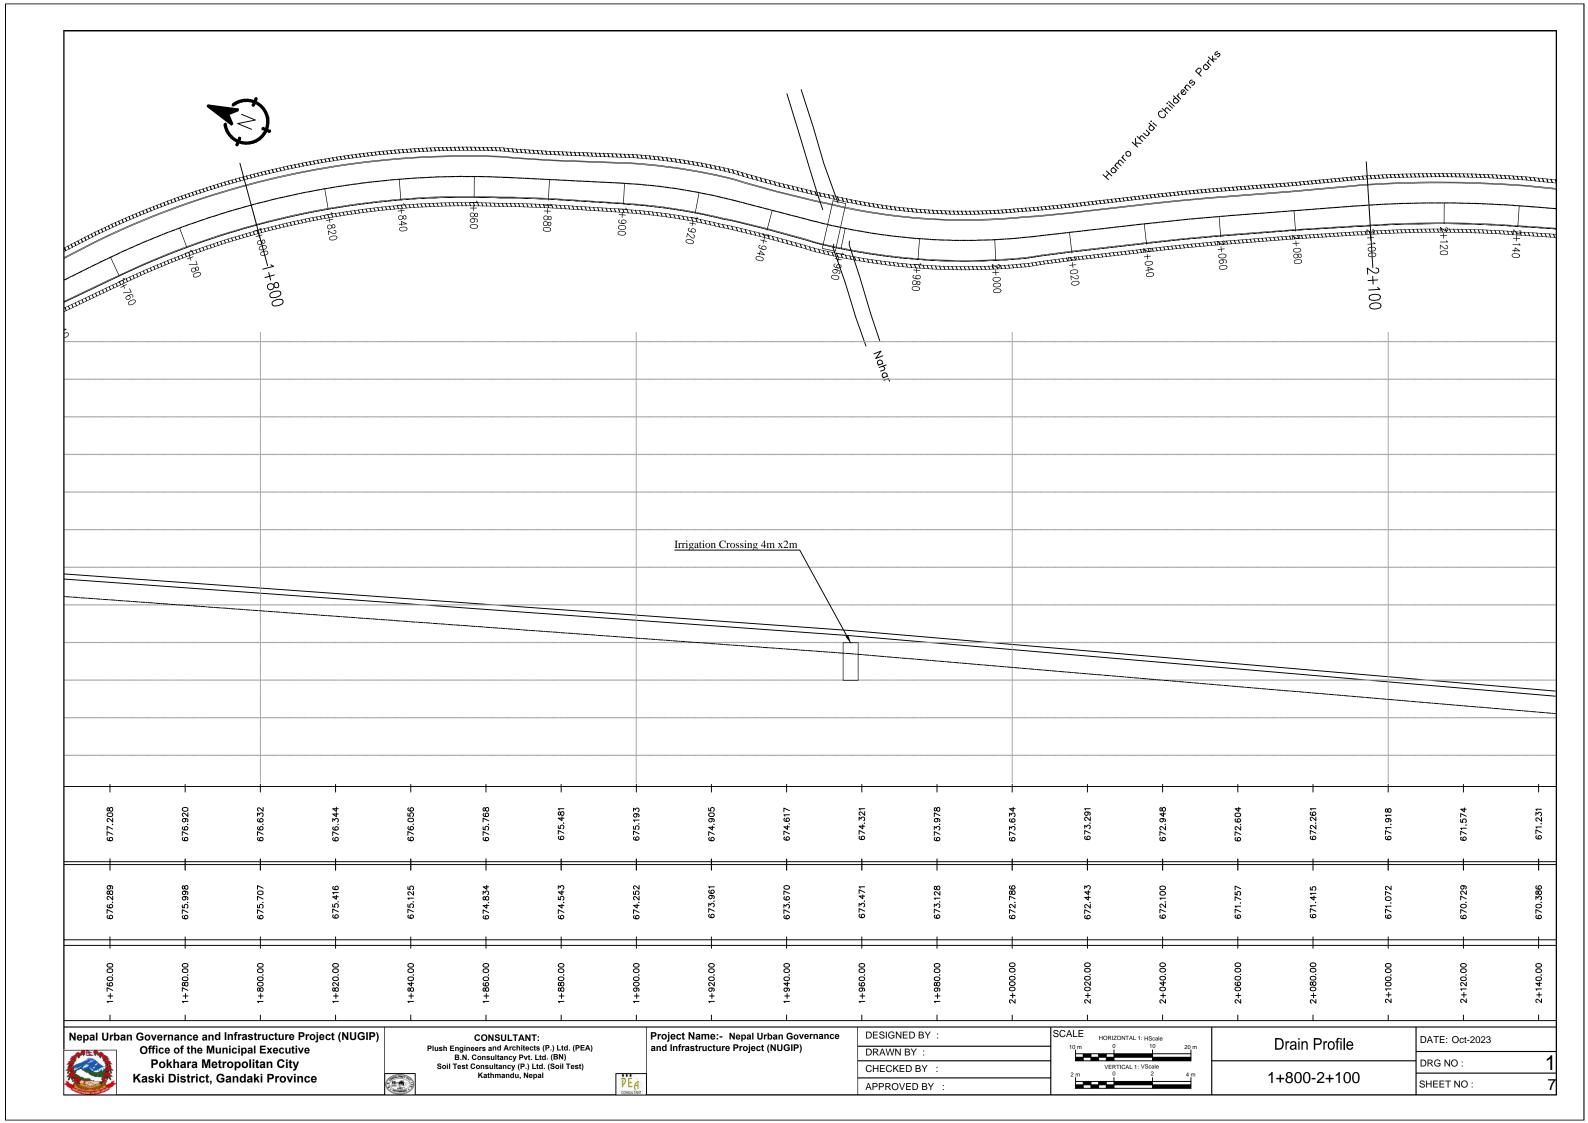


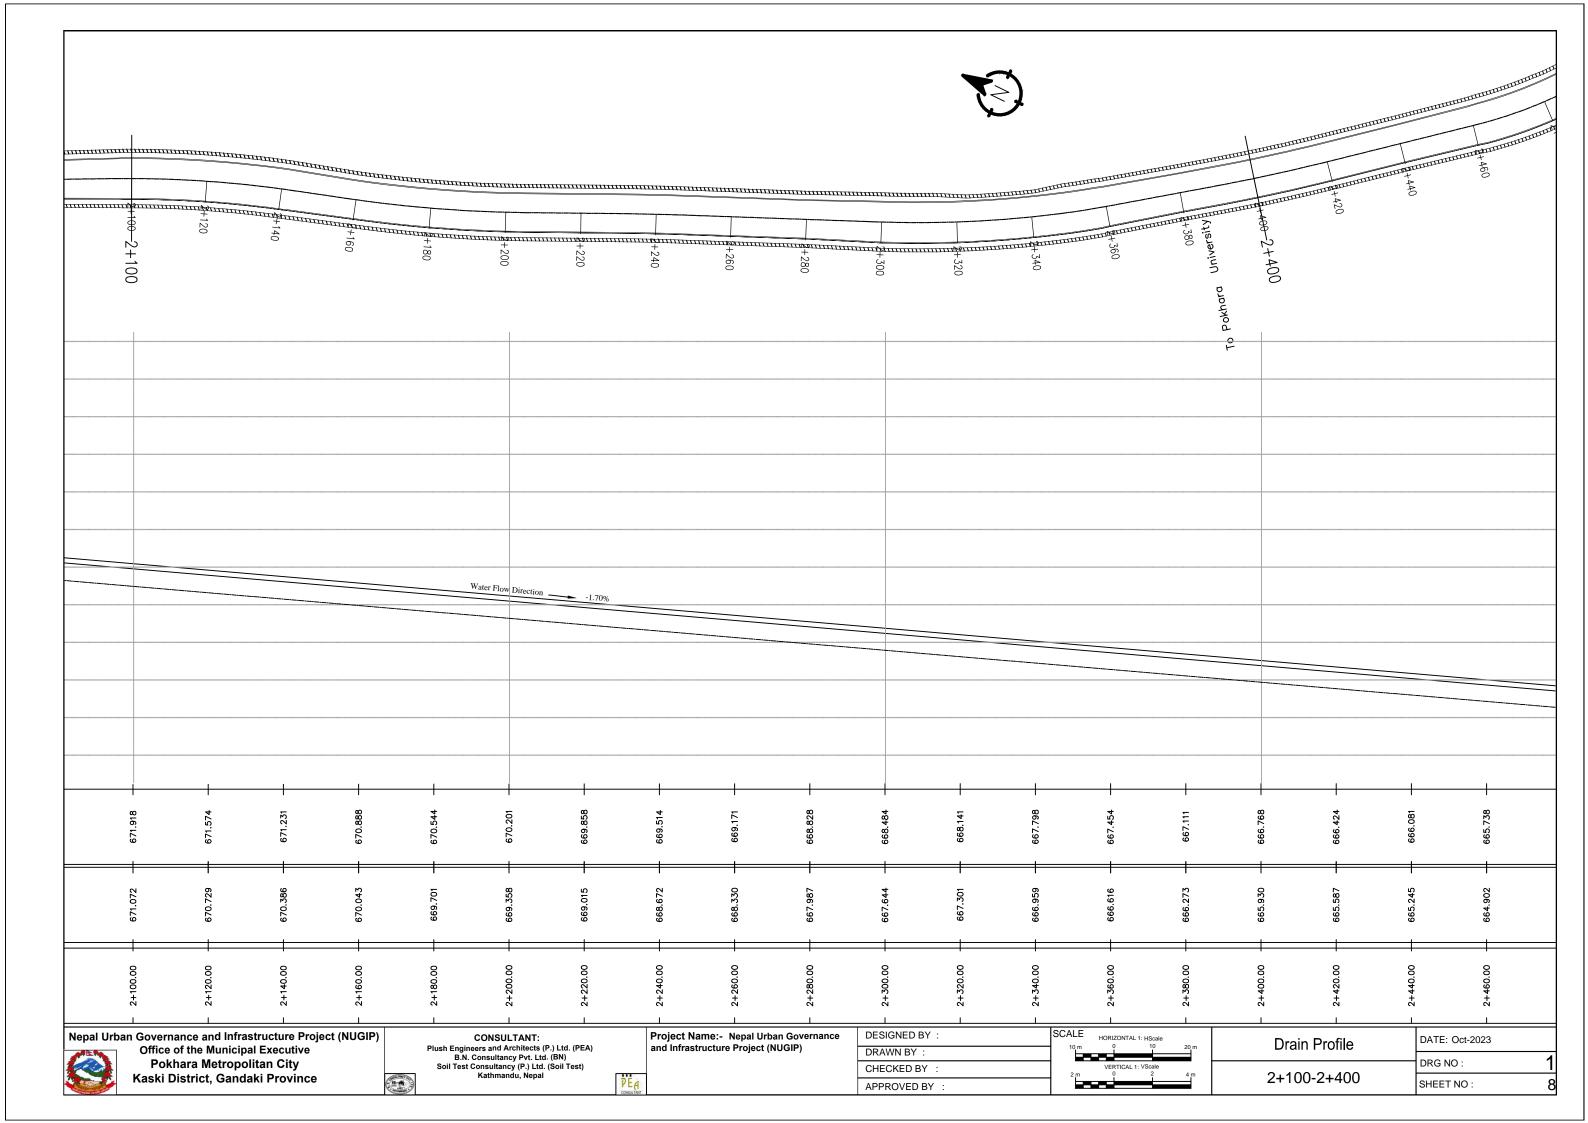


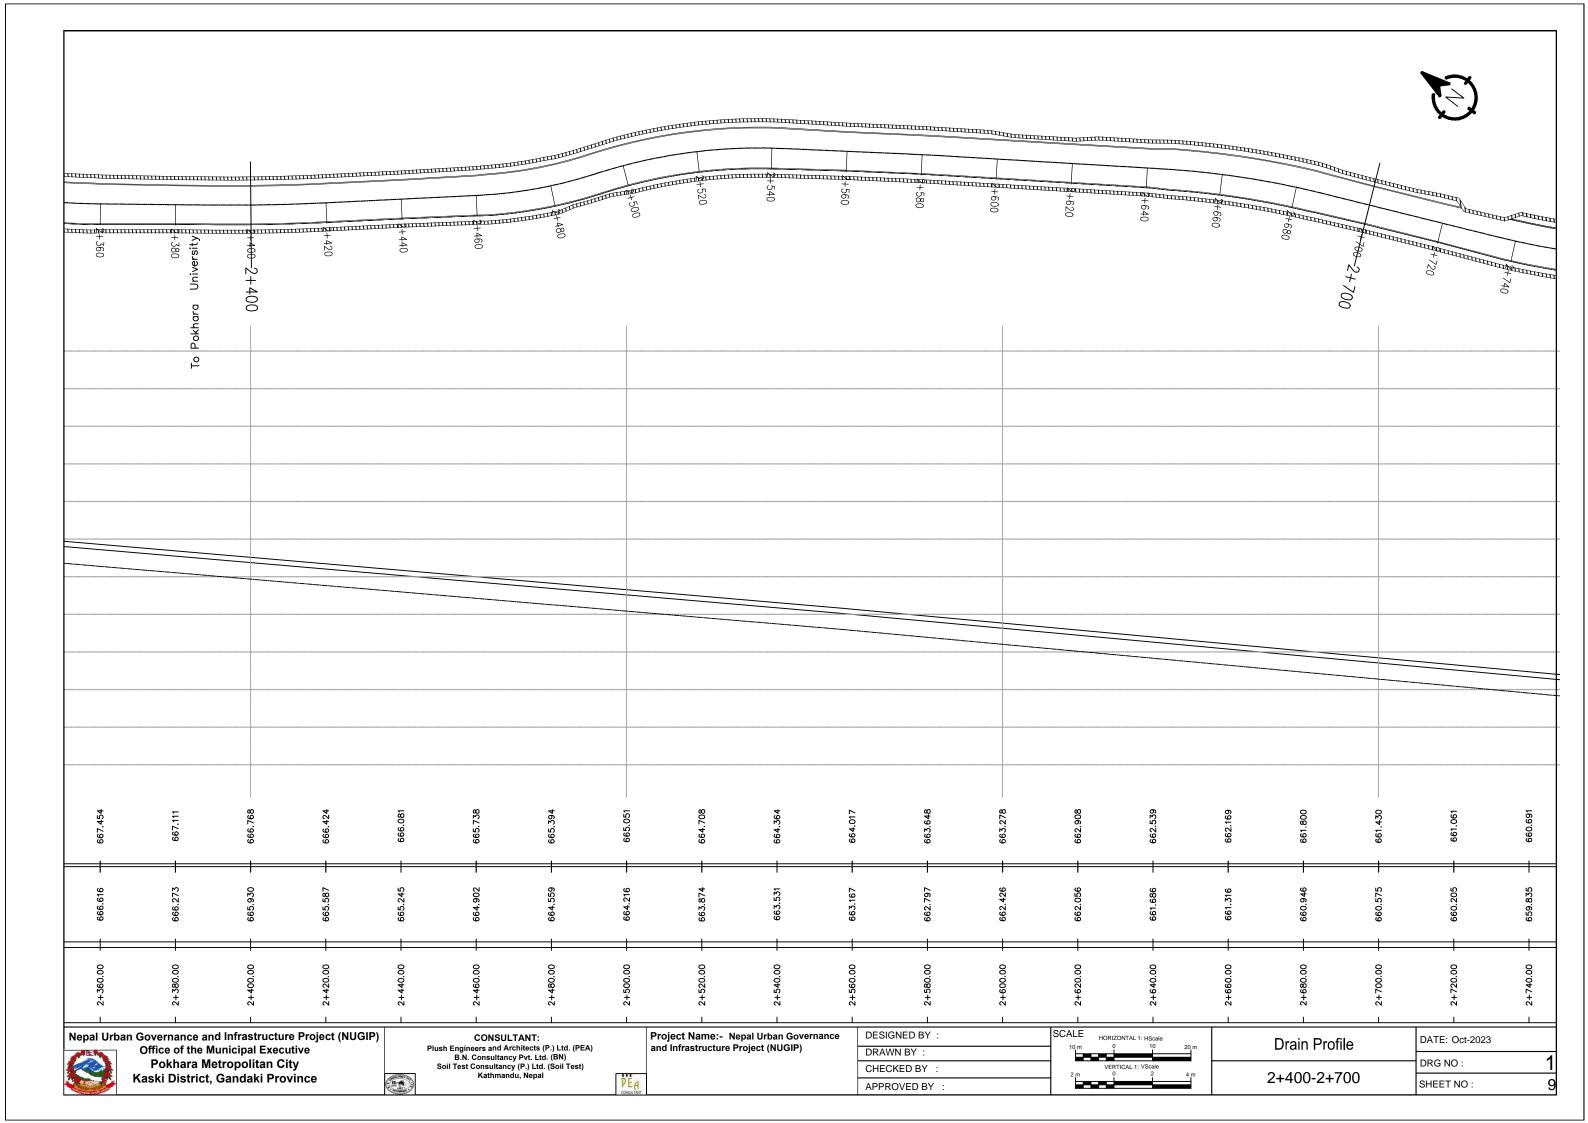


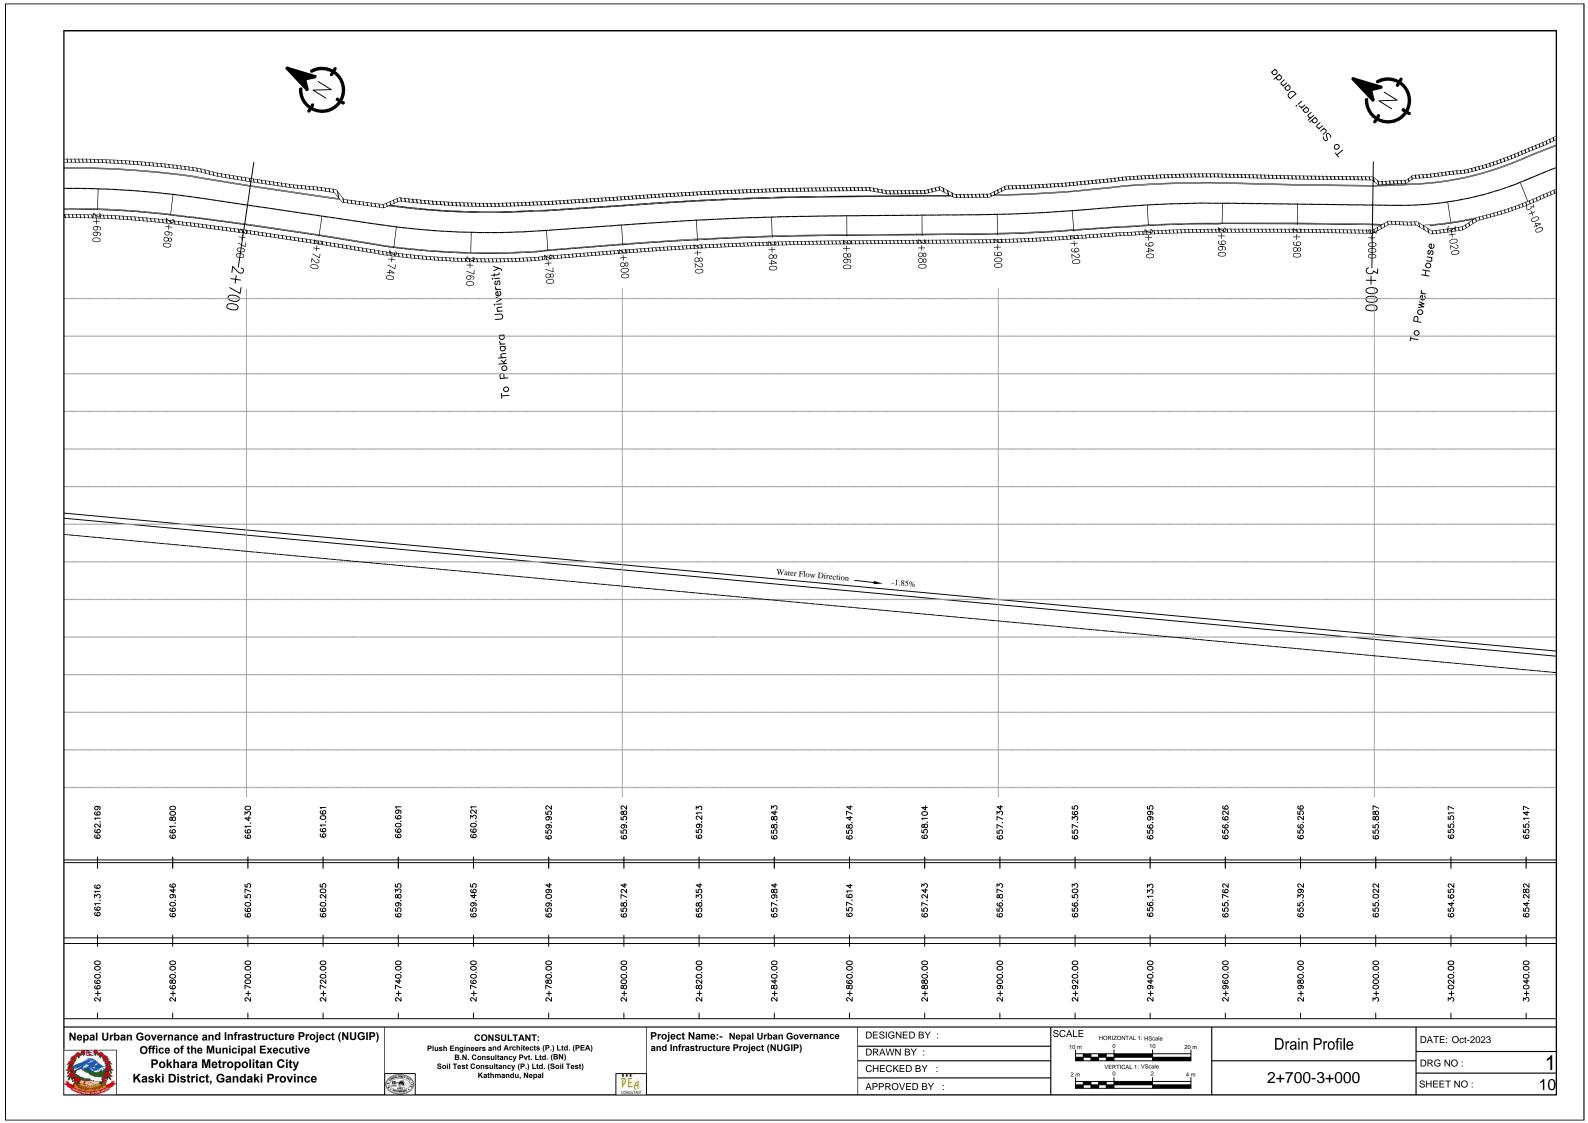


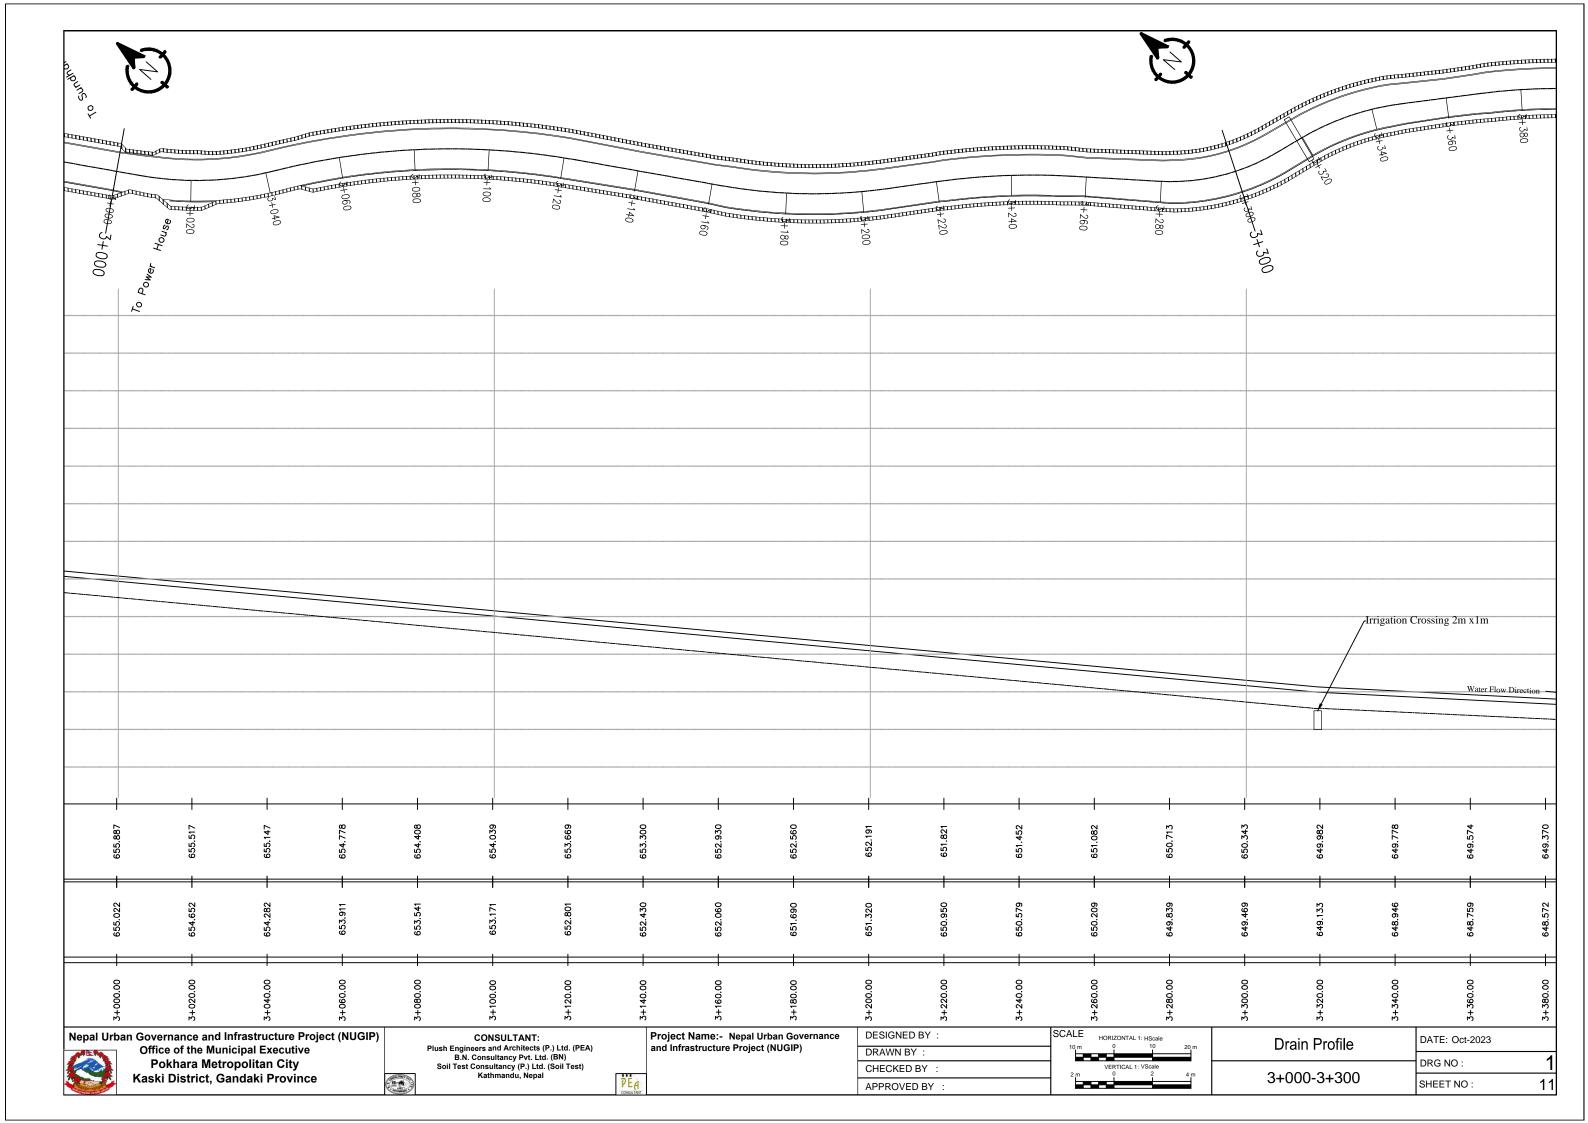


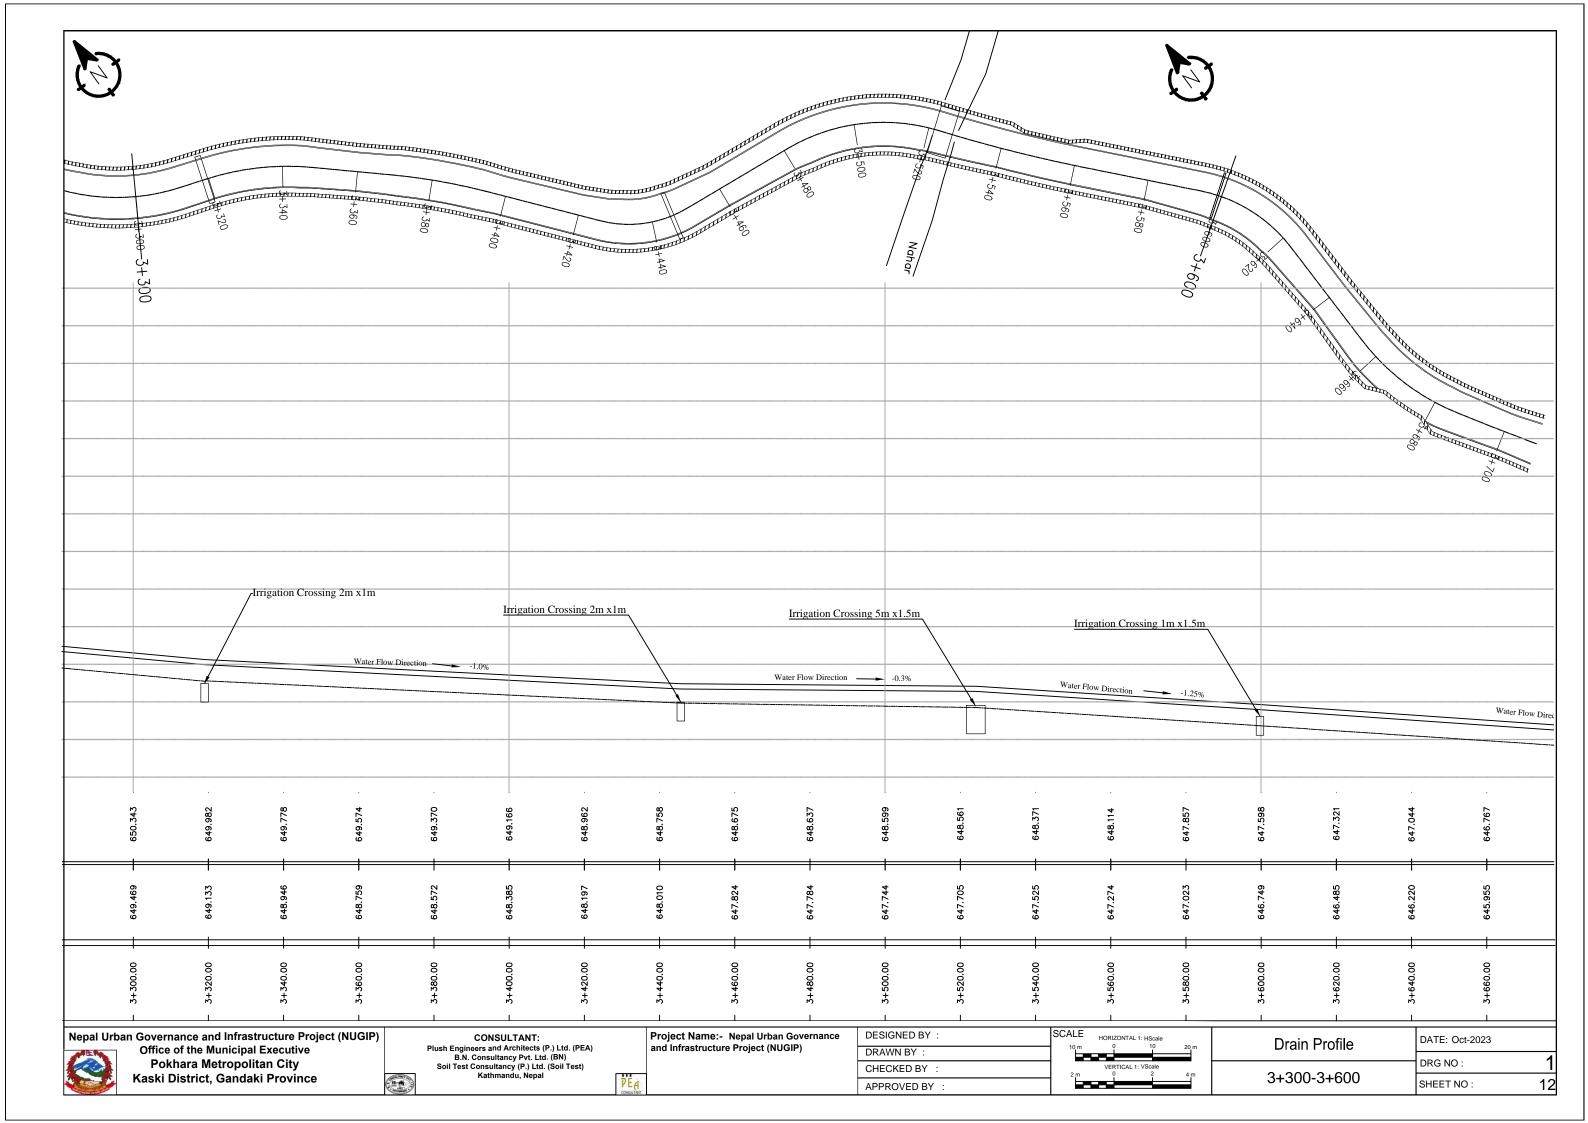


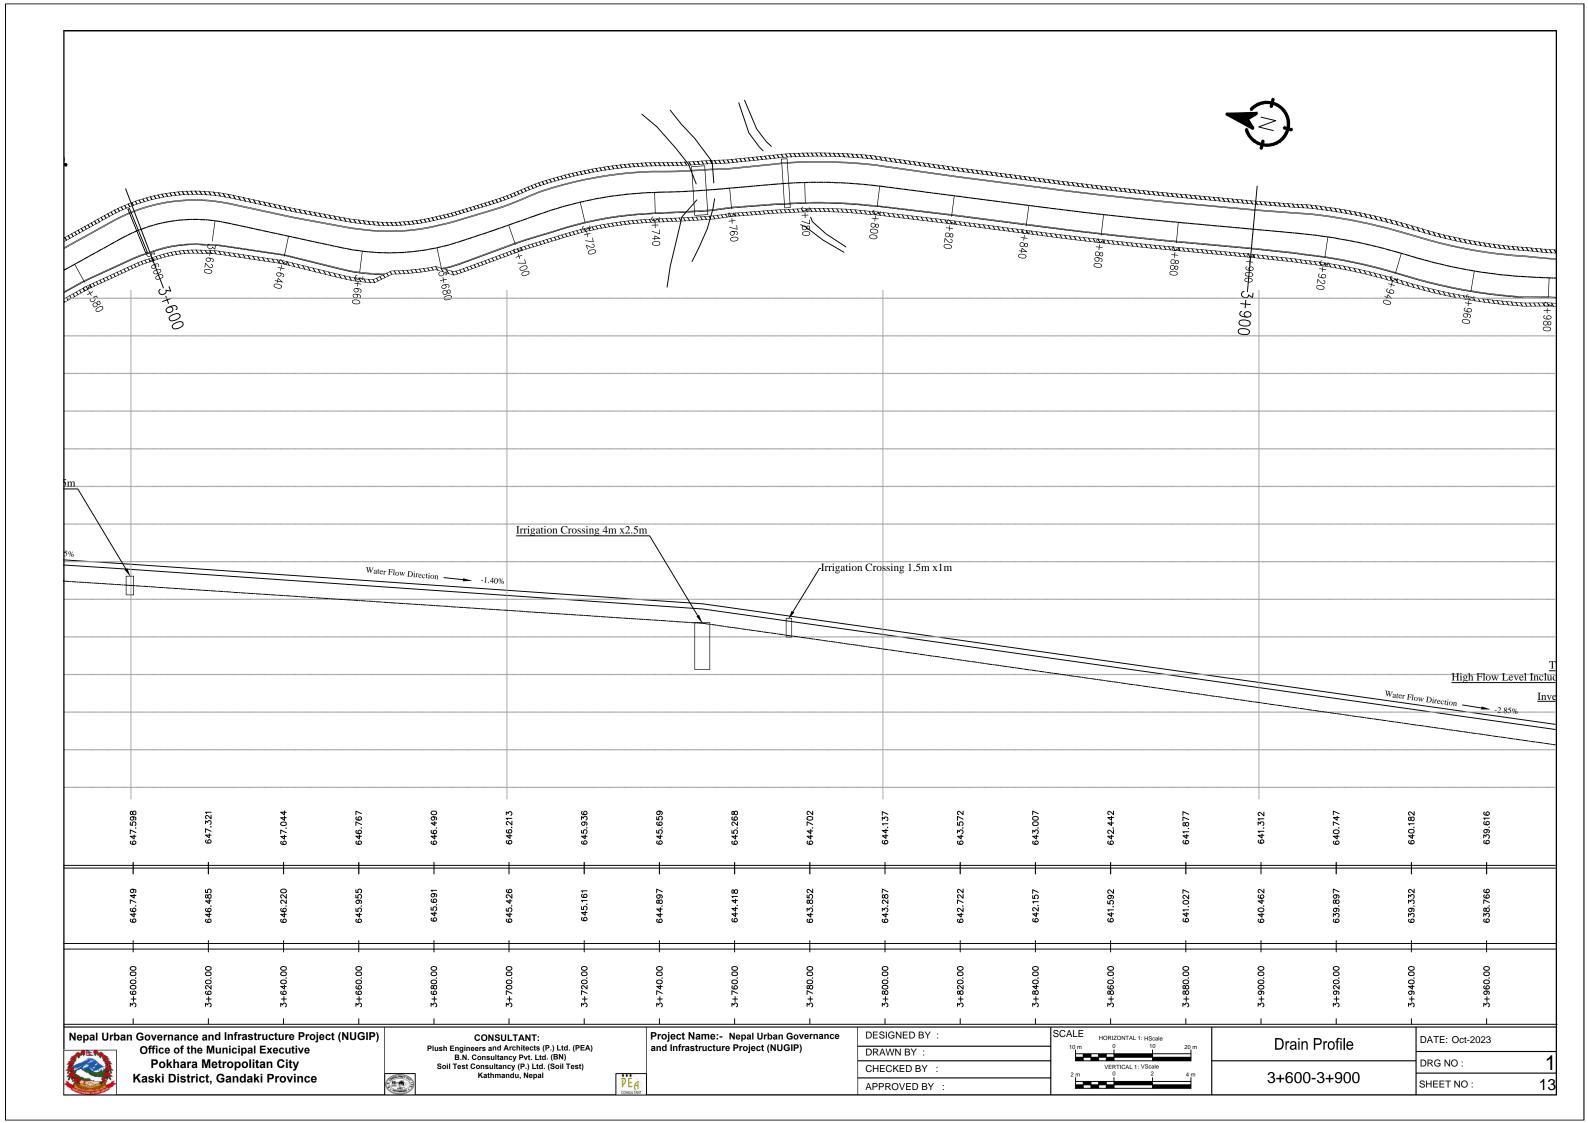

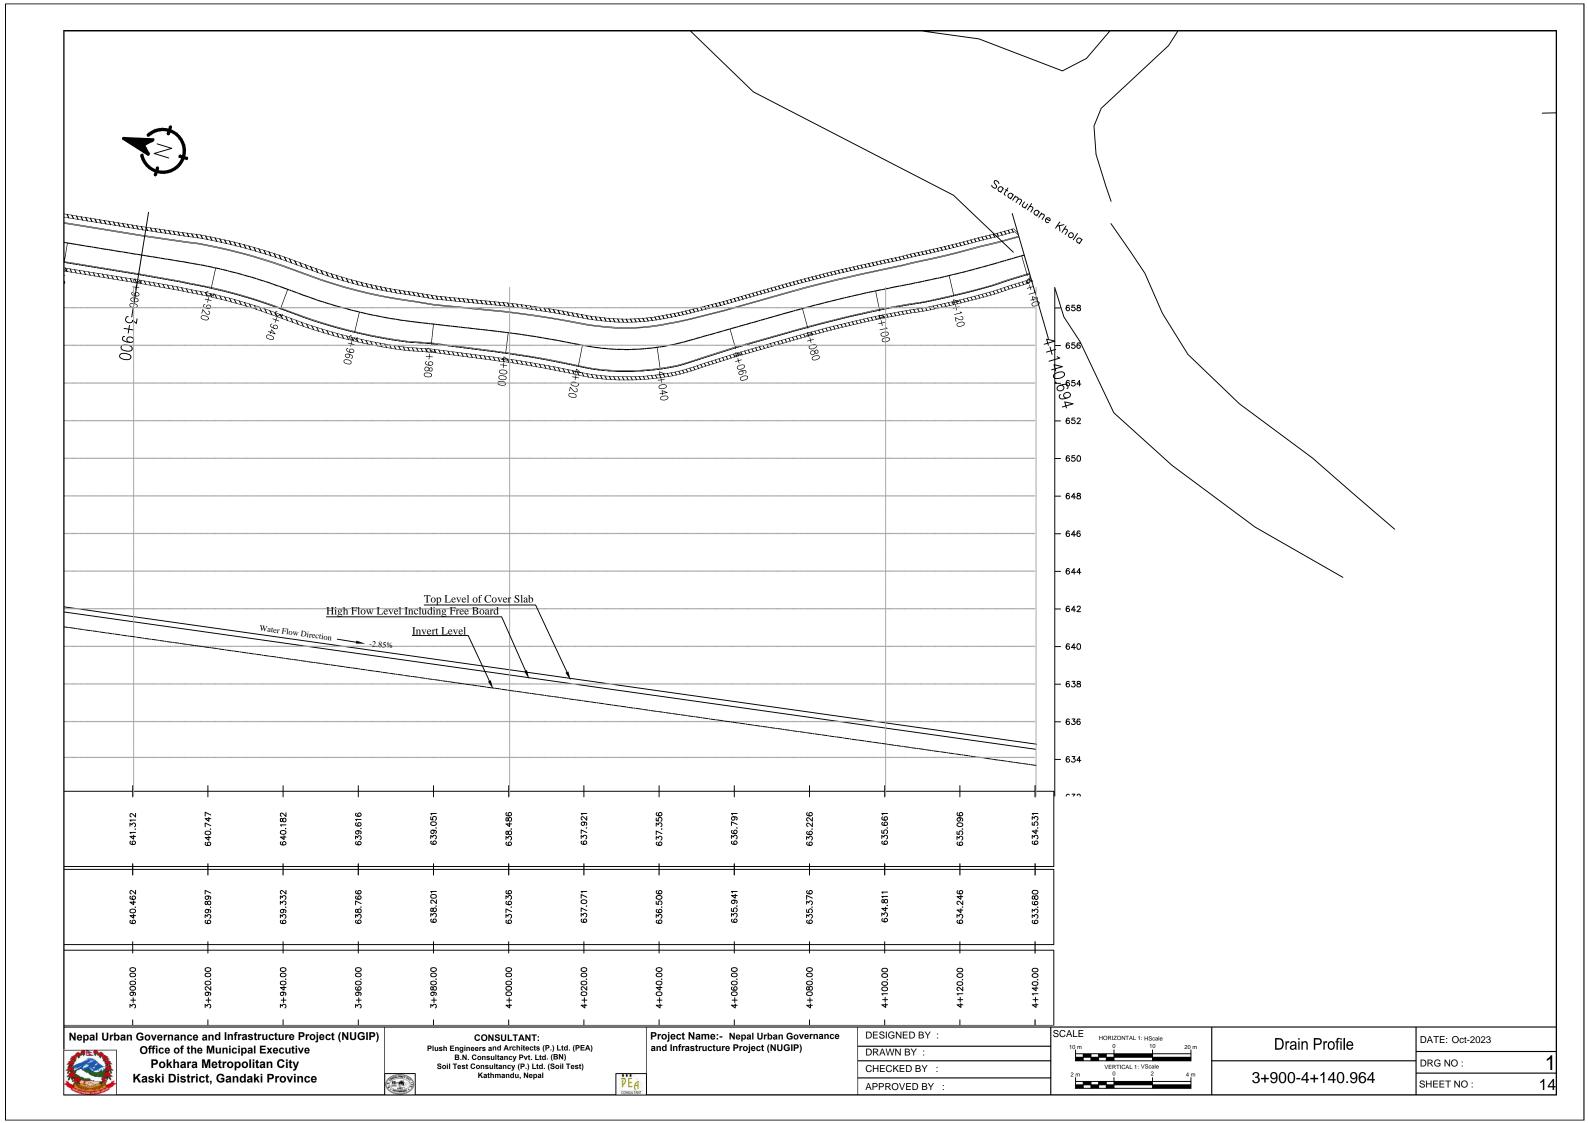

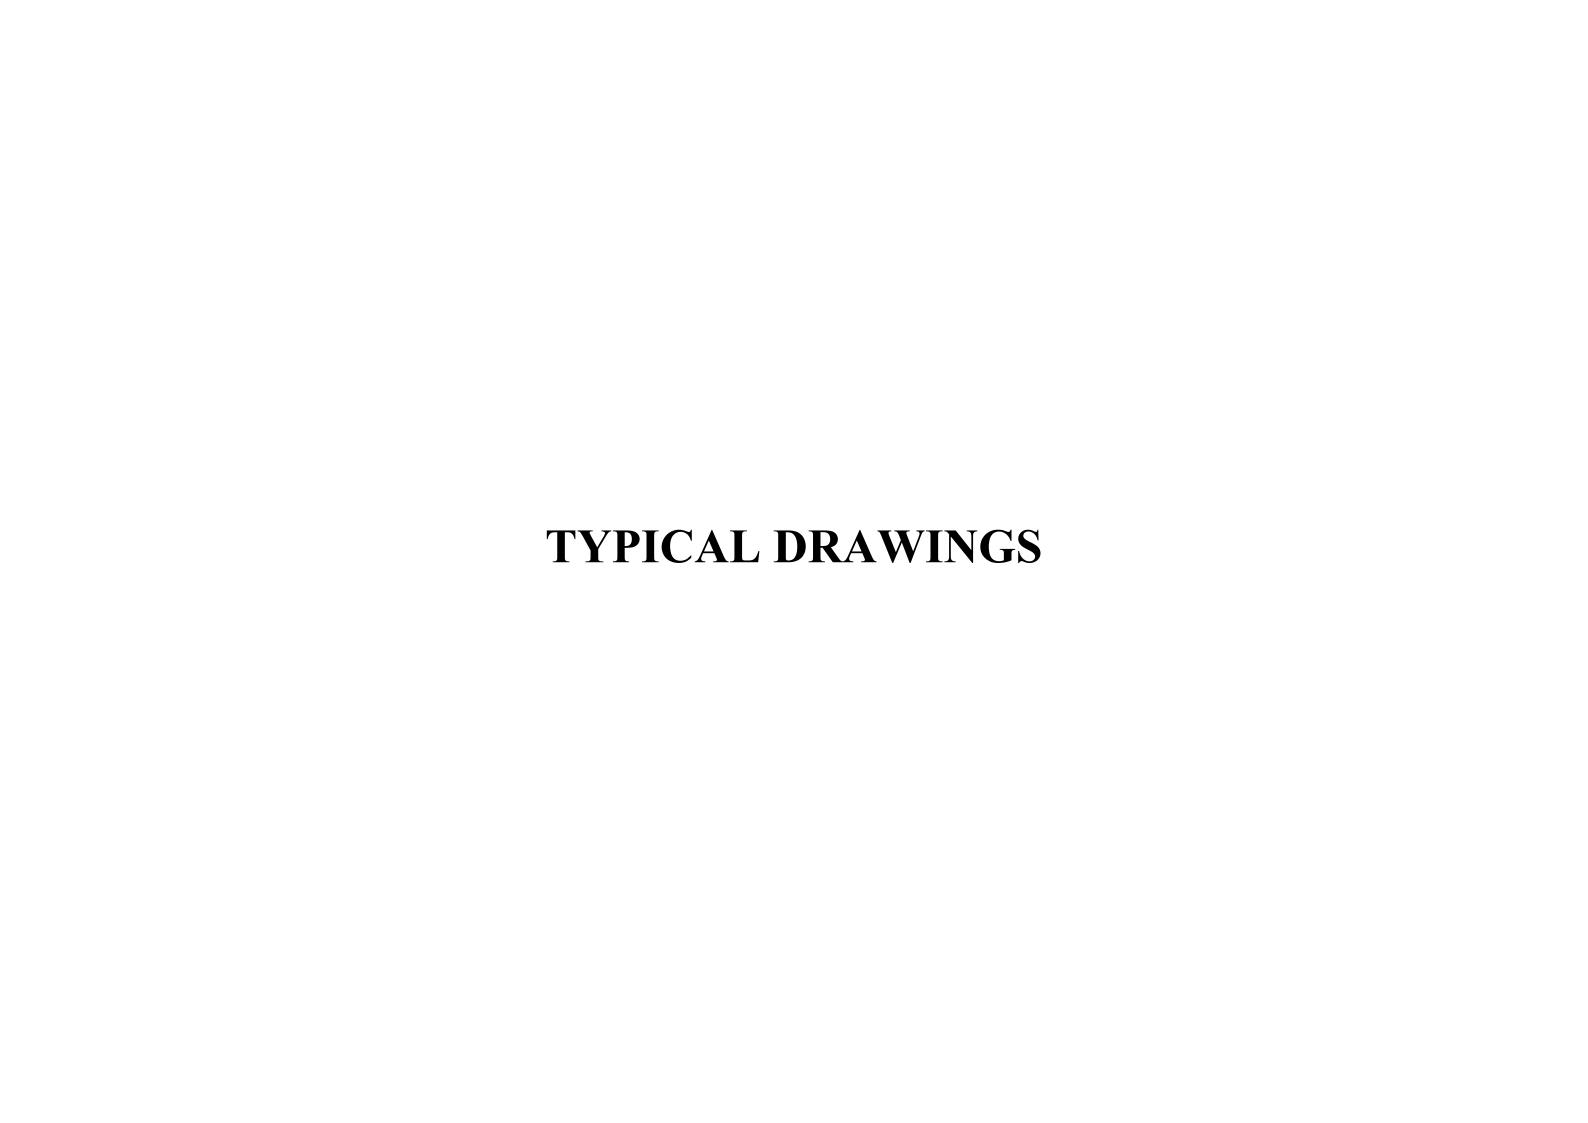

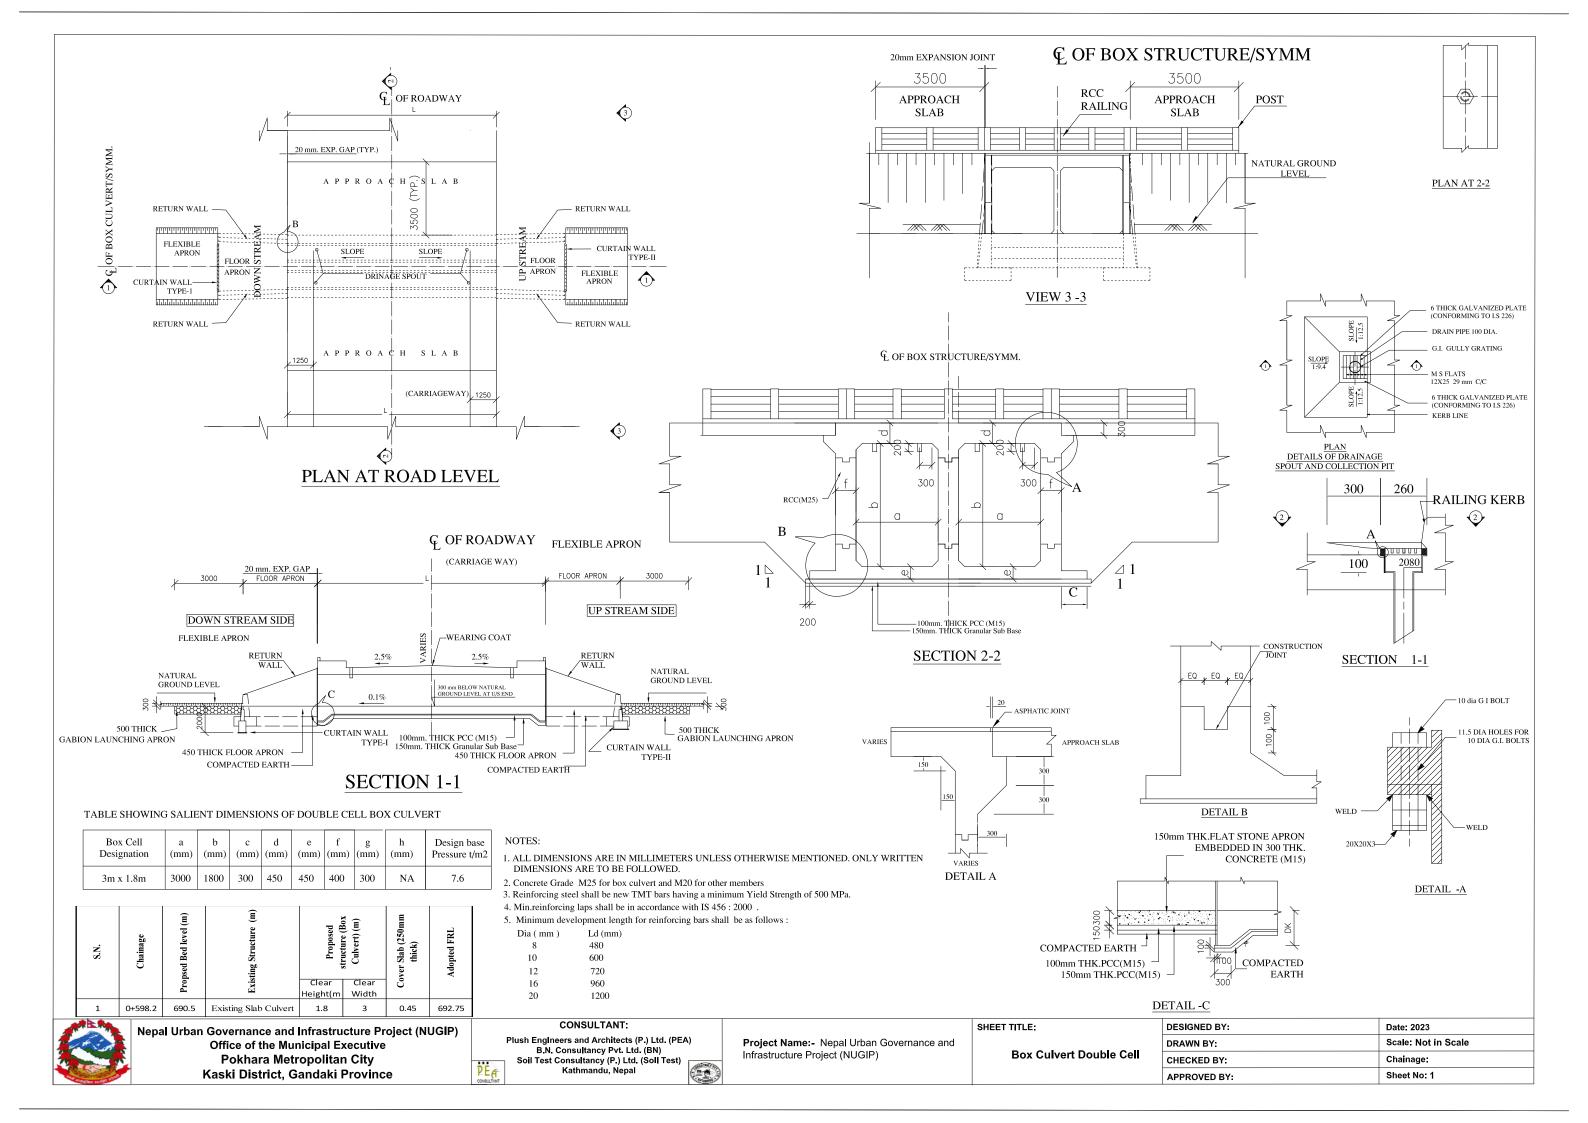

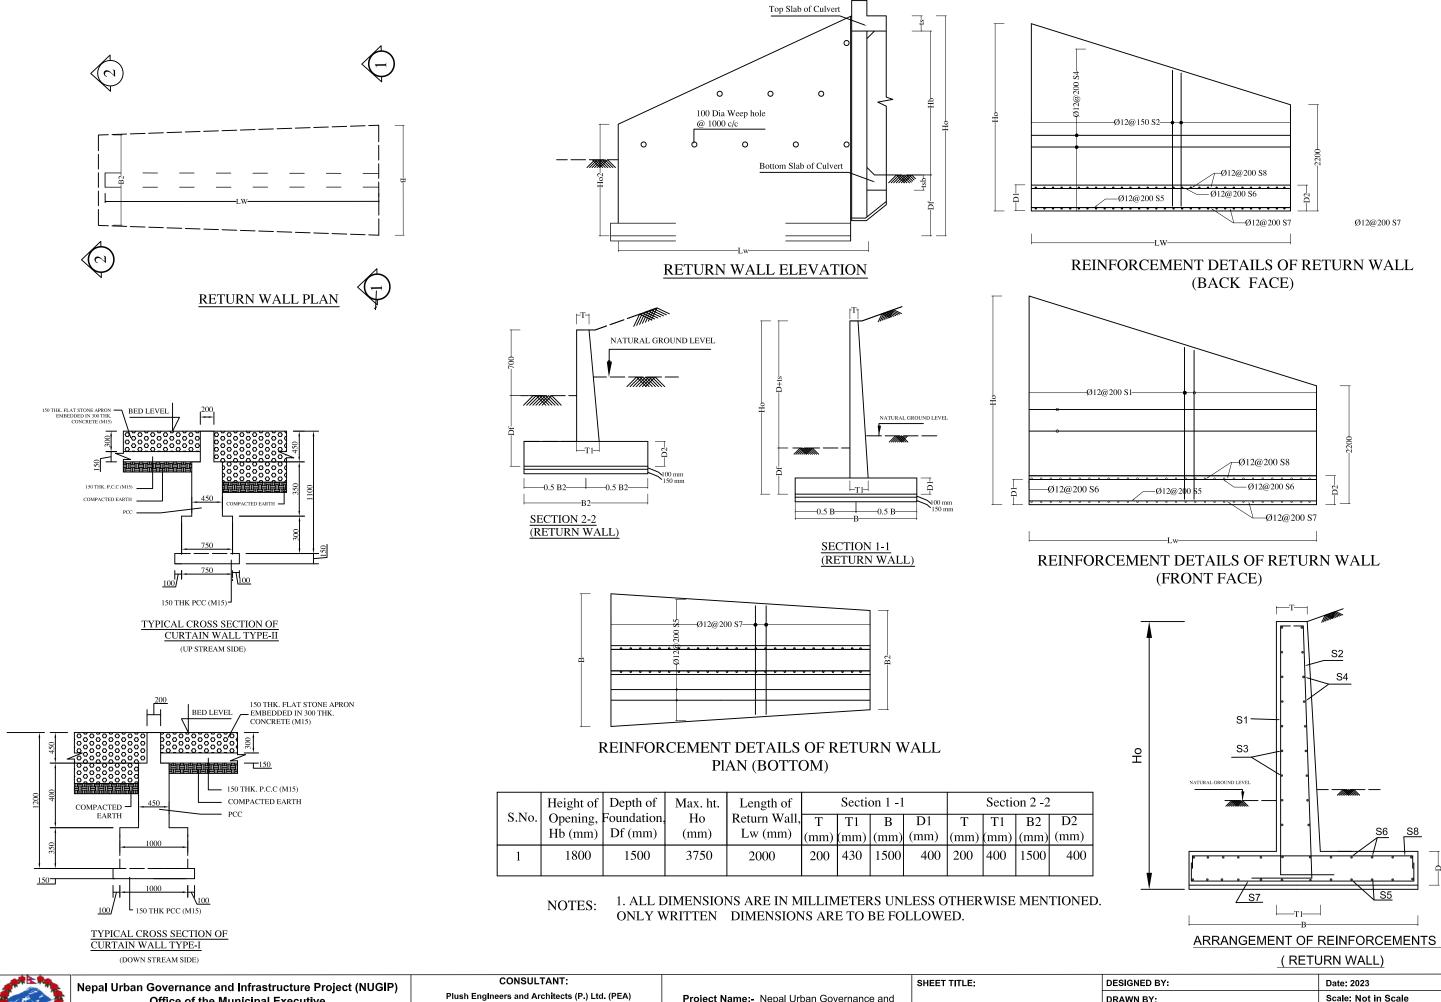

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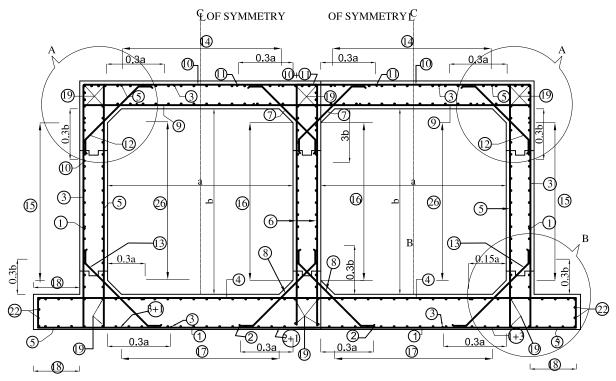
Plush Engineers and Architects (P.) Ltd. (PEA) B.N. Consultancy Pvt. Ltd. (BN) Soil Test Consultancy (P.) Ltd. (Soil Test)

Project Name:- Nepal Urban Governance and Infrastructure Project (NUGIP)

Box Culvert (Return Wall Details) CHECKED BY:


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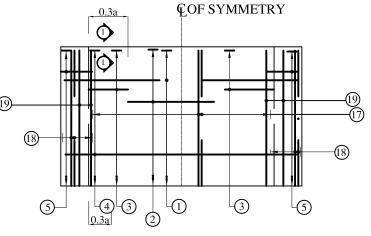


REINFORCEMENT DETAILS OF DOUBLE CELL BOX CULVERT

COF SYMMETRY 0.3a $\begin{bmatrix} 3 \\ 0.3a \end{bmatrix}$ L@L3 TOP SLAB R/F PLAN





VIEW 2 - 2

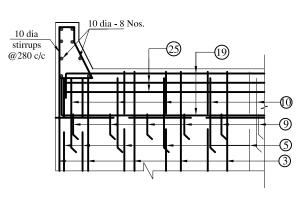

1+2 (19)-(17) DETAIL - C

BOTTOM SLAB R/F PLAN

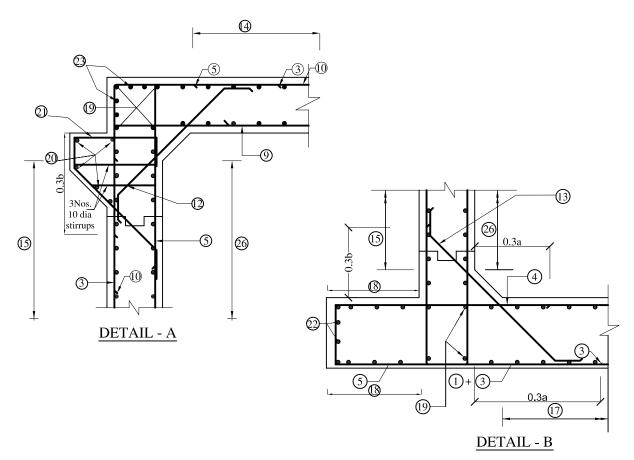

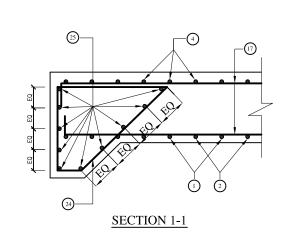

LEGEND:

: TOP FACE BARS / OUTER FACE BARS

: BOTTOM FACE BARS /

INNER FACE BARS

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Kathmandu, Nepal

Project Name: - Nepal Urban Governance and Infrastructure Project (NUGIP)

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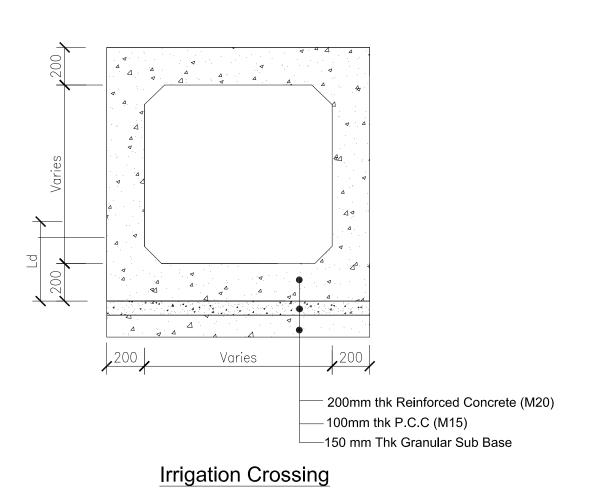
Box Culvert Double Cell (Reinforcement Details)


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DRAWN BY:	Scale:		
CHECKED BY:	Chainage:		
APPROVED BY:	Sheet No: 3		

	BOX-CELL DESIGNATION	ON Double Cell Box Culvert 3m x2m without earth cushion								
BAR MARK	Nc/ab/Ec SHAPE OP BARS (NOT TO SCALE)	BAR DIA. in mm.	SPACING in mm.	M1 in mm.	M2 in mm.	LENGTH in mm.	NO. OF BARS	TOTAL LENGTH in mm.	Wt/m, kg	Weight, kg
1	M:M1	10	200	1300	7000	9600	51	489600	0.62	303.6
2	M1	10	200	2100	0	2100	50	105000	0.62	65.1
3	M1 M2 <u>M</u> 1	16	200	1250	2600	5100	102	540600	1.58	854.1
4	M2 M1 M1	16	200	350	7600	8350	51	425850	1.58	672.8
5	M1 0.2m. 0.2mL M2	12	125	2600	600	6000	160	992000	0.89	882.9
6	M1 M2 <u>M</u> 1	12	125	200	2600	3000	160	512000	0.89	455.7
7	M1 M2 M1	12	200	200	1030	1430	102	145860	0.89	129.8
8	M1 M2 M1	12	200	200	1030	1430	102	145860	0.89	129.8
9	M2 M1 M1	16	200	260	7000	7520	51	383520	1.58	606.0
10	M2 M1 M1	12	200	1000	7000	9000	51	459000	0.89	408.5
11	M1	16	200	2100	0	2100	50	105000	1.58	165.9
12	M1 M2 M1	12	200	200	1170	1570	102	160140	0.89	142.5
13	M1 M2 M1	12	200	200	1170	1570	102	160140	0.89	142.5
14	M2 M1 M1	10	150	250	9900	10400	72	748800	0.62	464.3
15	M1 M1	10	150	200	9900	10300	23	236900	0.62	146.9
16	M2 M1 M1	10	150	160	9900	10220	23	235060	0.62	145.7
17	M2 M1 M1	10	150	225	9900	10350	72	745200	0.62	462.0
18	M2 M1 M1	10	150	225	9900	10350	12	124200	0.62	77.0
19	M2 M1 M1	10	-	160	9900	10220	16	163520	0.62	101.4
20	M1	12	-	9900	0	9900	10	99000	0.89	88.1
21	(M1) M2	12	200	1000	1260	2260	102	230520	0.89	205.2
22	M1 M2 M1	10	-	160	9900	10220	2	20440	0.62	12.7
23	M1 M2 M1	10	-	160	9900	10220	4	40880	0.62	25.3
24	M1+0.20 m M1 M2 M2	10	150	1100	1550	4150	102	423300	0.62	262.4
25	M1 M2 M1	10	ı	160	7600	7920	20	158400	0.62	98.2
26	M2 M1 M1	10	250	200	9900	10300	16	164800	0.62	102.2
										7150.7



PEA




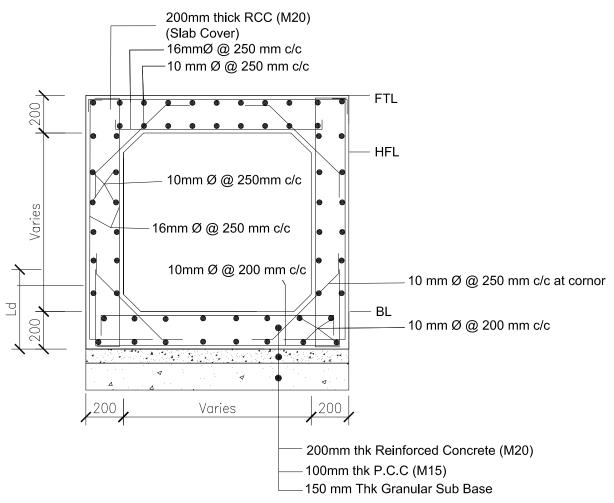



Reinforcement Details at Irrigation Crossing


S.N	Chainage	Proposed Structure	Proposed Size (H*w)
1	3+445.5	Irrigation Crossing	1.5*1



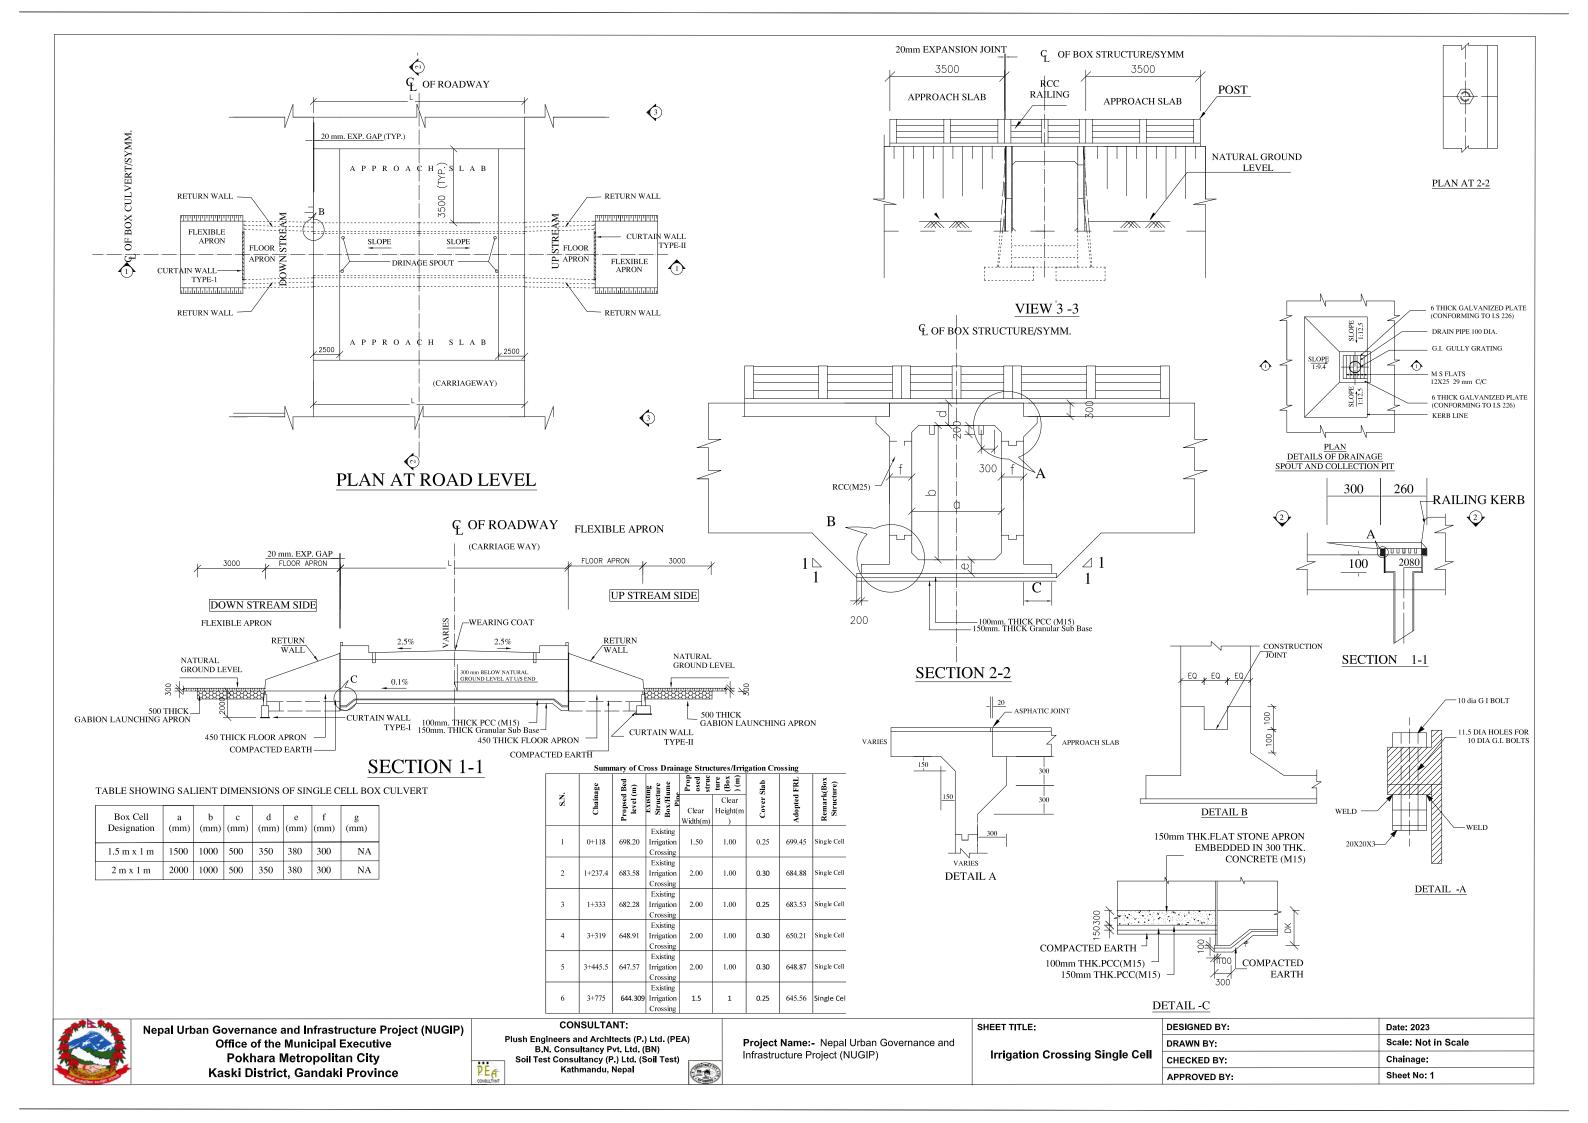


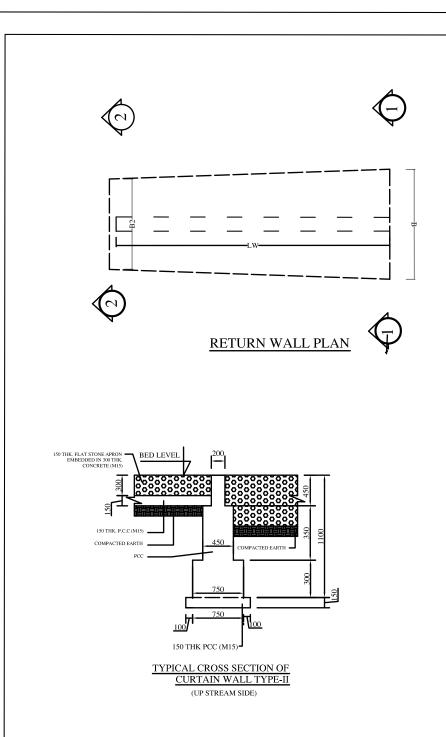


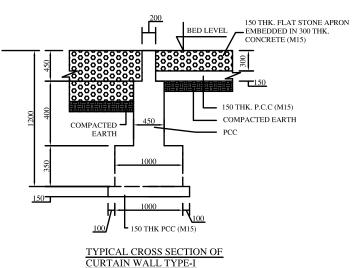

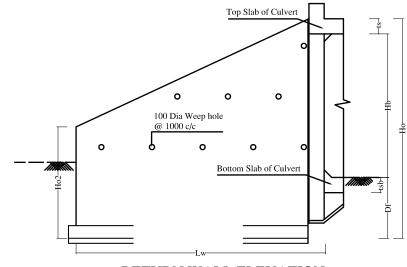

RETURN WALL ELEVATION

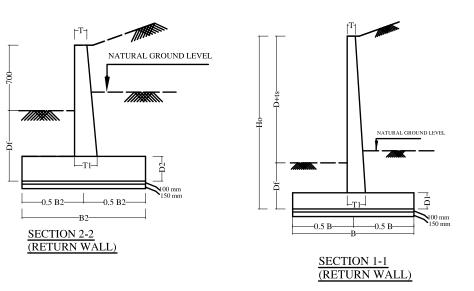


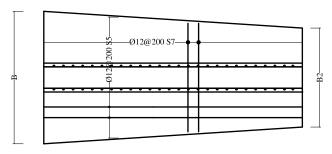


REINFORCEMENT DETAILS OF RETURN WALL PIAN (BOTTOM)

	~ ·				Length of	Section 1 -1			Section 2 -2				
	S.No.		Foundation.		Return Wall,		T1	В	D1	T	T1	B2	D2
		Hb (mm)	Df (mm)	(mm)	Lw (mm)	(mm)	(mm)	(mm)	(mm)	(mm)	(mm)	(mm)	(mm)
I	1	1000	1500	2850	2000	200	430	1500	400	200	400	1500	400


NOTES: 1. ALL DIMENSIONS ARE IN MILLIMETERS UNLESS OTHERWISE MENTIONED. ONLY WRITTEN DIMENSIONS ARE TO BE FOLLOWED.

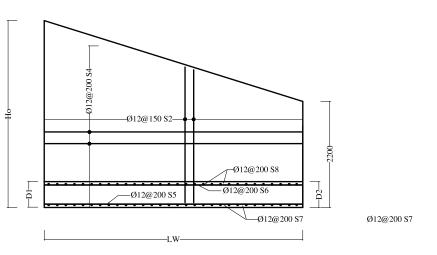

REINFORCEMENT DETAILS OF RETURN WALL (BACK FACE)

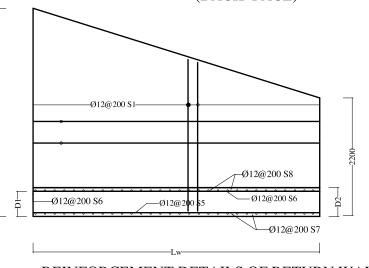

REINFORCEMENT DETAILS OF RETURN WALL (FRONT FACE)

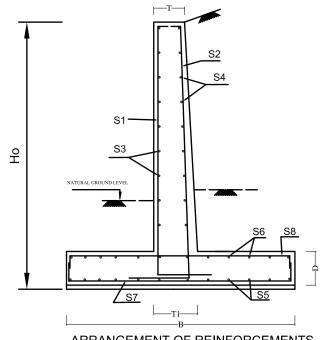

ARRANGEMENT OF REINFORCEMENTS
(RETURN WALL)



Plush Engineers and Architects (P.) Ltd. (PEA) B.N. Consultancy Pvt. Ltd. (BN) Soil Test Consultancy (P.) Ltd. (Soil Test)





Project Name:- Nepal Urban Governance and Infrastructure Project (NUGIP)


SHEET TITLE:


Irrigation Crossing (Return Wall Details)


DESIGNED BY:	Date: 2023
DRAWN BY:	Scale: Not in Scale
CHECKED BY:	Chainage:
APPROVED BY:	Sheet No: 2

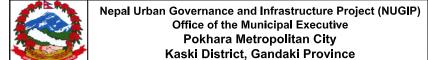

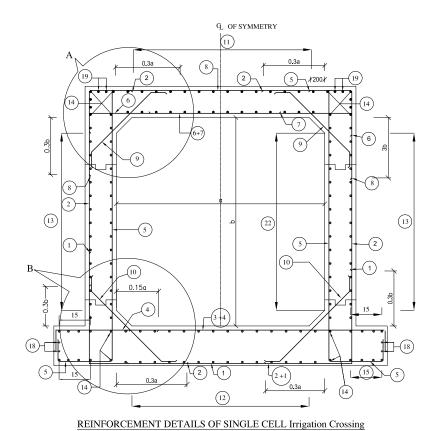

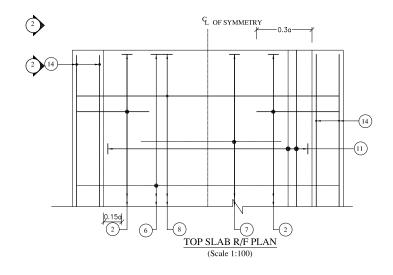

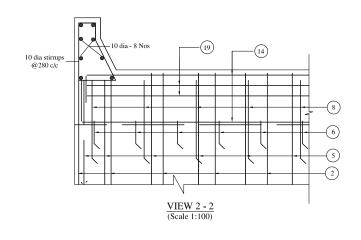


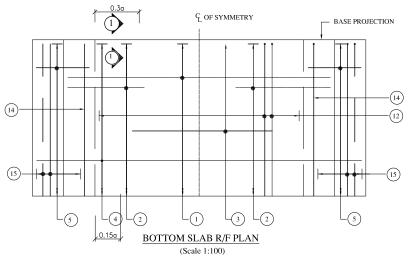



LEGEND:

: TOP FACE BARS / OUTER FACE BARS

: BOTTOM FACE BARS / INNER FACE BARS

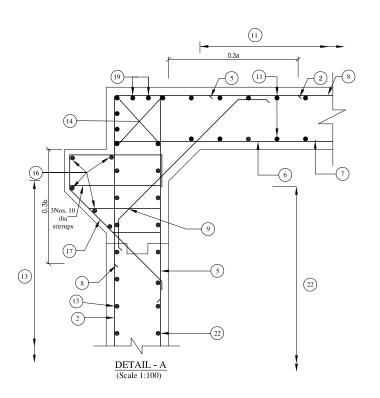

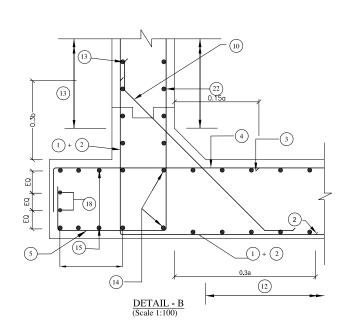

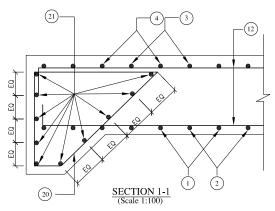



Project Name:- Nepal Urban Governance and Infrastructure Project (NUGIP)

SHEET TITLE:

Irrigation Crossing Single Cell (Reinforcement Details)

DESIGNED BY:	Date: 2023
DRAWN BY:	Scale:
CHECKED BY:	Chainage:
APPROVED BY:	Sheet No: 3
	DRAWN BY: CHECKED BY:



Nepal Urban Governance and Infrastructure Project (NUGIP)
Office of the Municipal Executive
Pokhara Metropolitan City
Kaski District, Gandaki Province

PEA


Plush Engineers and Architects (P.) Ltd. (PEA)
B,N. Consultancy Pvt. Ltd. (BN)
Soil Test Consultancy (P.) Ltd. (Soll Test)
Kathmandu, Nepal


	BOX-CELL DESIGNATION Nc/ab/Ec Single Cell Irrigation Crossing 1.5m x1m without earth cushion Nc/ab/Ec											Sing	le Cell Irr	igation C	Crossing 2m	x1m without	earth cushion		
BAR MARK	SHAPE OF BARS (NOT TO SCALE)	BAR DIA. in mm.	SPACING in mm.	M1 in mm.	M2 in mm.	LENGTH in mm.	NO. OF BARS	TOTAL LENGTH in mm.	Wt/m, kg	Weight, kg	BAR DIA. in mm.	SPACING in mm.	M1 in mm.	M2 in mm.	LENGTH in mm.	NO. OF BARS	TOTAL LENGTH in mm.	Wt/m, kg	Weight, kg
1	M1 M2 M1	10	250	930	2000	3860	40	174400	0.62	108.1	10	250	930	2500	4360	40	174400	0.62	108.1
2	M2 M1	16	250	850	1630	3330	82	355060	1.58	561.0	16	250	850	1630	3330	82	355060	1.58	561.0
3	<u>M1</u>					Bar not n	eeded								Bar not n	eeded			
4	M2 M1 M1	16	250	280	3000	3560	40	162400	1.58	256.6	16	250	280	3500	4060	40	162400	1.58	256.6
5	M1 0.2m. 0.2m. <u>M2</u>	16	250	1630	700	2730	80	298400	1.58	471.5	16	250	1630	700	2730	80	298400	1.58	471.5
6	M2 M1 M1	16	250	250	2000	2500	40	120000	1.58	189.6	16	250	250	2500	3000	40	120000	1.58	189.6
7	MI					Bar not n	eeded								Bar not n	eeded			
8	M2 M1 M1	10	250	900	2000	3800	40	172000	0.62	106.6	10	250	900	2500	4300	40	172000	0.62	106.6
9	M1 M2	10	250	200	900	1300	80	104000	0.62	64.5	10	250	200	900	1300	80	104000	0.62	64.5
10	M1 M2 M1	12	250	200	940	1340	80	107200	0.89	95.4	12	250	200	940	1340	80	107200	0.89	95.4
11	M2 M1 M1	10	250	200	9900	10300	16	164800	0.62	102.2	10	250	200	9900	10300	16	164800	0.62	102.2
12	M2 M1 M1	10	250	200	9900	10300	16	164800	0.62	102.2	10	250	200	9900	10300	16	164800	0.62	102.2
13	M1 M2 M1	10	250	200	9900	10300	16	164800	0.62	102.2	10	250	200	9900	10300	16	164800	0.62	102.2
14	M1 M2 M1	10	-	160	9900	10220	12	122640	0.62	76.0	10	-	160	9900	10220	12	122640	0.62	76.0
15	M1 M2 M1	10	250	200	9900	10300	12	123600	0.62	76.6	10	250	200	9900	10300	12	123600	0.62	76.6
16	M1	12	-	0	9900	9900	10	99000	0.89	88.1	12	-	0	9900	9900	10	99000	0.89	88.1
17	M1 M2	12	250	1000	1250	2250	80	180000	0.89	160.2	12	250	1000	1250	2250	80	180000	0.89	160.2
18	M1 <u>M2</u> M1	10	-	160	9900	10220	4	40880	0.62	25.3	10	-	160	9900	10220	4	40880	0.62	25.3
19	M1 M2 M1	10	-	1600	9900	13100	8	104800	0.62	65.0	10	-	1600	9900	13100	8	104800	0.62	65.0
20	M1+0.20 m M1 M2	10	150	1100	1550	4150	36	149400	0.62	92.6	10	150	1100	1550	4150	36	149400	0.62	92.6
21	M1 M2 M1	10	-	160	3500	3820	20	76400	0.62	47.4	10	-	160	3500	3820	20	76400	0.62	47.4
22	M2 M1 M1	10	250	160	9900	10220	14	143080	0.62	88.7	10	250	160	9900	10220	14	143080	0.62	88.7
				•	'				Total	2879.8								Total	2879.8





Project Name:- Nepal Urban Governance and Infrastructure Project (NUGIP)


DESIGNED BY:	Date: 2023
DRAWN BY:	Scale:
CHECKED BY:	Chainage:
APPROVED BY:	Sheet No: 4

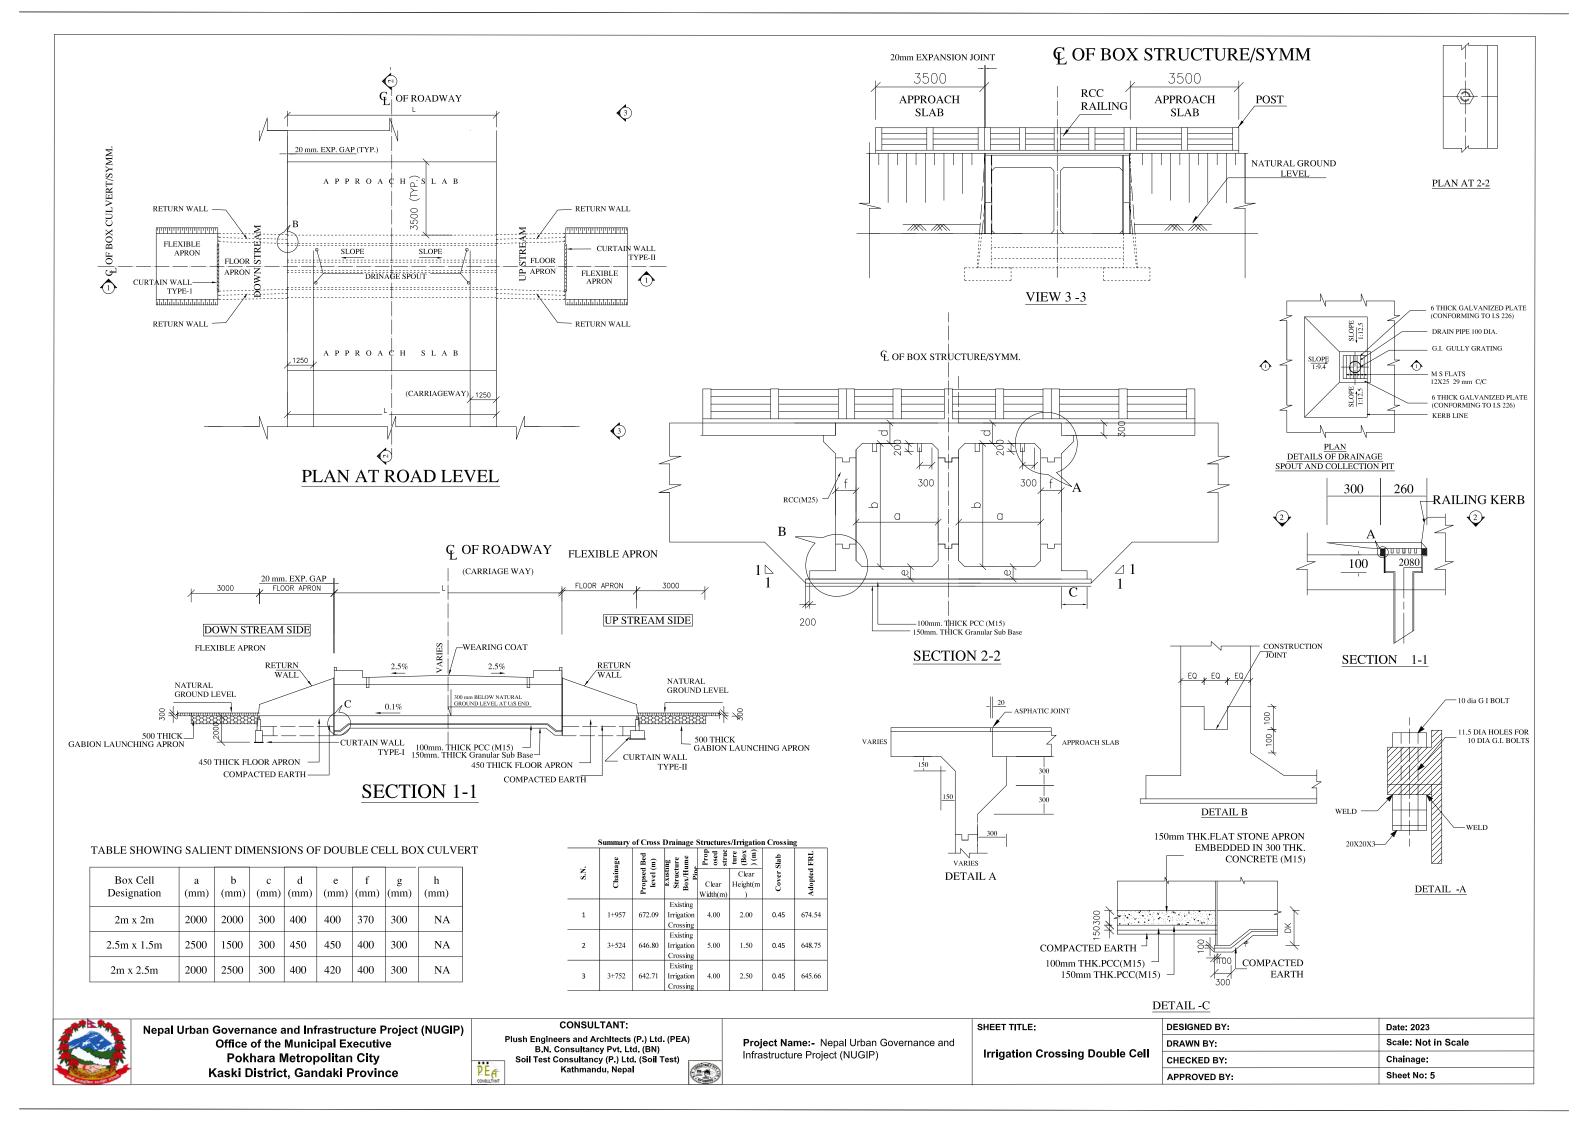

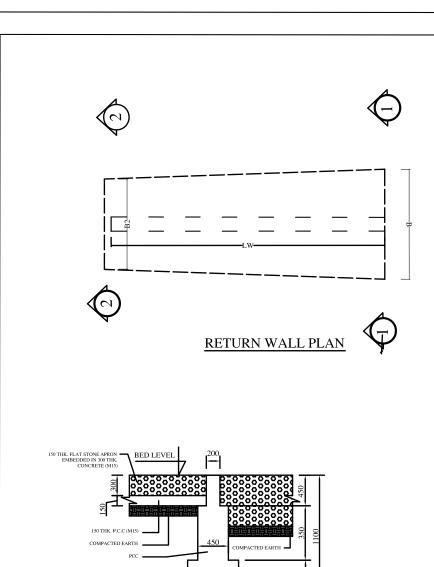


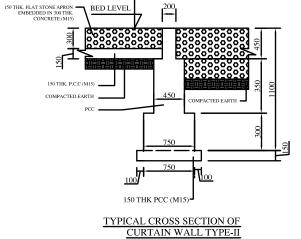


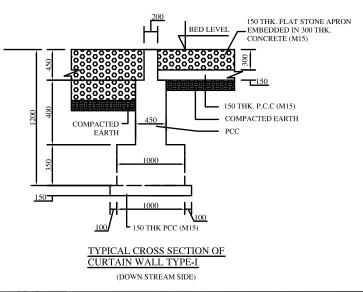

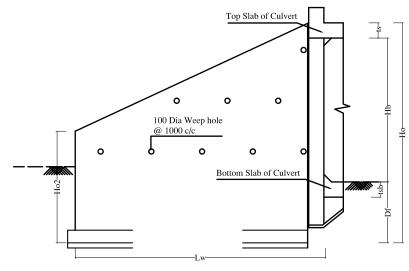

RETURN WALL ELEVATION

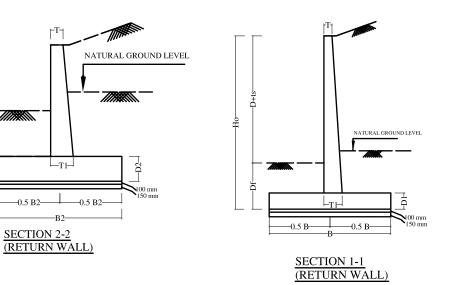


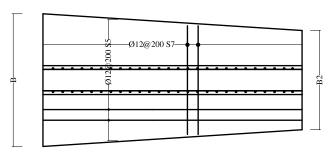


REINFORCEMENT DETAILS OF RETURN WALL PlAN (BOTTOM)

	Height of	Depth of	Max. ht.	Length of		Section	on 1 -1			Section	on 2 -2),
S.No.		Foundation.		Return Wall,	T	T1	В	D1	T	T1	B2	D2
	Hb (mm)	Df (mm)	(mm)	Lw (mm)	(mm)	(mm)	(mm)	(mm)	(mm)	(mm)	(mm)	(mm)
1	2500	1500	4400	2000	200	430	1500	400	200	400	1500	400
2	2000	1500	3900	2000	200		1500	400	200	400	1500	400
3	1500	1500	3450	2000	200		1500	400	200	400	1500	400


1. ALL DIMENSIONS ARE IN MILLIMETERS UNLESS OTHERWISE MENTIONED. NOTES: ONLY WRITTEN DIMENSIONS ARE TO BE FOLLOWED.

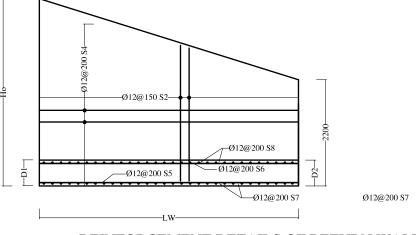


REINFORCEMENT DETAILS OF RETURN WALL (BACK FACE)

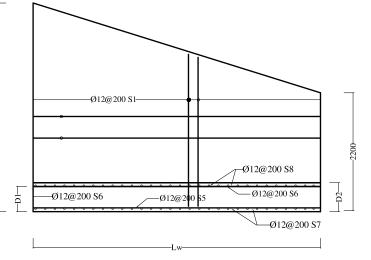

REINFORCEMENT DETAILS OF RETURN WALL (FRONT FACE)

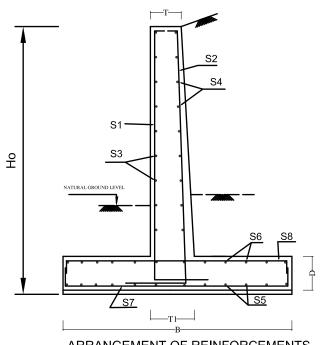

ARRANGEMENT OF REINFORCEMENTS (RETURN WALL)

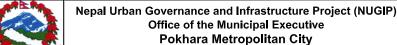

Kaski District, Gandaki Province

CONSULTANT: Plush Engineers and Architects (P.) Ltd. (PEA) B.N. Consultancy Pvt. Ltd. (BN) Soil Test Consultancy (P.) Ltd. (Soil Test)


SECTION 2-2




Project Name:- Nepal Urban Governance and Infrastructure Project (NUGIP)


DESIGNED BY: Date: 2023 Scale: Not in Scale DRAWN BY: CHECKED BY: Chainage: APPROVED BY: Sheet No: 6


SHEET TITLE: Irrigation Crossing (Return Wall

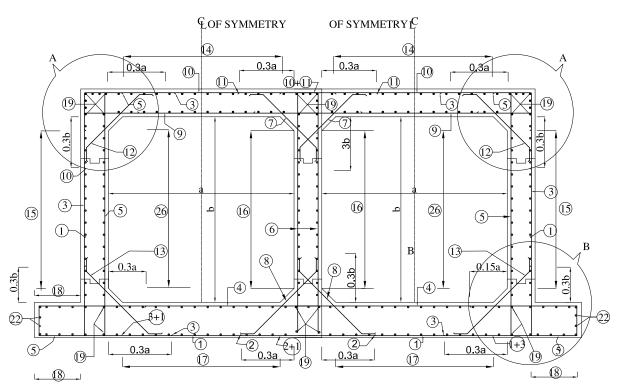


REINFORCEMENT DETAILS OF DOUBLE CELL Irrigation Crossing

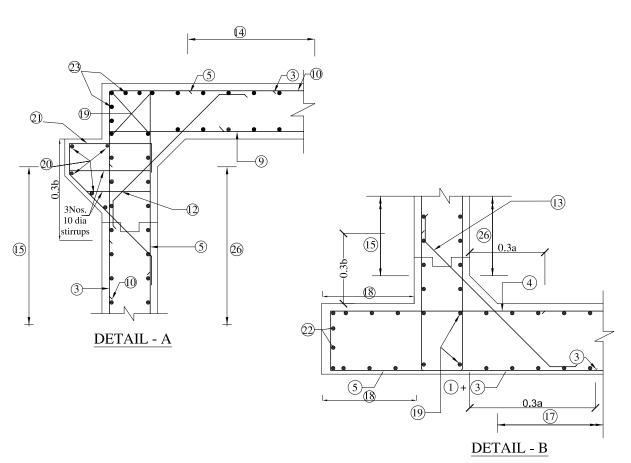


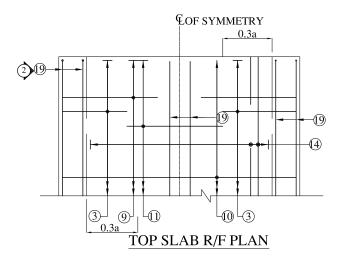

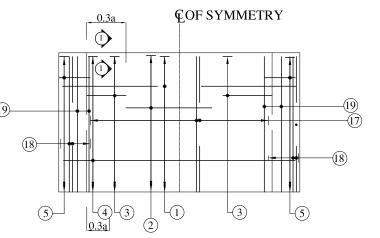


BOTTOM SLAB R/F PLAN

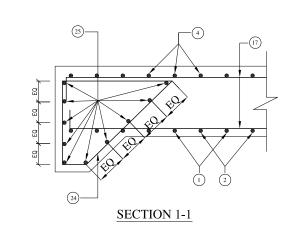

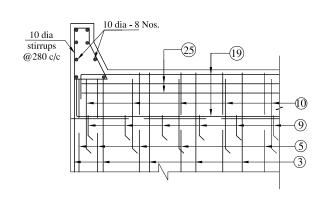

VIEW 2 - 2

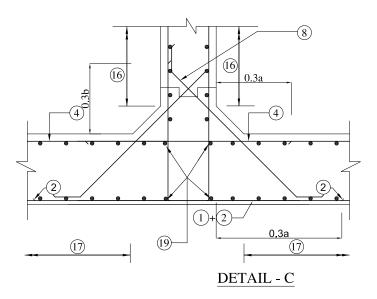

LEGEND:

: TOP FACE BARS / OUTER FACE BARS

- - : BOTTOM FACE BARS /

INNER FACE BARS



Nepal Urban Governance and Infrastructure Project (NUGIP)
Office of the Municipal Executive
Pokhara Metropolitan City
Kaski District, Gandaki Province

CONSULTANT:

Plush Engineers and Architects (P.) Ltd. (PEA) B.N. Consultancy Pvt. Ltd. (BN) Soil Test Consultancy (P.) Ltd. (Soll Test) Kathmandu, Nepal



Project Name:- Nepal Urban Governance and Infrastructure Project (NUGIP)

SHEET TITLE:

Irrigation Crossing Double Cell (Reinforcement Details)

DESIGNED BY:	Date: 2023
DRAWN BY:	Scale:
CHECKED BY:	Chainage:
APPROVED BY:	Sheet No: 7

	BOX-CELL DESIGNATION	Doub	le Cell Iı	rigation	Crossing	; 2m x2m w	vithout earth	n cushion			Dou	ble Cell	l Irrigati	on Crossi	ng 2m x2.	5m without	earth cushion	l		Double	Cell Irrigat	ion Crossi	ing 2.5m x l	1.5m withou	t earth cush	nion		
BAR MARK	Nc/ab/Ec SHAPE OF BARS (NOT TO SCALE)	BAR DIA in mm	SPACING in mm.	M1 in mm.	M2 in mm.	LENGTH in mm.	NO. OF BARS	TOTAL LENGTH in mm.	Wt/m, kg	Weight, kg	BAR DIA. in mm.	SPACING in mm.	M1 in mm.	M2 in mm.	LENGTH in mm.	NO. OF BARS	TOTAL LENGTH in mm.	Wt/m, kg	Weight, kg	BAR DIA. in mm.	SPACING in mm.	M1 in mm.	M2 in mm.	LENGTH in mm.	NO. OF BARS	TOTAL LENGTH in mm.	Wt/m, kg	Weight, kg
1	M1 M2 M1	10	200	950	4940	6840	51	348840	0.62	216.3	10	200	1270	5000	7540	51	384540	0.62	238.4	10	200	1300	6500	9100	51	489600	0.62	303.6
2	<u>M1</u>	10	200	1500	0	1500	50	75000	0.62	46.5	10	200	1500	0	1500	50	75000	0.62	46.5	10	200	1600	0	1600	50	105000	0.62	65.1
3	M2 <u>M</u> 1	12	200	920	2700	4540	102	463080	0.89	412.1 1	6 2	:00	920	3220	5060	102	567120	1.58	896.0	16	200	1250	2300	4800	102	540600	1.58	854.1
4	M2 M1 M1	12	150	300	5540	6240	67	418080	0.89	372.1	12	125	320	5600	6320	80	505600	0.89	450.0	16	200	350	7100	7850	51	425850	1.58	672.8
5	M1 0.2m. 0.2mL M2	12	125	2700	570	5970	162	967140	0.89	860.8	12	175	3220	600	7540	116	932640	0.89	830.0	12	125	2300	600	5700	160	992000	0.89	882.9
6	M2 M1	16	200	260	2700	3220	102	328440	1.58	518.9	16	200	260	3220	3740	102	432480	1.58	683.3	12	125	200	2300	2700	160	512000	0.89	455.7
7	M1 M2	12	200	200	960	1360	102	138720	0.89	123.5	12 2	200	200	950	1350	102	137700	0.89	122.6	12	200	200	1030	1430	102	145860	0.89	129.8
8	M1 M2 M1	12	200	200	960	1360	102	138720	0.89	123.5	12	200	200	990	1390	102	141780	0.89	126.2	12	200	200	1030	1430	102	145860	0.89	129.8
9	M2 M1 M1	12	125	200	4940	5340	81	432540	0.89	385.0	12	125	200	5000	5400	81	437400	0.89	389.3	16	200	260	7000	7520	51	383520	1.58	606.0
10	M2 M1 M1	10	200	950	4940	6840	51	348840	0.62	216.3	12	200	1250	5000	7500	51	382500	0.62	237.2	12	200	1000	7000	9000	51	459000	0.89	408.5
11	M1	16	200	1500	0	1500	50	75000	1.58	118.5	16	200	1500	0	1500	50	75000	1.58	118.5	16	200	2100	0	2100	50	105000	1.58	165.9
12	M1 M2	12	200	200	1060	1460	102	148920	0.89	132.5	12	200	200	1100	1500	102	153000	0.89	136.2	12	200	200	1170	1570	102	160140	0.89	142.5
13	M1 M2 M1	12	200	200	1060	1460	102	148920	0.89	132.5	12	200	200	1130	1530	102	156060	0.89	138.9	12	200	200	1170	1570	102	160140	0.89	142.5
14	M2 M1 M1	8	150	200	9900	10300	46	473800	0.4	189.5	10	150	250	9900	10400	46	478400	0.62	296.6	10	150	250	9900	10400	72	748800	0.62	464.3
15	M2 M1 M1	8	150	200	9900	10300	23	236900	0.4	94.8	10	150	200	9900	10300	35	360500	0.62	223.5	10	150	200	9900	10300	23	236900	0.62	146.9
16	M2 M1 M1	8	150	200	9900	10300	24	247200	0.4	98.9	10	150	160	9900	10220	35	357700	0.62	221.8	10	150	160	9900	10220	23	235060	0.62	145.7
17	M2 M1 M1	8	150	200	9900	10300	48	494400	0.4	197.8	10	150	210	9900	10320	48	495360	0.62	307.1	10	150	225	9900	10350	72	745200	0.62	462.0
18	M2 M1 M1	8	150	200	9900	10300	10	103000	0.4	41.2	10	150	210	9900	10320	12	123840	0.62	76.8	10	150	225	9900	10350	12	124200	0.62	77.0
19	M2 M1 M1	10	-	160	9900	10220	16	163520	0.62	101.4	10	-	160	9900	10220	16	163520	0.62	101.4	10	-	160	9900	10220	16	163520	0.62	101.4
20	M1	12	-	9900	0	9900	10	99000	0.89	88.1	12	-	9900	0	9900	10	99000	0.89	88.1	12	-	9900	0	9900	10	99000	0.89	88.1
21	[M1] M2]	12	200	1000	1260	2260	99	223740	0.89	199.1	12	200	1000	1260	2260	99	223740	0.89	199.1	12	200	1000	1260	2260	102	230520	0.89	205.2
22	M1 M2 M1	10	-	160	9900	10220	2	20440	0.62	12.7	10	-	160	9900	10220	2	20440	0.62	12.7	10	-	160	9900	10220	2	20440	0.62	12.7
23	M1 M2 M1	10	-	180	9900	10260	4	41040	0.62	25.4	10	-	180	9900	10260	4	41040	0.62	25.4	10	-	160	9900	10220	4	40880	0.62	25.3
24	M1+0.20 m M1 M2 M2	10	150	1100	1550	4150	76	315400	0.62	195.5	10	150	1100	1550	4150	76	315400	0.62	195.5	10	150	1100	1550	4150	102	423300	0.62	262.4
25	M1 M2 M1	10	_	160	5540	5860	20	117200	0.62	72.7	10	_	160	5600	5920	20	118400	0.62	73.4	10	-	160	7600	7920	20	158400	0.62	98.2
26	M2 M1 M1	10	250	180	9900	10260	16	164160	0.62	101.8	10	250	200	9900	10300	16	164800	0.62	102.2	10	250	200	9900	10300	16	164800	0.62	102.2
										5077.3									6336.7									7150.7



CONSULTANT:


Plush Engineers and Architects (P.) Ltd. (PEA)
B.N. Consultancy Pvt. Ltd. (BN)
Soil Test Consultancy (P.) Ltd. (Soll Test)
Kathmandu, Nepal

Project Name:- Nepal Urban Governance and Infrastructure Project (NUGIP)

SHEET TITLE:

Irrigation Crossing Double Cell (Reinforcement Details)

DESIGNED BY:	Date: 2023
DRAWN BY:	Scale:
CHECKED BY:	Chainage:
APPROVED BY:	Sheet No: 8

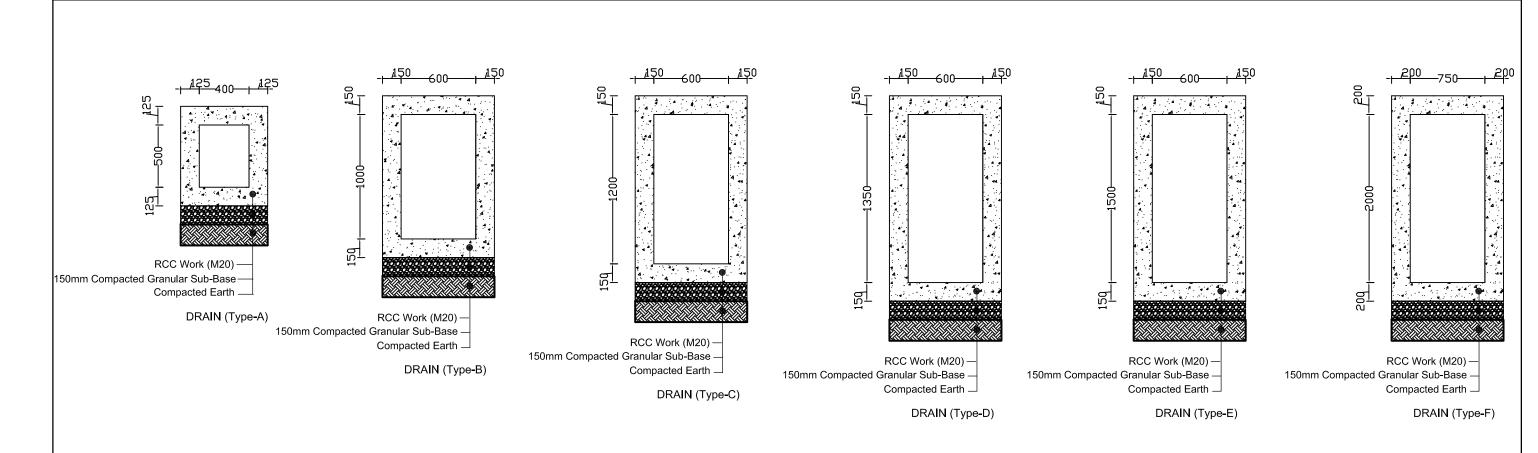

Summary of of Road Side Drain-Both sides

	<u>Sumr</u>	nary of of	'Road S	<u>ide Drair</u>	<u>ı-Both sid</u>	<u>es</u>
С	Н	Length	Width	Final Gross		Remarks
				Depth	Catageroy	
From	То	L	b	D		
	ı+m	m	m	m		
0+000.0	0+118.0	118.00	0.40	0.5	Α	Proposed Drain
	Summa	ary of Irrigation	canal cum f	Roade Side [Orain (Both sid	es)
			Average	Average		
СН		Length	Width	Gross		Remarks
				Depth	Catageroy	
From	То	L	b	D		
Km+m		m	m	m		
0+118.0	0+598.2	480.20	0.60	1.00	В	
0+598.2	1+237.4					
1+237.4	1+333.0					
1+333.0	1+957.0					
2+260.0	3+200.0					
3+599.0	3+752.0	3273.51	0.60	1.20	С	RCC Rectangular
3+752.0	4+140.0					
2+020.0	2+260.0					
3+200.0	3+319.0	9.0				
3+524.3	3+599.0					
3+445.5	3+524.3	78.82	0.60	1.35	D	
3+319.0	3+445.5	126.50	0.60	1.50	E	
1+957.0	2+020.0	63.00	0.75	2.00	F	

Note:- Size of irrigation canal cum side drain is based on existing site and existing invert level of inlet of existing irrigation canal

Project Name:- Nepal Urban Governance and Infrastructure Project (NUGIP)

Nepal Urban Governance and Infrastructure Project (NUGIP)
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Pokhara Metropolitan City
Kaski District, Gandaki Province







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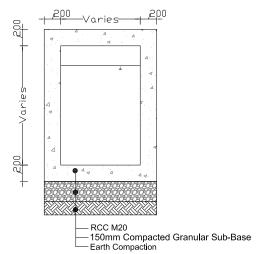
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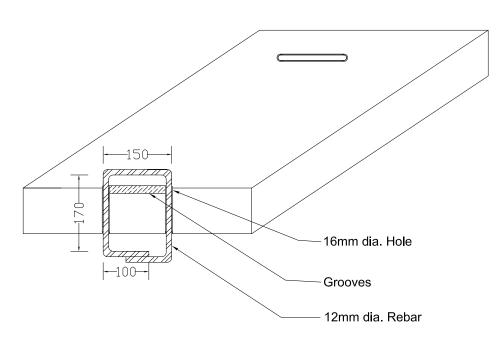
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CHECKED BY :	Chainage:					
APPROVED BY :	Sheet No. :1					



PLAN OF DRAIN

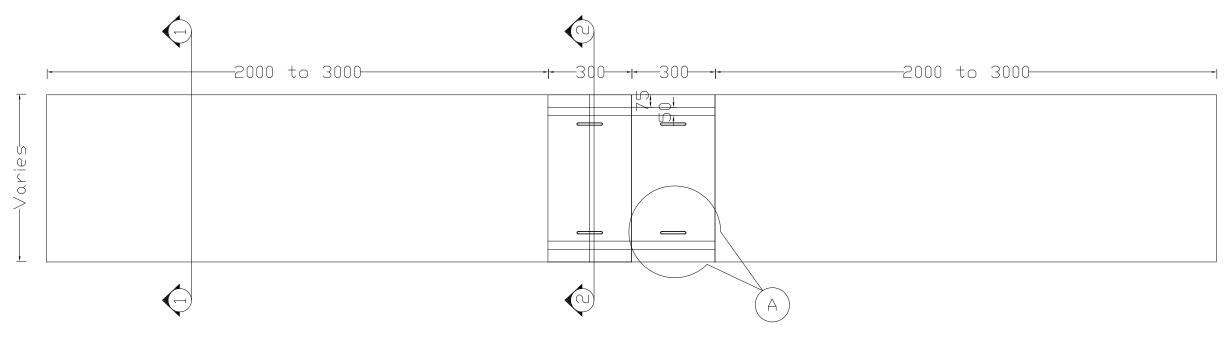



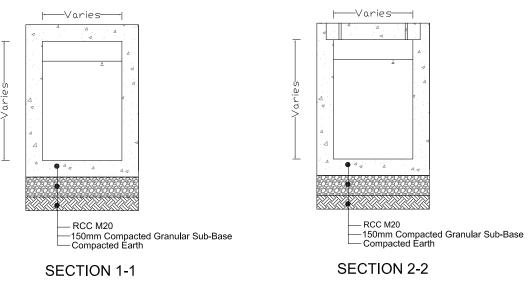

DETAIL AT- A

AT ROAD CROSSING

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B.N. Consultancy Pvt. Ltd. (BN)
Soil Test Consultancy (P.) Ltd. (Soil Test)
Kathmandu, Nepal


Infrastructure P

Project Name:- Nepal Urban Governance and Infrastructure Project (NUGIP)


Typical Side Drain

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Reinforcement Details at Section 2-2

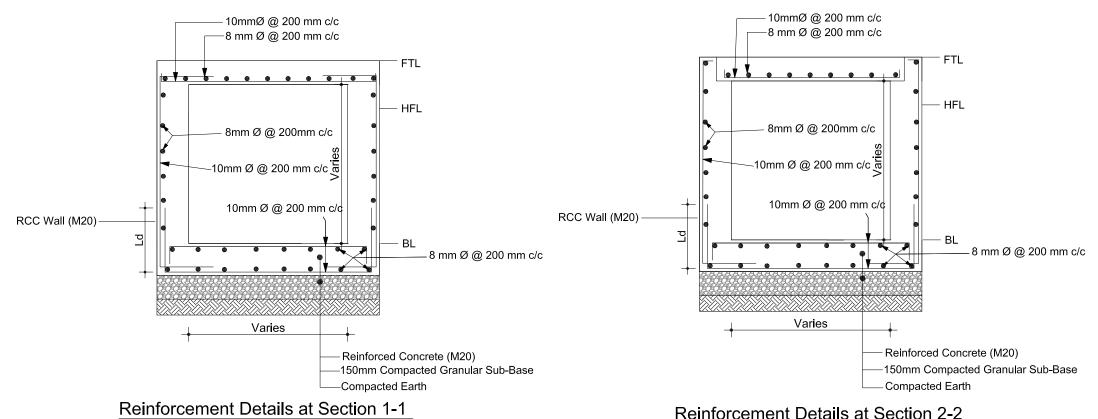

Reinforcement Details at Road Crossing

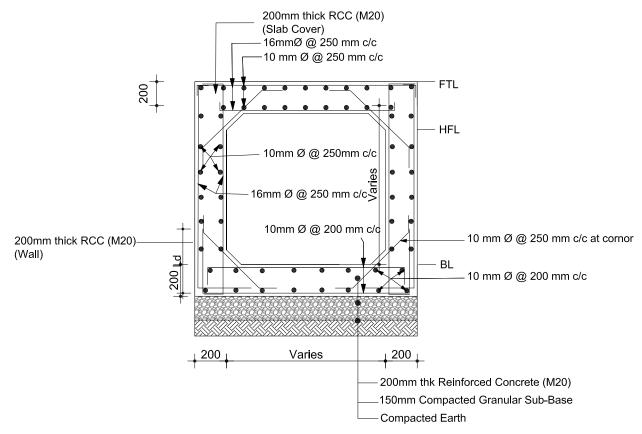

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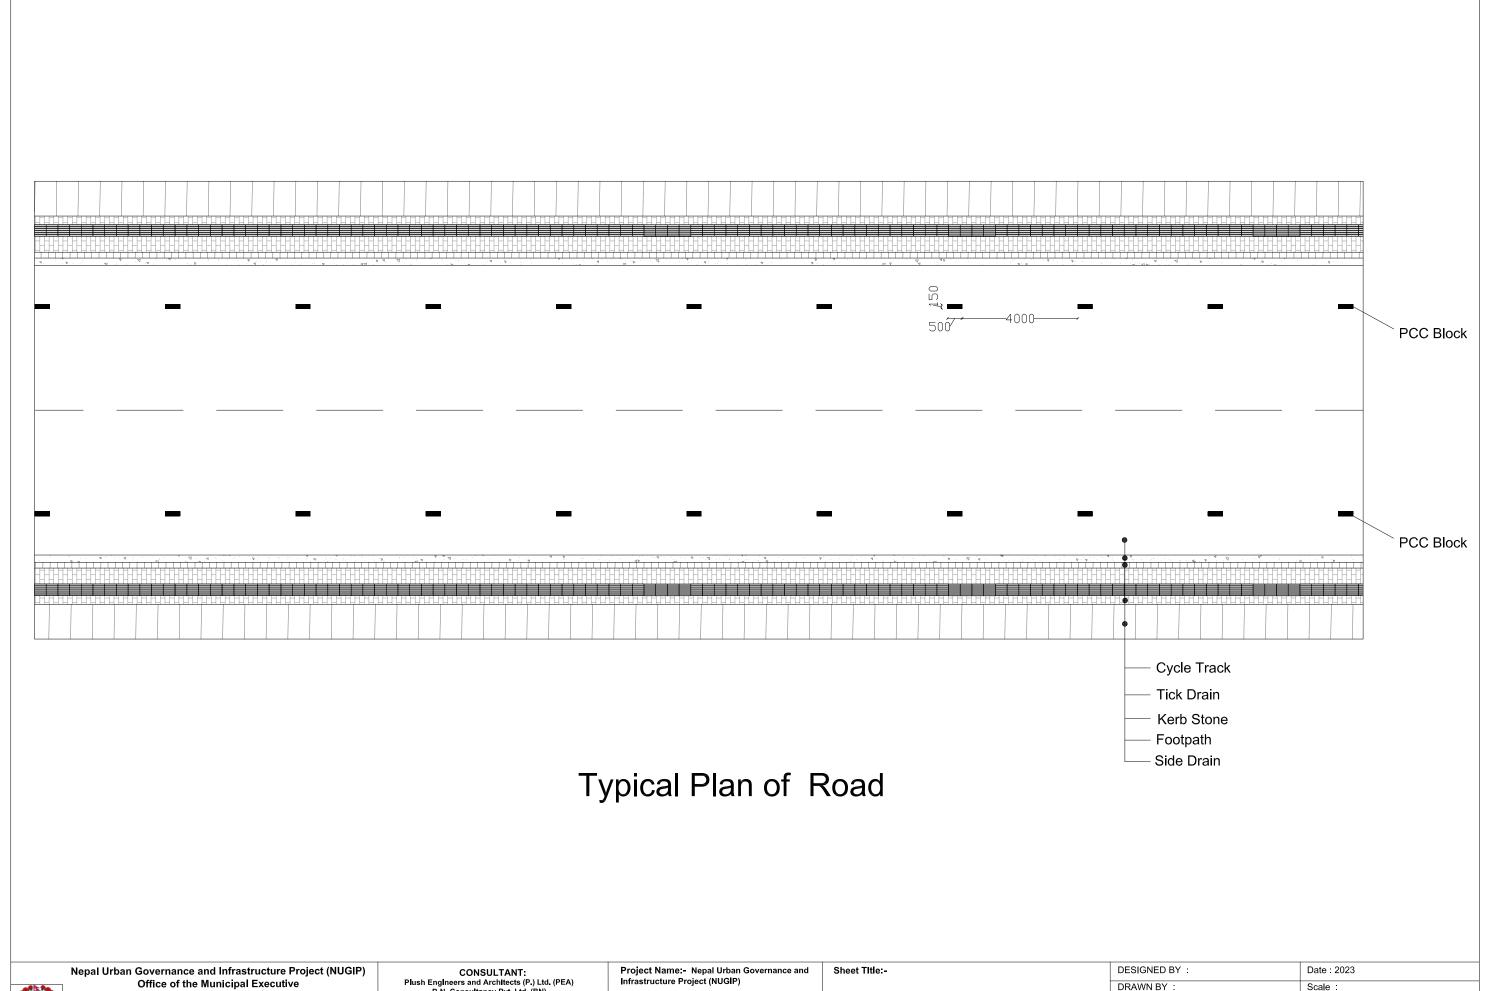
CONSULTANT:
Plush Engineers and Architects (P.) Ltd. (PEA)
B.N. Consultancy Pvt. Ltd. (BN)
Soil Test Consultancy (P.) Ltd. (Soil Test)
Kathmandu, Nepal

Project Name:- Nepal Urban Governance and Infrastructure Project (NUGIP)

Sheet Title:-

Typical Side Drain

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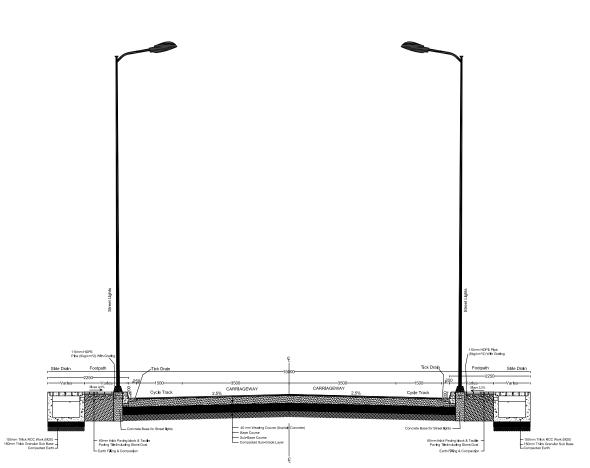


Nepal Urban Governance and Infrastructure Project (NUGIP)
Office of the Municipal Executive
Pokhara Metropolitan City Kaski District, Gandaki Province

CONSULTANT:
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Soil Test Consultancy (P.) Ltd. (Soil Test)
Kathmandu, Nepal

Typical Plan of Road


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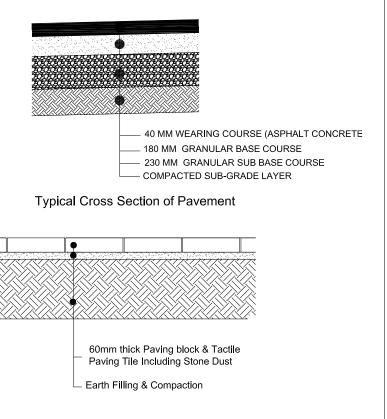
Kerb stone 110mm HDPE Pipe (6kg/cm^2) With Grati Side Drain ∠Tick Drain 75mm PCC (M15) -Varies Slope 2.5% Cycle Track KERB STONE DETAILS - Concrete Base for Street lights 150mm Thick RCC Work (M20) — 150mm Thick Granular Sub Base — Compacted Earth - 60mm thick Paving block & Tactile Paving Tile Including Stone Dust - Earth Filling & Compaction

Typical Cross Section of Footpath

Typical Cross Section of Road





Footpath Plan

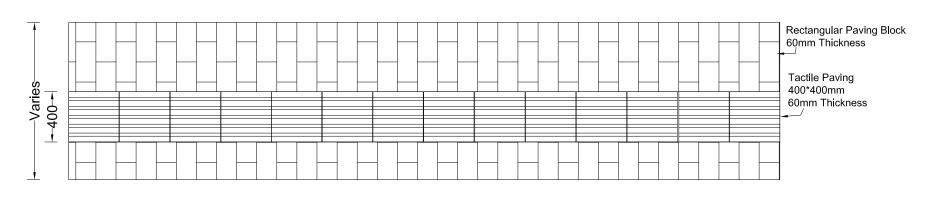

FOOTPATH DETAILS



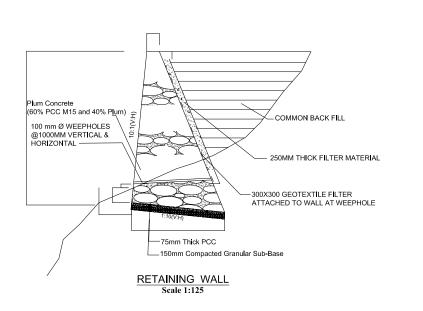

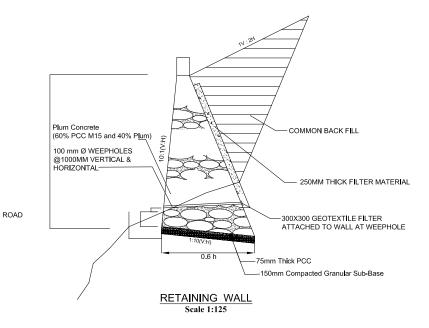

- 1. Wall height is to be modified as per actual site condition or as directed by the Engineer.
- 2. Wall height for more than 6.0 m, soil investigation is to be done or as directed by the Engineer.
- 3. Expansion Joint is to be provided maximum at a distance of 10.0 m $\mbox{C/C}$.It should be located, wherever possible, at every major changes in the wall height or as directed by the Engineer.
- 4. Mortar joint width to be 25mm to 35mm. Exposed face of masonry is to be free from mortar stains.
- 5. Minimum depth of foundation shall be 600mm or as directed by the Engineer.
- 6. Lowest weep hole should not be more than 200mm above final ground level at the toe of wall or as directed by the Engineer.
- 7. Place the foundation inclined at 10% slope
- 8. Retaining wall shall be curved in plan & profile to the center line of road where directed by the Engineer.
- 9. Wall interior is not to be filled with dry stone rubble.
- $10. \ Others \ not \ mentioned \ shall \ be \ in \ accordance \ with \ the \ specifications \ and \ special \ provisions$

Nepal Urban Governance and Infrastructure Project (NUGIP) Office of the Municipal Executive Pokhara Metropolitan City Kaski District, Gandaki Province

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Kathmandu, Nepal




Project Name:- Nepal Urban Governance and Infrastructure Project (NUGIP)


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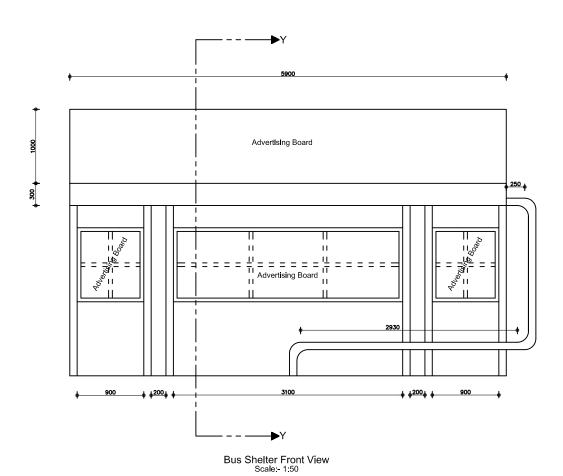
Typical Retaining Wall


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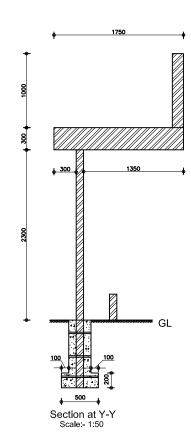





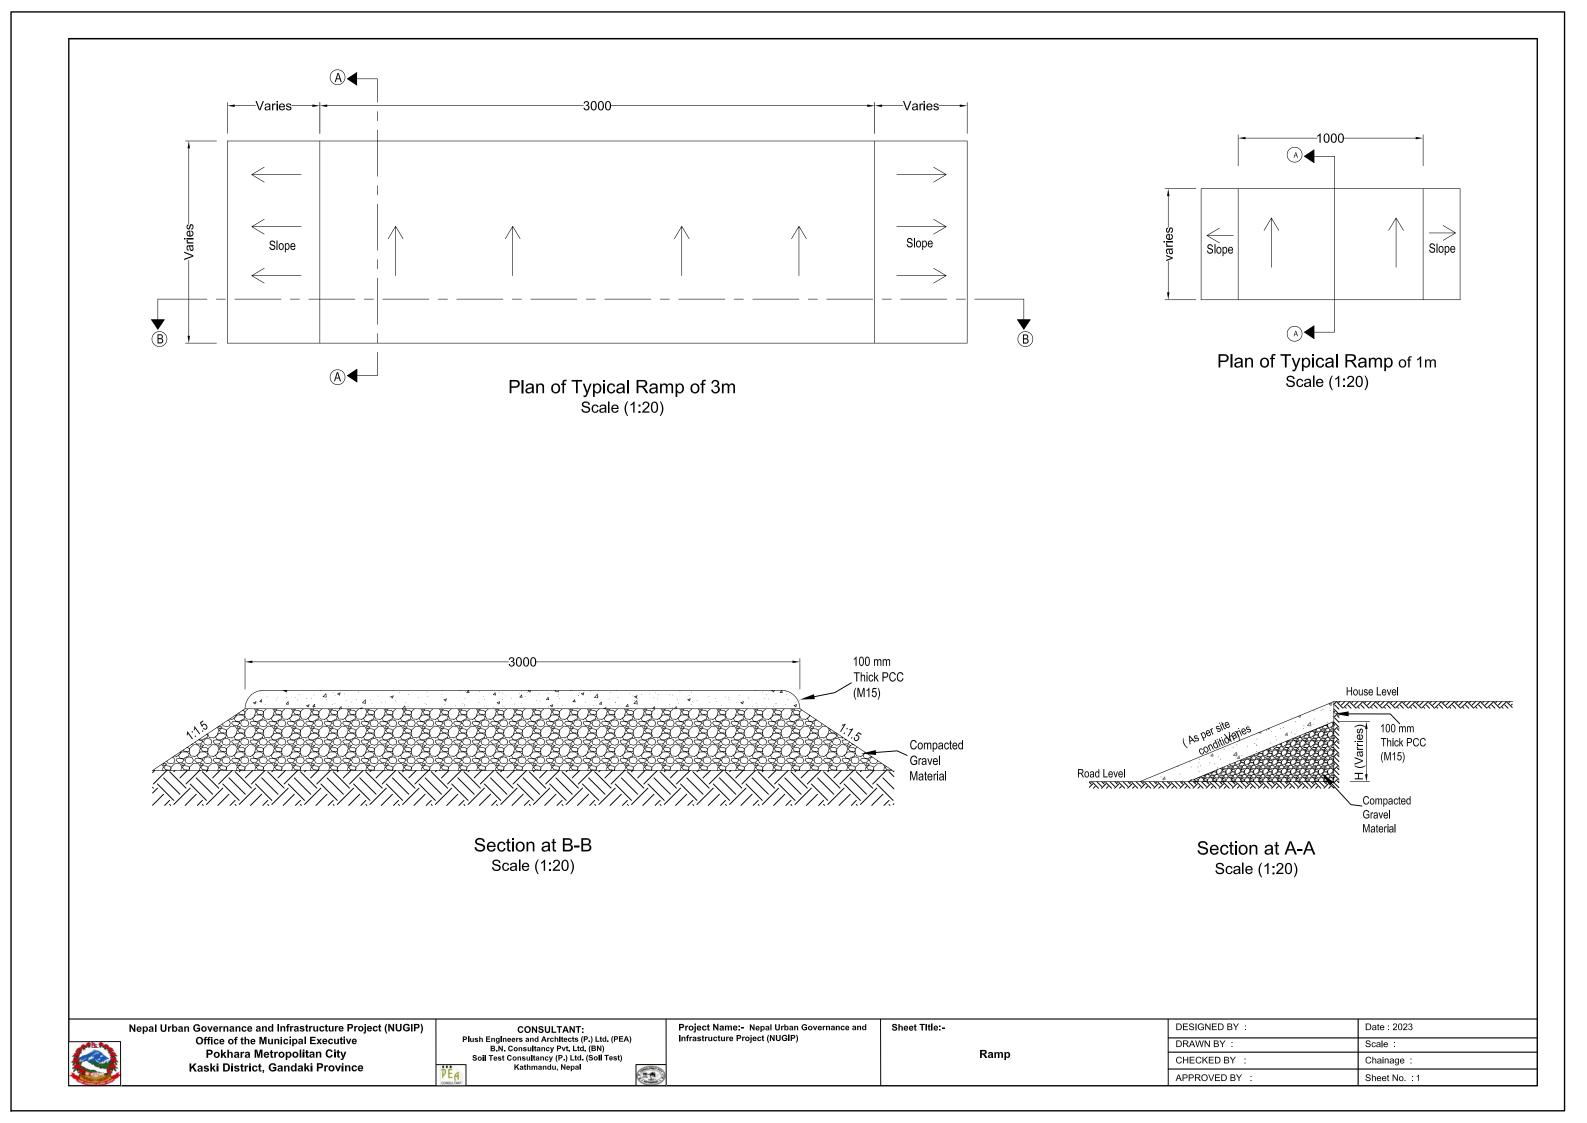



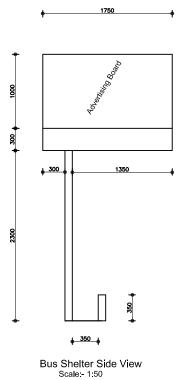

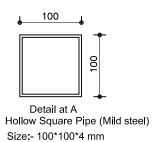

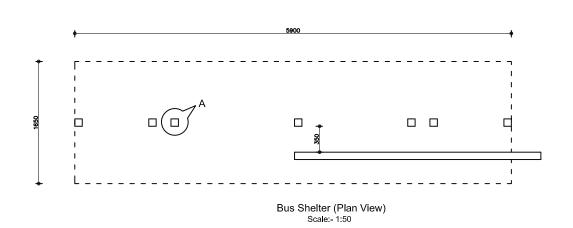



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B.N. Consultancy Pvt. Ltd. (BN)
Soil Test Consultancy (P.) Ltd. (Soil Test)
Kathmandu, Nepal


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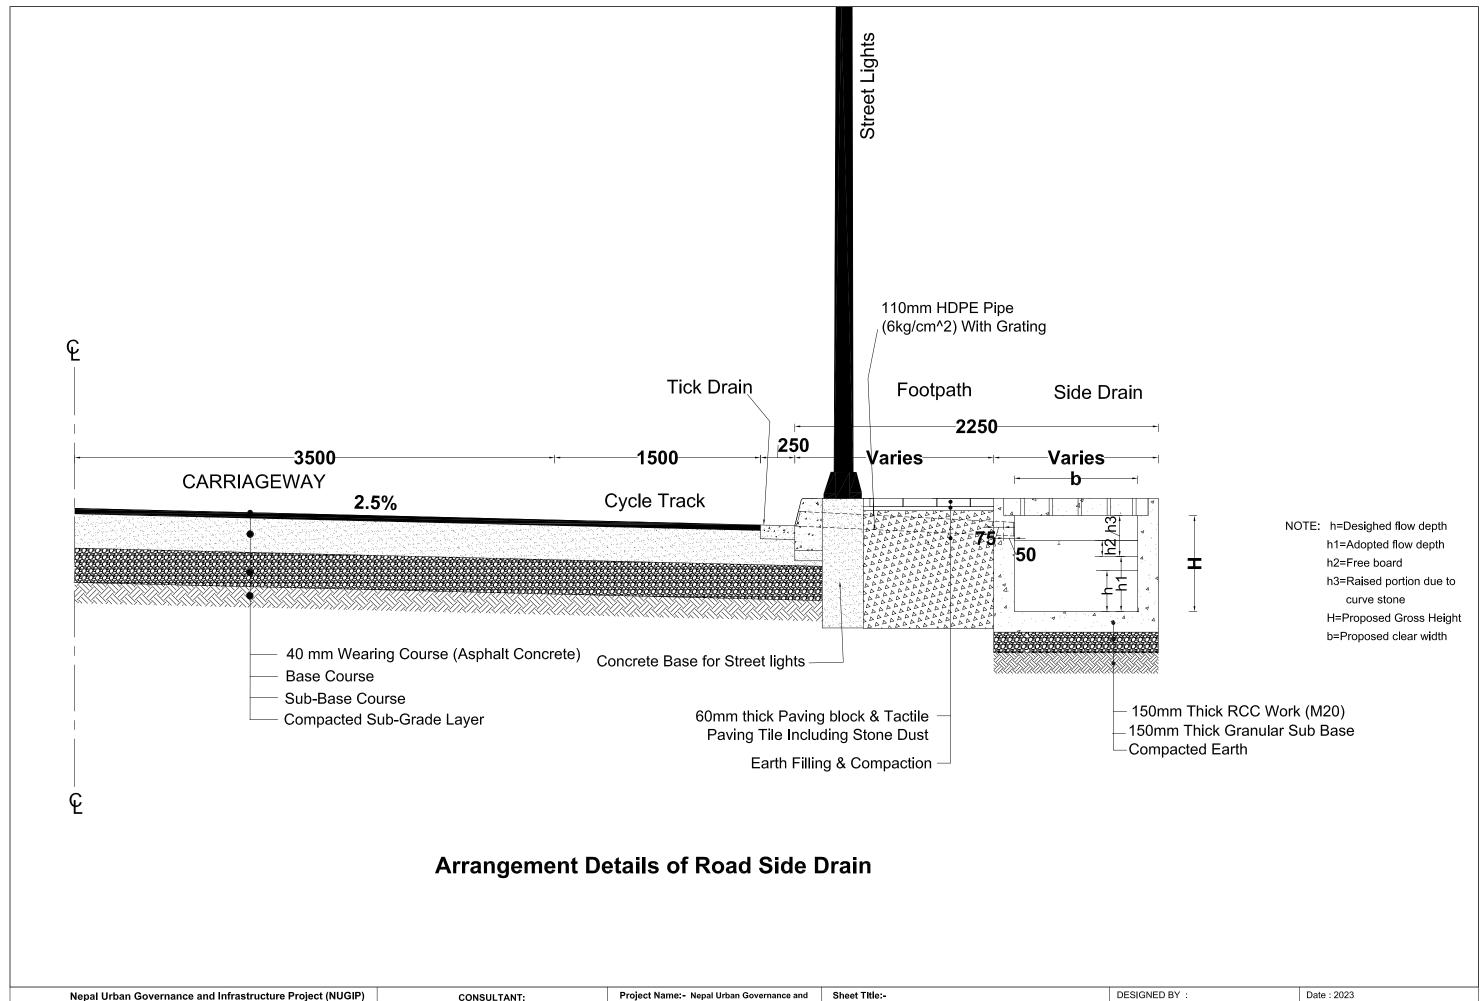
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Sheet Title:-

Bus Shelter

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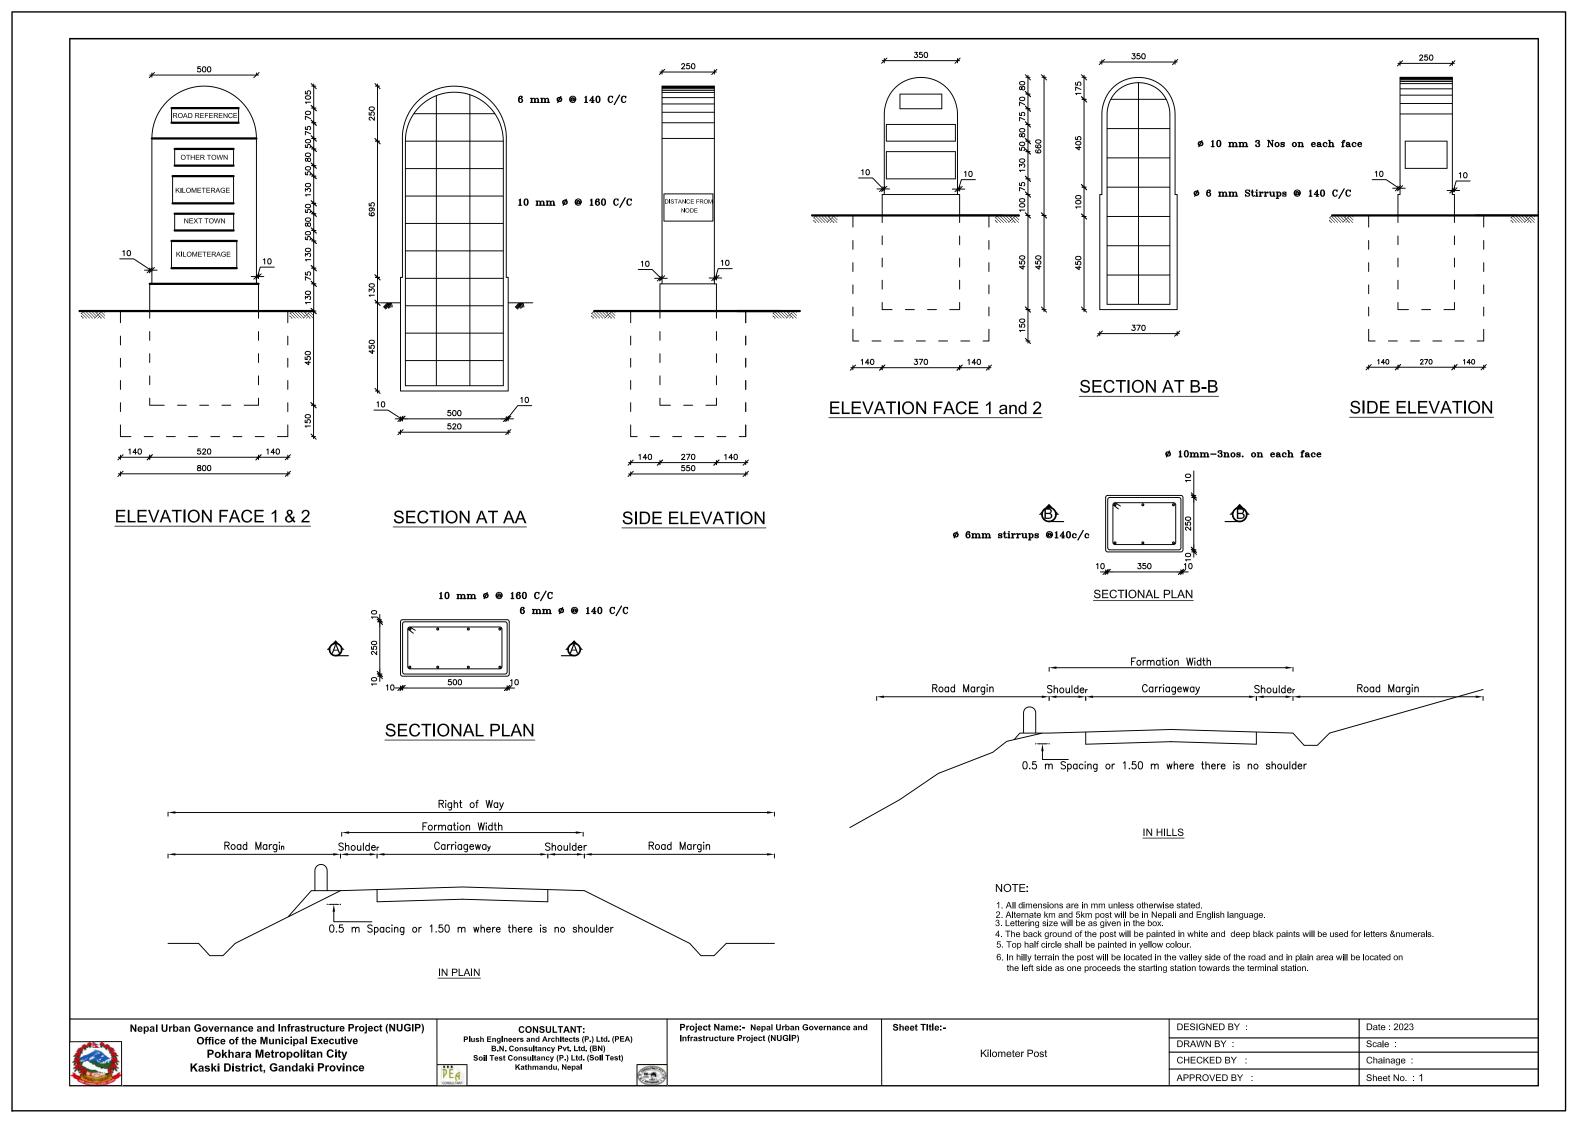



Project Name: - Nepal Urban Governance and Infrastructure Project (NUGIP)


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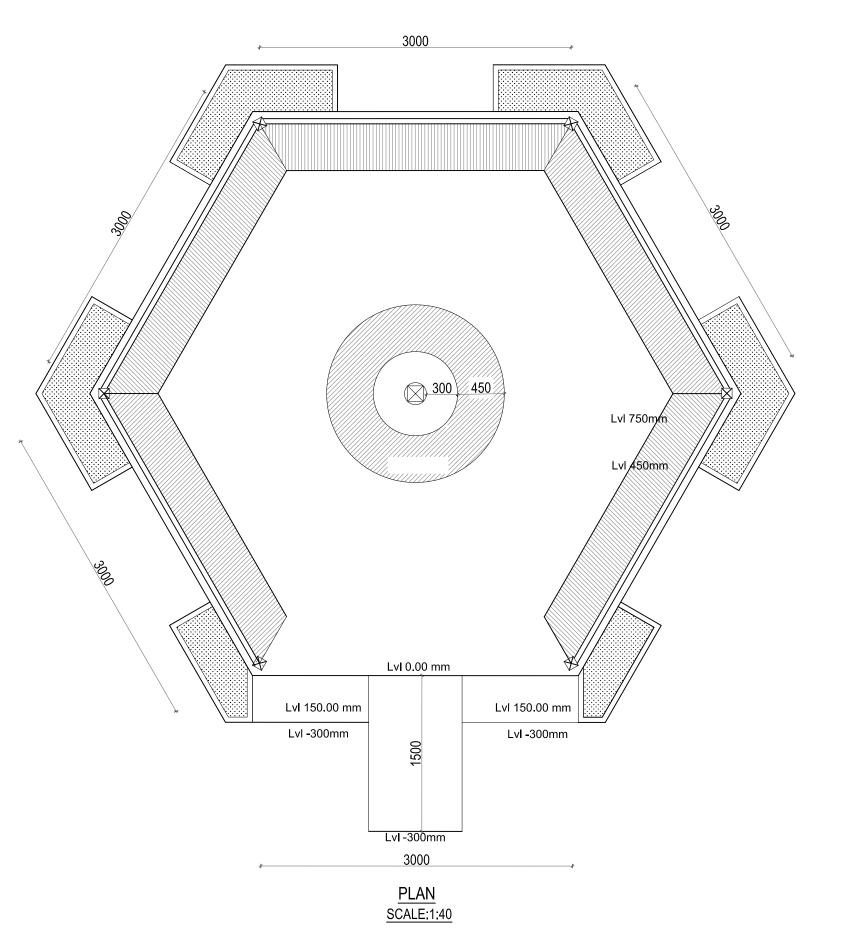
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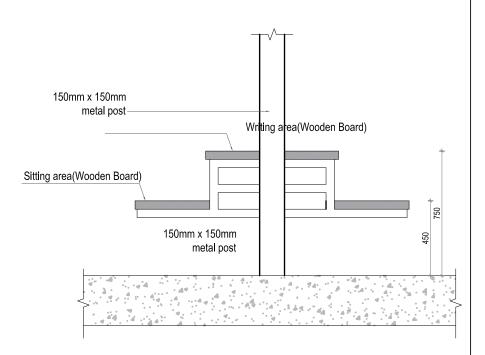
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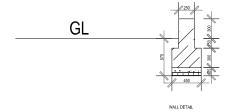


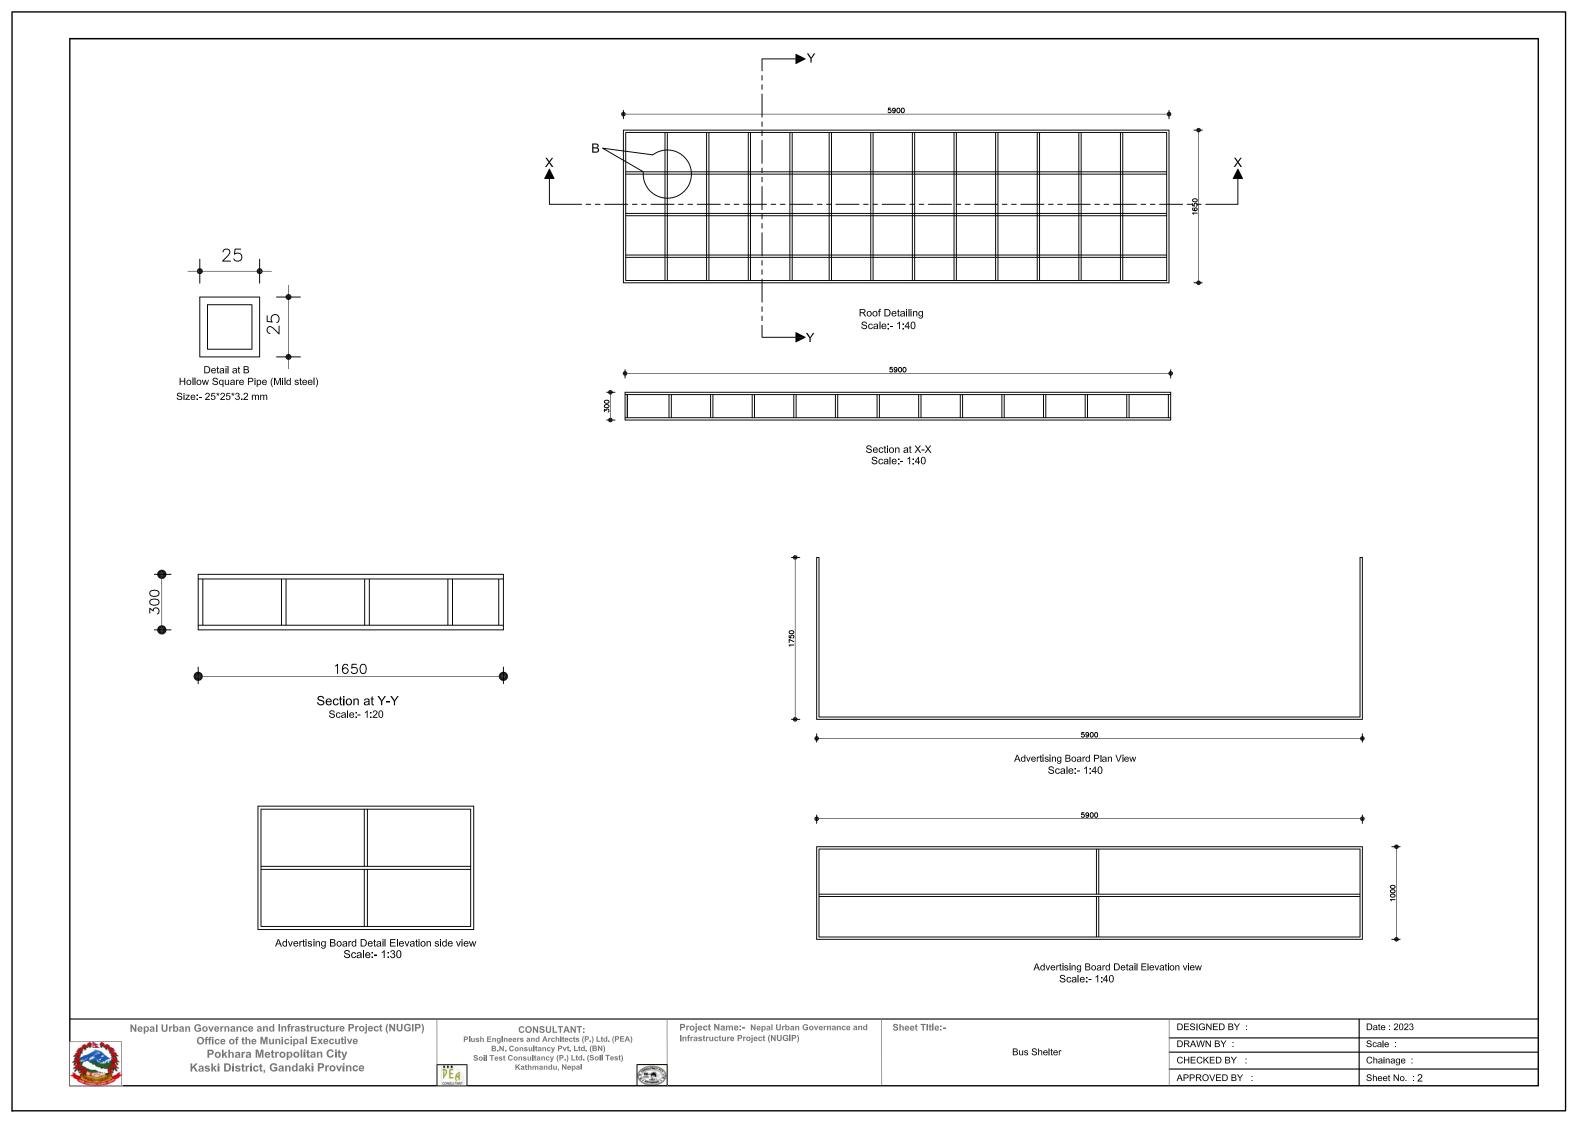





DETAIL OF CENTRAL SEATING/WRITING AREA

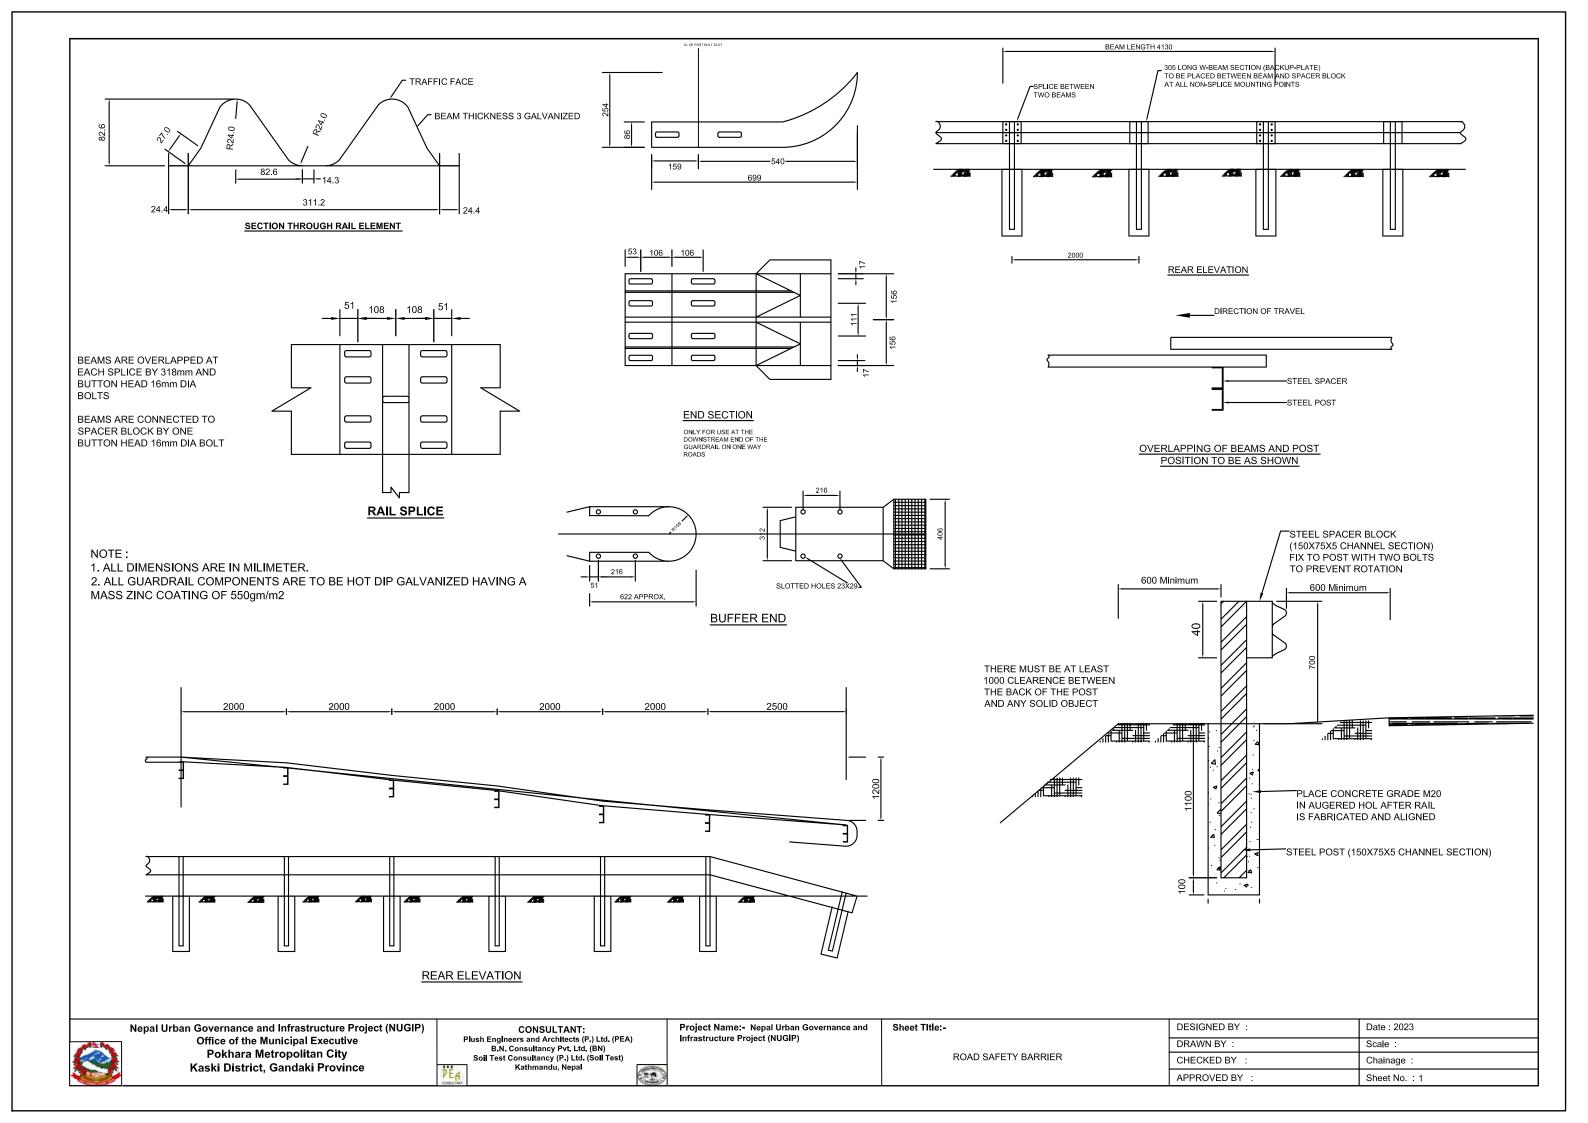SCALE:1:25

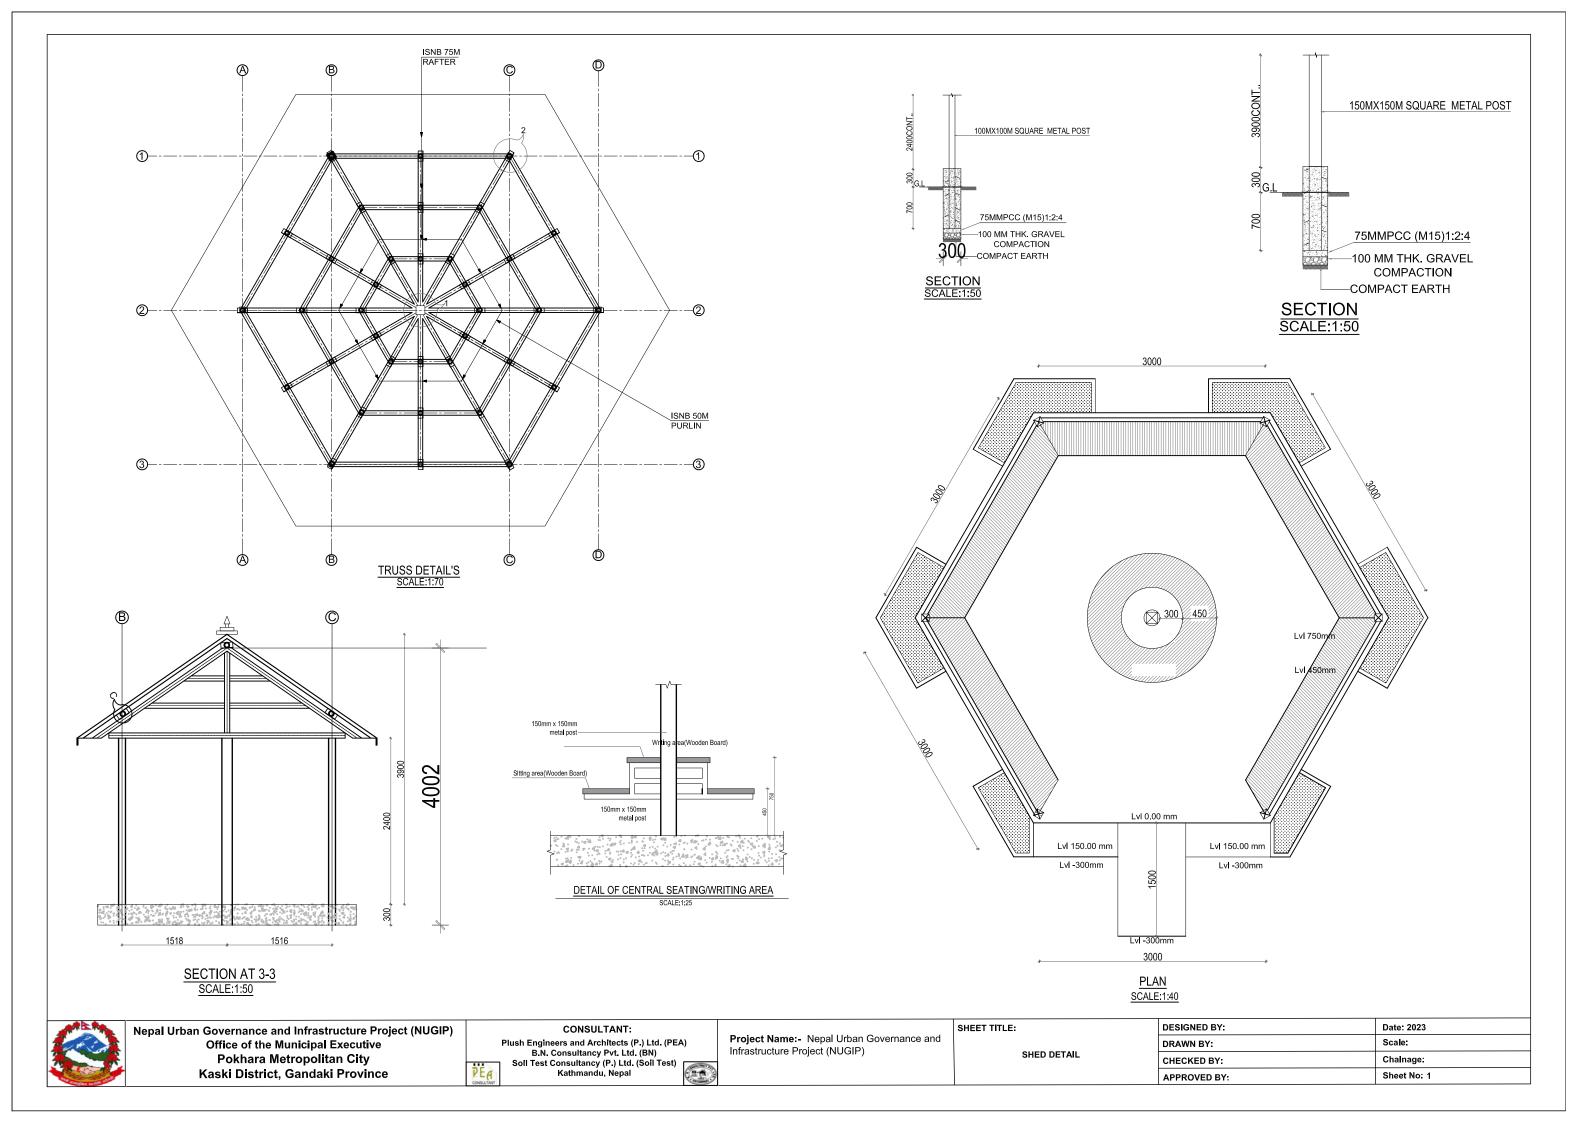


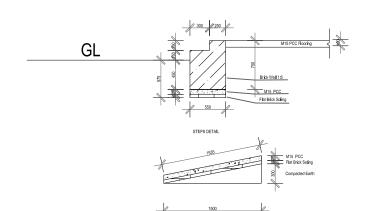

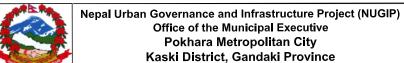





Plush Engineers and Architects (P.) Ltd. (PEA)
B.N. Consultancy Pvt. Ltd. (BN)
Soll Test Consultancy (P.) Ltd. (Soil Test)
Kathmandu, Nepal

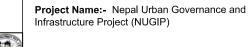

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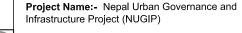


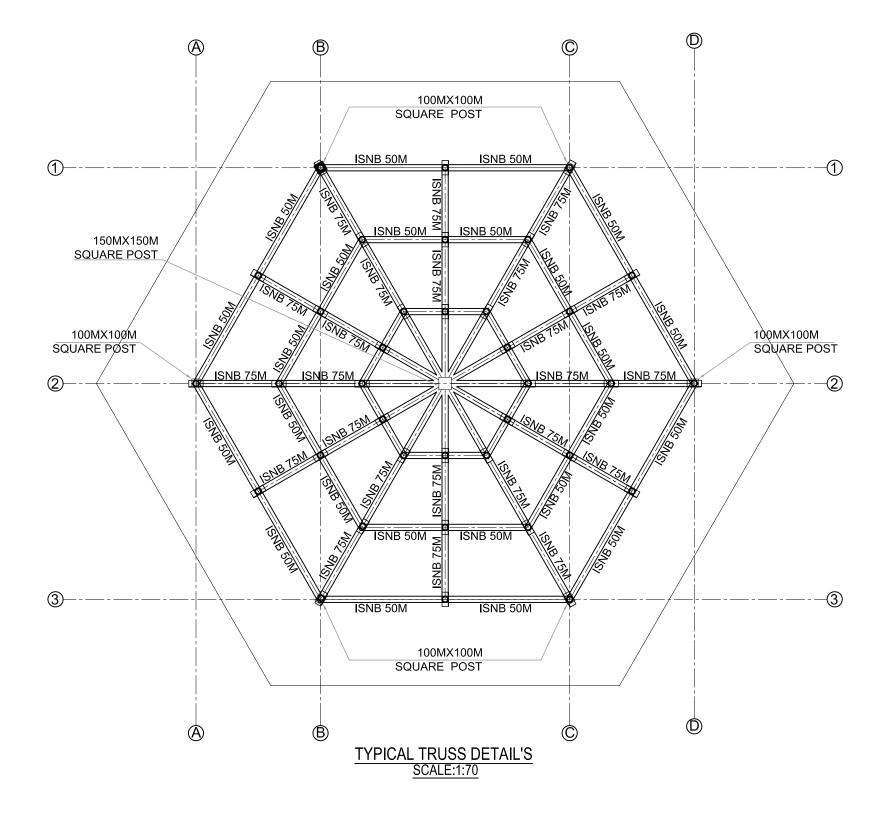

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Kaski District, Gandaki Province

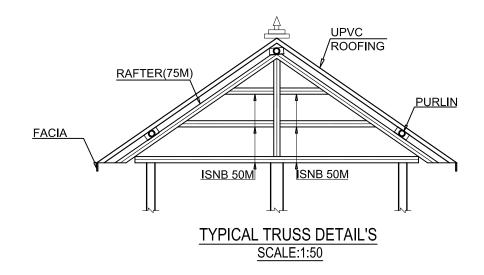CONSULTANT:

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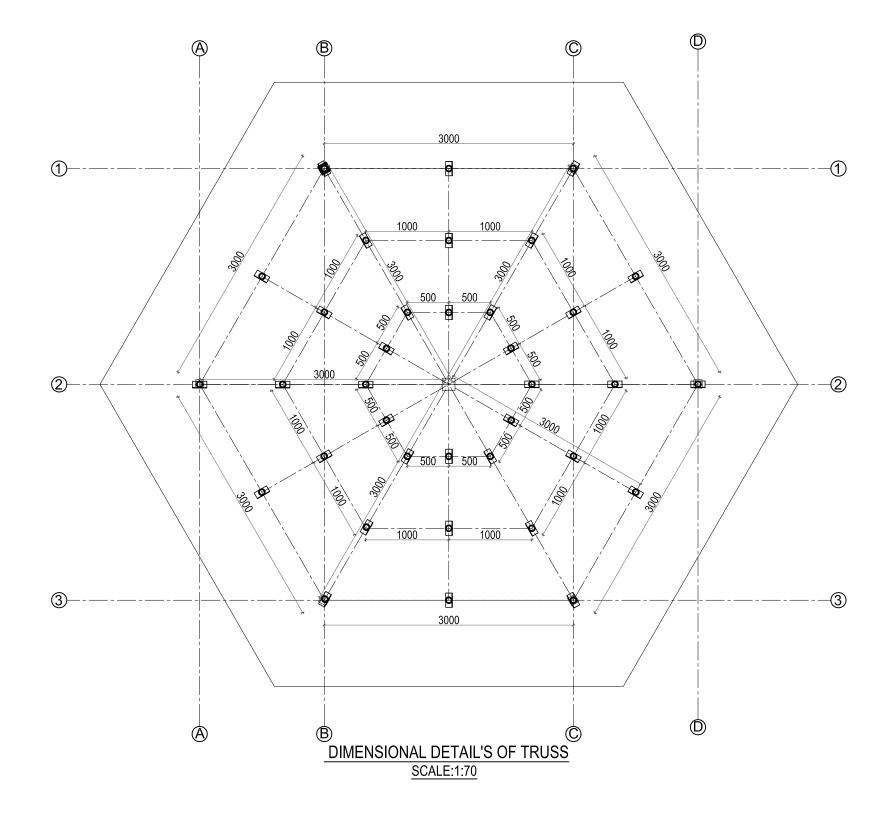
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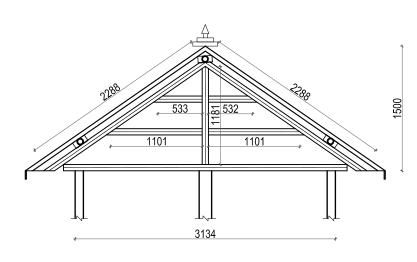
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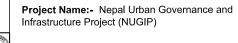
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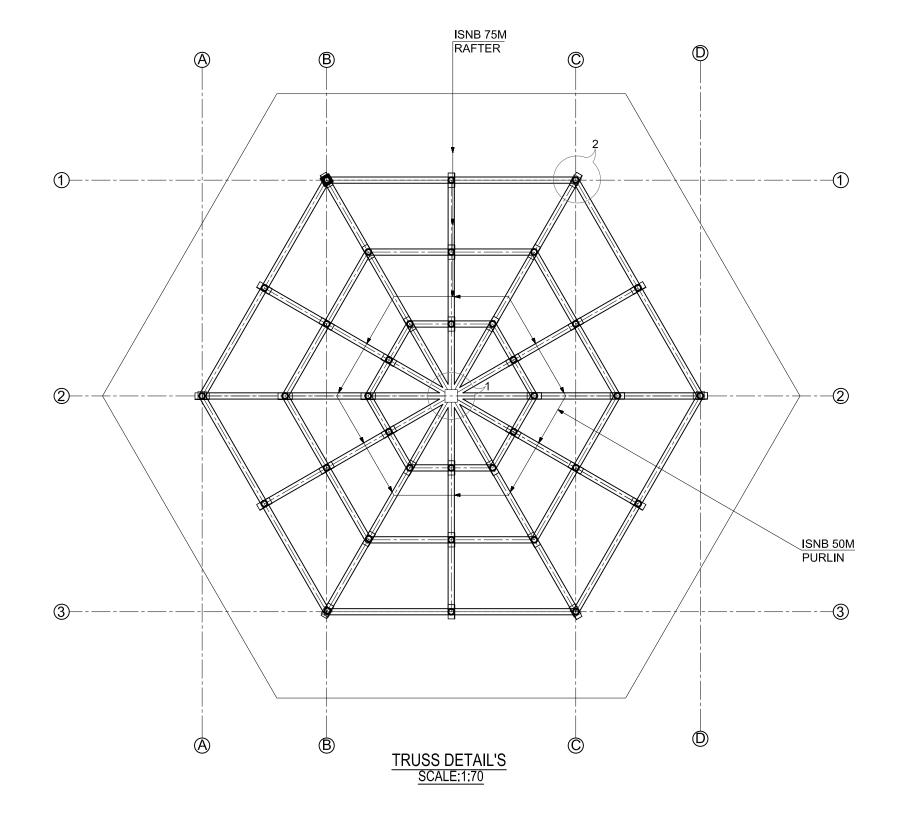
CONSULTANT: Plush Engineers and Architects (P.) Ltd. (PEA)
B.N. Consultancy Pvt. Ltd. (BN)
Soll Test Consultancy (P.) Ltd. (Soil Test)
Kathmandu, Nepal





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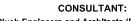







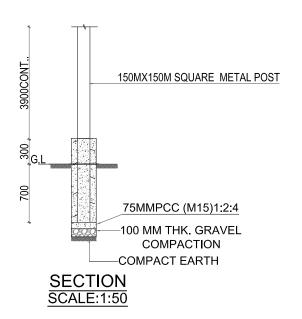

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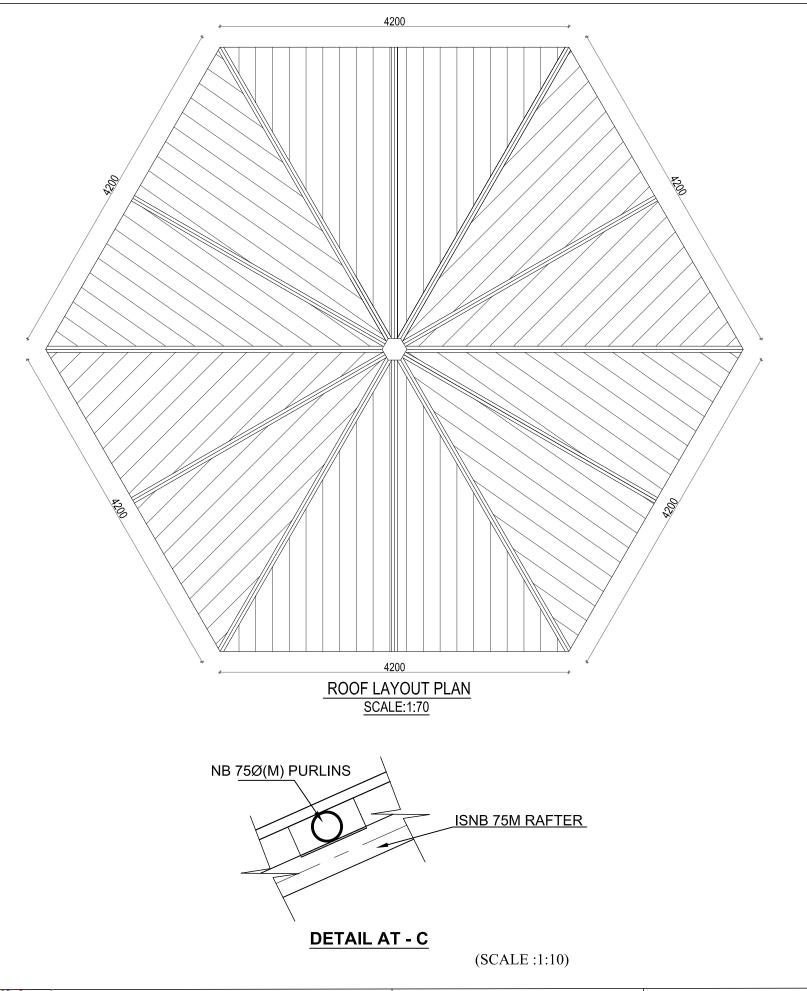
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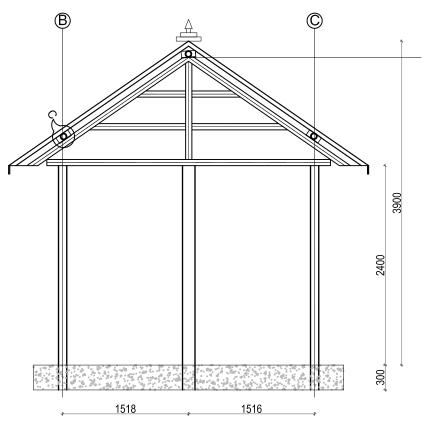

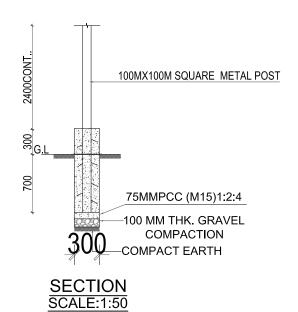
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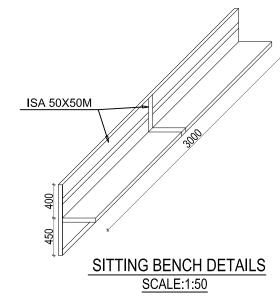
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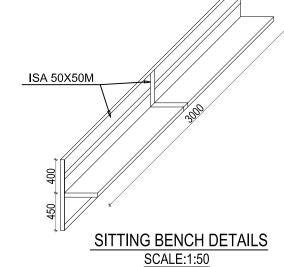
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SECTION AT 3-3 SCALE:1:50



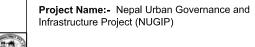



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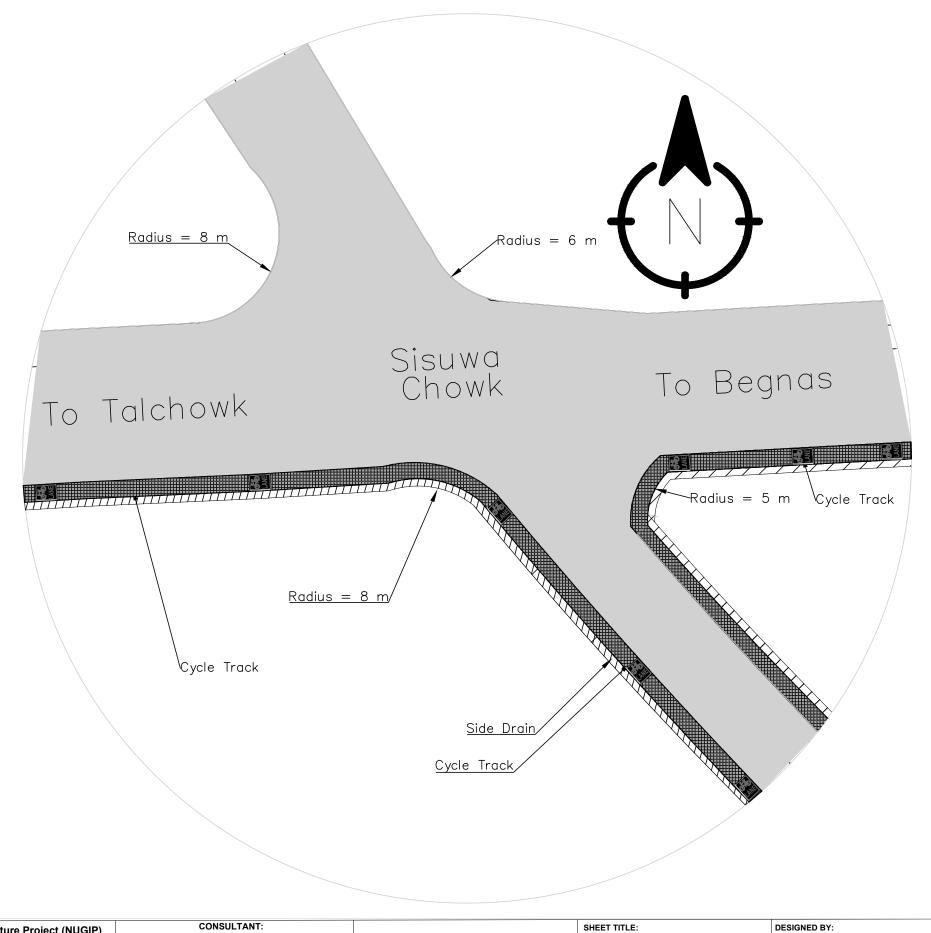
Plush Engineers and Architects (P.) Ltd. (PEA)
B.N. Consultancy Pvt. Ltd. (BN)
Soll Test Consultancy (P.) Ltd. (Soil Test)
Kathmandu, Nepal

Project Name:- Nepal Urban Governance and Infrastructure Project (NUGIP)

SHEET TITLE:

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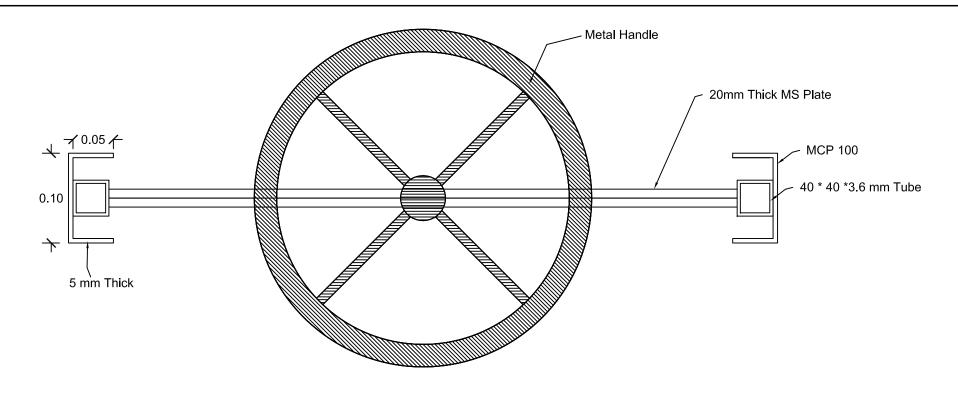
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Soil Test Consultancy (P.) Ltd. (Soil Test)
Kathmandu, Nepal




Project Name:- Nepal Urban Governance and Infrastructure Project (NUGIP)

Intersection

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Plan



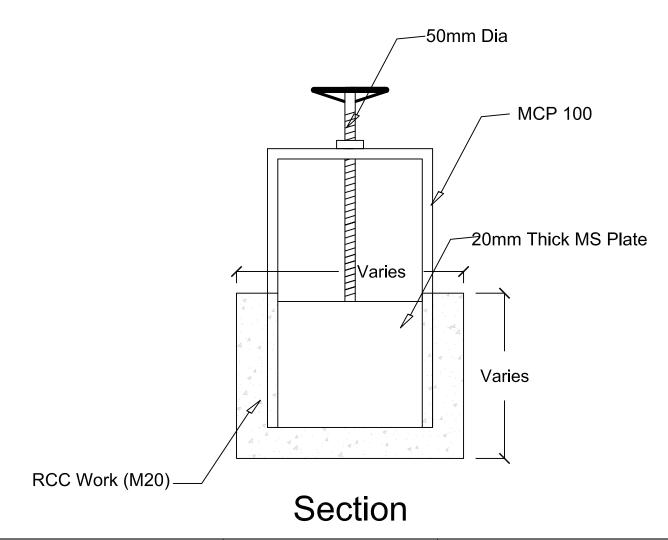

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Kathmandu, Nepal

EA) Inf

Project Name:- Nepal Urban Governance and Infrastructure Project (NUGIP)

Sheet Title:-


Irrigation Canal Gate

 DESIGNED BY:
 Date: 2023


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Road Marking Details



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Office of the Municipal Executive Pokhara Metropolitan City Kaski District, Gandaki Province

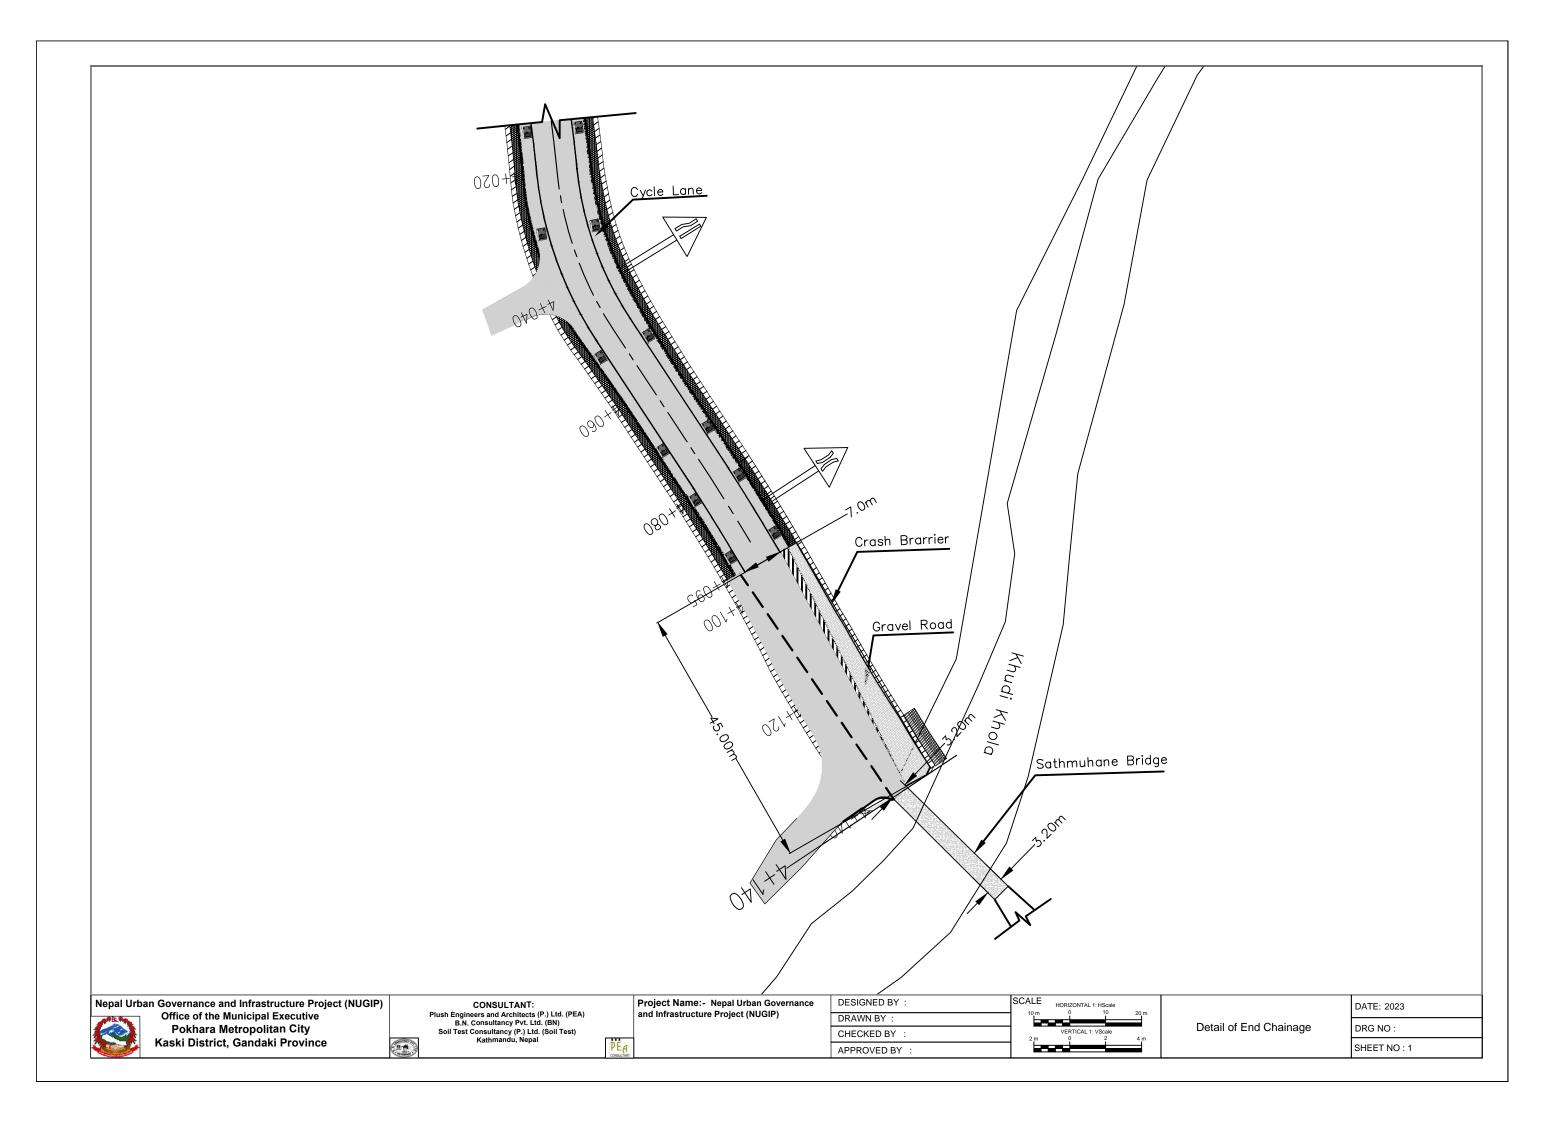CONSULTANT:
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B.N. Consultancy Pvt. Ltd. (BN)
Soil Test Consultancy (P.) Ltd. (Soil Test)
Kathmandu, Nepal

Project Name:- Nepal Urban Governance and Infrastructure Project (NUGIP)

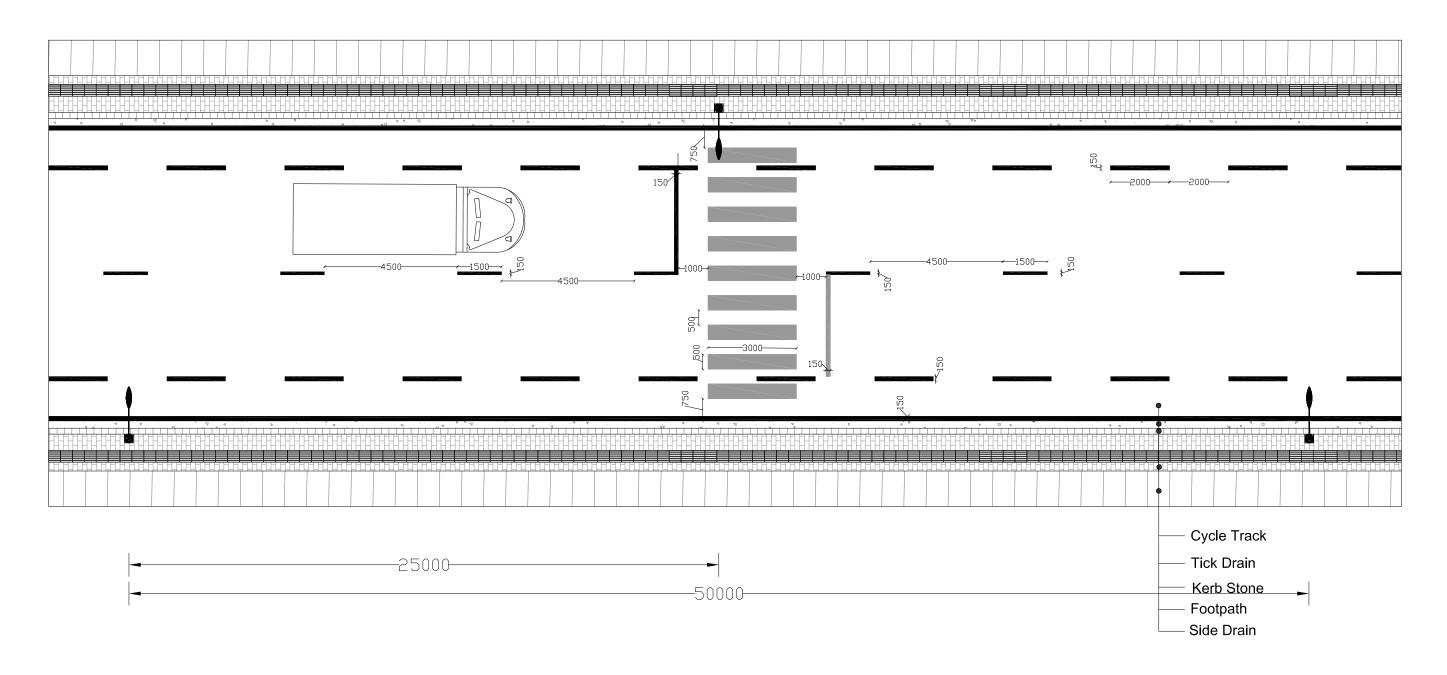Sheet Title:-

Road Marking Details

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TRAFFIC SIGNS

REGULATORY SIGNS



(40)

















B

GO























SUPPLEMENTARY PLATES



Examples:











२ कि.मी.को लागि For 2 km

बसहरु बाहेक

Except buses

HHH









WARNING SIGNS

























/K)









DIRECTION SIGNS

Signs on national highways - green backgrounds



On approaches to junctions



alternative style





Route confirmation sign - after junctions



Temporary diversion signs - yellow






ROAD MARKINGS





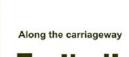







Along the edge of the carriageway



INFORMATION SIGNS

4



1.

At the junction





















TRAFFIC LIGHT SIGNALS

For control of vehicles



















The signal

RED

AMBER then back to

For controlling pedestrian crossing movements











Traffic Engineering and Safety Unit, Department of Roads, 1997

Nepal Urban Governance and Infrastructure Project (NUGIP) Office of the Municipal Executive Pokhara Metropolitan City Kaski District, Gandaki Province

CONSULTANT: B.N. Consultancy Pvt. Ltd. (BN)

Project Name: -Nepal Urban Governance and Infrastructure Project (NUGIP)

दहवी

DUHABI

SHEET TITLE: Standard Drawing of Traffic Sign DESIGNED BY: Date: 2023 Scale: DRAWN BY: CHECKED BY: Sheet No: 1 APPROVED BY:



Plush Engineers and Architects (P.) Ltd. (PEA) Soil Test Consultancy (P.) Ltd. (Soil Test)

Normal height 2000


Normal height 2000


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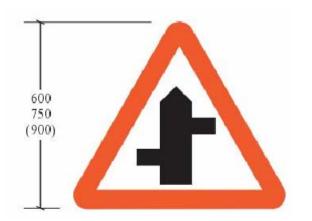
95。


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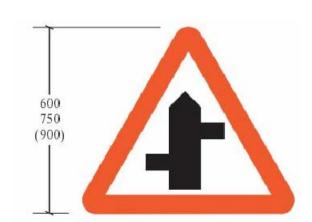
Figure F2







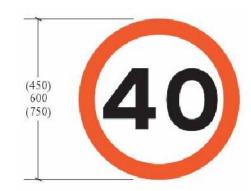


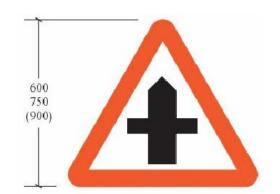

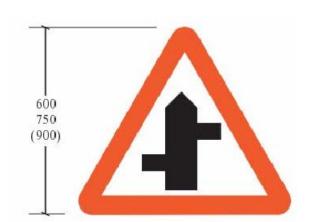

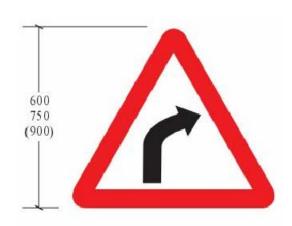

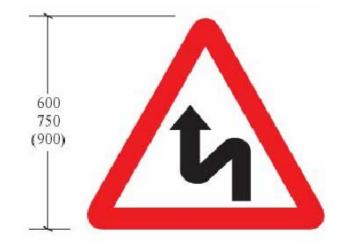

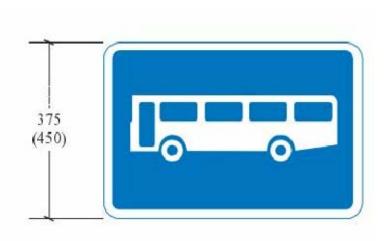



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CONSULTANT:
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B.N. Consultancy Pvt. Ltd. (BN)
Soil Test Consultancy (P.) Ltd. (Soil Test)
Kathmandu, Nepal


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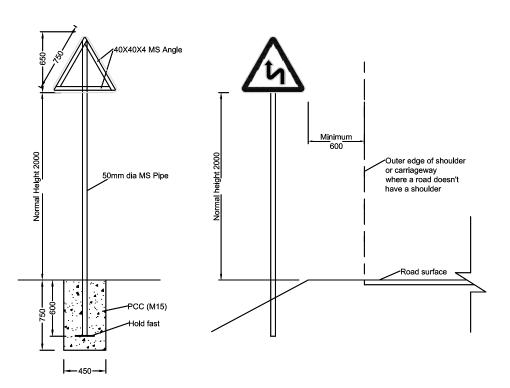
SHEET TITLE: Standard Drawing of Traffic Sign
 DESIGNED BY:
 Date: 2023

 DRAWN BY:
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 APPROVED BY:
 Sheet No: 2







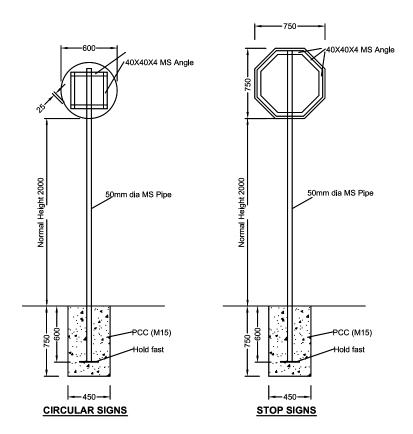













































































































































































EQUILATERAL TRIANGULAR SIGNS

SIGNS POSITIONING

Note: For the dimensions of board signs and letter, please refer Traffic Signs Manual Vol 1 & 2



Nepal Urban Governance and Infrastructure Project (NUGIP) Office of the Municipal Executive Pokhara Metropolitan City Kaski District, Gandaki Province

CONSULTANT:
Plush Engineers and Architects (P.) Ltd. (PEA)
B.N. Consultancy Pvt. Ltd. (BN) Soil Test Consultancy (P.) Ltd. (Soil Test)

Project Name:-Nepal Urban Governance and Infrastructure Project (NUGIP)

SHEET TITLE:

DESIGNED BY: Date: 2023 Scale: Standard Drawing of Traffic Sign DRAWN BY: CHECKED BY: Chalnage: Sheet No: 3 APPROVED BY:











SHARP BEND (TEMPORARY DIVERSION)








DANGEROUS OBSTRUCTION


DANGEROUS OBSTRUCTION





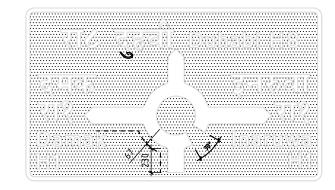

ON APPROACH TO JUNCTION

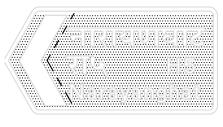




AT THE JUNCTION

ROUTE CONFIRMATION SIGN-AFTER JUNCTIONS



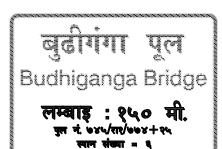






AT THE JUNCTION

BRIDGE NAME PLATE

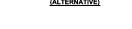









































D26 END





SUPPLEMENTARY PLATES WHITE BLACK





Standard Drawing of Traffic Sign

SHEET TITLE:

DESIGNED BY:	Date: 2023
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APPROVED BY:	Sheet No: 4

Note: For the dimensions of board signs and letter,


please refer Traffic Signs Manual Vol 1 & 2




Nepal Urban Governance and Infrastructure Project (NUGIP) Office of the Municipal Executive Pokhara Metropolitan City Kaski District, Gandaki Province


CONSULTANT: Plush Engineers and Architects (P.) Ltd. (PEA)
B.N. Consultancy Pvt. Ltd. (BN) Soil Test Consultancy (P.) Ltd. (Soil Test)


Project Name:-Nepal Urban Governance and Infrastructure Project (NUGIP)

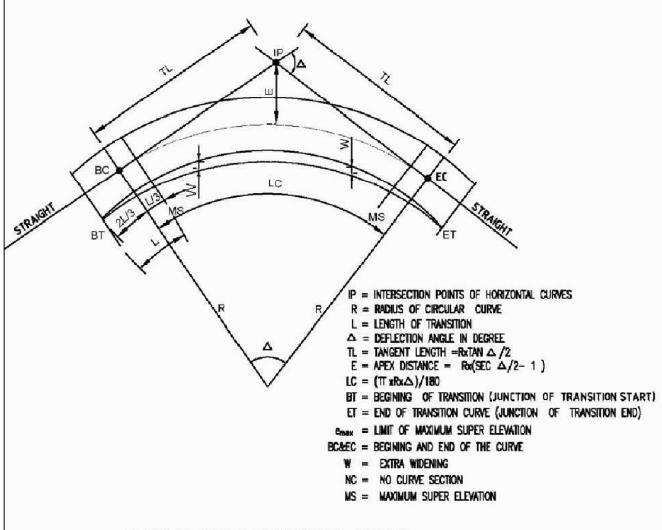

ELEMENTS OF HORIZONTAL CURVE

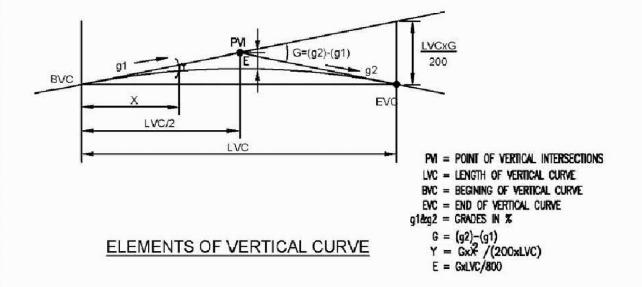

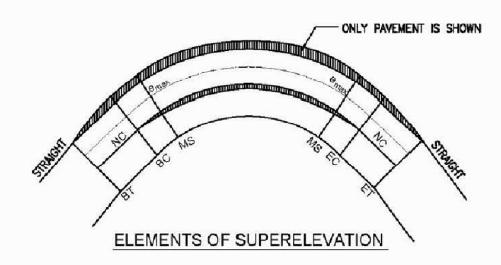

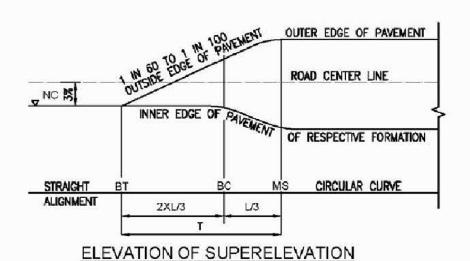

CLACULATION OF SUPER ELEVATION

T = (e2-e1)/100 x RATE OF CHANGE OF SUPER ELEVATION x RW/2

Where,

T = TRANSITION LENGTH IN METRE

e1 = PRECEDING SUPER ELEVATION IN %

SUPER ELEVATION (SE)

MIN. e = 3.0% = TO THE CAMBER SLOPE

MAX. e = 6.0%

RATE OF CHANGE OF SE = 1 IN 60 TO 1 IN 100



Kaski District, Gandaki Province

CONSULTANT:
Plush Engineers and Architects (P.) Ltd. (PEA)
B.N. Consultancy Pvt. Ltd. (BN)
Soil Test Consultancy (P.) Ltd. (Soil Test)
Kathmandu, Nepal

Project Name:-Nepal Urban Governance and Infrastructure Project (NUGIP)

e2 = FOLLOWING SUPERELEVATION IN %


RW = ROAD WIDTH IN METRE


SHEET TITLE: Standard Drawing of Traffic Sign
 DESIGNED BY:
 Date: 2023

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 Scale:

 CHECKED BY:
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 APPROVED BY:
 Sheet No: 5



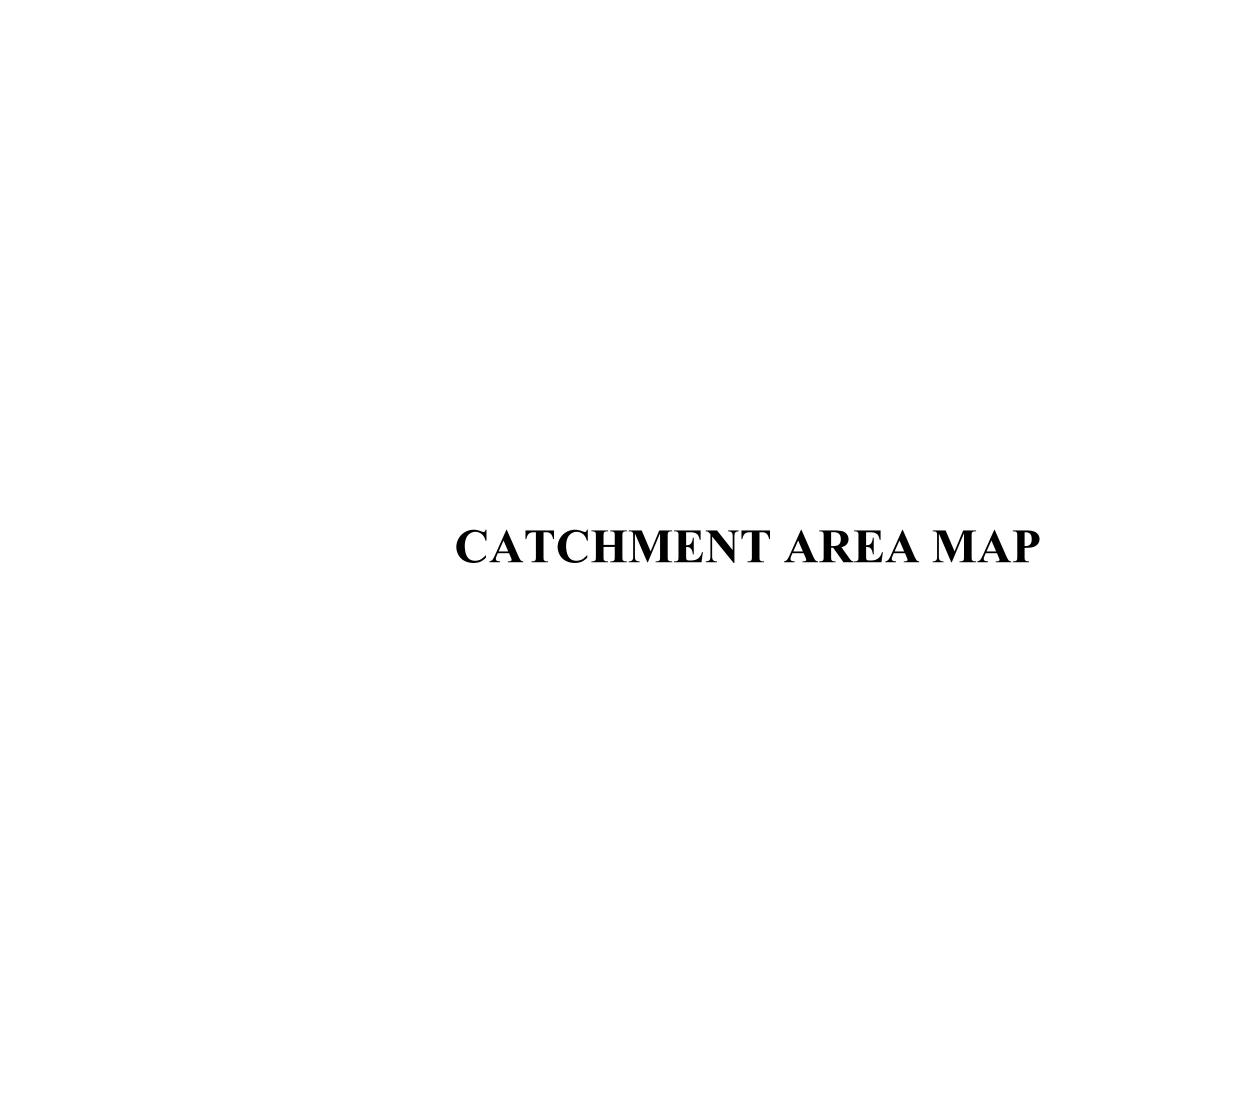

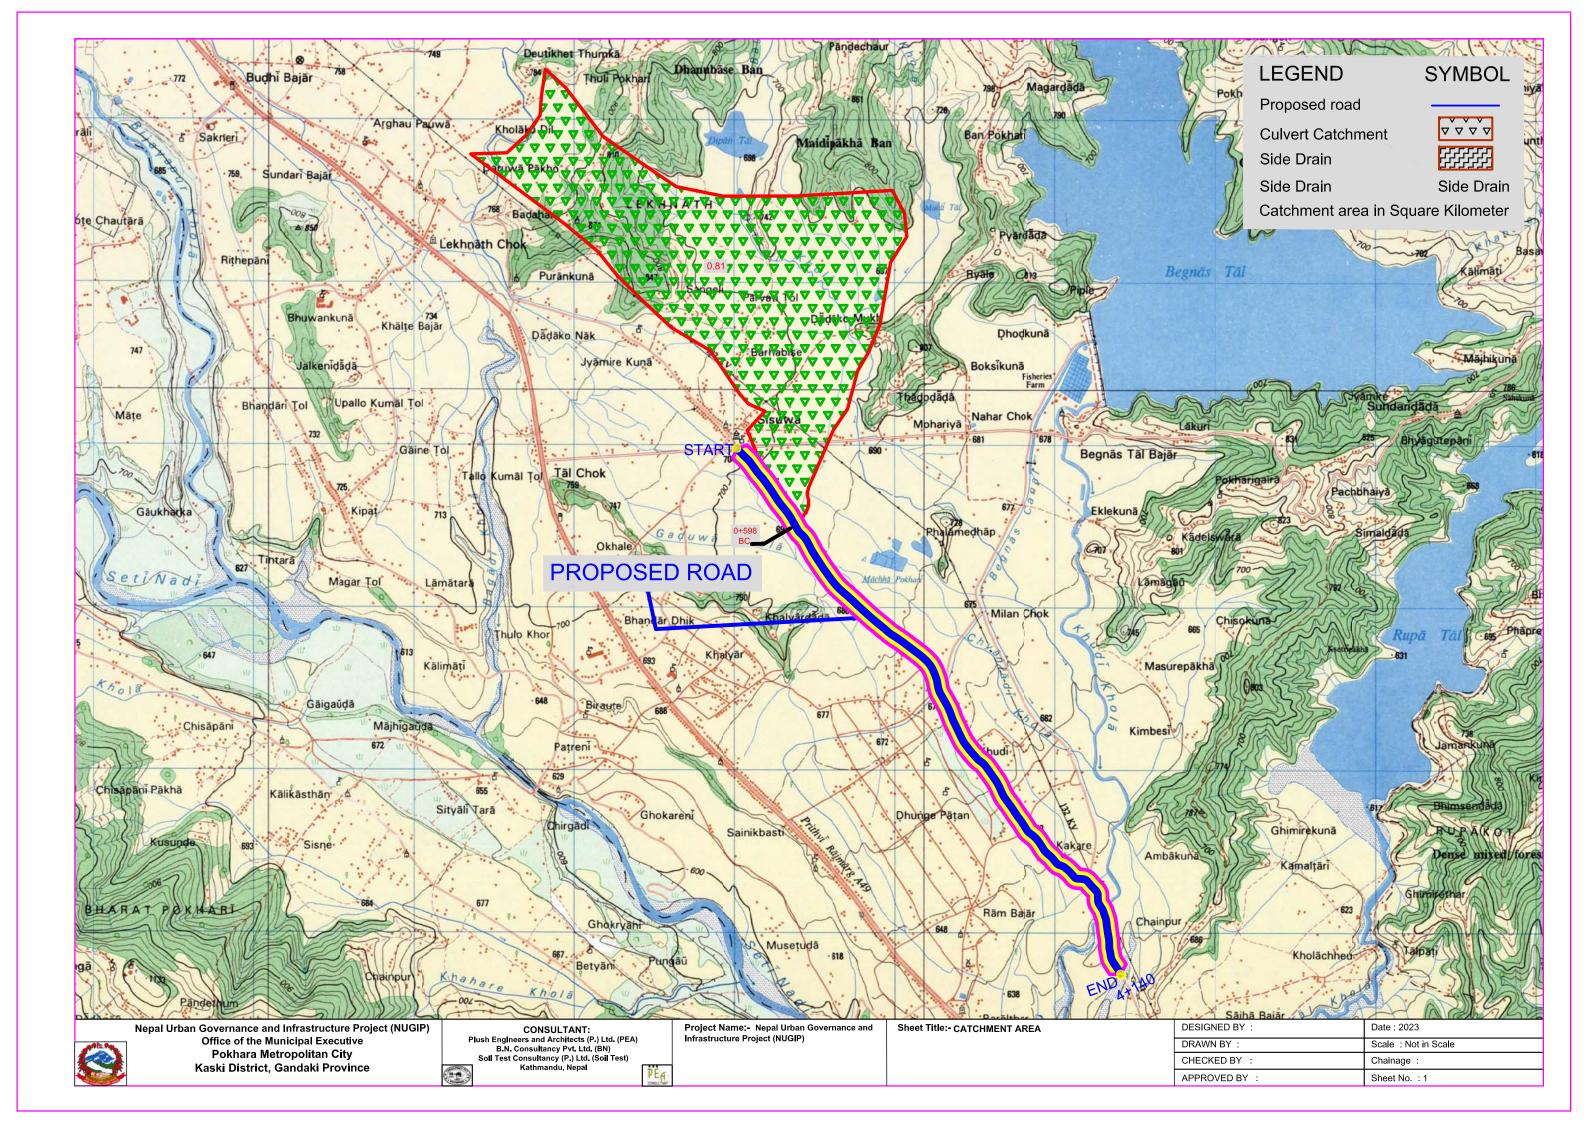

DESCRIPTION CARD


Bench Mark No.: BM-1 Place Name: Gagangauda Chowk

Municipality/Rural Municipality Name: Pokhara Metropolitan City- 30

District: Kaski

Station	Easting	Northing	Elevation	Remarks
BM-1	213890.419	3114852.343	636.193	Slab

Reference Point

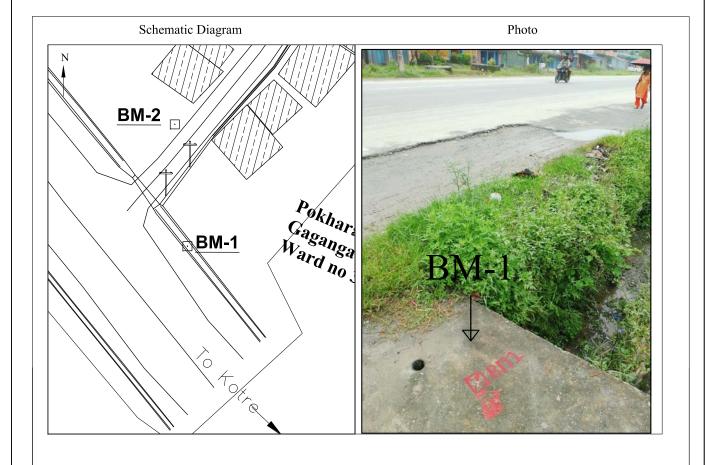



DESCRIPTION CARD

Bench Mark No.: BM-2 Place Name:Gagangauda Chowk

Metropolitan Name: Pokhara Metropolitan City- 30

District: Kaski

Station	Easting	Northing	Elevation	Remarks
BM-2	213888.450	3114871.303	636.448	Slab

Reference Point


R1 = 2.80 m Slab $R2 = 6.90 m Slab$ $R3 = 6.0 m EP$





Nepal Urban Governance and Infrastructure Project (NUGIP) Office of the Municipal Executive Pokhara Metropolitan City Kaski District, Gandaki Province

CONSULTANT: Plush Engineers and Architects (P.) Ltd. (PEA)
B.N. Consultancy Pvt. Ltd. (BN)
Soil Test Consultancy (P.) Ltd. (Soil Test)

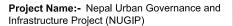

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CHECKED BY:	Chainage:
APPROVED BY:	Sheet No: 1

DESCRIPTION CARD


Bench Mark No. : BM-3 Place Name:Khudi Khola

Metropolitan Name: Pokhara Metropolitan City- 30

District: Kaski

Station	Easting	Northing	Elevation	Remarks
BM-3	214236.248	3115069.057	616.234	Slab

Reference Point

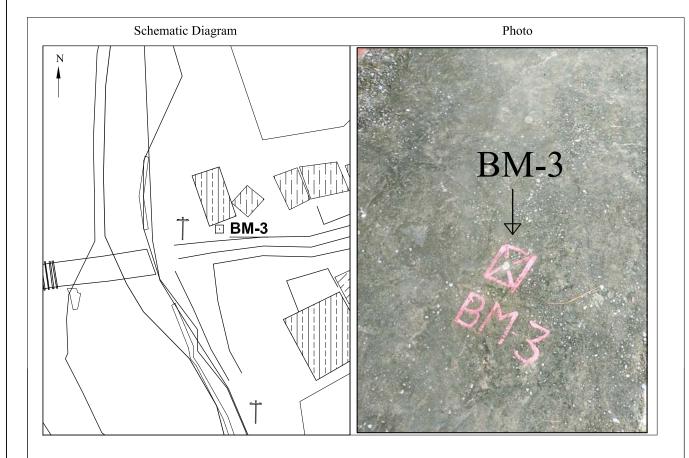

General Information

This point is established at Khudi Khola. The point is marked on the left side of the road on the slab near the electric pole.

ROAD PROJECT

DESCRIPTION CARD

Bench Mark No. : BM-4 Place Name:Khudi Khola


Metropolitan Name: Pokhara Metropolitan City- 30

District: Kaski

Station	Easting	Northing	Elevation	Remarks
BM-4	214270.679	3115068.224	619.414	Slab


Reference Point

R1 = 1.30 m Tree $R2 = 2.10 m Slab$ $R3 = 10.40 m Boulder$
--

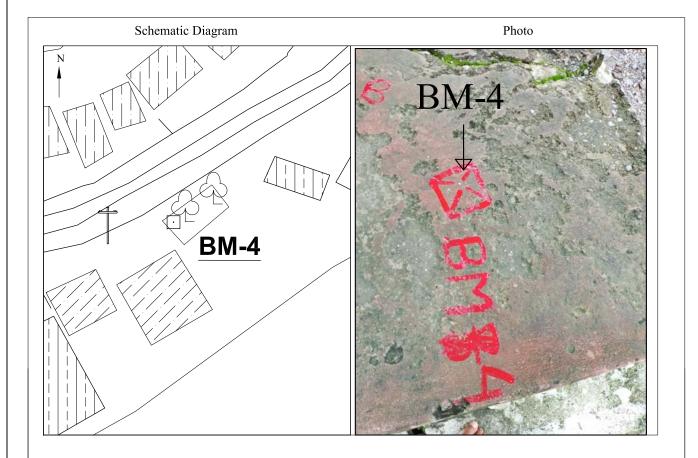

General Information

This point is established at Khudi Khola. The point is marked on the right side of the road near Chutaro.

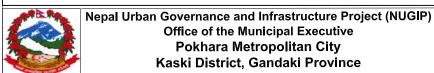



Project Name:- Nepal Urban Governance and Infrastructure Project (NUGIP)

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DESCRIPTION CARD

Bench Mark No.: BM-5 Place Name:Saatmane Khola


Metropolitan Name: Pokhara Metropolitan City- 30

District: Kaski

Station	Easting	Northing	Elevation	Remarks
BM-5	214530.114	3115506.440	634.612	Slab

Reference Point

R1 = 1.50m Bridge	R2 = 8.40m Slab	R3 = 3.50m Slab
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General Information

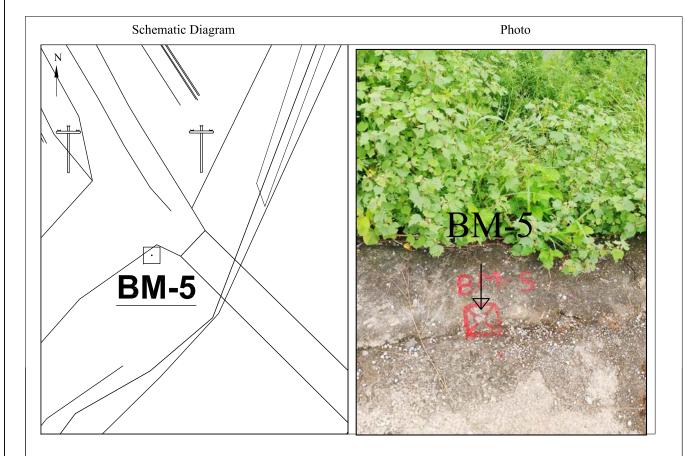This point is established at Saatmane Khola near the bridge. The point is marked on the left side of the road on the top of slab

ROAD PROJECT

DESCRIPTION CARD

Bench Mark No.: BM-6 Place Name:Saatmane Khola


Metropolitan Name: Pokhara Metropolitan City- 30

District: Kaski

Station	Easting	Northing	Elevation	Remarks
BM-6	214521.481	3115538.932	635.290	Slab

Reference Point

	R1 = 2.70m Slab	R2 = 7.30m Slab	R3 = 5.0m EP
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General Information

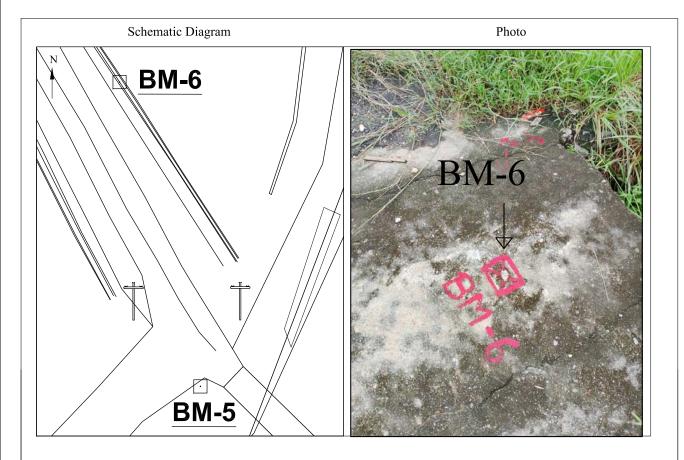This point is established at Saatmane Khola. The point is marked on the right side of the road on the top of slab



Nepal Urban Governance and Infrastructure Project (NUGIP) Office of the Municipal Executive Pokhara Metropolitan City Kaski District, Gandaki Province



Project Name:- Nepal Urban Governance and Infrastructure Project (NUGIP)

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DESCRIPTION CARD

Bench Mark No.: BM-7 Place Name:Pandey Chowk


Metropolitan Name: Pokhara Metropolitan City- 30

District: Kaski

Station	Easting	Northing	Elevation	Remarks
BM-7	214441.025	3115851.357	645.546	Slab

Reference Point

R1 =	5.0m Slab	R2 =	3.50m EP	R3 =	3.60m Slab
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General Information

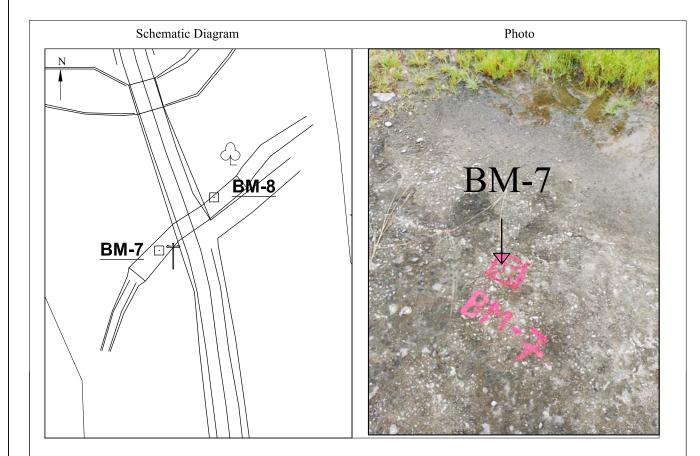This point is established at Pandey Chowk. The point is marked on the left side of the road way to Saatmane on the top of slab

ROAD PROJECT

DESCRIPTION CARD

Bench Mark No.: BM-8 Place Name:Pandey Chowk


Metropolitan Name: Pokhara Metropolitan City- 30

District: Kaski

Station	Easting	Northing	Elevation	Remarks
BM-8	214449.577	3115859.638	645.667	Slab

Reference Point

R1	= 4.50m Boulder	R2 =	5.0m Slab	R3 =	8.40m Slab
1					

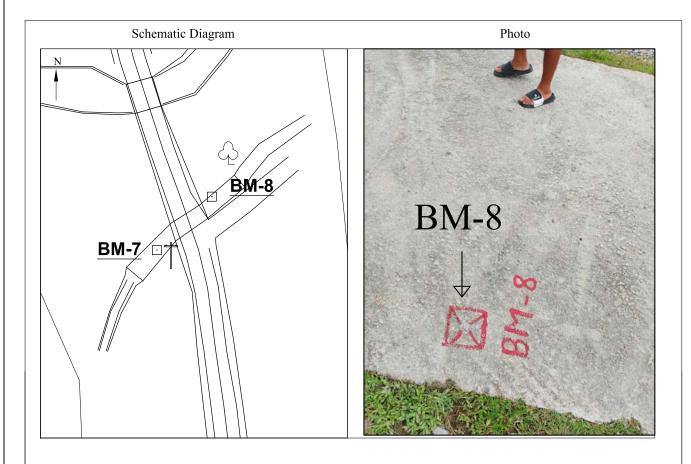

General Information

This point is established at Pandey Chowk. The point is marked on the right side of the road way to Lekhnath on the top of slab



Nepal Urban Governance and Infrastructure Project (NUGIP) Office of the Municipal Executive Pokhara Metropolitan City Kaski District, Gandaki Province

CONSULTANT: Plush Engineers and Architects (P.) Ltd. (PEA)
B.N. Consultancy Pvt. Ltd. (BN)
Soil Test Consultancy (P.) Ltd. (Soil Test)



Project Name:- Nepal Urban Governance and Infrastructure Project (NUGIP)

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DESCRIPTION CARD

Bench Mark No. : BM-9 Place Name:Taka Chowk


Metropolitan Name: Pokhara Metropolitan City- 30

District: Kaski

Station	Easting	Northing	Elevation	Remarks	
BM-9	213968.341	3116400.325	655.586	Slab	

Reference Point

R1 = 1.0m Pole	R2 = 1.40m Pole	R3 = 4.30m Pole
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General Information

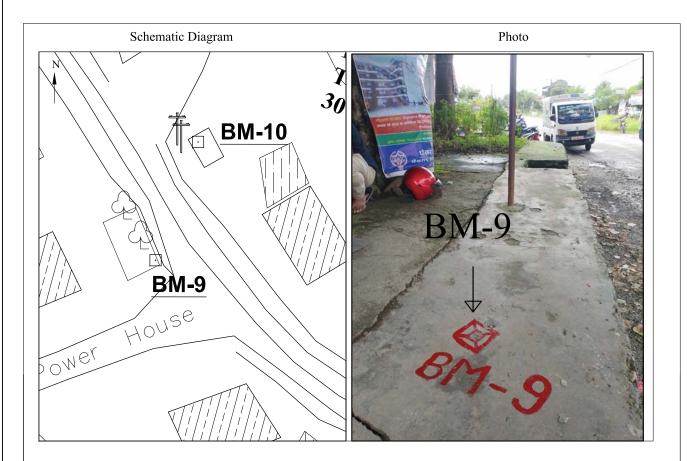This point is established at Taka Chowk. The point is marked on the South East corner of Chautaro way to Chadal Chowk.

ROAD PROJECT

DESCRIPTION CARD

Bench Mark No. : BM-10 Place Name:Taka Chowk


Metropolitan Name: Pokhara Metropolitan City- 30

District: Kaski

Station	Easting	Northing	Elevation	Remarks
BM-10	213973.627	3116415.031	655.039	Slab


Reference Point

R1 =	1.40m Pati	R2 =	3.10m Pole	R3 =	1.80m Pole
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General Information

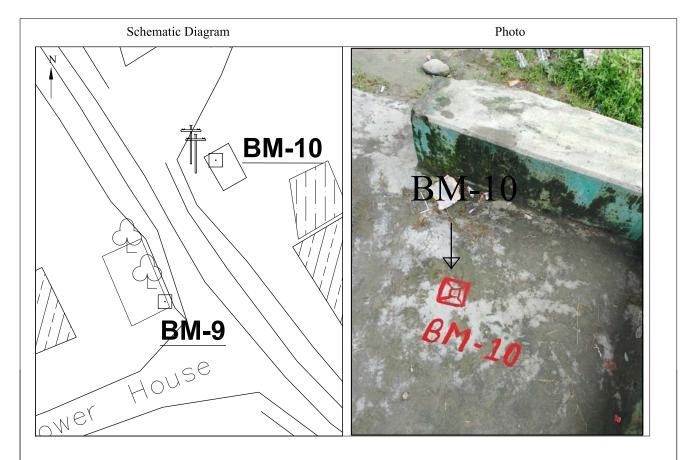This point is established at Taka Chowk. The point is marked on the North East corner Pratikshyalaya way to Administrative Office



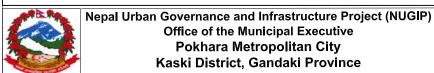

Project Name:- Nepal Urban Governance and Infrastructure Project (NUGIP)

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DESCRIPTION CARD


Bench Mark No. : BM-11 Place Name:Khudi Bazar

Metropolitan Name: Pokhara Metropolitan City- 30

District: Kaski

Station	Easting	Northing	Elevation	Remarks
BM-11	213561.308	3116999.368	668.970	Slab

Reference Point

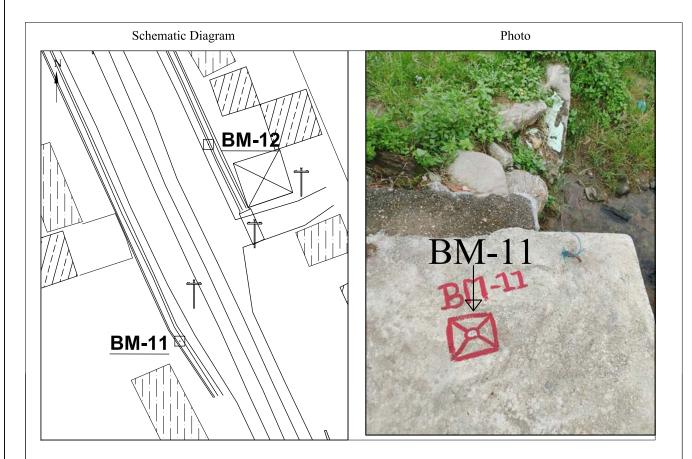

General Information

This point is established at Khudi Bazar. The point is marked on left side of the road on top of slab

ROAD PROJECT

DESCRIPTION CARD


Bench Mark No. : BM-12 Place Name:Khudi Bazar

Metropolitan Name: Pokhara Metropolitan City- 30

District: Kaski

Station	Easting	Northing	Elevation	Remarks
BM-12	213565.357	3117027.246	669.305	Slab

Reference Point

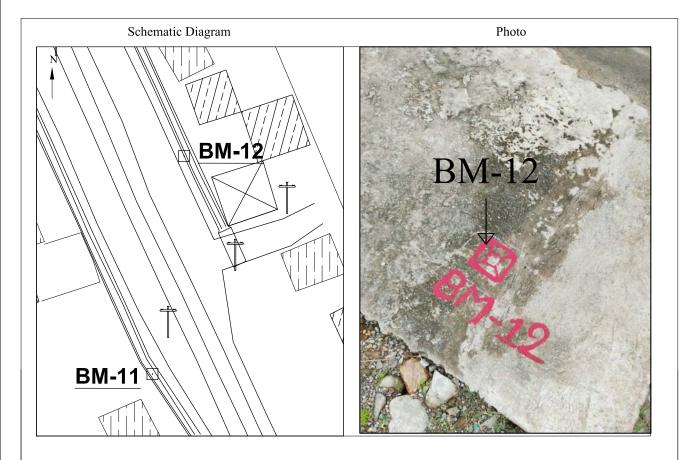

General Information


This point is established at Khudi Bazar. The point is marked on right side of the road on top of slab.



Nepal Urban Governance and Infrastructure Project (NUGIP)
Office of the Municipal Executive
Pokhara Metropolitan City
Kaski District, Gandaki Province



CONSULTANT:
Plush Engineers and Architects (P.) Ltd. (PEA)
B.N. Consultancy Pvt. Ltd. (BN)
Soil Test Consultancy (P.) Ltd. (Soil Test)
Kathmandu, Nepal

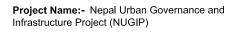

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DESCRIPTION CARD


Bench Mark No.: BM-13 Place Name: Shantinagar Tole

Metropolitan Name: Pokhara Metropolitan City- 30

District: Kaski

Station	Easting	Northing	Elevation	Remarks
BM-13	213363.837	3117461.100	676.300	Slab

Reference Point

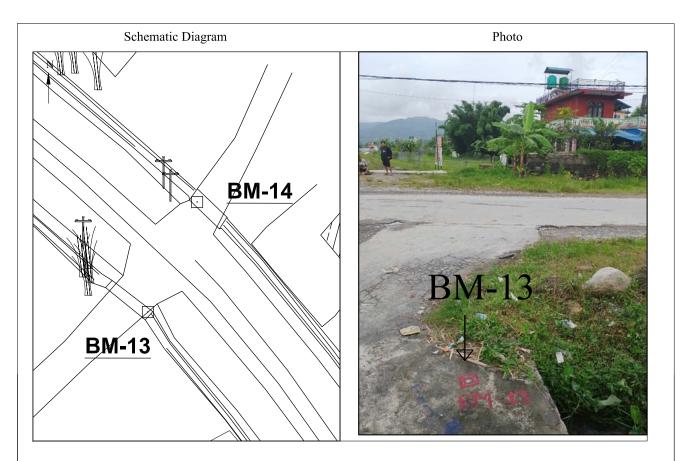

General Information

This point is established at Shantinagar Tole. The point is marked on left side of road way to Dipsika Urja on the top of slab.

ROAD PROJECT

DESCRIPTION CARD

Bench Mark No.: BM-14 Place Name: Shantinagar Tole


Metropolitan Name: Pokhara Metropolitan City- 30

District: Kaski

Station Coordinate	Easting	Northing	Elevation	Remarks	
BM-14	213370.111	3117475.089	676.591	Slab	

Reference Point

R1 = 5.20 m Pole $R2 = 4.0 m Pole$ $R3 = 3.5 m EP$
--

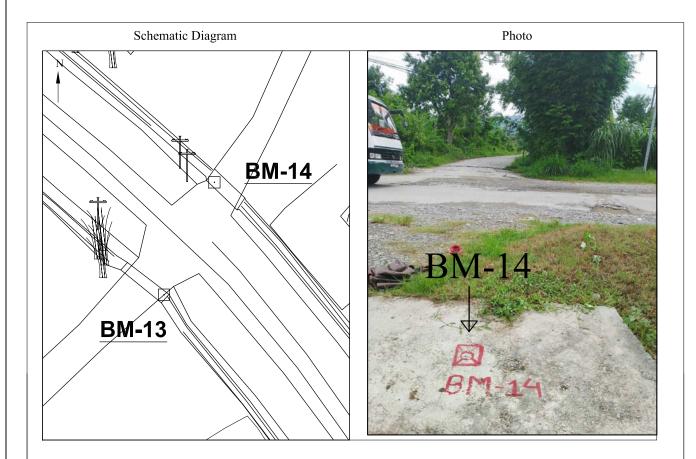

General Information

This point is established at Shantinagar Tole. The point is marked on right side of road way to Suyog Salon on top of slab



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DESCRIPTION CARD

Bench Mark No.: BM-15 Place Name: Shantinagar Tole


Metropolitan Name: Pokhara Metropolitan City- 30

District: Kaski

Station	Easting	Northing	Elevation	Remarks
BM-15	212988.374	3117766.289	683.674	Slab

Reference Point

R1 = 4.60m Slab	R2 = 3.0m Tree	R3 = 7.50m EP
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General Information

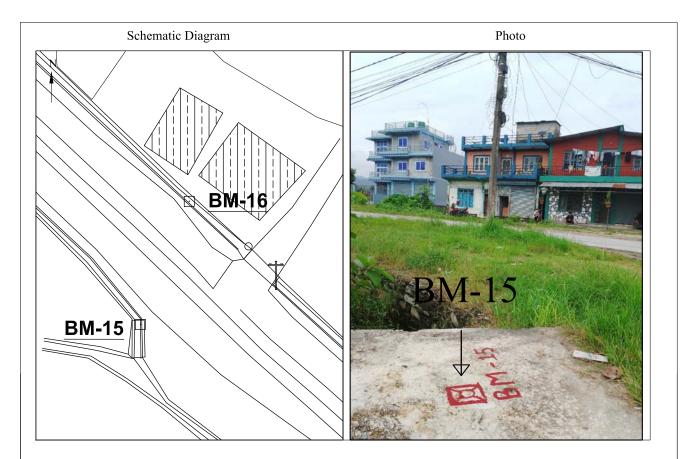This point is established at near the Water Tank. The point is marked on left side of road way to Lekhnath on the top of slab.

ROAD PROJECT

DESCRIPTION CARD

Bench Mark No.: BM-16 Place Name: Shantinagar Tole


Metropolitan Name: Pokhara Metropolitan City- 30

District: Kaski

Station	Easting	Northing	Elevation	Remarks
BM-16	212995.224	3117783.581	683.452	Slab

Reference Point

R1 = 2.0m Pole	R2 = 3.10m Pole	R3 = 11.30m EP
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General Information

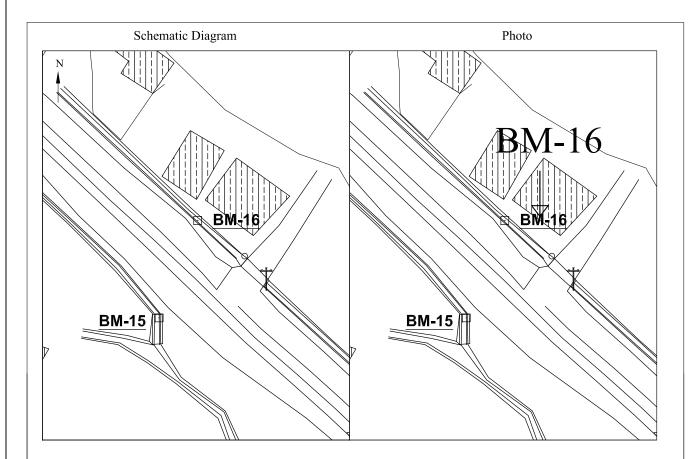
This point is established at near the Water Tank. The point is marked on right side of road way to Lekhnath on the top of slab.



Nepal Urban Governance and Infrastructure Project (NUGIP) Office of the Municipal Executive Pokhara Metropolitan City Kaski District, Gandaki Province



CONSULTANT: Plush Engineers and Architects (P.) Ltd. (PEA)
B.N. Consultancy Pvt. Ltd. (BN)
Soil Test Consultancy (P.) Ltd. (Soil Test)

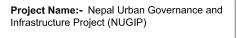

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DESCRIPTION CARD


Bench Mark No. : BM-17 Place Name:Sisuwa Guwaz

Metropolitan Name: Pokhara Metropolitan City- 30

District: Kaski

Station	Easting	Northing	Elevation	Remarks
BM-17	212615.811	3118245.667	691.309	Slab

Reference Point

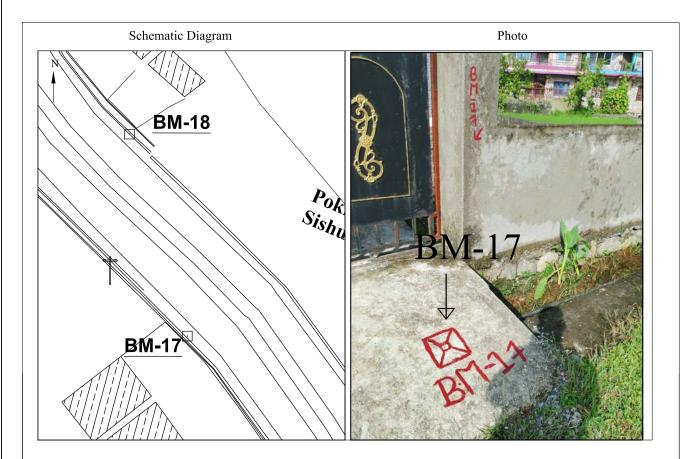

General Information

This point is established at Sisuwa Guwaz. The point is marked on left side of road way to Lekhnath on the top of slab

ROAD PROJECT

DESCRIPTION CARD

Bench Mark No. : BM-18 Place Name:Sisuwa Guwaz


Metropolitan Name: Pokhara Metropolitan City- 30

District: Kaski

Station	Easting	Northing	Elevation	Remarks
BM-18	212607.437	3118274.957	691.601	Slab


Reference Point

R1 = 2.90 m Wall $R2 = 1.30 m Wall$ $R3 = 15.0 m Stab$	1 1C1 2.70111 Wall	R2 = 1.30m Wall		
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General Information

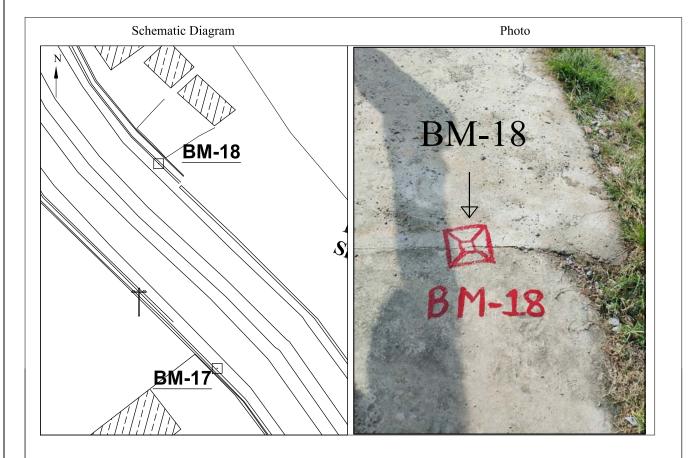This point is established at Sisuwa Guwaz. The point is marked on right side of road way to Lekhnath on the top of slab.



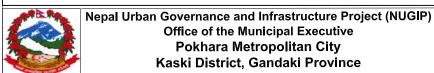

Project Name:- Nepal Urban Governance and Infrastructure Project (NUGIP)

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DESCRIPTION CARD

Bench Mark No. : BM-19 Place Name:Sisuwa Chowk


Metropolitan Name: Pokhara Metropolitan City- 30

District: Kaski

Station	Easting	Northing	Elevation	Remarks
BM-19	212227.935	3118786.901	700.768	Slab

Reference Point

R1 = 9.0 m Pole $R2 = 10.0 m Pole$ $R3 = 9.40 m Slab$

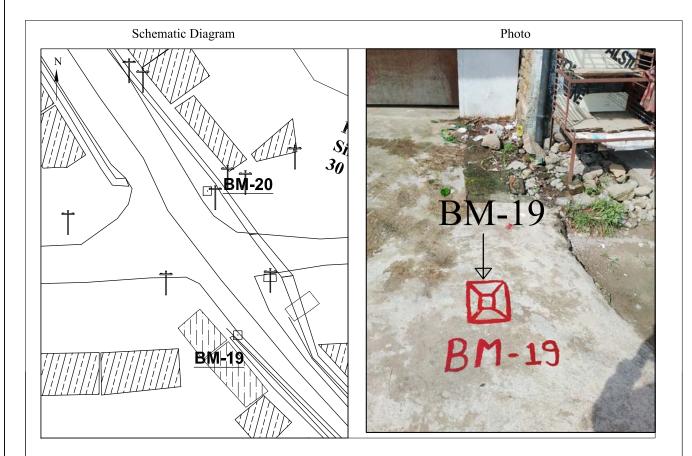

General Information

This point is established at Sisuwa Chowk. The point is marked on left side of road way to Talchok on the top of slab

ROAD PROJECT

DESCRIPTION CARD


Bench Mark No. : BM-20 Place Name:Sisuwa Chowk

Metropolitan Name: Pokhara Metropolitan City- 30

District: Kaski


Station	Easting	Northing	Elevation	Remarks
BM-20	212222.834	3118811.017	701.338	Slab

Reference Point

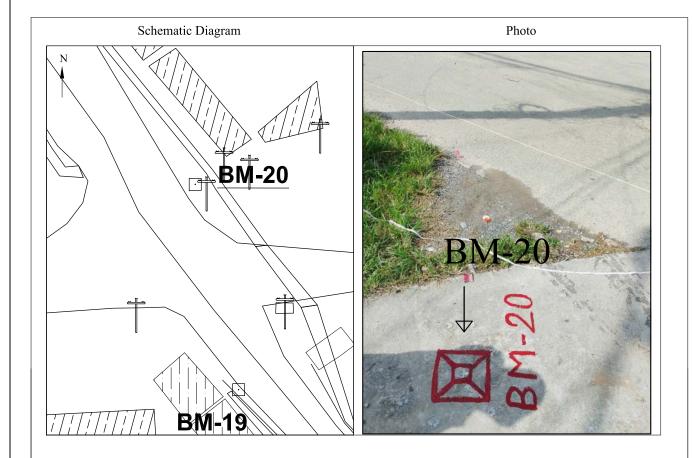

General Information

This point is established at Sisuwa Chowk. The point is marked on left side of road way to Begnas lake on the top of slab.

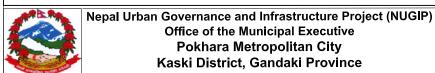



Project Name:- Nepal Urban Governance and Infrastructure Project (NUGIP)

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DESCRIPTION CARD


Bench Mark No. : BM-21 Place Name:Mansumarga Chowk

Metropolitan Name: Pokhara Metropolitan City- 30

District: Kaski

Station Coordinate	Easting	Northing	Elevation	Remarks
BM-21	211731.066	3119387.902	714.389	Slab

Reference Point

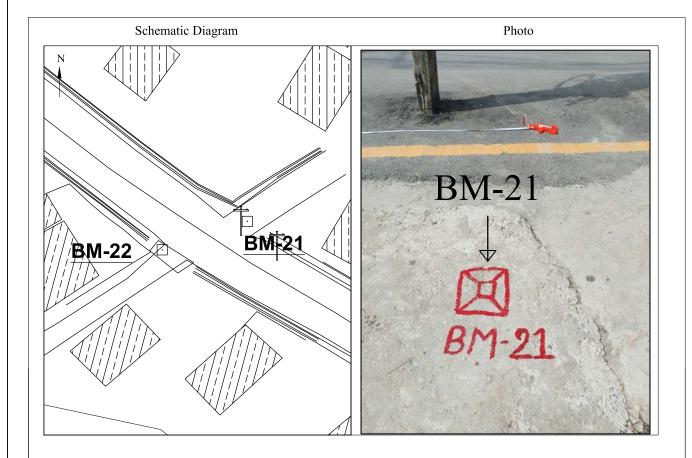

General Information

This point is established at Mansumarga Chowk. The point is marked on right side of road way to Khabarkot on the top of slab.

ROAD PROJECT

DESCRIPTION CARD

Bench Mark No. : BM-22 Place Name:Mansumarga Chowk


Metropolitan Name: Pokhara Metropolitan City- 30

District: Kaski

Station	Easting	Northing	Elevation	Remarks	
BM-22	211719.391	3119384.003	714.822	Slab	


Reference Point

R1 = 1.60m Wall	R2 = 3.80m Slab	R3 = 11.50 Slab
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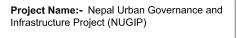
General Information

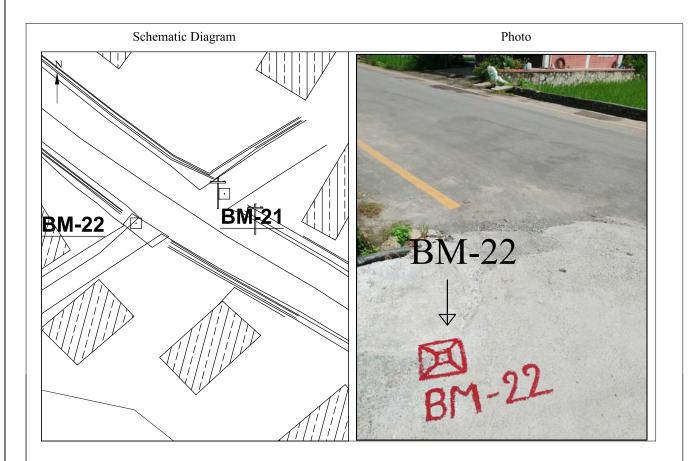This point is established at Mansumarga Chowk. The point is marked on left side of road way to Nahar on the top of slab.



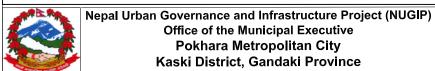

CONSULTANT:
Plush Engineers and Architects (P.) Ltd. (PEA)
B.N. Consultancy Pvt. Ltd. (BN)
Soil Test Consultancy (P.) Ltd. (Soil Test)



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APPROVED BY:	Sheet No: 11

DESCRIPTION CARD


Bench Mark No. : BM-23 Place Name:Chandakali Chowk

Metropolitan Name: Pokhara Metropolitan City- 27

District: Kaski

Station	Easting	Northing	Elevation	Remarks
BM-23	211049.509	3119699.842	726.973	Slab

Reference Point

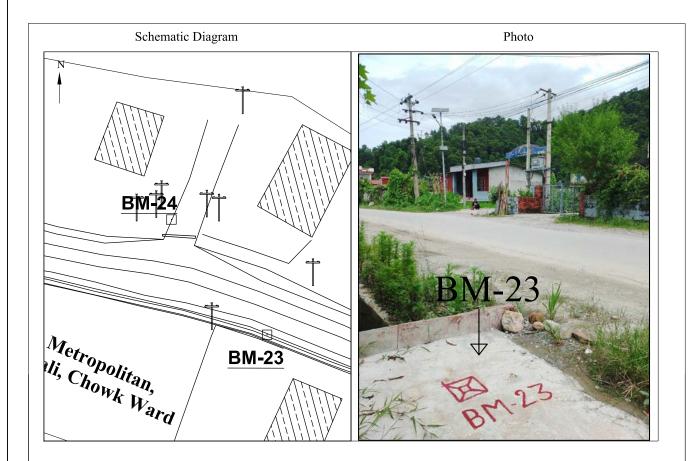

General Information

This point is established at Chandakali Chowk. The point is marked on left side of road way on the top of slab.

ROAD PROJECT

DESCRIPTION CARD

Bench Mark No. : BM-24 Place Name:Chandakali Chowk


Metropolitan Name: Pokhara Metropolitan City- 27

District: Kaski

Station	Easting	Northing	Elevation	Remarks
BM-24	211035.246	3119717.030	727.345	Slab


Reference Point

R1 = 13.70 m Slab $R2 = 5.0 m EP$ $R3 = 2.0 m EP$	R1 = 13.70m Slab		R3 = 2.0m EP
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General Information

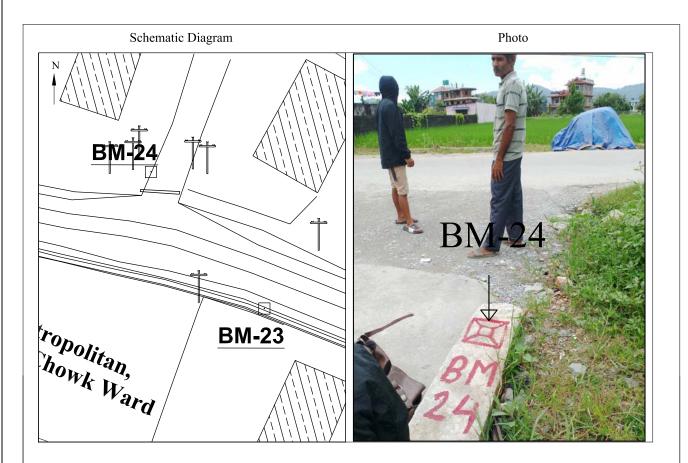This point is established at Chandakali Chowk. The point is marked on left side of road near the transformer on the top of slab.



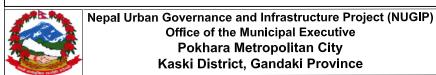

Project Name:- Nepal Urban Governance and Infrastructure Project (NUGIP)

DESIGNED BY:	Date: 2023
DRAWN BY:	Scale: Not In Scale
CHECKED BY:	Chainage:
APPROVED BY:	Sheet No: 12

DESCRIPTION CARD


Bench Mark No.: BM-25 Place Name: Dadhanak

Metropolitan Name: Pokhara Metropolitan City- 27

District: Kaski

Station	Easting	Northing	Elevation	Remarks
BM-25	210666.856	3120030.692	733.588	Slab

Reference Point

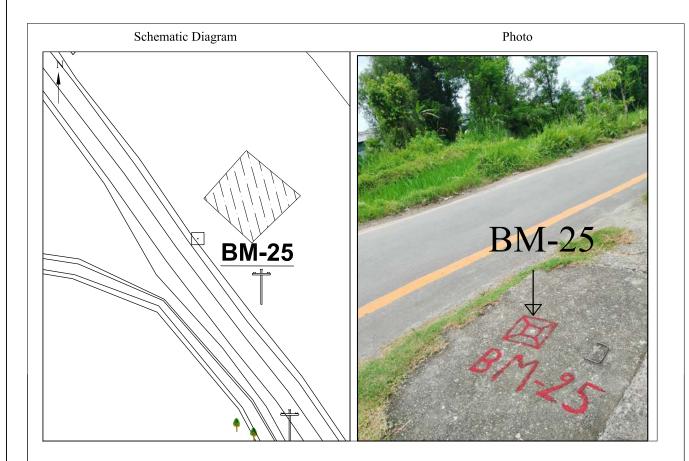

General Information

This point is established at Dadhanak. The point is marked on right side of road on the top of slab.

ROAD PROJECT

DESCRIPTION CARD

Bench Mark No. : BM-26 Place Name: Dadhanak


Metropolitan Name: Pokhara Metropolitan City- 27

District: Kaski

Station	Easting	Northing	Elevation	Remarks
BM-26	210622.349	3120088.519	734.752	Slab

Reference Point

R1 = 5.60m Tree	R2 = 5.30m Tree	R3 = 7.10m Boulder
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General Information

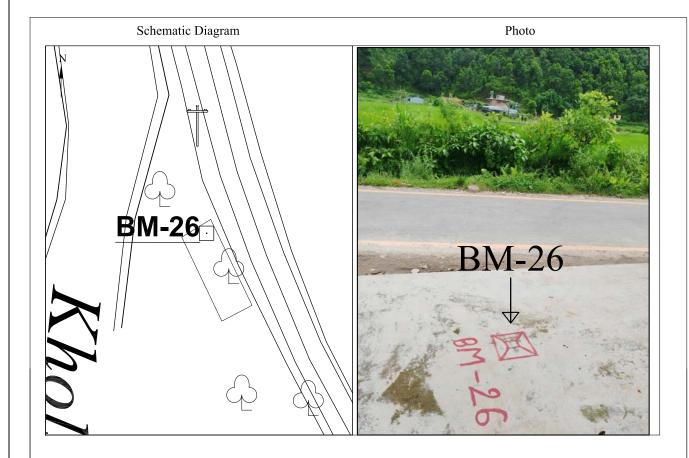
This point is established at Dadhanak. The point is marked on left side of road on the corner of the Chautaro



Nepal Urban Governance and Infrastructure Project (NUGIP)
Office of the Municipal Executive
Pokhara Metropolitan City
Kaski District, Gandaki Province

Plusi

CONSULTANT:
Plush Engineers and Architects (P.) Ltd. (PEA)
B.N. Consultancy Pvt. Ltd. (BN)
Soil Test Consultancy (P.) Ltd. (Soil Test)
Kathmandu, Nepal

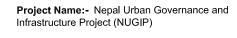

SHEET TI	TLE:
_	ESCRIPTION CARD O

DESIGNED BY:	Date: 2023
DRAWN BY:	Scale: Not In Scale
CHECKED BY:	Chainage:
APPROVED BY:	Sheet No: 13

DESCRIPTION CARD

Bench Mark No. : BM-27 Place Name: Arjun Chowk


Metropolitan Name: Pokhara Metropolitan City- 27

District: Kaski

Station Coordinate	Easting	Northing	Elevation	Remarks	
BM-27	210307.053	3120144.031	739.630	Slab	

Reference Point

R1 = 2.90m EP	R2 = 2.50m Pole	R3 = 2.90m Pole
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General Information

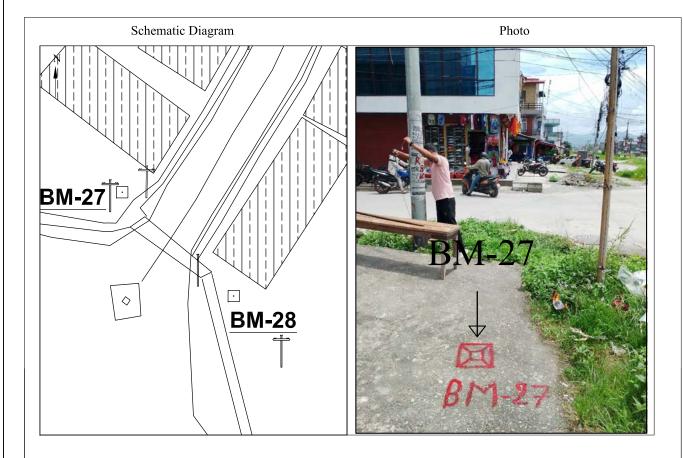This point is established at Arjun Chowk. The point is marked on right side of road way to Prithvi Highway on the top of slab.

ROAD PROJECT

DESCRIPTION CARD

Bench Mark No. : BM-28 Place Name: Arjun Chowk


Metropolitan Name: Pokhara Metropolitan City- 27

District: Kaski

Station	Easting	Northing	Elevation	Remarks
BM-28	210320.975	3120131.075	738.842	Slab


Reference Point

R1 = 2.80m Slab	R2 = 10.	0m EP	R3 =	4.70m EP
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General Information

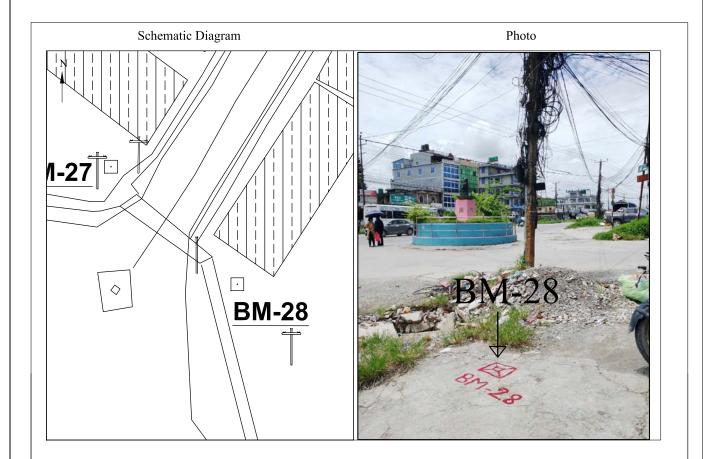This point is established at Arjun Chowk. The point is marked on left side of road way to Prithvi Highway on the top of slab.



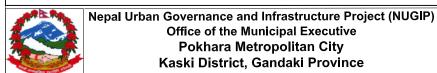

Project Name:- Nepal Urban Governance and Infrastructure Project (NUGIP)

	DESIGNED BY:	Date: 2023	
	DRAWN BY:	Scale: Not In Scale	
	CHECKED BY:	Chainage:	
	APPROVED BY:	Sheet No: 14	